

SITE NUMBER/ID:

(N) 26.3' A.G.L. CONCRETE POLE

SOLAR POWER, EMBEDDED

PROJECT SUMMARY:

SITE ADDRESS: VARIOUS

APPLICANT:

SOUTHERN CALIFORNIA GAS CO. 555 W. 5TH ST., SUITE 3RD., LOS ANGELES, CA 90013 REPRESENTATIVE: LINDA HOANG PHONE: (213) 244-3393

PROPERTY OWNER:

PUBLIC RIGHT OF WAY

LATITUDE: XX.YYYYYYYY

LONGITUDE: -YYY.XXXXXXXX

OCCUPANCY CLASSIFICATION: UTILITY / WIRELESS ANTENNA

ZONING CLASSIFICATION:


CONSTRUCTION TYPE:

PROJECT DESCRIPTION:

SOUTHERN CALIFORNIA GAS CO. PROPOSES TO INSTALL ACLARA EQUIPMENT MOUNTED ON A NEW CONCRETE POLE, 26'-4" ABOVE GROUND LEVEL

SHEET INDEX:

SHEET NO:	DESCRIPTION:
T-1	TITLE SHEET
T-2	GENERAL NOTES
A-1	ELEVATIONS
A-2	EQUIPMENT DETAILS
A-3	MOUNTING DETAILS
A-4	MATERIALS LIST
E-1	ELECTRICAL DIAGRAM

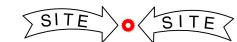

CONSULTING TEAM:

SAC/ZONING/PERMITTING:

SOUTHERN CALIFORNIA GAS CO. LINDA HOANG 555 W. 5TH ST., 3RD FLOOR LOS ANGELES, CA 90013 (213) 244-3393

CONTRACTOR

HENKELS & MCCOY

2840 FICUS STREET POMONA, CA 91766 PHONE: (909) 270-7880 FAX: (909) 548-6664

CONTACT: DARLENE CASTILLO DATE: 08-14-14

CONSTRUCTION PROJECT MANAGER

SOUTHERN CALIFORNIA GAS CO. ROBERT SHY 555 W. 5TH ST., 3RD FLOOR LOS ANGELES, CA 90013 (213) 364-2195

NETWORK CONSTRUCTION ENGINEER

SOUTHERN CALIFORNIA GAS CO. JUAN MALDONADO 555 W. 5TH ST., 3RD FLOOR LOS ANGELES, CA 90013

APPROVALS:

SIGNATURE

DATE

THE FOLLOWING PARTIES HEREBY APPROVE AND ACCEPT THESE DOCUMENTS AND AUTHORIZE THE CONTRACTOR TO PROCEED WITH THE CONSTRUCTION DESCRIBED HEREIN. ALL CONSTRUCTION DOCUMENTS ARE SUBJECT TO REVIEW BY THE LOCAL BUILDING DEPARTMENT AND ANY CHANGES AND MODIFICATIONS THEY MAY IMPOSE.

PRINT NAME

SAC REP.

LANDLORD	PUBLIC R.O.W.			
PRECON. MGR			 _	
DEVELOP. MGR			 _	
CONST. MGR			 _	
PROJECT. MGR			 _	
SR. RF ENGINEER				
RF ENGINEER			 _	
OPERATIONS			 _	

VICINITY MAP

PERMIT #:

APPLICABLE CODES:

CALIFORNIA ADMINISTRATIVE CODE

2013 CALIFORNIA BUILDING CODE ANSI/FIA-222-FI IFF SAFETY CODE NEPA-101

2013 UNIFORM PLUMBING CODE 2013 NATIONAL ELECTRIC CODE

LOCAL BUILDING CODE CITY/COUNTY ORDINANCES





REVISION A: INITIAL DESIGN.

REVISION 1: AS BUILT PER REDLINE BY THE CONTRACTOR.

REVISION HISTORY

	DATE:	
DESIGNER: J.M.		
CAD DRAFTING: A.J.	05/25/15	
CHECKED BY: J.M.		
SCALE: AS SHOWN		
SHEET NUMBER:	REVISION:	
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REVISED BY 05/25/15 ADONIS V. JAVIER

CONSTRUCTION DOCUMENTS IS PROPRIETARY BY NATURE. ANY USE OR DISCLOSURE OTHER THAN THAT WHICH RELATES TO THE GAS COMPANY IS STRICTLY PROHIBITED.





ADVANCED METER THE GAS COMPANY TOWER 555 W. 5TH STREET LOS ANGELES, CA 90013

PROJECT INFORMATION:

26.3' CONCRETE POLE SOLAR, EMBEDDED

SHEET TITLE:

TITLE SHEET

LICENSURE:

VICENTE MANI ANGIT P.E.

INTENT

- THIS CONSTRUCTION DRAWINGS DESCRIBE THE WORK TO BE DONE AND THE MATERIALS TO BE FURNISHED FOR CONSTRUCTION.
- THE INTENTION OF THE DOCUMENT IS TO INCLUDE ALL LABOR AND MATERIALS REASONABLY NECESSARY FOR THE PROPER EXECUTION AND COMPLETION OF THE WORK AS STIPULATED IN THE CONTRACT.
- 3. MINOR DEVIATIONS FROM THE DESIGN LAYOUT ARE ANTICIPATED AND SHALL BE CONSIDERED AS PART OF THE WORK. NO CHANGES THAT ALTER THE CHARACTER OF THE WORK WILL BE MADE OR PERMITTED BY THE OWNER WITHOUT ISSUING A CHANGE ORDER.
- THE DRAWINGS ARE GRAPHIC AND PICTORIAL PORTIONS OF THE CONTRACT DOCUMENTS SHOWING THE DESIGN, LOCATION AND DIMENSIONS OF THE WORK, GENERALLY INCLUDING PLANS, ELEVATIONS, SECTIONS, DETAILS, SCHEDULES
- 5. IN CASE OF INCONSISTENCY BETWEEN OTHER PARTS OF THE CONTRACT. THE CONTRACTOR SHALL PERFORM THE WORK IN ACCORDANCE WITH THE OWNER'S
- 6. WHERE DRAWINGS REFER TO STANDARD SPECIFICATIONS, THE LATEST OR MOST RECENT EDITION SHALL APPLY.

CHANGE ORDER PROCEDURE

1. CHANGE ORDER MAY BE INITIATED BY THE OWNER AND/OR THE CONTRACTOR INVOLVED. THE CONTRACTOR, UPON VERBAL REQUEST FROM THE OWNER SHALL PREPARE A WRITTEN PROPOSAL DESCRIBING THE CHANGE IN WORK OR MATERIALS AND ANY CHANGES IN THE CONTRACT AMOUNT AND PRESENT TO THE OWNER WITHIN 72 HOURS FOR APPROVAL. SUBMIT REQUESTS FOR SUBSTITUTIONS IN THE FORM AND IN ACCORDANCE WITH PROCEDURES REQUIRED FOR CHANGE ORDER DEPORCES. ANY CHANGES IN THE FORDER OR MATERIALS PROPOSALS. ANY CHANGES IN THE SCOPE OF WORK OR MATERIALS WHICH ARE PERFORMED BY THE CONTRACTOR WITHOUT A WRITTEN CHANGE ORDER AS DESCRIBED AND APPROVED BY THE OWNER SHALL PLACE FULL RESPONSIBILITY OF THESE ACTIONS ON THE CONTRACTOR.

CODE COMPLIANCE

ALL WORK SHALL BE IN ACCORDANCE WITH APPLICABLE LOCAL, STATE AND FEDERAL REGULATIONS. THESE SHALL INCLUDE BUT NOT BE LIMITED TO THE LATEST VERSION OF THE FOLLOWING:

CALIFORNIA ADMINISTRATIVE CODE 2013 CALIFORNIA BUILDING CODE 2013 UNIFORM PLUMBING CODE 2013 NATIONAL FLECTRIC CODE 2013 UNIFORM MECHANICAL CODE ANSI/EIA-222-F LIFE SAFETY CODE NFPA-101 LOCAL BUILDING CODE CITY AND COUNTY ORDINANCES

ADMINISTRATION

- BEFORE THE COMMENCEMENT OF ANY WORK, THE CONTRACTOR WILL ASSIGN A PROJECT MANAGER WHO WILL ACT AS A SINGLE POINT OF CONTACT FOR ALL PERSONNEL INVOLVED IN THIS PROJECT. THIS PROJECT MANAGER WILL BE DEVELOPING A MASTER SCHEDULE FOR THE PROJECT WHICH WILL BE SUBMITTED TO THE OWNER PRIOR TO THE COMMENCEMENT OF ANY WORK.
- 2. SUBMIT A BAR TYPE PROGRESS CHART NOT MORE THAN THREE (3) DAYS SUBMIT A BAR TYPE PROGRESS CHART NOT MORE THAN THREE (3) DATS AFTER THE DATE ESTABLISHED FOR COMMENCEMENT OF THE WORK ON THE SCHEDULE, INDICATING A TIME BAR FOR EACH MAJOR CATEGORY OF WORK TO BE PERFORMED AT THE SITE, PROPERLY SEQUENCED AND COORDINATED WITH OTHER ELEMENTS OF WORK AND SHOWING COMPLETION OF THE WORK SUFFICIENTLY IN ADVANCE OF THE DATE ESTABLISHED FOR SUBSTANTIAL COMPLETION OF THE SITE.
- PRIOR TO COMMENCING CONSTRUCTION, THE OWNER SHALL SCHEDULE AN ON-SITE MEETING WITH ALL MAJOR PARTIES. THIS WOULD INCLUDE BUT NOT LIMITED TO, THE OWNER, PROJECT MANAGER, CONTRACTOR, AND LAND OWNER REPRESENTATIVE.
- THE CONTRACTOR SHALL BE EQUIPPED WITH SOME MEANS OF CONSTANT COMMUNICATIONS, SUCH AS A MOBILE PHONE OR BEEPER. THIS EQUIPMENT WILL NOT BE SUPPLIED BY THE OWNER, NOR WILL
- 5. DURING CONSTRUCTION, THE CONTRACTOR MUST ENSURE THAT EMPLOYEES AND SUBCONTRACTORS WEAR HARD HATS AT ALL TIMES. THE CONTRACTOR WILL COMPLY WITH ALL SCG SAFETY REQUIREMENTS IN THEIR
- 6. PROVIDE WRITTEN DAILY UPDATES AND PHOTOGRAPHS OF ON-SITE PROGRESS TO THE PROJECT MANAGER VIA E-MAIL.
- 7. A COMPLETE INVENTORY OF CONSTRUCTION MATERIALS AND EQUIPMENT REQUIRED PRIOR TO THE START OF CONSTRUCTION
- NOTIFY THE OWNER / PROJECT MANAGER IN WRITING NO LESS THAN 48 HOURS IN ADVANCE OF CONCRETE POURS, TOWER ERECTIONS, AND EQUIPMENT CABINET PLACEMENTS.
- 9. CLOSEOUT PACKAGE IS DUE COMPLETE WITH DETAILED TOP PHOTOS UPON SITE PUNCHWALK WITH PROJECT MANAGER (SEE PROJECT MANAGER FOR SAMPLE CLOSEOUT PACKAGE).

WARRANTIES AND BONDS

- 1. THE CONTRACTOR IS RESPONSIBLE FOR APPLICATION AND PAYMENT
- 2. SEE MASTER CONTRACTOR SERVICES AGREEMENT FOR ADDITIONAL DETAILS.

GENERAL NOTES

1. IDEMNIFICATION CLAUSE: THE CONTRACTOR AGREES AND SHALL:

ASSUME SOLE AND COMPLETE RESPONSIBILITY OF THE JOBSITE CONDITIONS DURING THE COURSE OF CONSTRUCTION OF THIS PROJECT, INCLUDING THE SAFETY OF ALL PERSONS AND PROPERTIES. THAT THESE REQUIREMENTS SHALL APPLY CONTINUOUSLY AND NOT BE LIMITED TO NORMAL WORKING HOURS AND CONDITIONS. THE CONTRACTOR FURTHER AGREES TO DEFEND HOURS AND HOLD SOCAL GAS REPRESENTATIVES AND ENGINEERS HARMLESS FROM ANY AND ALL LIABILITY, REAL OR ALLEGED IN CONNECTION WITH THE PERFORMANCE OF THE WORK ON THIS PROJECT.

- PRIOR TO THE BEGINNING OF ANY CONSTRUCTION AND THROUGHOUT THE COURSE OF CONSTRUCTION WORK, THE CONTRACTOR SHALL FULLY COMPLY WITH "CALIFORNIA OCCUPATIONAL SAFETY AND HEALTH" ACT OF 1973 INCLUDING ALL REVISIONS AND AMENDMENTS THERETO
- 3. ALL WORK SHALL CONFORM TO THE LATEST EDITION OF GO 95, 128, AND THE STANDARD "SPECIFICATIONS FOR PUBLIC WORKS CONSTRUCTION", AS ADOPTED BY THE CITY, COUNTY OR STATE AS MODIFIED BY STANDARD PLANS AND ADDENDUM
- 4. THE EXISTENCE AND LOCATION OF UTILITIES AND OTHER AGENCIES
 FACILITIES AS SHOWN HEREON ARE OBTAINED BY A SEARCH OF AVAILABLE FACILITIES AS SHOWN HEREON ARE OBTAINED BY A SEARCH OF AVAILABLE RECORDS. OTHER FACILITIES MAY EXIST, THE CONTRACTOR SHALL VERIFY PRIOR TO THE START OF CONSTRUCTION AND SHALL USE EXTREME CARE AND PROTECTIVE MEASURES TO PREVENT DAMAGE TO THESE FACILITIES. THE CONTRACTOR IS RESPONSIBLE FOR THE PROTECTION OF ALL UTILITY OR AGENCY FACILITIES WITHIN THE LIMITS OF WORK, WHETHER THEY ARE SHOWN ON THIS PLAN OR NOT.
- 5. THE CONTRACTOR SHALL NOTIFY UNDERGROUND SERVICE ALERT (800) 227-2800, AT LEAST TWO WORKING DAYS PRIOR TO THE START OF
- 6. THE CONTRACTOR SHALL NOTIFY THE CITY, COUNTY OR STATE ENGINEER INSPECTION DEPARTMENT (213) 482-7030, AT LEAST TWO WORKING DAYS BEFORE THE START OF ANY WORK REQUIRING THEIR INVOLVEMENT.
- ALL WORK AREA AND STREET TRAFFIC CONTROL SHALL BE IN ACCORDANCE WITH THE SPECIFICATIONS OF THE WORK AREA TRAFFIC CONTROL BOOK AND SPECIFICATIONS FROM THE CITY, COUNTY OR STATE.
- 8. THE CITY, COUNTY OR STATE SHALL SPECIFY THE EXPIRATION PERIOD OF THE PERMIT FOR THIS CONSTRUCTION PROJECT.
- 9. THE MINIMUM COVER FOR ALL CONDUITS PLACED UNDERGROUND SHALL BE 36 INCHES TO THE FINISHED GRADE AT ALL TIMES.
- 10. ALL SHRUBS, PLANTS OR TREES THAT HAVE BEEN DAMAGED OR DISTURBED DURING THE COURSE OF THE WORK, SHALL BE REPLANTED AND/OR REPLACED SO AS TO RESTORE THE WORK SITE TO ITS ORIGINAL CONDITION.
- 11. VAULTS, PEDESTALS, CONDUITS AND OTHER TYPES OF SUBSTRUCTURE ARE VAULIS, FEDESTALS, CONDUITS AND OTHER TITES OF SUBSTRUCTURE ARE EITHER SPECIFIED ON THIS PLAN OR WILL BE SPECIFIED BY THE CONSTRUCTION ENGINEER. ANY AND ALL DEVIATIONS FROM THE SPECIFIED TYPES OF MATERIAL MUST BE APPROVED BY THE SYSTEM ENGINEER, IN
- ALL RECONSTRUCTION, RESURFACING, PAVEMENT DELINEATION AND OTHER IMPROVEMENTS ARE TO BE RESTORED TO THE SAME OR IMPROVED CONDITION BASED ON GENERAL NOTE NO. 3 ABOVE.

INSURANCE AND BONDS

- THE CONTRACTOR SHALL AT THEIR OWN EXPENSE CARRY AND MAINTAIN FOR THE DURATION OF THE PROJECT ALL INSURANCE AS REQUIRED AND LISTED.
- 2. THE CONTRACTOR SHALL NOT COMMENCE WITH THEIR WORK UNTIL THEY HAVE PRESENTED AN ORIGINAL CERTIFICATE OF INSURANCE STATING ALL COVERAGES TO THE OWNER
- 3. THE OWNER SHALL BE NAMED AS AN ADDITIONAL INSURED ON ALL POLICIES.
- 4. REFER TO THE MASTER AGREEMENT FOR REQUIRED INSURANCE LIMITS.

CLEAN UP

- 1. THE CONTRACTOR SHALL AT ALL TIMES KEEP THE SITE FREE FROM ACCUMULATION OF WASTE MATERIALS OR RUBBISH CAUSED BY THEIR EMPLOYEES AT WORK. AT THE COMPLETION OF THE WORK, THEY SHALL REMOVE ALL RUBBISH FROM AND ABOUT THE BUILDING AREA, INCLUDING ALL THEIR TOOLS, SCAFFOLDING AND SURPLUS MATERIALS AND SHALL LEAVE THEIR WORK CLEAN AND READY FOR USE.
- VISUALLY INSPECT EXTERIOR SURFACES AND REMOVE ALL TRACES OF SOIL, WASTE MATERIALS, SMUDGES AND OTHER FOREIGN MATTER.
- 3. REMOVE ALL TRACES OF SPLASHED MATERIALS FROM ADJACENT
- IF NECESSARY TO ACHIEVE A UNIFORM DEGREE OF CLEANLINESS, HOSE DOWN THE EXTERIOR OF THE STRUCTURE.

SUBSTANTIAL COMPLETION

- 1. SUBSTANTIAL COMPLETION IS THE STAGE OF WORK IS SUFFICIENTLY COMPLETE IN ACCORDANCE EITH THE CONTRACT SO THE OWNER CAN FULLY UTILIZE THE WORK FOR ITS INTENDED USE. SUCH TIME, CONTRACTOR SHALL SUBMIT TO OWNER A REQUEST FOR FINAL PAYMENT AND FINAL COMPLETION REPORT ITEMIZING AND DETAILED INVENTORY OF WORK TO COMPLETION AND AS-BUILT DOCUMENTS/DRAWINGS.
- OWNER WILL ONLY RELEASE FINAL PAYMENT UPON SATISFACTORY REVIEW AND CONTRACTOR COMPLIANCE OF THE FINAL PAYMENT REQUIREMENTS.

CONFLICTS

- THE CONTRACTOR SHALL BE RESPONSIBLE FOR VERIFICATION OF ALL MEASUREMENTS AT THE SITE BEFORE ORDERING ANY MATERIALS OR DOING ANY WORK. NO EXTRA CHARGE OR COMPENSATION SHALL BE ALLOWED DUE TO DIFFERENCE BETWEEN ACTUAL DIMENSIONS AND DIMENSIONS INDICATED IN THE CONSTRUCTION DRAWINGS. ANY SUCH DISCREPANCY IN DIMENSION WHICH MAY BE FOUND SHALL BE SUBMITTED TO THE OWNER FOR CONSIDERATION BEFORE THE CONTRACTOR PROCEEDS WITH THE WORK IN THE AFFECTED AREAS.
- 2. THE BIDDER, IF AWARDED THE CONTRACT, WILL NOT BE ALLOWED ANY EXTRA COMPENSATION BY REASON OF ANY MATTER OR THING CONCERNING WHICH BIDDER MIGHT HAVE FULLY INFORMED THEMSELVES PRIOR TO THE BIDDING.
- 3. NO PLEA OF IGNORANCE OF CONDITIONS THAT EXIST, OR OF DIFFICULTIES OR CONDITIONS THAT MAY BE ENCOUNTERED OR OF ANY OTHER RELEVANT MATTER CONCERNING THE WORK TO BE PERFORMED IN THE EXECUTION OF THE WORK WILL BE ACCEPTED AS AS EXCUSE FOR ANY FAILURE OR OMISSION ON THE PART OF THE CONTRACTOR TO FULFILL EVERY DETAIL OF ALL REQUIREMENTS OF THE CONTRACT DOCUMENTS GOVERNING THE WORK.

STRUCTURAL NOTES

1. DESIGN CRITERIA:

2013 CALIFORNIA BUILDING CODE. ASCE 7-10 MINIMUM DESIGN LOADS FOR BUILDINGS OTHER STRUCTURES. INTERNATIONAL BUILDING CODE (IBC) 2012 TIA-222 G STANDARD. 2009 AASHTO LTS - 5TH EDITION.

- 2. DURING CONSTRUCTION, THE CONTRACTOR SHALL NOTIFY THE ENGINEER DURING CONSTRUCTION, THE CONTRACTOR SHALL NOTIFY THE ENGINEER OF ANY UNUSUAL OR UNFORESEEN CONDITION PRIOR TO CONTINUING WITH CONSTRUCTION. SHOULD ANY CONDITION ARISE WHERE THE INTENT OF THE DRAWINGS IS IN DOUBT, OR WHERE THERE APPEARS TO BE DISCREPANCY BETWEEN THE DRAWINGS AND THE CONDITION IN THE FIELD, THE ENGINEER SHALL BE NOTIFIED PRIOR TO CONTINUING
- 3. PORTLAND CEMENT SHALL CONFORM TO ASTM C-150 TYPE II. AGGREGATE FOR STONE CONCRETE SHALL CONFORM TO ASTM C-33.
 AGGREGATE FOR LIGHTWEIGHT CONCRETE SHALL CONFORM TO ASTM C-330.
 AGGREGATE ASTM C-33: MAXIMUM SIZE 1 ½" FOR FOOTINGS AND 1" FOR ALL OTHER WORK.
- 4. ALL REINFORCING BARS, ANCHOR BOLTS, PRESTRESSING TENDONS AND ALL OTHER CONCRETE INSERTS SHALL BE WELL SECURED IN POSITION PRIOR TO PLACING CONCRETE.
- 5. THE MAXIMUM SLUMP SHALL BE BETWEEN THE RANGE OF 3" TO 5" FOR FOOTINGS, SLABS ON EARTH AND MASS CONCRETE

STANDARD SYMBOLS

	BUILDING
O	BOLLARD
CATV	CABLE TV LINE
<u>@</u>	CENTER LINE
	CONCRETE BLOCK WALL
====	CURB, GUTTER & SIDEWALK
	DRIVEWAY
—·—EOP—·—	EDGE OF PAVEMENT
$-\cdot -\!$	EDGE OF DIRT
EV	ELECTRIC VAULT
	FENCE
xx	CHAINLINK FENCE
•	FIRE HYDRANT
——— GAS ———	GAS LINE
	GAS VALVE
———GV———	GATE VALVE
×	GUY POLE
\otimes	JOINT POLE
MH	MANHOLE
OIL	OIL LINE
PWR	POWER LINE
——P——	PROPERTY LINE
РВ	PULLBOX
++++++++++	RAILROAD TRACK
	RETAINING WALL
ROW	RIGHT OF WAY
s	SANITARY SEWER
——SD——	STORM DRAIN LINE
STL	STREET LIGHT LINE
þ	STREET SIGN
	SERVICE PEDESTAL
TEL	TELCO LINE
——w——	WATER LINE
(VM)	WATER METER

05/25/15 ADONIS V. JAVIER A.J.

REVISED BY

EV. DATE

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ADVANCED METER THE GAS COMPANY TOWER 555 W. 5TH STREET LOS ANGELES, CA 90013

PROJECT INFORMATION:

26.3' CONCRETE POLE SOLAR, EMBEDDED


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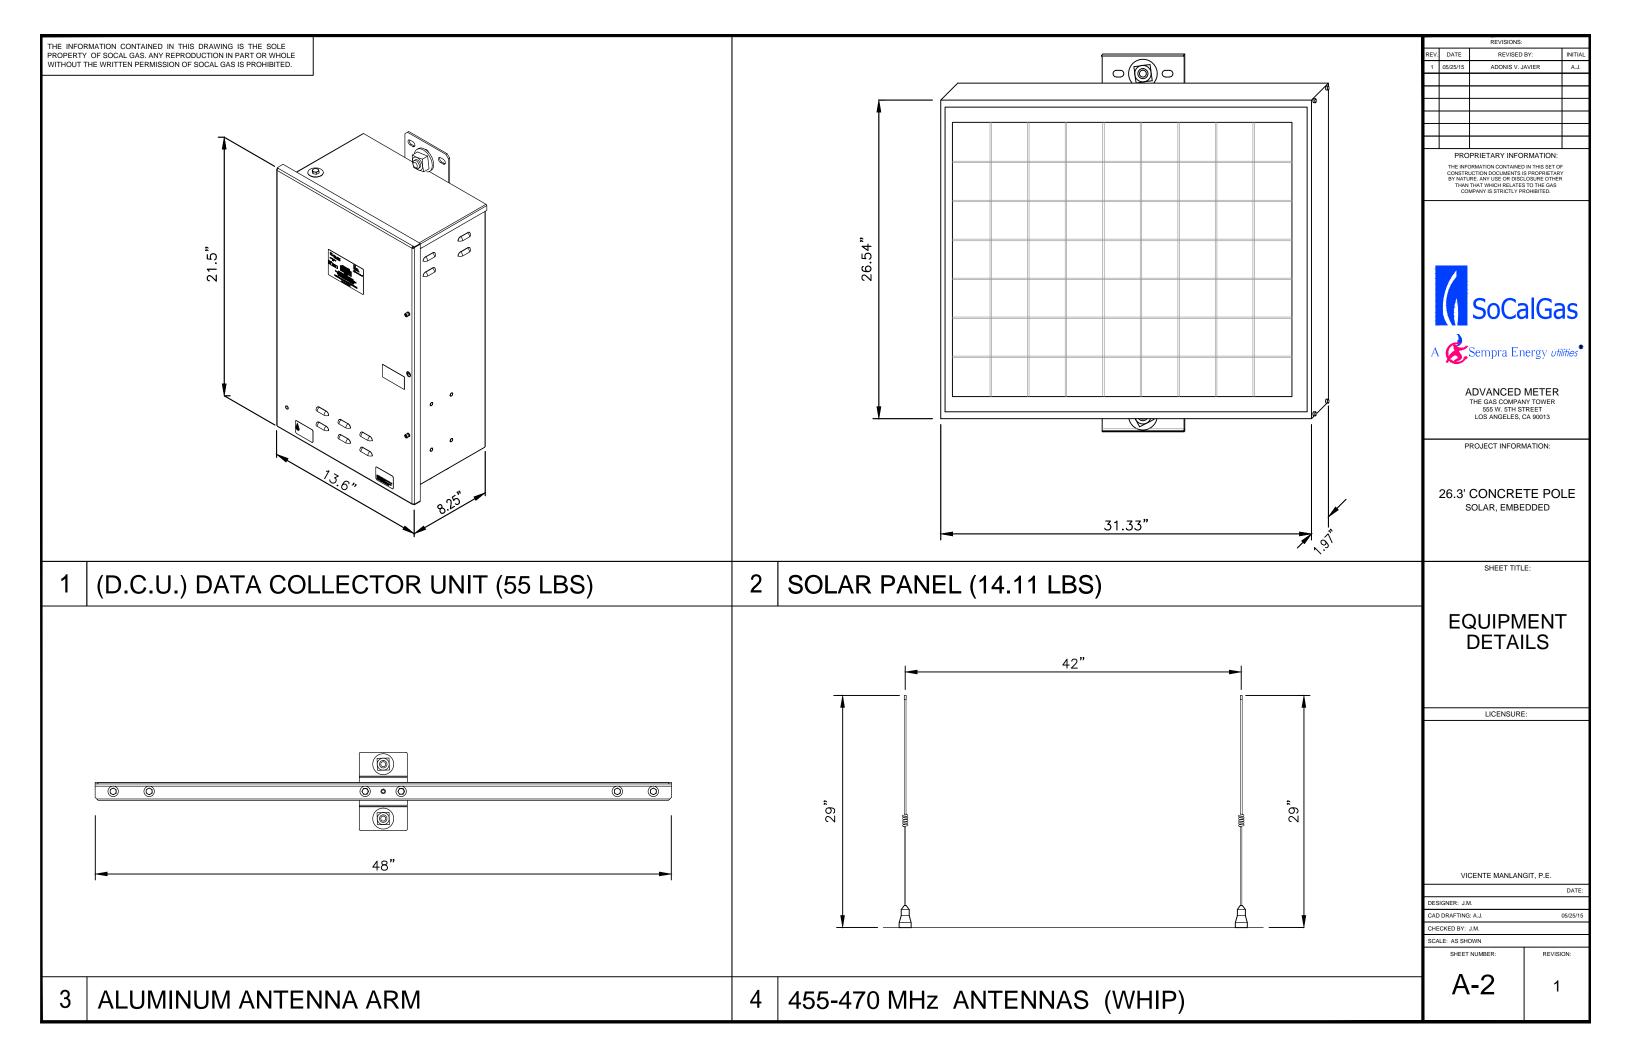
GENERAL NOTES & SYMBOLS


LICENSURE:

VICENTE MANI ANGIT P.E.

DATE DESIGNER: J.M. CAD DRAFTING: A.J 05/25/1 CHECKED BY: J.M. SCALE: AS SHOWN T-2




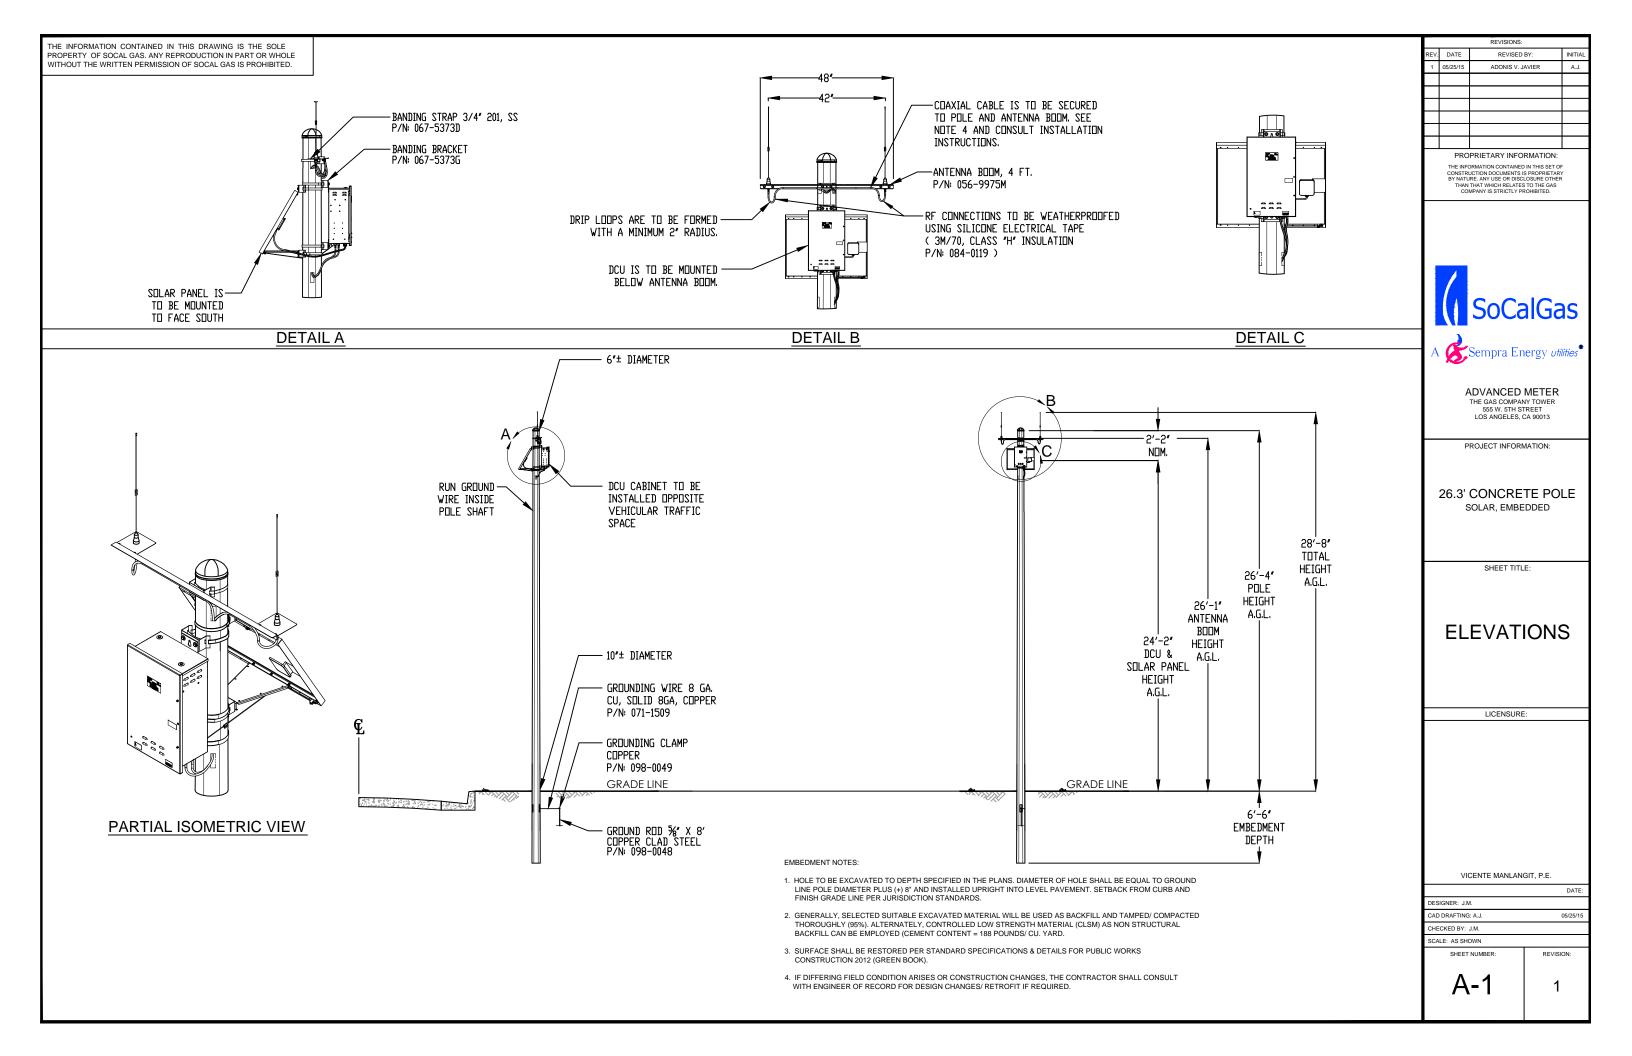

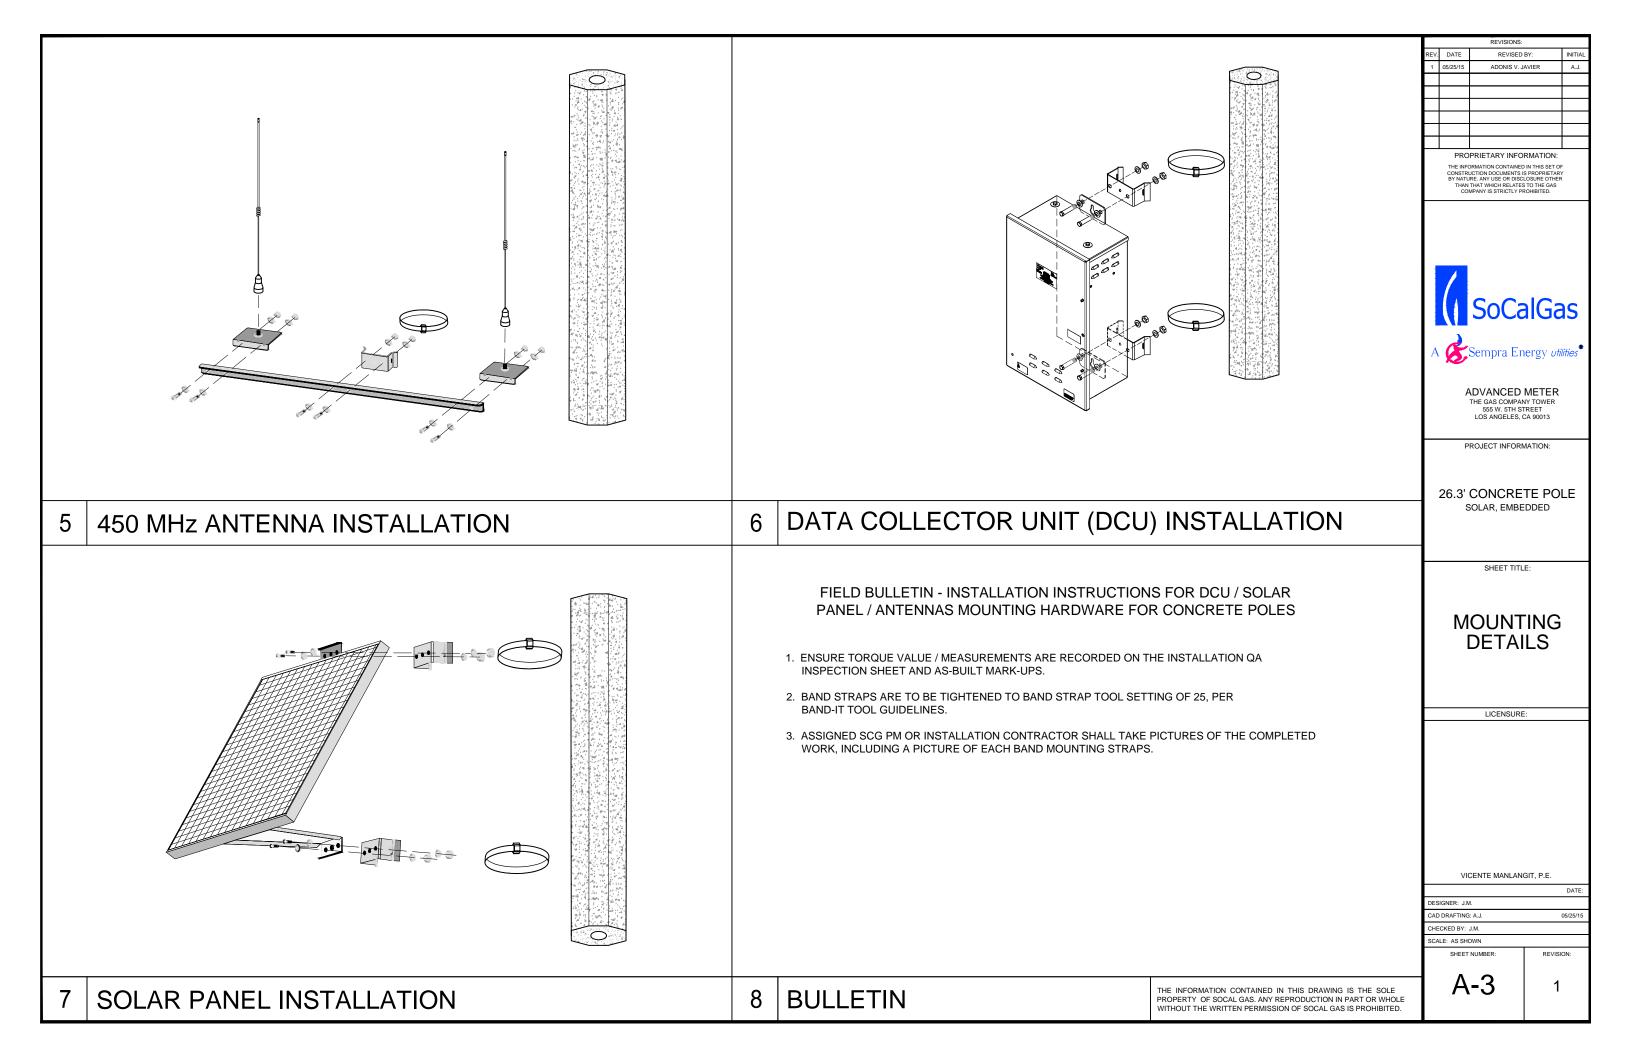

	MATERIALS LIST						
ITEM NO.	PART NUMBER	DESCRIPTION	QTY.				
1	501-9975VERST1R1-SCG	DCU, CELL, SOLAR PWR, SCG	1				
2	042-9975	BATTERY, 26 AMP HOUR, DCU 9975	1				
3	109-9975D	UHF ANT BASE ASSY	2				
4	EM-M10007	455-470MHz ANT,DCUII	2				
5	056-9975M	ANTENNA BOOM, 4 FT	1				
6	109-9975F65	65 W SOL PANEL W/ MNTG	1				
7	109-10700-02	MTG KIT, METAL/CONCRETE POLE, SOLAR	1				
	069-561832LS	5/16-18 X 1", HEX HEAD BOLT,SS	10				
	069-3304	5/16 " SPR LW, .32 ID X .59 OD, 18-8 SS	10				
	069-3305	5/16 F/WASH METAL, SS	10				
	069-3306	5/16-18 HEX NUT SS	10				
	067-5373D	BANDING CLAMP $\frac{3}{4}$ SS 201, UB256	5				
	067-5373G	BANDING BRACKET	5				
	067-5373C	BANDING STRAP $\frac{3}{4}$ " 201, SS	5				
	070-2570-10	10' LOW LOSS N-M TO N-M	2				
*8	098-0048	GROUND ROD, $\frac{5}{8}$ " X 8'	1				
*9	098-0049	GROUNDING CLAMP	1				
*10	071-1509	GROUNDING WIRE 8 GA, CU, SOLID	1				
*11	098-0050	GROUNDING WIRE SPLICE	1				
*12	098-0054	CABLE MGMT. BRACKETS (TRAP BOXES)	AS NEEDED				
*13	TBD	SNAP-IN CLAMP	AS NEEDED				
*14	098-0056	LMT-400 2 HOLE BOOM CLAMP	AS NEEDED				
*15	098-0057	LMT-400 4 HOLE BOOM CLAMP	AS NEEDED				
*16	084-0119	FUSION TAPE	AS NEEDED				
*17	TCP-360	½" CABLE SPACERS	2				
*18	*18 501-9975-SWKIT-01 DCU DOOR TAMPER SWITCH						
	*CONTRACTOR SUPPLIED MATERIALS						

FOR SMALL ENCLOSURE: 501-9975-SWKIT FOR LARGE ENCLOSURE: 501-9975-SWKIT-01

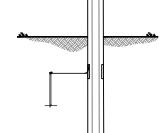

REV. DATE REVISED BY:

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ADVANCED METER
THE GAS COMPANY TOWER
555 W. 5TH STREET
LOS ANGELES, CA 90013

PROJECT INFORMATION:

26.3' CONCRETE POLE SOLAR, EMBEDDED

SHEET TITLE:

MATERIALS LIST

LICENSURE:

VICENTE MANLANGIT, P.E.


	DATE:
DESIGNER: J.M.	
CAD DRAFTING: A.J.	05/25/15
CHECKED BY: J.M.	
SCALE: AS SHOWN	
SHEET NUMBER:	REVISION:

A-4


NOTES:
1. MAXIMUM DCU CABINET WEIGHT NOT TO EXCEED 55# WITH BATTERIES.
2. ENCLOSURE RATED NEMA 3R.
3. DRAWING NOT TO SCALE.
4. RF COAXIAL CABLES ARE TO BE SECURED USING TRAP BOXES, STAINLESS STEEL BANDING, SNAP LOCKS, ETC.

NOTES:

- 1. LOAD AND VOLTAGE DROP CALCULATIONS MUST BE PERFORMED FOR SPECIFIC SITE DESIGN.
- 2. AERATE CONDUCTORS AS REQUIRED BY NEC.
- 3. ALL CONDUCTORS SHALL BE INSTALLED IN AN APPROVED RACEWAY.
- 4. ALL CONDUCTORS SHALL BE COPPER AND THHN/THWN RATED INSULATION
- 5. ALL OUTDOOR INSTALLATION SHALL BE IN AN OUTDOOR RATED ENCLOSURE.

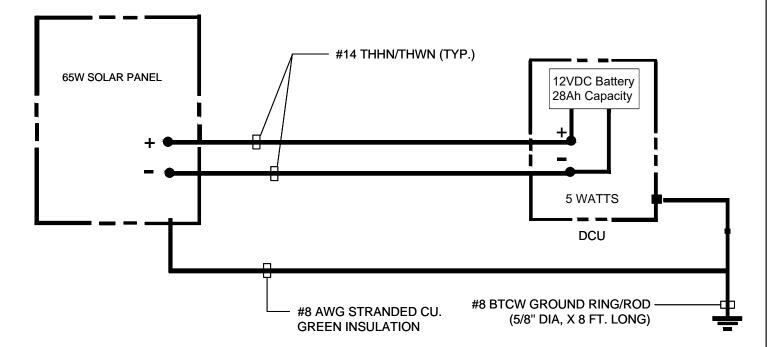

SOLAR POWER SOURCE

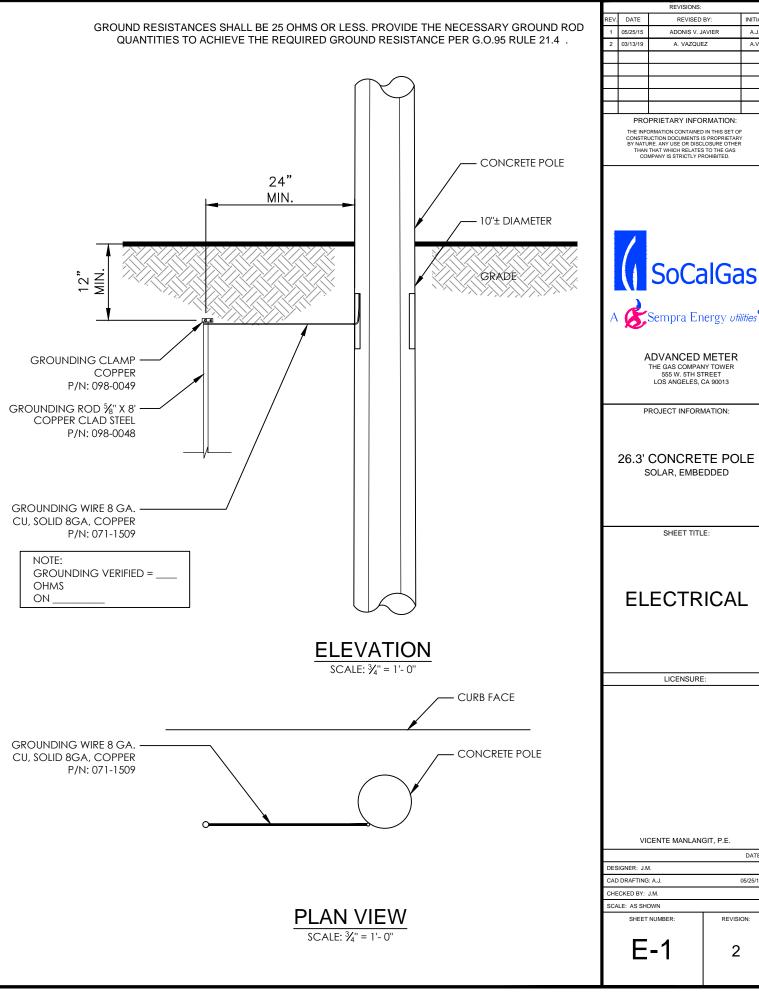



CITY: COUNTY: JURISDICTION: SITE NUMBER/ID: SITE TYPE:

(N) 29' A.G.L. WOOD POLE

SOLAR POWER, EMBEDDED SHEET INDEX:

SITE ADDRESS: SHEET NO: **DESCRIPTION:** VARIOUS APPLICANT: TITLE SHEET T-1 SOUTHERN CALIFORNIA GAS CO. 555 W. 5TH ST., 17TH FLOOR, LOS ANGELES, CA 90013 REPRESENTATIVE: OLIVIA GUTIERREZ PHONE: (213) 244-2201 GENERAL NOTES T-2 **ELEVATIONS** A-1 PROPERTY OWNER: **EQUIPMENT DETAILS** A-2 A-3 MOUNTING DETAILS A-4 MATERIALS LIST ELECTRICAL DIAGRAM PUBLIC RIGHT OF WAY LATITUDE: XX.YYYYYYYY LONGITUDE: -YYY.XXXXXXXX OCCUPANCY CLASSIFICATION: UTILITY/WIRELESS ANTENNA ZONING CLASSIFICATION: CONSTRUCTION TYPE: PROJECT DESCRIPTION: SOUTHERN CALIFORNIA GAS CO. PROPOSES TO INSTALL ACLARA EQUIPMENT MOUNTED ON A NEW CLASS 5. WOOD POLE, 29' ABOVE GROUND LEVEL

CONSULTING TEAM:

PROJECT SUMMARY:

SAC/ZONING/PERMITTING:

SOUTHERN CALIFORNIA GAS CO OLIVIA GUTIERREZ 555 W. 5TH ST., 17TH FLOOR LOS ANGELES, CA 90013

CONTRACTOR

(213) 244-2201

AM ORTEGA CONSTRUCTION 224 N. SHERMAN AVENUE. CORONA, CA 92882 PHONE: (951) 360-1352

CONSTRUCTION PROJECT MANAGER

SOUTHERN CALIFORNIA GAS CO. OLIVIA GUTIERREZ 555 W. 5TH ST., 17TH FLOOR LOS ANGELES, CA 90013 (213) 244-2201

NETWORK CONSTRUCTION ENGINEER

SOUTHERN CALIFORNIA GAS CO. JUAN MALDONADO 555 W. 5TH ST., 17TH FLOOR LOS ANGELES, CA 90013

APPROVALS:

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SIGNATURE

PRINT NAME

SAC REP.

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PRECON. MGR				
DEVELOP. MGR				
CONST. MGR				
PROJECT. MGR				
SR. RF ENGINEER				
RF ENGINEER			_	
OPERATIONS				







PERMIT #:

REVISION HISTORY

REVISION A: INITIAL DESIGN.

APPLICABLE CODES:

2015 GREENBOOK STANDARD SPECS. FOR PUBLIC WORKS CONSTRUCTION 2015 CITY CONSTRUCTION STANDARD DETAILS ANSI/TIA/EIA-222-F LIFE SAFETY CODE NFPA-101 2018 UNIFORM MECHANICAL CODE 2017 NATIONAL ELECTRIC CODE CITY/COUNTY ORDINANCES

REV.	DATE	REVISED BY:	INITIAL
Α	05/25/18	ADONIS JAVIER	A.J.
	DDC	ADDICTABY INCODMATION.	

PROPRIETARY INFORMATION:

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ADVANCED METER THE GAS COMPANY TOWER 555 W. 5TH STREET LOS ANGELES, CA 90013

PROJECT INFORMATION:

29' WOOD POLE CLASS 5, SOLAR

SHEET TITLE:

TITLE SHEET

LICENSURE:

SIGNER: J.M. AD DRAFTING: A.J. 05/25/18 HECKED BY: J.M. CALE: AS SHOWN SHEET NUMBER REVISION:

T-1

Α

INTENT

- THIS CONSTRUCTION DRAWINGS DESCRIBE THE WORK TO BE DONE AND THE MATERIALS TO BE FURNISHED FOR CONSTRUCTION.
- 2. THE INTENTION OF THE DOCUMENT IS TO INCLUDE ALL LABOR AND MATERIALS REASONABLY NECESSARY FOR THE PROPER EXECUTION AND COMPLETION OF THE WORK AS STIPULATED IN THE CONTRACT.
- 3. MINOR DEVIATIONS FROM THE DESIGN LAYOUT ARE ANTICIPATED AND SHALL BE CONSIDERED AS PART OF THE WORK. NO CHANGES THAT ALTER THE CHARACTER OF THE WORK WILL BE MADE OR PERMITTED BY THE OWNER WITHOUT ISSUING A CHANGE ORDER.
- 4. THE DRAWINGS ARE GRAPHIC AND PICTORIAL PORTIONS OF THE CONTRACT DOCUMENTS SHOWING THE DESIGN, LOCATION AND DIMENSIONS OF THE WORK, GENERALLY INCLUDING PLANS, ELEVATIONS, SECTIONS, DETAILS, SCHEDULES AND DIAGRAMS.
- IN CASE OF INCONSISTENCY BETWEEN OTHER PARTS OF THE CONTRACT, THE CONTRACTOR SHALL PERFORM THE WORK IN ACCORDANCE WITH THE OWNER'S INTERPRETATION.
- 6. WHERE DRAWINGS REFER TO STANDARD SPECIFICATIONS, THE LATEST OR MOST RECENT EDITION SHALL APPLY.

CHANGE ORDER PROCEDURE

1. CHANGE ORDER MAY BE INITIATED BY THE OWNER AND/OR THE CONTRACTOR INVOLVED. THE CONTRACTOR, UPON VERBAL REQUEST FROM THE OWNER SHALL PREPARE A WRITTEN PROPOSAL DESCRIBING THE CHANGE IN WORK OR MATERIALS AND ANY CHANGES IN THE CONTRACT AMOUNT AND PRESENT TO THE OWNER WITHIN 72 HOURS FOR APPROVAL. SUBMIT REQUESTS FOR SUBSTITUTIONS IN THE FORM AND IN ACCORDANCE WITH PROCEDURES REQUIRED FOR CHANGE ORDER PROPOSALS. ANY CHANGES IN THE SCOPE OF WORK OR MATERIALS WHICH ARE PERFORMED BY THE CONTRACTOR WITHOUT A WRITTEN CHANGE ORDER AS DESCRIBED AND APPROVED BY THE OWNER SHALL PLACE FULL RESPONSIBILITY OF THESE ACTIONS ON THE CONTRACTOR.

CODE COMPLIANCE

- ALL WORK SHALL BE IN ACCORDANCE WITH APPLICABLE LOCAL, STATE AND FEDERAL REGULATIONS. THESE SHALL INCLUDE BUT NOT BE LIMITED TO THE LATEST VERSION OF THE FOLLOWING:
 - 2015 GREENBOOK STANDARD SPECS. FOR PUBLIC WORKS CONSTRUCTION
 - 2015 CITY CONSTRUCTION STANDARD DETAILS 2016 CALIFORNIA BUILDING CODE
 - 2017 NATIONAL ELECTRIC CODE
 - 2018 UNIFORM MECHANICAL CODE
 - ANSI/TIA/EIA-222-F LIFE SAFETY CODE NFPA-101 CITY AND COUNTY ORDINANCES

ADMINISTRATION

- BEFORE THE COMMENCEMENT OF ANY WORK, THE CONTRACTOR WILL ASSIGN A PROJECT MANAGER WHO WILL ACT AS A SINGLE POINT OF CONTACT FOR ALL PERSONNEL INVOLVED IN THIS PROJECT. THIS PROJECT MANAGER WILL BE DEVELOPING A MASTER SCHEDULE FOR THE PROJECT WHICH WILL BE SUBMITTED TO THE OWNER PRIOR TO THE COMMENCEMENT OF ANY WORK.
- 2. SUBMIT A BAR TYPE PROGRESS CHART NOT MORE THAN THREE (3) DAYS AFTER THE DATE ESTABLISHED FOR COMMENCEMENT OF THE WORK ON THE SCHEDULE, INDICATING A TIME BAR FOR EACH MAJOR CATEGORY OF WORK TO BE PERFORMED AT THE SITE, PROPERLY SEQUENCED AND COORDINATED WITH OTHER ELEMENTS OF WORK AND SHOWING COMPLETION OF THE WORK SUFFICIENTLY IN ADVANCE OF THE DATE ESTABLISHED FOR SUBSTANTIAL COMPLETION OF THE SITE.
- PRIOR TO COMMENCING CONSTRUCTION, THE OWNER SHALL SCHEDULE AN ON-SITE MEETING WITH ALL MAJOR PARTIES. THIS WOULD INCLUDE BUT NOT LIMITED TO, THE OWNER, PROJECT MANAGER, CONTRACTOR, AND LAND OWNER REPRESENTATIVE.
- 4. THE CONTRACTOR SHALL BE EQUIPPED WITH SOME MEANS OF CONSTANT COMMUNICATIONS, SUCH AS A MOBILE PHONE OR BEEPER. THIS EQUIPMENT WILL NOT BE SUPPLIED BY THE OWNER, NOR WILL WIRELESS SERVICE BE ARRANGED.
- DURING CONSTRUCTION, THE CONTRACTOR MUST ENSURE THAT EMPLOYEES AND SUBCONTRACTORS WEAR HARD HATS AT ALL TIMES. THE CONTRACTOR WILL COMPLY WITH ALL SCG SAFETY REQUIREMENTS IN THEIR AGREEMENT.
- PROVIDE WRITTEN DAILY UPDATES AND PHOTOGRAPHS OF ON-SITE PROGRESS TO THE PROJECT MANAGER VIA E-MAIL.
- 7. A COMPLETE INVENTORY OF CONSTRUCTION MATERIALS AND EQUIPMENT IS REQUIRED PRIOR TO THE START OF CONSTRUCTION.
- NOTIFY THE OWNER / PROJECT MANAGER IN WRITING NO LESS THAN 48 HOURS IN ADVANCE OF CONCRETE POURS, TOWER ERECTIONS, AND EQUIPMENT CABINET PLACEMENTS.
- . CLOSEOUT PACKAGE IS DUE COMPLETE WITH DETAILED TOP PHOTOS UPON SITE PUNCHWALK WITH PROJECT MANAGER (SEE PROJECT MANAGER FOR SAMPLE CLOSEOUT PACKAGE).

WARRANTIES AND BONDS

- THE CONTRACTOR IS RESPONSIBLE FOR APPLICATION AND PAYMENT OF CONTRACTOR LICENSES AND BONDS.
- 2. SEE MASTER CONTRACTOR SERVICES AGREEMENT FOR ADDITIONAL DETAILS.

GENERAL NOTES

- 1. IDEMNIFICATION CLAUSE: THE CONTRACTOR AGREES AND SHALL:
 - ASSUME SOLE AND COMPLETE RESPONSIBILITY OF THE JOBSITE CONDITIONS DURING THE COURSE OF CONSTRUCTION OF THIS PROJECT, INCLUDING THE SAFETY OF ALL PERSONS AND PROPERTIES. THAT THESE REQUIREMENTS SHALL APPLY CONTINUOUSLY AND NOT BE LIMITED TO NORMAL WORKING HOURS AND CONDITIONS. THE CONTRACTOR FURTHER AGREES TO DEFEND INDEMNITY AND HOLD SOCAL GAS REPRESENTATIVES AND ENGINEERS HARMLESS FROM ANY AND ALL LIABILITY, REAL OR ALLEGED IN CONNECTION WITH THE PERFORMANCE OF THE WORK ON THIS PROJECT.
- PRIOR TO THE BEGINNING OF ANY CONSTRUCTION AND THROUGHOUT THE COURSE OF CONSTRUCTION WORK, THE CONTRACTOR SHALL FULLY COMPLY WITH "CALIFORNIA OCCUPATIONAL SAFETY AND HEALTH" ACT OF 1973 INCLUDING ALL REVISIONS AND AMENDMENTS THERETO.
- ALL WORK SHALL CONFORM TO THE LATEST EDITION OF GO 95, 128, AND THE STANDARD "SPECIFICATIONS FOR PUBLIC WORKS CONSTRUCTION", AS ADOPTED BY THE CITY, COUNTY OR STATE AS MODIFIED BY STANDARD PLANS AND ADDERDUM.
- 4. THE EXISTENCE AND LOCATION OF UTILITIES AND OTHER AGENCIES FACILITIES AS SHOWN HEREON ARE OBTAINED BY A SEARCH OF AVAILABLE RECORDS. OTHER FACILITIES MAY EXIST, THE CONTRACTOR SHALL VERIFY PRIOR TO THE START OF CONSTRUCTION AND SHALL USE EXTREME CARE AND PROTECTIVE MEASURES TO PREVENT DAMAGE TO THESE FACILITIES. THE CONTRACTOR IS RESPONSIBLE FOR THE PROTECTION OF ALL UTILITY OR AGENCY FACILITIES WITHIN THE LIMITS OF WORK, WHETHER THEY ARE SHOWN ON THIS PLAN OR NOT.
- THE CONTRACTOR SHALL NOTIFY UNDERGROUND SERVICE ALERT (800) 227-2600, AT LEAST TWO WORKING DAYS PRIOR TO THE START OF ANY EXCAVATION.
- THE CONTRACTOR SHALL NOTIFY THE CITY, COUNTY OR STATE ENGINEER INSPECTION DEPARTMENT (213) 482-7030, AT LEAST TWO WORKING DAYS BEFORE THE START OF ANY WORK REQUIRING THEIR INVOLVEMENT.
- ALL WORK AREA AND STREET TRAFFIC CONTROL SHALL BE IN ACCORDANCE WITH THE SPECIFICATIONS OF THE WORK AREA TRAFFIC CONTROL BOOK AND SPECIFICATIONS FROM THE CITY, COUNTY OR STATE.
- 8. THE CITY, COUNTY OR STATE SHALL SPECIFY THE EXPIRATION PERIOD OF THE PERMIT FOR THIS CONSTRUCTION PROJECT.
- 9. THE MINIMUM COVER FOR ALL CONDUITS PLACED UNDERGROUND SHALL BE 36 INCHES TO THE FINISHED GRADE AT ALL TIMES.
- 10. ALL SHRUBS, PLANTS OR TREES THAT HAVE BEEN DAMAGED OR DISTURBED DURING THE COURSE OF THE WORK, SHALL BE REPLANTED AND/OR REPLACED SO AS TO RESTORE THE WORK SITE TO ITS ORIGINAL CONDITION.
- 11. VAULTS, PEDESTALS, CONDUITS AND OTHER TYPES OF SUBSTRUCTURE ARE EITHER SPECIFIED ON THIS PLAN OR WILL BE SPECIFIED BY THE CONSTRUCTION ENGINEER. ANY AND ALL DEVIATIONS FROM THE SPECIFIED TYPES OF MATERIAL MUST BE APPROVED BY THE SYSTEM ENGINEER, IN WRITING BEFORE INSTALLATION THEREOF.
- 12. ALL RECONSTRUCTION, RESURFACING, PAVEMENT DELINEATION AND OTHER IMPROVEMENTS ARE TO BE RESTORED TO THE SAME OR IMPROVED CONDITION BASED ON GENERAL NOTE NO. 3 ABOVE.

INSURANCE AND BONDS

- THE CONTRACTOR SHALL AT THEIR OWN EXPENSE CARRY AND MAINTAIN FOR THE DURATION OF THE PROJECT ALL INSURANCE AS REQUIRED AND LISTED.
- THE CONTRACTOR SHALL NOT COMMENCE WITH THEIR WORK UNTIL THEY HAVE PRESENTED AN ORIGINAL CERTIFICATE OF INSURANCE STATING ALL COVERAGES TO THE OWNER.
- 3. THE OWNER SHALL BE NAMED AS AN ADDITIONAL INSURED ON ALL POLICIES.
- 4. REFER TO THE MASTER AGREEMENT FOR REQUIRED INSURANCE LIMITS.

CLEAN UP

- 1. THE CONTRACTOR SHALL AT ALL TIMES KEEP THE SITE FREE FROM ACCUMULATION OF WASTE MATERIALS OR RUBBISH CAUSED BY THEIR EMPLOYEES AT WORK. AT THE COMPLETION OF THE WORK, THEY SHALL REMOVE ALL RUBBISH FROM AND ABOUT THE BUILDING AREA, INCLUDING ALL THEIR TOOLS, SCAFFOLDING AND SURPLUS MATERIALS AND SHALL LEAVE THEIR WORK CLEAN AND READY FOR USE.
- 2. VISUALLY INSPECT EXTERIOR SURFACES AND REMOVE ALL TRACES OF SOIL, WASTE MATERIALS, SMUDGES AND OTHER FOREIGN MATTER.
- 3. REMOVE ALL TRACES OF SPLASHED MATERIALS FROM ADJACENT SURFACES.
- 4. IF NECESSARY TO ACHIEVE A UNIFORM DEGREE OF CLEANLINESS, HOSE DOWN THE EXTERIOR OF THE STRUCTURE.

SUBSTANTIAL COMPLETION

- 1. SUBSTANTIAL COMPLETION IS THE STAGE OF WORK IS SUFFICIENTLY COMPLETE IN ACCORDANCE EITH THE CONTRACT SO THE OWNER CAN FULLY UTILIZE THE WORK FOR ITS INTENDED USE. SUCH TIME, CONTRACTOR SHALL SUBMIT TO OWNER A REQUEST FOR FINAL PAYMENT AND FINAL COMPLETION REPORT ITEMIZING AND DETAILED INVENTORY OF WORK TO COMPLETION AND AS-BUILT DOCUMENTS/DRAWINGS.
- OWNER WILL ONLY RELEASE FINAL PAYMENT UPON SATISFACTORY REVIEW AND CONTRACTOR COMPLIANCE OF THE FINAL PAYMENT REQUIREMENTS.

CONFLICTS

- 1. THE CONTRACTOR SHALL BE RESPONSIBLE FOR VERIFICATION OF ALL MEASUREMENTS AT THE SITE BEFORE ORDERING ANY MATERIALS OR DOING ANY WORK. NO EXTRA CHARGE OR COMPENSATION SHALL BE ALLOWED DUE TO DIFFERENCE BETWEEN ACTUAL DIMENSIONS AND DIMENSIONS INDICATED IN THE CONSTRUCTION DRAWINGS. ANY SUCH DISCREPANCY IN DIMENSION WHICH MAY BE FOUND SHALL BE SUBMITTED TO THE OWNER FOR CONSIDERATION BEFORE THE CONTRACTOR PROCEEDS WITH THE WORK IN THE AFFECTED AREAS.
- THE BIDDER, IF AWARDED THE CONTRACT, WILL NOT BE ALLOWED ANY EXTRA COMPENSATION BY REASON OF ANY MATTER OR THING CONCERNING WHICH BIDDER MIGHT HAVE FULLY INFORMED THEMSELVES PRIOR TO THE BIDDING.
- 3. NO PLEA OF IGNORANCE OF CONDITIONS THAT EXIST, OR OF DIFFICULTIES OR CONDITIONS THAT MAY BE ENCOUNTERED OR OF ANY OTHER RELEVANT MATTER CONCERNING THE WORK TO BE PERFORMED IN THE EXECUTION OF THE WORK WILL BE ACCEPTED AS AS EXCUSE FOR ANY FAILURE OR OMISSION ON THE PART OF THE CONTRACTOR TO FULFILL EVERY DETAIL OF ALL REQUIREMENTS OF THE CONTRACT DOCUMENTS GOVERNING THE WORK.

STRUCTURAL NOTES


1. DESIGN CRITERIA:

2013 CALIFORNIA BUILDING CODE.
ASCE 7-10 MINIMUM DESIGN LOADS FOR BUILDINGS
OTHER STRUCTURES.
INTERNATIONAL BUILDING CODE (IBC) 2012
TIA-222 G STANDARD.
2013 AASHTO LTS - 6TH EDITION.

- DURING CONSTRUCTION, THE CONTRACTOR SHALL NOTIFY THE ENGINEER OF ANY UNUSUAL OR UNFORESEEN CONDITION PRIOR TO CONTINUING WITH CONSTRUCTION. SHOULD ANY CONDITION ARISE WHERE THE INTENT OF THE DRAWINGS IS IN DOUBT, OR WHERE THERE APPEARS TO BE DISCREPANCY BETWEEN THE DRAWINGS AND THE CONDITION IN THE FIELD, THE ENGINEER SHALL BE NOTIFIED PRIOR TO CONTINUING THE WORK.
- 3. PORTLAND CEMENT SHALL CONFORM TO ASTM C-150 TYPE II.
 AGGREGATE FOR STONE CONCRETE SHALL CONFORM TO ASTM C-33.
 AGGREGATE FOR LIGHTWEIGHT CONCRETE SHALL CONFORM TO ASTM C-330.
 AGGREGATE ASTM C-33: MAXIMUM SIZE 1 ½" FOR FOOTINGS AND
 1" FOR ALL OTHER WORK.
- 4. ALL REINFORCING BARS, ANCHOR BOLTS, PRESTRESSING TENDONS AND ALL OTHER CONCRETE INSERTS SHALL BE WELL SECURED IN POSITION PRIOR TO PLACING CONCRETE.
- THE MAXIMUM SLUMP SHALL BE BETWEEN THE RANGE OF 3" TO 5" FOR FOOTINGS, SLABS ON EARTH AND MASS CONCRETE.

STANDARD SYMBOLS

	BUILDING
•	BOLLARD
CATV	CABLE TV LINE
<u>-</u>	CENTER LINE
	CONCRETE BLOCK WALL
	CURB, GUTTER & SIDEWALK
	DRIVEWAY
—·—EOP—·—	EDGE OF PAVEMENT
— · —EOD— · —	EDGE OF DIRT
EV	ELECTRIC VAULT
	FENCE
x	CHAINLINK FENCE
•	FIRE HYDRANT
——— GAS ———	GAS LINE
	GAS VALVE
GV	GATE VALVE
×	GUY POLE
\otimes	JOINT POLE
MH	MANHOLE
OIL	OIL LINE
PWR	POWER LINE
——— R———	PROPERTY LINE
РВ	PULLBOX
++++++++++	RAILROAD TRACK
	RETAINING WALL
ROW	RIGHT OF WAY
s	SANITARY SEWER
sp	STORM DRAIN LINE
STL	STREET LIGHT LINE
þ	STREET SIGN
	SERVICE PEDESTAL
———TEL———	TELCO LINE
———w——	WATER LINE
(WM)	WATER METER

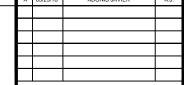

REVISED BY

DATE

PROPRIETARY INFORMATION:

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ADVANCED METER
THE GAS COMPANY TOWER
555 W. 5TH STREET
LOS ANGELES. CA 90013

Sempra Energy utility

PROJECT INFORMATION:

29' WOOD POLE CLASS 5, SOLAR

SHEET TITLE:

GENERAL NOTES & SYMBOLS

LICENSURE

DATE:

DESIGNER: J.M.

CAD DRAFTING: A.J.


CHECKED BY: J.M.


SCALE: AS SHOWN


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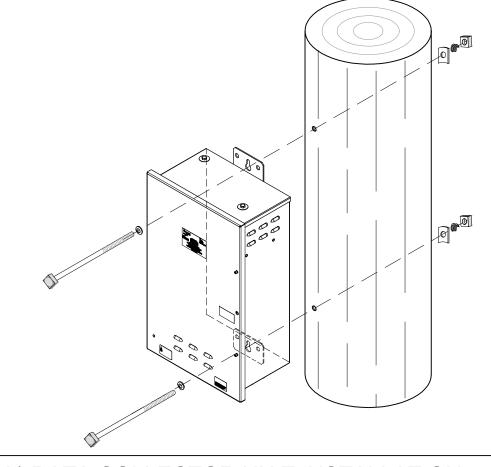
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		REVISIONS:	
REV.	DATE	REVISED BY:	INITIAL
Α	05/25/18	ADONIS JAVIER	A.J.
	DP∩	DDIETARY INFORMATION:	

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ADVANCED METER
THE GAS COMPANY TOWER
555 W. 5TH STREET
LOS ANGELES, CA 90013

PROJECT INFORMATION:

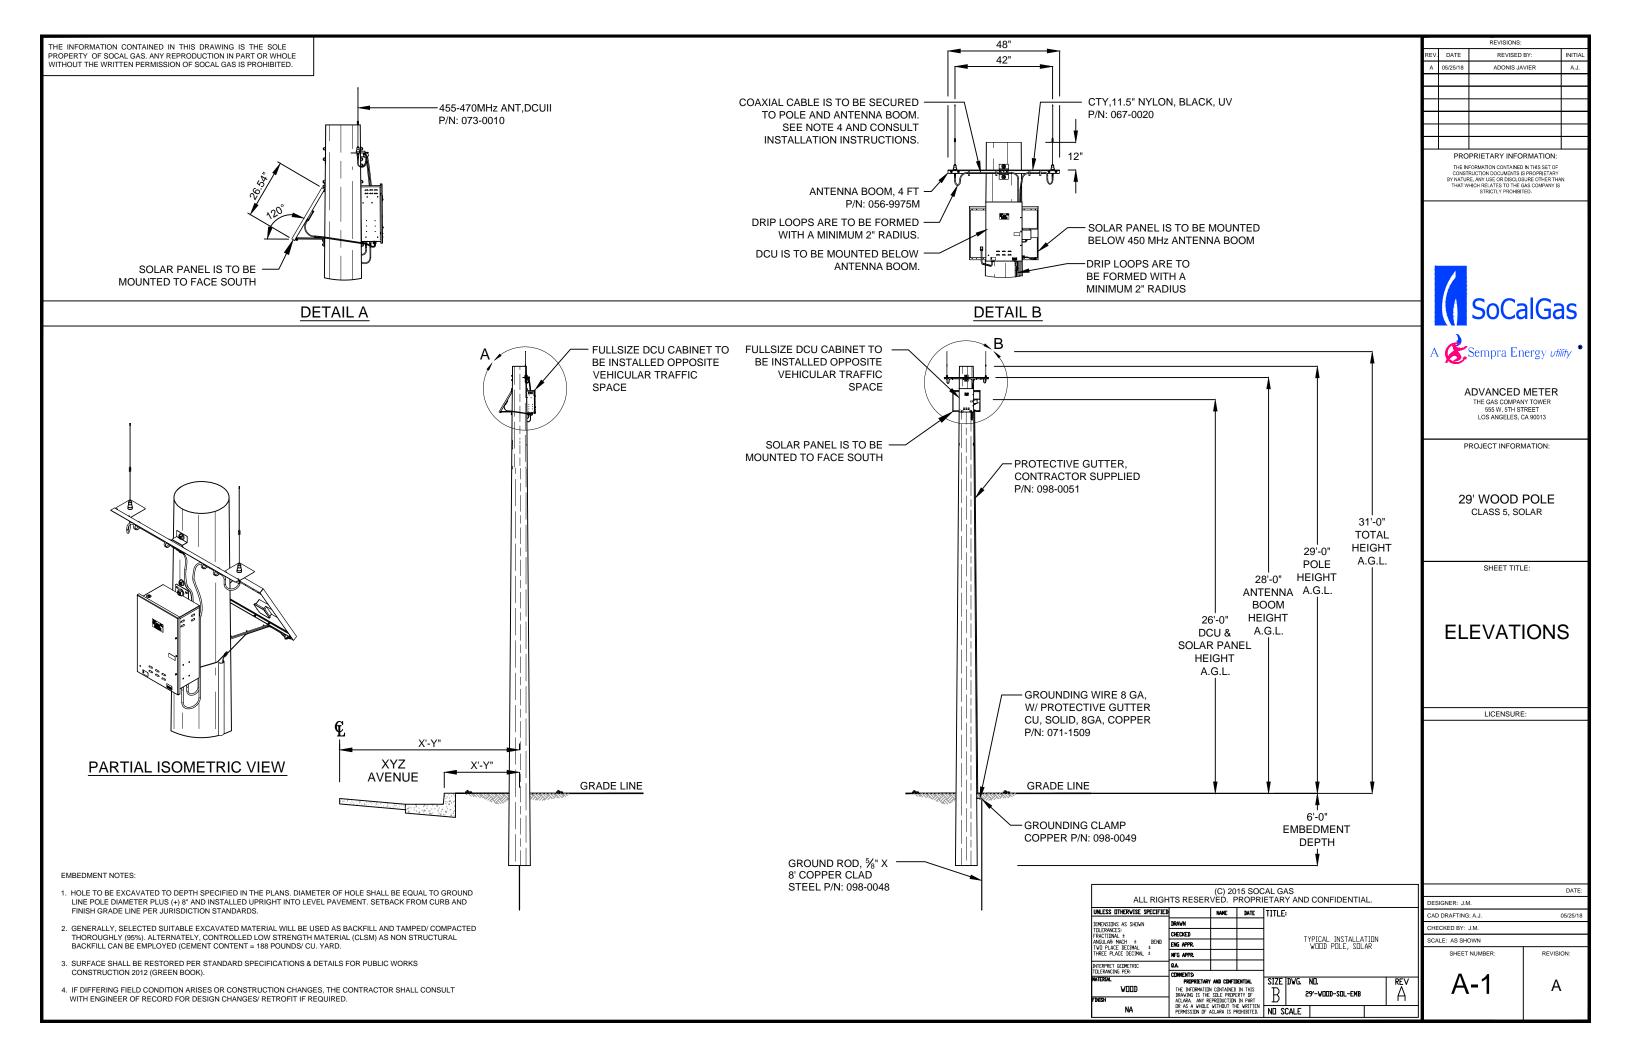29' WOOD POLE CLASS 5, SOLAR

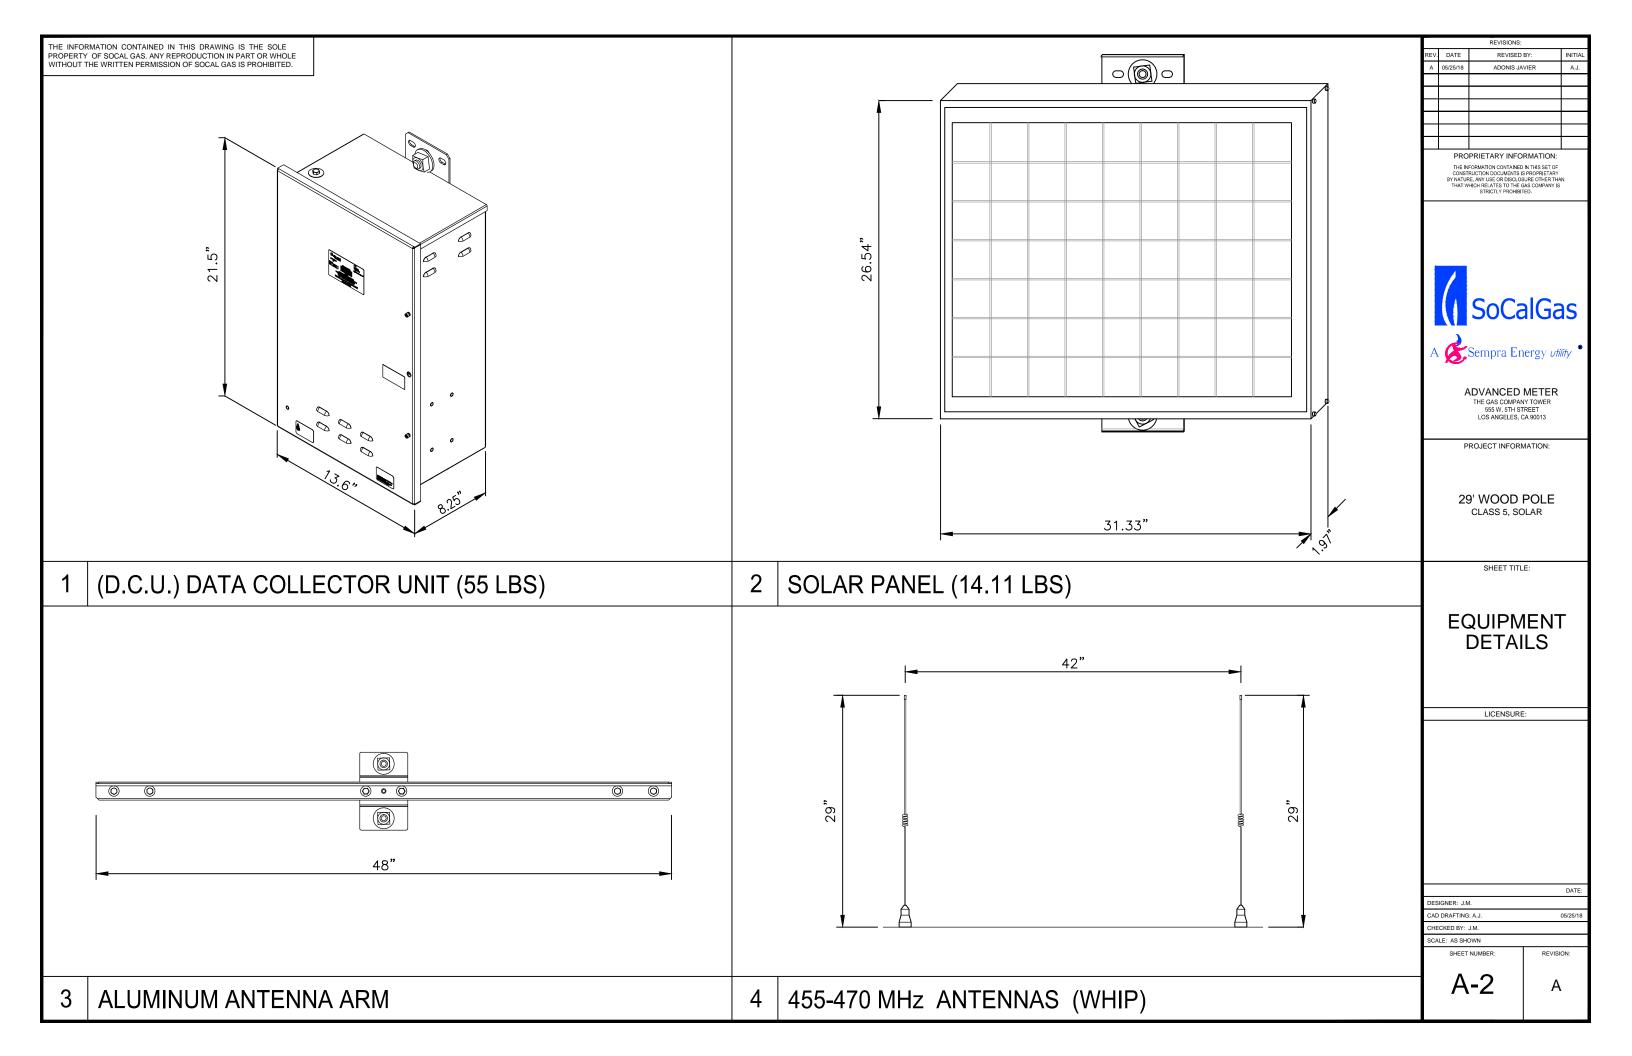LICENSURE:

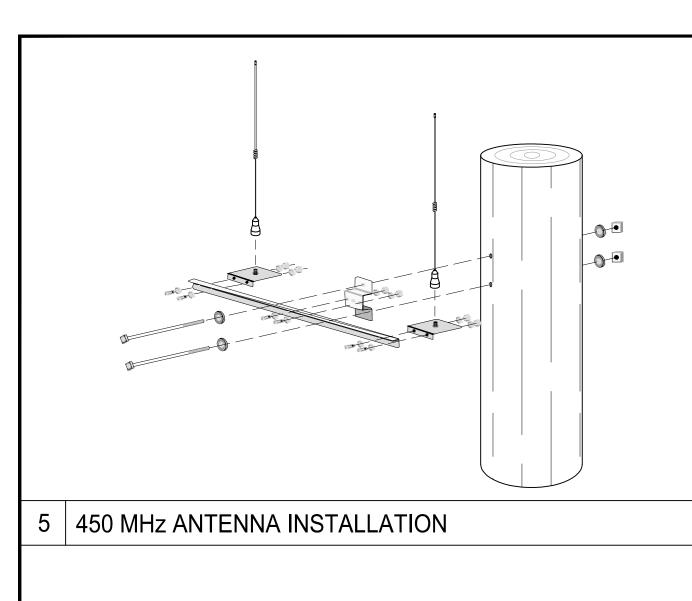SHEET TITLE: **MOUNTING DETAILS**

ESIGNER: J.M. AD DRAFTING: A.J. HECKED BY: J.M. CALE: AS SHOWN REVISION:

Α

A-3

(D.C.U.) DATA COLLECTOR UNIT INSTALLATION

FIELD BULLETIN - INSTALLATION INSTRUCTIONS FOR DCU / SOLAR PANEL / ANTENNAS MOUNTING HARDWARE FOR WOOD POLES


- 1. DCU AND SOLAR PANEL MOUNTING BOLTS SHALL BE TORQUED TO 60-70 FT. LBS., AND 450 MHz ANTENNA MOUNTING BOLTS SHALL BE TORQUED TO 9-15 FT. LBS. SEE SCG'S POLE MOUNT CELLULAR DCU INSTALLATION INSTRUCTIONS, Y20342-TUM,
- 2. APPLY LOCTITE THREAD LOCKER (PART #209728/BLUE 242) TO THE MOUNTING BOLT THREADS PRIOR TO PLACING THE NUT AND FINAL TORQUE APPLICATION.
- 3. SLIP MARK BOTH THE BOLT HEAD AND RETAINING NUT WITH APPLICABLE SLIP MARK MATERIAL (PART # 20G728/BLUE 242). SLIP MARK THE DCU, SOLAR PANEL AND THE 450 MHz ANTENNA BRACKET. SEE ATTACHMENT FOR SLIP PAINT SPECIFICATIONS.
- 4. ENSURE TORQUE VALUE/MEASUREMENTS ARE RECORDED ON THE INSTALLATION QA INSPECTION SHEET AND AS-BUILT MARK-UPS.
- ASSIGNED SCG PM OR INSTALLATION CONTRACTOR SHALL TAKE PICTURES OF THE COMPLETED WORK, INCLUDING PICTURES OF EACH MOUNTING BOLT.
- 6. THE RESPECTIVE INSTALLATION QA FORM, AS-BUILT MARK-UPS, AND ASSOCIATED PICTURES SHALL BE UPLOADED TO

SOLAR PANEL THROUGH POLE INSTALLATION

BULLETIN

THE INFORMATION CONTAINED IN THIS DRAWING IS THE SOLE PROPERTY OF SOCAL GAS. ANY REPRODUCTION IN PART OR WHOLE WITHOUT THE WRITTEN PERMISSION OF SOCAL GAS IS PROHIBITED.

		MATERIALS LIST				
ITEM NO	PART NUMBER	DESCRIPTION	QTY.			
1	501-9975VERST1R1-SCG	DCU, CELL, SOLAR PWR, SCG	1			
2	042-9975	BATTERY, 26 AMP HOUR, DCU 9975	1			
3	073-0010	455-470MHz ANT,DCUII	2			
4	EM-M10007	UHF ANT BASE ASSY	2			
5	109-9975F65	65W SOL PANEL W/ MNTG	1			
6	056-9975M	ANTENNA BOOM, 4 FT	1			
7	109-11700-01	MTG KIT, WOOD POLE, SOLAR	1			
	069-3306	5/16-18 HEX NUT SS	2			
	069-3305	5/16 F/WASH METAL,SS	2			
	069-3304	5/16 " SPR LW, .32 ID X .59 OD, 18-8 SS	2			
	069-561832LS	5/16-18 X 1", HEX HEAD BOLT,SS	2			
	067-9975F	BRKT,POLE MNTG	1			
	070-2570-06	6' LOW LOSS N-M TO N-M	2			
*8	067-0020	CTY,11.5" NYLON, BLACK, UV	4			
*9	071-1509	GROUNDING WIRE 8 GA, CU, SOLID	1			
*10	098-0051	PROTECTIVE GUTTER, CONTRACTOR SUPPLIED	1			
*11	098-0049	GROUNDING CLAMP	1			
*12	098-0050	GROUNDING WIRE SPLICE	1			
*13	098-0048	GROUND ROD, 5/8" X 8'	1			
*14	069-5801	5/8" FLAT WASHER, HD GALV	12			
*15	069-5811768-G	5/8"-11 THREADED ROD, HD GALV	6			
*16	069-5800	5/8"-11 THREADED NUT, HD GALV	12			
*17	TCP-360	½" CABLE SPACERS	AS NEEDED			
*18	CSS-100	CABLE STRAP, 10' w/ LCK HD	2			
*19	084-0119	FUSION TAPE	AS NEEDED			
*20	TBD	SQUARE WASHERS	6			
*21	TBD	5" SPRING COIL WASHER	6			
*22	TBD	5ੂ" X 5" LAG SCREW	AS NEEDED			
*23	TBD	WASHER, SQUARE, CURVED, GALV (SIZED AS REQ'D)	2			
*24	TBD	WASHER, DOUBLE COIL, SPRING, GALV (SIZED AS REQUIRED)	AS NEEDED			
	*CONTRACTOR SUPPLIED MATERIALS					

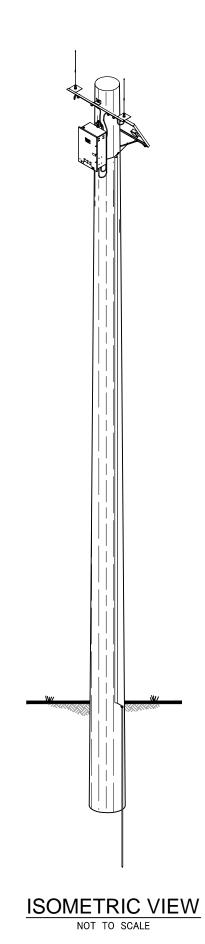

REVISIONS:						
REV.	DATE	REVISED BY:	INITIAL			
Α	05/25/18	ADONIS JAVIER	A.J.			

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ADVANCED METER
THE GAS COMPANY TOWER
555 W. 5TH STREET
LOS ANGELES, CA 90013

PROJECT INFORMATION:

29' WOOD POLE CLASS 5, SOLAR

SHEET TITLE:

MATERIALS LIST

LICENSURE:

ALL RIGHTS RESER			CAL GAS ETARY AND CONFIDENTIAL.
THERVISE SPECIFIED	NAME	DATE	TITLE:

UNLESS OTH DIMENSIONS AS SHOWN
TOLLERANCES:
FRACTIONAL ±
ANGULAR MACH ± BEND
TVO PLACE DECIMAL ±
THREE PLACE DECIMAL ± DRAWN CHECKED TYPICAL INSTALLATION WOOD POLE, SOLAR ENG APPR. INTERPRET GEDMETRIC TOLERANCING PER:

COMPANTS

COMPANTS

PRESENTARY AND CONTINENTIAL

THE INFORMATION CONTAINED IN THIS

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PROMISSION BY ALAWAS IS PROBINITED.


ND SCALE WOOD 29'-WOOD-SOL-EMB

	A-4	Α
	SHEET NUMBER:	REVISION:
1	SCALE: AS SHOWN	
-	CHECKED BY: J.M.	
-	CAD DRAFTING: A.J.	05/25/18
	DESIGNER: J.M.	
- 1		DATE:

NOTES:
1. MAXIMUM DCU CABINET WEIGHT NOT TO EXCEED 55# WITH BATTERIES.
2. ENCLOSURE RATED NEMA 3R.
3. DRAWING NOT TO SCALE.
4. RF COAXIAL CABLES ARE TO BE SECURED USING TRAP BOXES, STAINLESS STEEL BANDING, SNAP LOCKS, ETC.


NOTES:

- 1. LOAD AND VOLTAGE DROP CALCULATIONS MUST BE PERFORMED FOR SPECIFIC SITE DESIGN.
- 2. AERATE CONDUCTORS AS REQUIRED BY NEC.
- 3. ALL CONDUCTORS SHALL BE INSTALLED IN AN APPROVED RACEWAY.
- 4. ALL CONDUCTORS SHALL BE COPPER AND THHN/THWN RATED INSULATION
- 5. ALL OUTDOOR INSTALLATION SHALL BE IN AN OUTDOOR RATED ENCLOSURE.
- 6. GROUND RESISTANCES SHALL BE 25 OHMS OR LESS. PROVIDE THE NECESSARY GROUND ROD QUANTITIES TO ACHIEVE THE REQUIRED GROUND RESISTANCE.

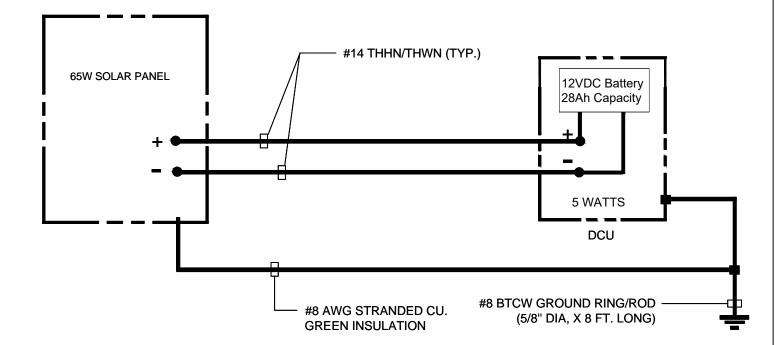

SOLAR POWER SOURCE

GROUND RESISTANCES SHALL BE 25 OHMS OR LESS. PROVIDE THE NECESSARY GROUND ROD QUANTITIES TO ACHIEVE THE REQUIRED GROUND RESISTANCE PER G.O.95 RULE 21.4 .

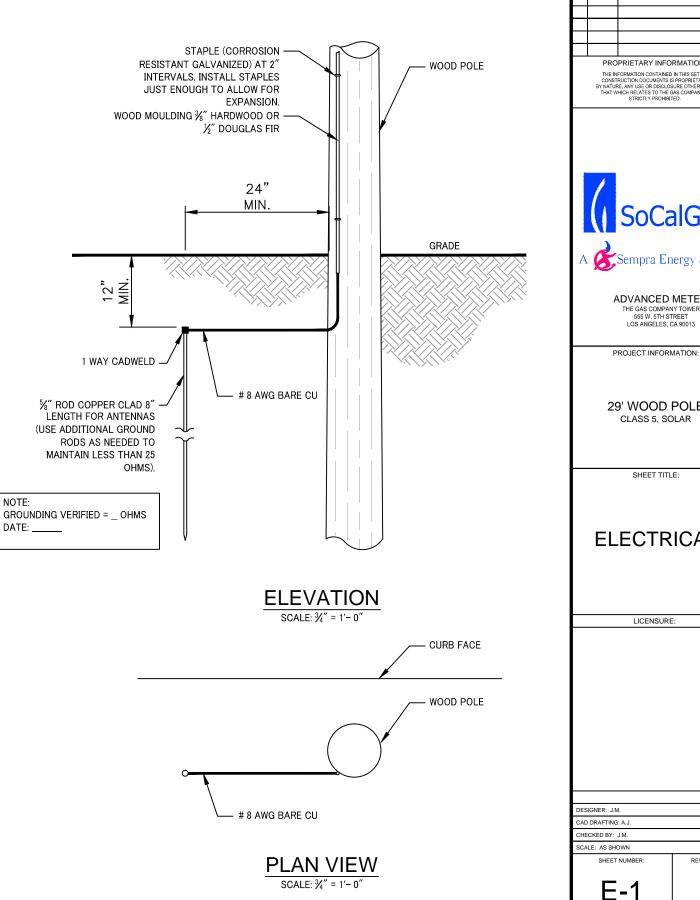

REV.	DATE	REVISED BY:	INITIAL
Α	05/25/18	ADONIS JAVIER	A.J.
	·		

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Sempra Energy utility

ADVANCED METER
THE GAS COMPANY TOWER
555 W. 5TH STREET
LOS ANGELES, CA 90013

29' WOOD POLE CLASS 5, SOLAR

ELECTRICAL

LICENSURE:

05/25/18

Α

REVISION:



CITY: COUNTY: JURISDICTION: SITE NUMBER/ID: SITE TYPE:

(N) 31' A.G.L. STEEL POLE SOLAR POWER, EMBEDDED

PROJECT SUMMARY: SHEET INDEX: **DESCRIPTION:** SITE ADDRESS: SHEET NO: VARIOUS APPLICANT: TITLE SHEET T-1 SOUTHERN CALIFORNIA GAS CO. 555 W. 5TH ST., 17TH FLOOR, LOS ANGELES, CA 90013 REPRESENTATIVE: VERONICA FISTES GENERAL NOTES T-2 ELEVATIONS PHONE: (213) 244-2297 A-1 DCU BOX DETAILS PROPERTY OWNER: A-2 A-3 **EQUIPMENT DETAILS**

E-1

PUBLIC RIGHT OF WAY

LATITUDE: XX.YYYYYYYY

LONGITUDE: -YYY.XXXXXXXX

OCCUPANCY CLASSIFICATION: UNMANNED UTILITY WIRELESS FACILITY

ZONING CLASSIFICATION:

CONSTRUCTION TYPE:

PROJECT DESCRIPTION:

SOUTHERN CALIFORNIA GAS CO. PROPOSES TO INSTALL ACLARA EQUIPMENT MOUNTED 28'-0" ABOVE GROUND LEVEL ON A NEW 31' A.G.L. STEEL POLE, EM32-850A370-85-FD.


BUILDING DEPARTMENT AND ANY CHANGES AND MODIFICATIONS THEY MAY IMPOSE.

PRINT NAME

MOUNTING DETAILS MATERIALS LIST

ELECTRICAL DIAGRAM

LANDLORD	PUBLIC R.O.W.		
PRECON. MGR			
DEVELOP. MGR			
CONST. MGR			
PROJECT. MGR			
SR. RF ENGINEER			
RF ENGINEER			

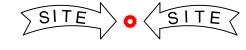

PERMIT #:

APPLICABLE CODES:

2015 GREENBOOK STANDARD SPECS. FOR PUBLIC WORKS CONSTRUCTION

2015 CITY CONSTRUCTION STANDARD DETAILS ANSI/TIA/FIA-222-F LIFE SAFETY CODE NEPA-101

2017 NATIONAL ELECTRIC CODE

CITY/COUNTY ORDINANCES





REVISION HISTORY

REVISION A: INITIAL DESIGN

	INEVISIONS.				
REV.	DATE	REVISED BY:	INITIAL		
Α	05/25/18	ADONIS JAVIER	A.J.		
	PRC	PRIETARY INFORMATION:			

CONSTRUCTION DOCUMENTS IS PROPRIETARY BY NATURE. ANY USE OR DISCLOSURE OTHER THAN THAT WHICH RELATES TO THE GAS COMPANY IS STRICTLY PROHIBITED.





ADVANCED METER THE GAS COMPANY TOWER 555 W. 5TH STREET LOS ANGELES, CA 90013

PROJECT INFORMATION:

31' STEEL POLE

EM210-900A370-PC-FP-HH-6' EMB-1" AH SOLAR, EMBEDDED

SHEET TITLE:

TITLE SHEET

LICENSURE:

DESIGNER: J.M. 05/25/18 CHECKED BY: J.M. SCALE: AS SHOWN

T-1

Α

CONSULTING TEAM: SAC/ZONING/PERMITTING: SOUTHERN CALIFORNIA GAS CO.

VERONICA FISTES LOS ANGELES, CA 90013 (213) 244-2297

CONTRACTOR

AM ORTEGA CONSTRUCTION CONTACT: SEAN RAMOS 224 N. SHERMAN AVENUE CORONA, CA 92882 PHONE: (951) 360-1352

CONSTRUCTION PROJECT MANAGER

SOUTHERN CALIFORNIA GAS CO. JUAN MALDONADO 555 W. 5TH ST., 17TH FLOOR LOS ANGELES, CA 90013 (213) 244-2324

NETWORK CONSTRUCTION ENGINEER

SOUTHERN CALIFORNIA GAS CO. JUAN MALDONADO 555 W. 5TH ST., 17TH FLOOR LOS ANGELES, CA 90013

APPROVALS:

SIGNATURE

THE FOLLOWING PARTIES HEREBY APPROVE AND ACCEPT THESE DOCUMENTS AND AUTHORIZE THE CONTRACTOR TO PROCEED WITH THE CONSTRUCTION DESCRIBED HEREIN. ALL CONSTRUCTION DOCUMENTS ARE SUBJECT TO REVIEW BY THE LOCAL

LANDLORD	PUBLIC R.O.W.	
PRECON. MGR		
DEVELOP. MGR		
CONST. MGR		
PROJECT. MGR		
SR. RF ENGINEER		
RF ENGINEER		
OPERATIONS		
SAC REP.		

INTENT

- THIS CONSTRUCTION DRAWINGS DESCRIBE THE WORK TO BE DONE AND THE MATERIALS TO BE FURNISHED FOR CONSTRUCTION.
- THE INTENTION OF THE DOCUMENT IS TO INCLUDE ALL LABOR AND MATERIALS REASONABLY NECESSARY FOR THE PROPER EXECUTION AND COMPLETION OF THE WORK AS STIPULATED IN THE CONTRACT.
- 3. MINOR DEVIATIONS FROM THE DESIGN LAYOUT ARE ANTICIPATED AND SHALL BE CONSIDERED AS PART OF THE WORK. NO CHANGES THAT ALTER THE CHARACTER OF THE WORK WILL BE MADE OR PERMITTED BY THE OWNER WITHOUT ISSUING A CHANGE ORDER.
- 4. THE DRAWINGS ARE GRAPHIC AND PICTORIAL PORTIONS OF THE CONTRACT DOCUMENTS SHOWING THE DESIGN, LOCATION AND DIMENSIONS OF THE WORK, GENERALLY INCLUDING PLANS, ELEVATIONS, SECTIONS, DETAILS, SCHEDULES AND DIAGRAMS.
- IN CASE OF INCONSISTENCY BETWEEN OTHER PARTS OF THE CONTRACT, THE CONTRACTOR SHALL PERFORM THE WORK IN ACCORDANCE WITH THE OWNER'S INTERPRETATION.
- 6. WHERE DRAWINGS REFER TO STANDARD SPECIFICATIONS, THE LATEST OR MOST RECENT EDITION SHALL APPLY.

CHANGE ORDER PROCEDURE

1. CHANGE ORDER MAY BE INITIATED BY THE OWNER AND/OR THE CONTRACTOR INVOLVED. THE CONTRACTOR, UPON VERBAL REQUEST FROM THE OWNER SHALL PREPARE A WRITTEN PROPOSAL DESCRIBING THE CHANGE IN WORK OR MATERIALS AND ANY CHANGES IN THE CONTRACT AMOUNT AND PRESENT TO THE OWNER WITHIN 72 HOURS FOR APPROVAL. SUBMIT REQUESTS FOR SUBSTITUTIONS IN THE FORM AND IN ACCORDANCE WITH PROCEDURES REQUIRED FOR CHANGE ORDER PROPOSALS. ANY CHANGES IN THE SCOPE OF WORK OR MATERIALS WHICH ARE PERFORMED BY THE CONTRACTOR WITHOUT A WRITTEN CHANGE ORDER AS DESCRIBED AND APPROVED BY THE OWNER SHALL PLACE FULL RESPONSIBILITY OF THESE ACTIONS ON THE CONTRACTOR.

CODE COMPLIANCE

 ALL WORK SHALL BE IN ACCORDANCE WITH APPLICABLE LOCAL, STATE AND FEDERAL REGULATIONS. THESE SHALL INCLUDE BUT NOT BE LIMITED TO THE LATEST VERSION OF THE FOLLOWING:

2015 GREENBOOK STANDARD SPECS. FOR PUBLIC WORKS CONSTRUCTION 2015 CITY CONSTRUCTION STANDARD DETAILS 2016 CALIFORNIA BUILDING CODE 2017 NATIONAL FLECTRIC CODE

ANSI/TIA/EIA-222-F LIFE SAFETY CODE NFPA-101 CITY AND COUNTY ORDINANCES

ADMINISTRATION

- BEFORE THE COMMENCEMENT OF ANY WORK, THE CONTRACTOR WILL ASSIGN A PROJECT MANAGER WHO WILL ACT AS A SINGLE POINT OF CONTACT FOR ALL PERSONNEL INVOLVED IN THIS PROJECT. THIS PROJECT MANAGER WILL BE DEVELOPING A MASTER SCHEDULE FOR THE PROJECT WHICH WILL BE SUBMITTED TO THE OWNER PRIOR TO THE COMMENCEMENT OF ANY WORK.
- 2. SUBMIT A BAR TYPE PROGRESS CHART NOT MORE THAN THREE (3) DAYS AFTER THE DATE ESTABLISHED FOR COMMENCEMENT OF THE WORK ON THE SCHEDULE, INDICATING A TIME BAR FOR EACH MAJOR CATEGORY OF WORK TO BE PERFORMED AT THE SITE, PROPERLY SEQUENCED AND COORDINATED WITH OTHER ELEMENTS OF WORK AND SHOWING COMPLETION OF THE WORK SUFFICIENTLY IN ADVANCE OF THE DATE ESTABLISHED FOR SUBSTANTIAL COMPLETION OF THE SITE.
- PRIOR TO COMMENCING CONSTRUCTION, THE OWNER SHALL SCHEDULE AN ON-SITE MEETING WITH ALL MAJOR PARTIES. THIS WOULD INCLUDE BUT NOT LIMITED TO, THE OWNER, PROJECT MANAGER, CONTRACTOR, AND LAND OWNER REPRESENTATIVE.
- 4. THE CONTRACTOR SHALL BE EQUIPPED WITH SOME MEANS OF CONSTANT COMMUNICATIONS, SUCH AS A MOBILE PHONE OR BEEPER. THIS EQUIPMENT WILL NOT BE SUPPLIED BY THE OWNER, NOR WILL WIRELESS SERVICE BE ARRANGED.
- DURING CONSTRUCTION, THE CONTRACTOR MUST ENSURE THAT EMPLOYEES AND SUBCONTRACTORS WEAR HARD HATS AT ALL TIMES. THE CONTRACTOR WILL COMPLY WITH ALL SCG SAFETY REQUIREMENTS IN THEIR AGREEMENT.
- 6. PROVIDE WRITTEN DAILY UPDATES AND PHOTOGRAPHS OF ON-SITE PROGRESS TO THE PROJECT MANAGER VIA E-MAIL.
- 7. A COMPLETE INVENTORY OF CONSTRUCTION MATERIALS AND EQUIPMENT IS REQUIRED PRIOR TO THE START OF CONSTRUCTION.
- NOTIFY THE OWNER / PROJECT MANAGER IN WRITING NO LESS THAN 48 HOURS IN ADVANCE OF CONCRETE POURS, TOWER ERECTIONS, AND EQUIPMENT CABINET PLACEMENTS.
- CLOSEOUT PACKAGE IS DUE COMPLETE WITH DETAILED TOP PHOTOS UPON SITE PUNCHWALK WITH PROJECT MANAGER (SEE PROJECT MANAGER FOR SAMPLE CLOSEOUT PACKAGE).

WARRANTIES AND BONDS

- THE CONTRACTOR IS RESPONSIBLE FOR APPLICATION AND PAYMENT OF CONTRACTOR LICENSES AND BONDS.
- 2. SEE MASTER CONTRACTOR SERVICES AGREEMENT FOR ADDITIONAL DETAILS.

GENERAL NOTES

1. IDEMNIFICATION CLAUSE: THE CONTRACTOR AGREES AND SHALL:

ASSUME SOLE AND COMPLETE RESPONSIBILITY OF THE JOBSITE CONDITIONS DURING THE COURSE OF CONSTRUCTION OF THIS PROJECT, INCLUDING THE SAFETY OF ALL PERSONS AND PROPERTIES. THAT THESE REQUIREMENTS SHALL APPLY CONTINUOUSLY AND NOT BE LIMITED TO NORMAL WORKING HOURS AND CONDITIONS. THE CONTRACTOR FURTHER AGREES TO DEFEND INDEMNITY AND HOLD SOCAL GAS REPRESENTATIVES AND ENGINEERS HARMLESS FROM ANY AND ALL LIABILITY, REAL OR ALLEGED IN CONNECTION WITH THE PERFORMANCE OF THE WORK ON THIS PROJECT.

- PRIOR TO THE BEGINNING OF ANY CONSTRUCTION AND THROUGHOUT THE COURSE OF CONSTRUCTION WORK, THE CONTRACTOR SHALL FULLY COMPLY WITH "CALIFORNIA OCCUPATIONAL SAFETY AND HEALTH" ACT OF 1973 INCLUDING ALL REVISIONS AND AMENDMENTS THERETO.
- ALL WORK SHALL CONFORM TO THE LATEST EDITION OF GO 95, 128, AND THE STANDARD "SPECIFICATIONS FOR PUBLIC WORKS CONSTRUCTION", AS ADOPTED BY THE CITY, COUNTY OR STATE AS MODIFIED BY STANDARD PLANS AND ADDENDUM.
- 4. THE EXISTENCE AND LOCATION OF UTILITIES AND OTHER AGENCIES FACILITIES AS SHOWN HEREON ARE OBTAINED BY A SEARCH OF AVAILABLE RECORDS. OTHER FACILITIES MAY EXIST, THE CONTRACTOR SHALL VERIFY PRIOR TO THE START OF CONSTRUCTION AND SHALL USE EXTREME CARE AND PROTECTIVE MEASURES TO PREVENT DAMAGE TO THESE FACILITIES. THE CONTRACTOR IS RESPONSIBLE FOR THE PROTECTION OF ALL UTILITY OR AGENCY FACILITIES WITHIN THE LIMITS OF WORK, WHETHER THEY ARE SHOWN ON THIS PLAN OR NOT.
- THE CONTRACTOR SHALL NOTIFY UNDERGROUND SERVICE ALERT (800) 227-2600, AT LEAST TWO WORKING DAYS PRIOR TO THE START OF ANY EXCAVATION.
- THE CONTRACTOR SHALL NOTIFY THE CITY, COUNTY OR STATE ENGINEER INSPECTION DEPARTMENT (213) 482-7030, AT LEAST TWO WORKING DAYS BEFORE THE START OF ANY WORK REQUIRING THEIR INVOLVEMENT.
- ALL WORK AREA AND STREET TRAFFIC CONTROL SHALL BE IN ACCORDANCE WITH THE SPECIFICATIONS OF THE WORK AREA TRAFFIC CONTROL BOOK AND SPECIFICATIONS FROM THE CITY, COUNTY OR STATE.
- 8. THE CITY, COUNTY OR STATE SHALL SPECIFY THE EXPIRATION PERIOD OF THE PERMIT FOR THIS CONSTRUCTION PROJECT.
- THE MINIMUM COVER FOR ALL CONDUITS PLACED UNDERGROUND SHALL BE 36 INCHES TO THE FINISHED GRADE AT ALL TIMES.
- 10. ALL SHRUBS, PLANTS OR TREES THAT HAVE BEEN DAMAGED OR DISTURBED DURING THE COURSE OF THE WORK, SHALL BE REPLANTED AND/OR REPLACED SO AS TO RESTORE THE WORK SITE TO ITS ORIGINAL CONDITION.
- 11. VAULTS, PEDESTALS, CONDUITS AND OTHER TYPES OF SUBSTRUCTURE ARE EITHER SPECIFIED ON THIS PLAN OR WILL BE SPECIFIED BY THE CONSTRUCTION ENGINEER. ANY AND ALL DEVATIONS FROM THE SPECIFIED TYPES OF MATERIAL MUST BE APPROVED BY THE SYSTEM ENGINEER, IN WINTING DECODE INSTALLATION THEFORE
- ALL RECONSTRUCTION, RESURFACING, PAVEMENT DELINEATION AND OTHER IMPROVEMENTS ARE TO BE RESTORED TO THE SAME OR IMPROVED CONDITION BASED ON GENERAL NOTE NO. 3 ABOVE.

INSURANCE AND BONDS

- THE CONTRACTOR SHALL AT THEIR OWN EXPENSE CARRY AND MAINTAIN FOR THE DURATION OF THE PROJECT ALL INSURANCE AS REQUIRED AND LISTED.
- 2. THE CONTRACTOR SHALL NOT COMMENCE WITH THEIR WORK UNTIL THEY HAVE PRESENTED AN ORIGINAL CERTIFICATE OF INSURANCE STATING ALL COVERAGES TO THE OWNER
- 3. THE OWNER SHALL BE NAMED AS AN ADDITIONAL INSURED ON ALL POLICIES.
- 4. REFER TO THE MASTER AGREEMENT FOR REQUIRED INSURANCE LIMITS.

CLEAN UP

- THE CONTRACTOR SHALL AT ALL TIMES KEEP THE SITE FREE FROM ACCUMULATION OF WASTE MATERIALS OR RUBBISH CAUSED BY THEIR EMPLOYEES AT WORK. AT THE COMPLETION OF THE WORK, THEY SHALL REMOVE ALL RUBBISH FROM AND ABOUT THE BUILDING AREA, INCLUDING ALL THEIR TOOLS, SCAFFOLDING AND SURPLUS MATERIALS AND SHALL LEAVE THEIR WORK CLEAN AND READY FOR USE.
- 2. VISUALLY INSPECT EXTERIOR SURFACES AND REMOVE ALL TRACES OF SOIL, WASTE MATERIALS, SMUDGES AND OTHER FOREIGN MATTER.
- 3. REMOVE ALL TRACES OF SPLASHED MATERIALS FROM ADJACENT SURFACES.
- 4. IF NECESSARY TO ACHIEVE A UNIFORM DEGREE OF CLEANLINESS, HOSE DOWN THE EXTERIOR OF THE STRUCTURE.

SUBSTANTIAL COMPLETION

- 1. SUBSTANTIAL COMPLETION IS THE STAGE OF WORK IS SUFFICIENTLY COMPLETE IN ACCORDANCE EITH THE CONTRACT SO THE OWNER CAN FULLY UTILIZE THE WORK FOR ITS INTENDED USE. SUCH TIME, CONTRACTOR SHALL SUBMIT TO OWNER A REQUEST FOR FINAL PAYMENT AND FINAL COMPLETION REPORT ITEMIZING AND DETAILED INVENTORY OF WORK TO COMPLETION AND AS-BUILT DOCUMENTS/DRAWINGS.
- OWNER WILL ONLY RELEASE FINAL PAYMENT UPON SATISFACTORY REVIEW AND CONTRACTOR COMPLIANCE OF THE FINAL PAYMENT REQUIREMENTS.

CONFLICTS

- 1. THE CONTRACTOR SHALL BE RESPONSIBLE FOR VERIFICATION OF ALL MEASUREMENTS AT THE SITE BEFORE ORDERING ANY MATERIALS OR DOING ANY WORK. NO EXTRA CHARGE OR COMPENSATION SHALL BE ALLOWED DUE TO DIFFERENCE BETWEEN ACTUAL DIMENSIONS AND DIMENSIONS INDICATED IN THE CONSTRUCTION DRAWINGS. ANY SUCH DISCREPANCY IN DIMENSION WHICH MAY BE FOUND SHALL BE SUBMITTED TO THE OWNER FOR CONSIDERATION BEFORE THE CONTRACTOR PROCEEDS WITH THE WORK IN THE AFFECTED AREAS.
- THE BIDDER, IF AWARDED THE CONTRACT, WILL NOT BE ALLOWED ANY EXTRA COMPENSATION BY REASON OF ANY MATTER OR THING CONCERNING WHICH BIDDER MIGHT HAVE FULLY INFORMED THEMSELVES PRIOR TO THE BIDDING.
- 3. NO PLEA OF IGNORANCE OF CONDITIONS THAT EXIST, OR OF DIFFICULTIES OR CONDITIONS THAT MAY BE ENCOUNTERED OR OF ANY OTHER RELEVANT MATTER CONCERNING THE WORK TO BE PERFORMED IN THE EXECUTION OF THE WORK WILL BE ACCEPTED AS AS EXCUSE FOR ANY FAILURE OR OMISSION ON THE PART OF THE CONTRACTOR TO FULFILL EVERY DETAIL OF ALL REQUIREMENTS OF THE CONTRACT DOCUMENTS GOVERNING THE WORK.

STRUCTURAL NOTES

1. DESIGN CRITERIA:

2016 CALIFORNIA BUILDING CODE.
ASCE 7-10 MINIMUM DESIGN LOADS FOR BUILDINGS
OTHER STRUCTURES.
INTERNATIONAL BUILDING CODE (IBC) 2015
TIA-222 G STANDARD.

TIA-222 G STANDARD. 2018 AASHTO LTS - 7TH EDITION. G.O.95

- DURING CONSTRUCTION, THE CONTRACTOR SHALL NOTIFY THE ENGINEER OF ANY UNUSUAL OR UNFORESEEN CONDITION PRIOR TO CONTINUING WITH CONSTRUCTION. SHOULD ANY CONDITION ARISE WHERE THE INTENT OF THE DRAWINGS IS IN DOUBT, OR WHERE THERE APPEARS TO BE DISCREPANCY BETWEEN THE DRAWINGS AND THE CONDITION IN THE FIELD, THE ENGINEER SHALL BE NOTIFIED PRIOR TO CONTINUING THE WORK.
- 3. PORTLAND CEMENT SHALL CONFORM TO ASTM C-150 TYPE II.
 AGGREGATE FOR STONE CONCRETE SHALL CONFORM TO ASTM C-33.
 AGGREGATE FOR LIGHTWEIGHT CONCRETE SHALL CONFORM TO ASTM C-330.
 AGGREGATE ASTM C-33: MAXIMUM SIZE 1 ½" FOR FOOTINGS AND
 1" FOR ALL OTHER WORK.
- 4. ALL REINFORCING BARS, ANCHOR BOLTS, PRESTRESSING TENDONS AND ALL OTHER CONCRETE INSERTS SHALL BE WELL SECURED IN POSITION PRIOR TO PLACING CONCRETE.
- 5. THE MAXIMUM SLUMP SHALL BE BETWEEN THE RANGE OF 3" TO 5" FOR FOOTINGS, SLABS ON EARTH AND MASS CONCRETE.

STANDARD SYMBOLS

	BUILDING
0	BOLLARD
CATV	CABLE TV LINE
¢	CENTER LINE
	CONCRETE BLOCK WALL
E≡≡≡d	CURB, GUTTER & SIDEWALK
	DRIVEWAY
— · —EOP— · —	EDGE OF PAVEMENT
— · —EOD— · —	EDGE OF DIRT
EV	ELECTRIC VAULT
	FENCE
x	CHAINLINK FENCE
•	FIRE HYDRANT
——— GAS ———	GAS LINE
	GAS VALVE
———GV———	GATE VALVE
×	GUY POLE
\otimes	JOINT POLE
MH	MANHOLE
OIL	OIL LINE
PWR	POWER LINE
——— P.———	PROPERTY LINE
РВ	PULLBOX
+++++++++	RAILROAD TRACK
	RETAINING WALL
ROW	RIGHT OF WAY
——s——	SANITARY SEWER
———SD———	STORM DRAIN LINE
STL	STREET LIGHT LINE
þ	STREET SIGN
	SERVICE PEDESTAL
TEL	TELCO LINE
w	WATER LINE
WM)	WATER METER

A 05/25/18 ADONIS JAVIER A.J.

REVISED BY

REV. DATE

PROPRIETARY INFORMATION:

THE INFORMATION CONTAINED IN THIS SET OF CONSTRUCTION DOCUMENTS IS PROPRIETARY BY NATURE. ANY USE OR DISCLOSURE OTHER THAN THAT WHICH RELATES TO THE GAS COMPANY IS STRICTLY PROHIBITED.



Sempra Energy *utilities*

ADVANCED METER
THE GAS COMPANY TOWER
555 W. 5TH STREET
LOS ANGELES, CA 90013

PROJECT INFORMATION:

31' STEEL POLE

EM210-900A370-PC-FP-HH-6' EMB-1" AF <u>SOLAR, EMBEDDED</u>

SHEET TITLE:

GENERAL NOTES & SYMBOLS

LICENSURE:

DATE:

DESIGNER: J.M.


CAD DRAFTING: A.J. 05/25/18


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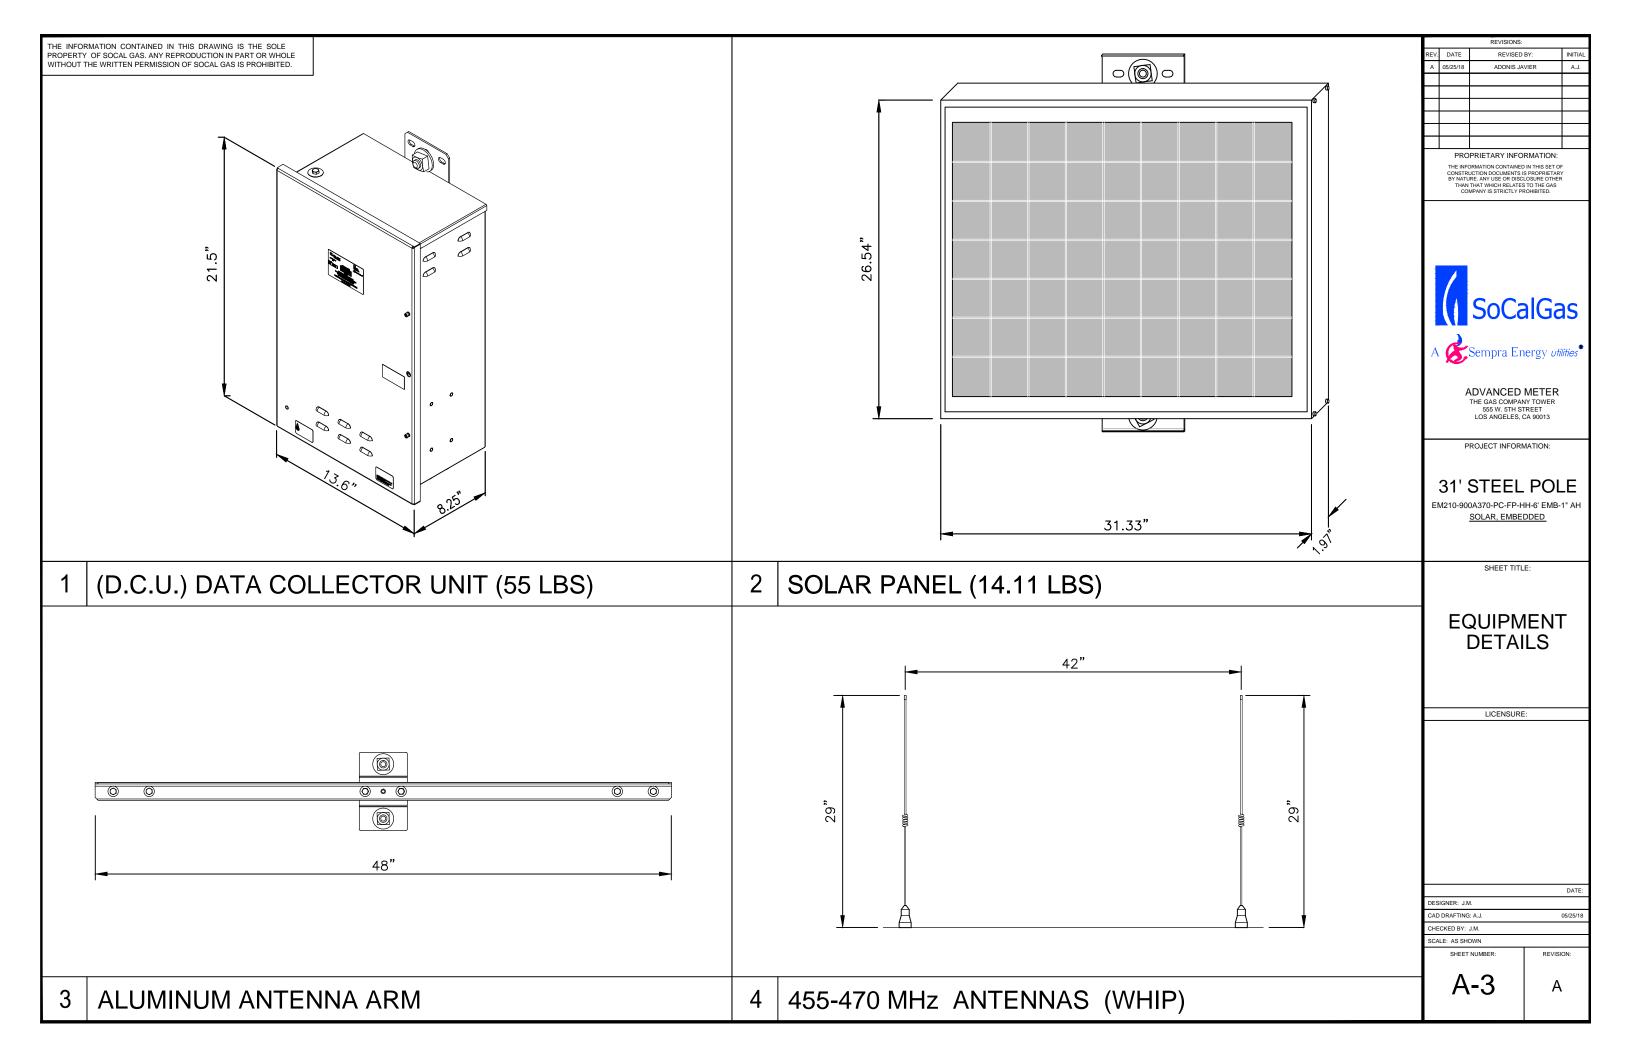
SCALE: AS SHOWN


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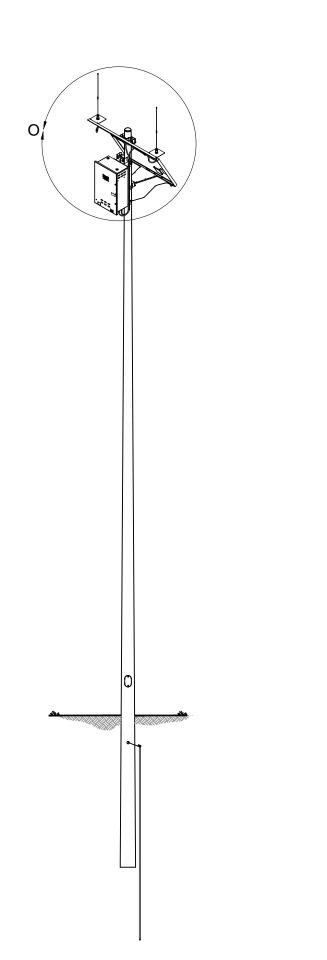







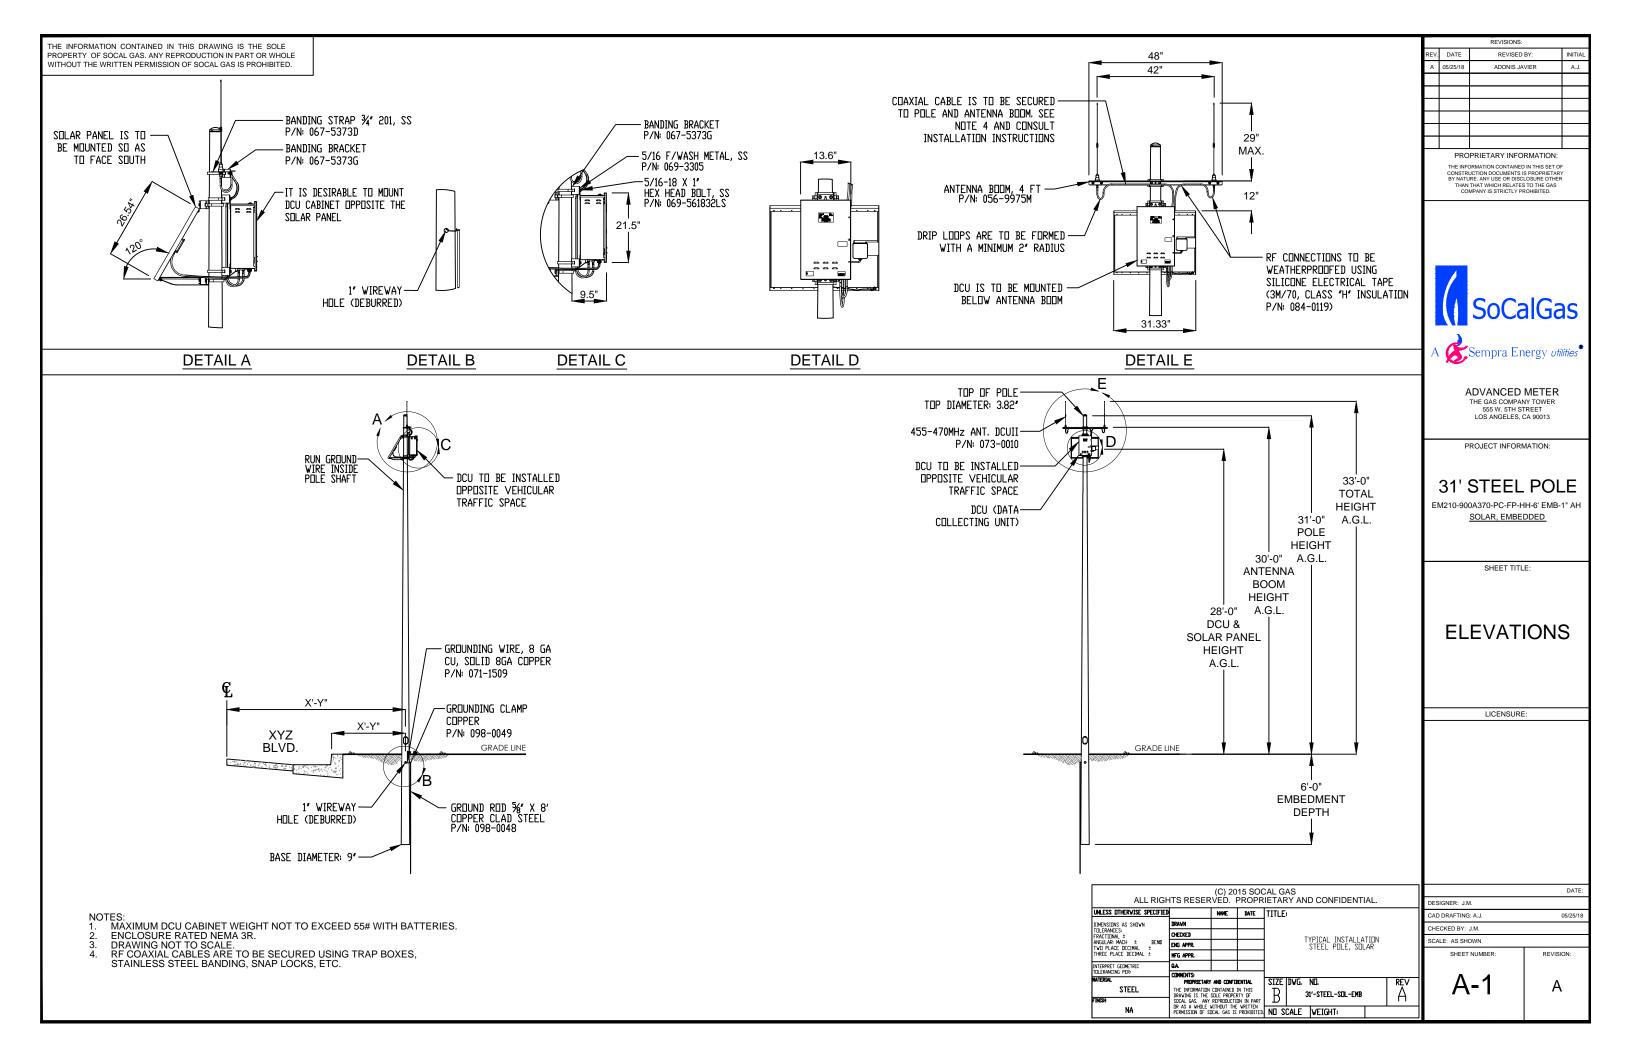

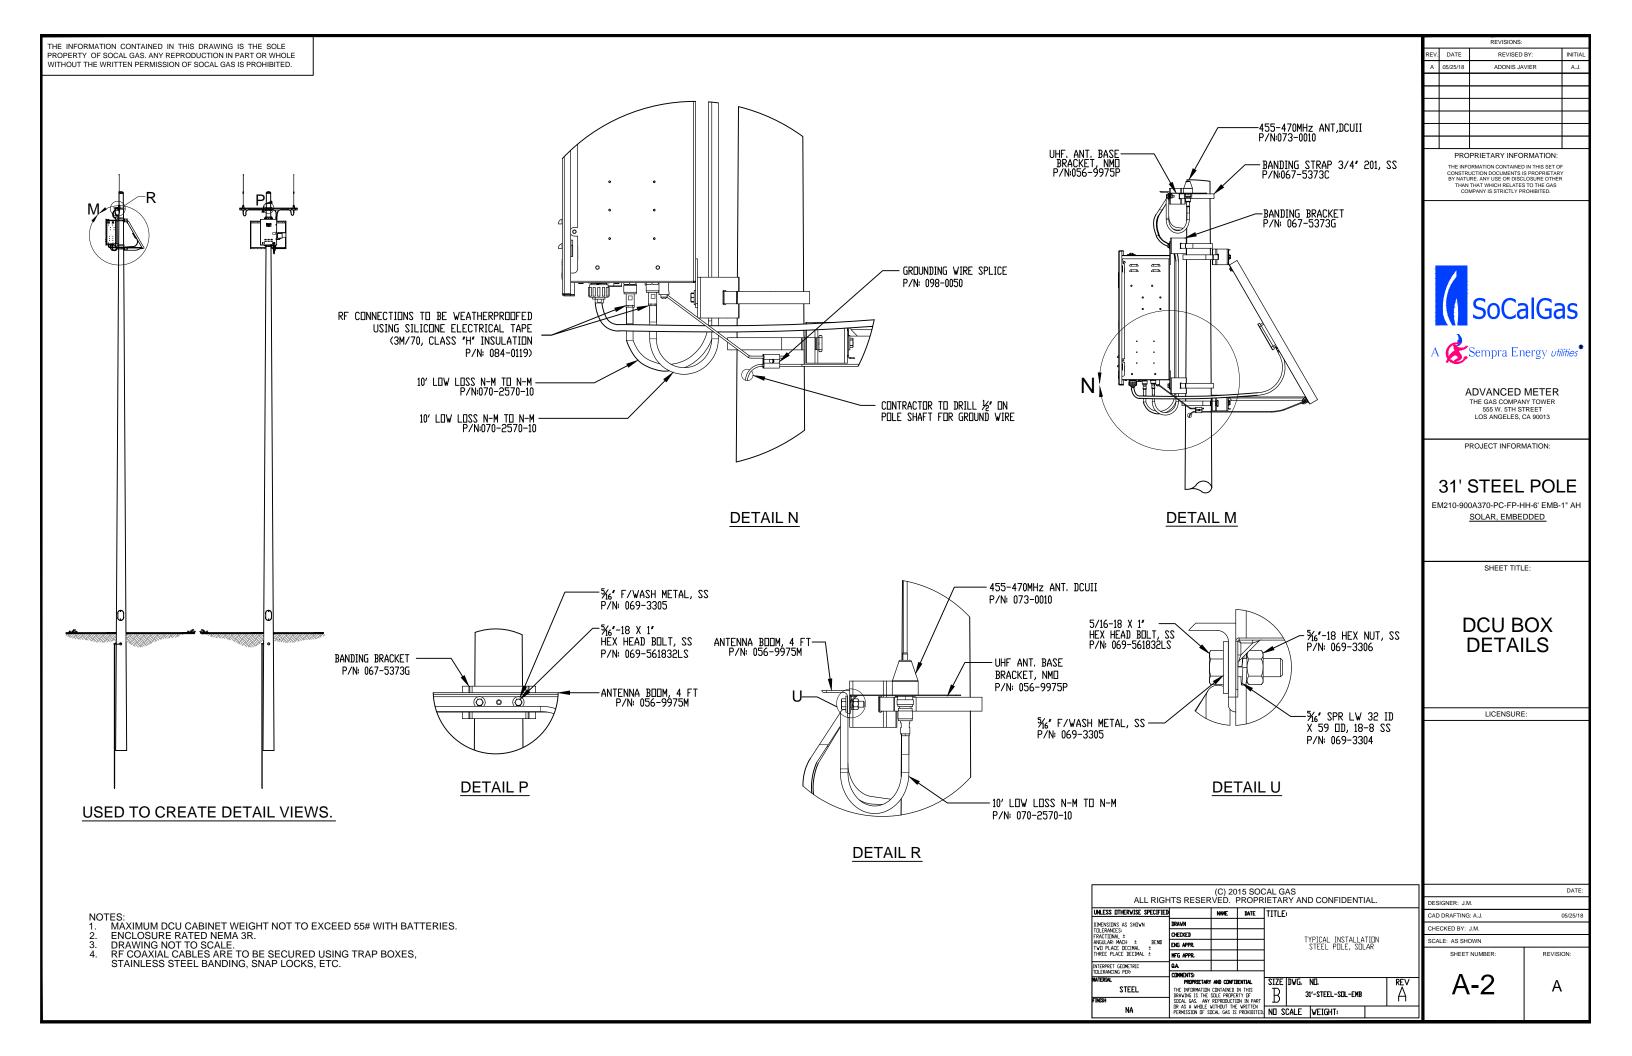TEM NO.	PART NUMBER	DESCRIPTION	QTY.
1 11700-CELL-SOL-SCG		DCU, CELL, SOLAR PWR, SCG	1
2	042-9975	BATTERY, 26 AMP HOUR, DCU 9975	1 1
3	109-9975D	UHF ANT BASE ASSY	2
**4	073-0010	455-470MHz ANT.DCUII	2
5	056-9975M	ANTENNA BOOM, 4 FT	1
6	109-9975F65	65W SOL PANEL W/ MNTG	1
7	109-11700-02	MTG KIT, METAL POLE, SOLAR	1
	067-5373C	BANDING STRAP 3/4" 201, SS	5
	067-5373G	BANDING BRACKET	5
	067-5373D	BANDING CLAMP 3/4 SS 201,UB256	5
	069-561832LS	5/16-18 X 1", HEX HEAD BOLT,SS	10
	069-3305	5/16 F/WASH METAL,SS	10
	069-3304	5/16 " SPR LW, .32 ID X .59 OD, 18-8 SS	10
	069-3306	5/16-18 HEX NUT SS	10
	070-2570-10	10' LOW LOSS N-M TO N-M	1
*8	098-0048	GROUND ROD, 5/8" X 8'	1
*9	098-0049	GROUNDING CLAMP	1
*10	071-1509	GROUNDING WIRE 8 GA, CU, SOLID	1
*12	098-0050	GROUNDING WIRE SPLICE	1
*13	098-0054	CABLE MGMT. BRACKETS, (TRAP BOX)	AS NEEDED
*14	TBD	SNAP-IN CLAMPS	AS NEEDED
*15	098-0056	LMR-400 2 HOLE BOOM CLAMP	AS NEEDED
*16	098-0057	LMR-400 4 HOLE BOOM CLAMP	AS NEEDED
*17	084-0119	FUSION TAPE	AS NEEDED
*18	TCP-360	½" CABLE SPACERS	2

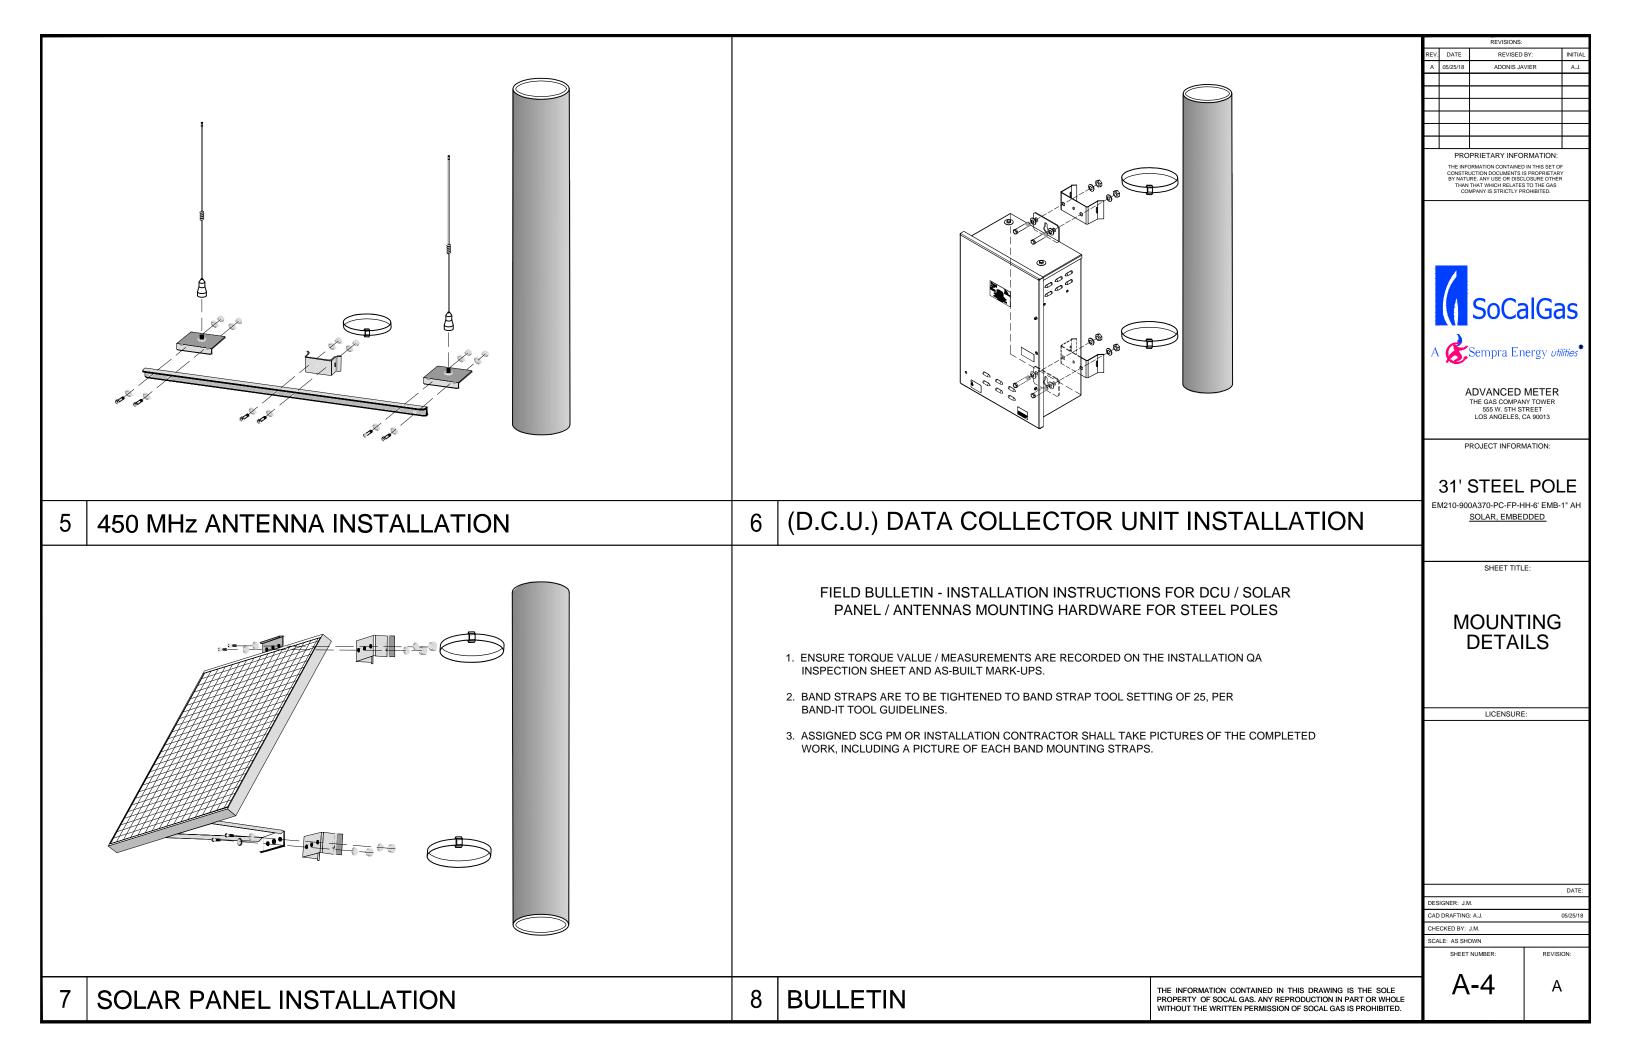

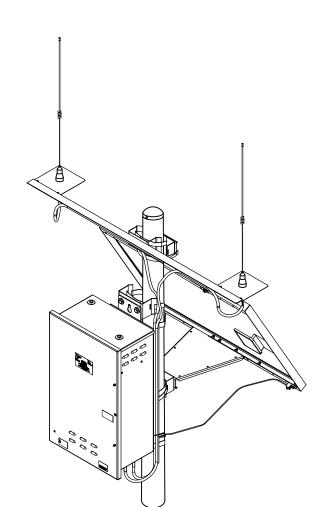

DETAIL O

REVISIONS:					
REV.	DATE	REVISED BY:	INITIAL		
Α	05/25/18	ADONIS JAVIER	A.J.		
	DDO	DDIETADY INCODMATION.			

PROPRIETARY INFORMATION:

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ADVANCED METER
THE GAS COMPANY TOWER
555 W. 5TH STREET
LOS ANGELES, CA 90013

PROJECT INFORMATION:

31' STEEL POLE

EM210-900A370-PC-FP-HH-6' EMB-1" AH SOLAR, EMBEDDED

SHEET TITLE:


MATERIALS LIST

LICENSURE:


(C) 2015 SOCAL GAS ALL RIGHTS RESERVED. PROPRIETARY AND CONFIDENTIAL.								
UNLESS OTHERVISE SPECIFIED		NAME	DATE	TITLE				
DIMENSIONS AS SHOWN	DRAVN							
TOLERANCES: FRACTIONAL ±	CHECKED			TYPICAL INSTALLATION STEEL POLE, SOLAR				
ANGULAR: MACH ± BEND TVD PLACE DECIMAL ±	ENG APPR.							
THREE PLACE DECIMAL ±	MFG APPR.							
INTERPRET GEOMETRIC	QA.							
TOLERANCING PER- HATERIAL STEEL FINESH	COMENTS: PROPRIETARY AND CONFIDENTIAL THE INFORMATION CONTAINED IN THIS BRAVING IS THE SOLE PROPERTY OF SOCAL GAS. ANY REPRODUCTION IN PART		SIZE B		NO. '-steel-sol-emb		REV A	
NA	OR AS A WHOLE WITHOUT THE WRITTEN PERMISSION OF SOCAL GAS IS PROHIBITED.		ND S	CALE	WEIGHT:	'		

v	SHEET NUMBER:	REVISION:
	SCALE: AS SHOWN	
	CHECKED BY: J.M.	00/20/10
	CAD DRAFTING: A.J.	05/25/18
	DESIGNER: J.M.	
		DATE:


NOTES:
1. MAXIMUM DCU CABINET WEIGHT NOT TO EXCEED 55# WITH BATTERIES.
2. ENCLOSURE RATED NEMA 3R.
3. DRAWING NOT TO SCALE.
4. RF COAXIAL CABLES ARE TO BE SECURED USING TRAP BOXES, STAINLESS STEEL BANDING, SNAP LOCKS, ETC.

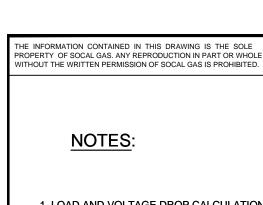


- 1. LOAD AND VOLTAGE DROP CALCULATIONS MUST BE PERFORMED FOR SPECIFIC SITE DESIGN.
- 2. AERATE CONDUCTORS AS REQUIRED BY NEC.
- 3. ALL CONDUCTORS SHALL BE INSTALLED IN AN APPROVED RACEWAY.
- 4. ALL CONDUCTORS SHALL BE COPPER AND THHN/THWN RATED INSULATION
- 5. ALL OUTDOOR INSTALLATION SHALL BE IN AN OUTDOOR RATED ENCLOSURE.

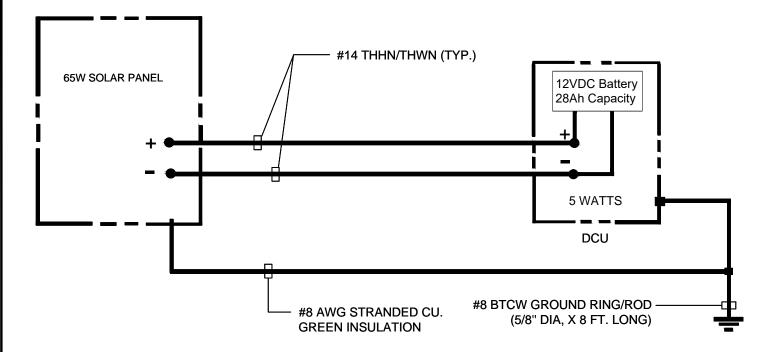



SOLAR POWER SOURCE

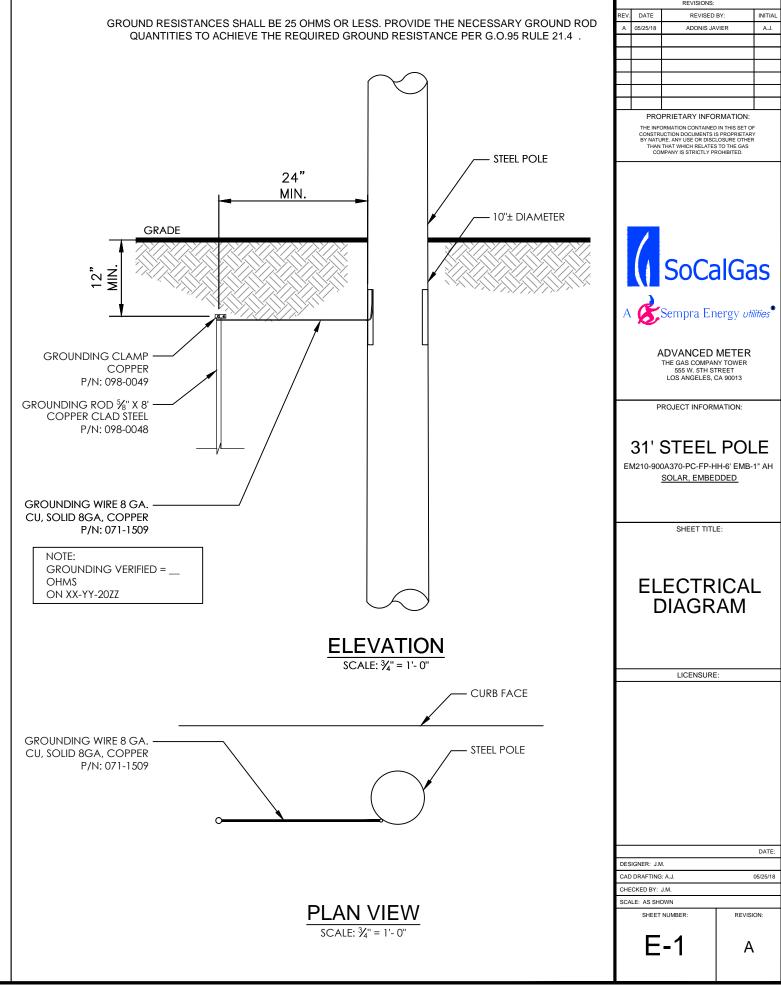


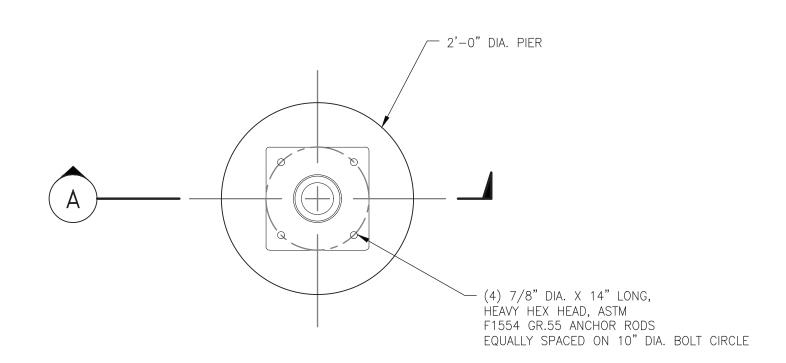


ANTENNA POLE FOUNDATION <u>PLAN</u>

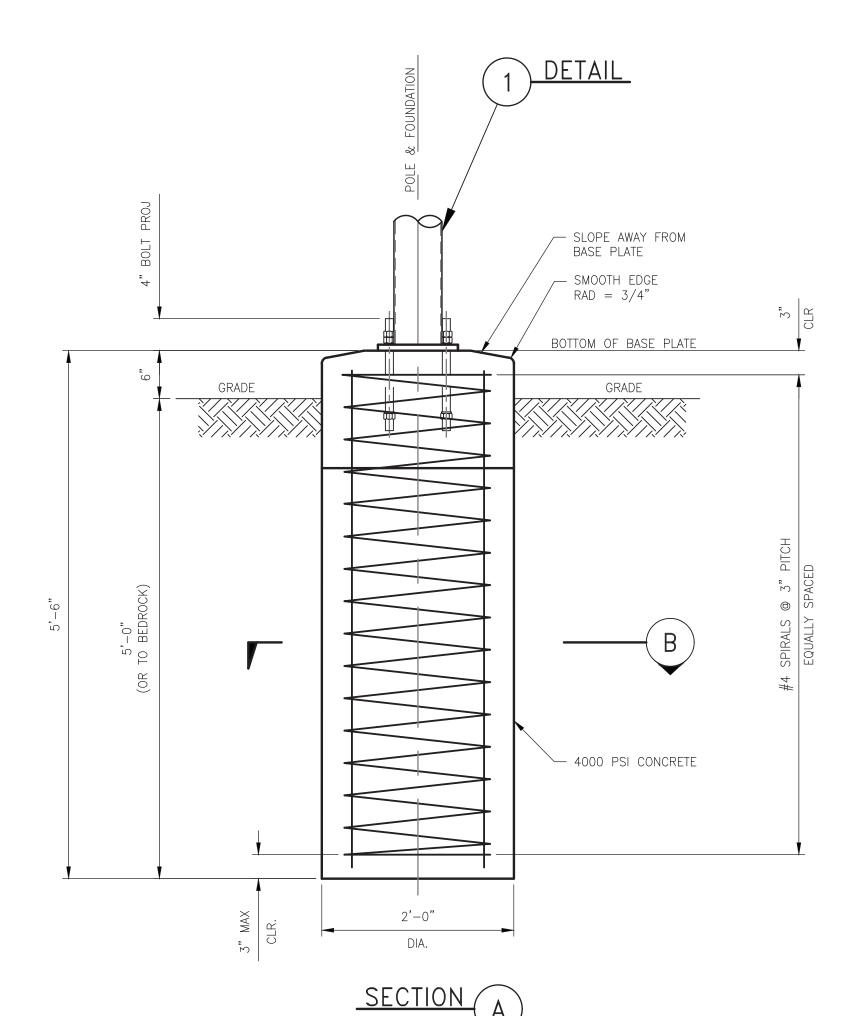

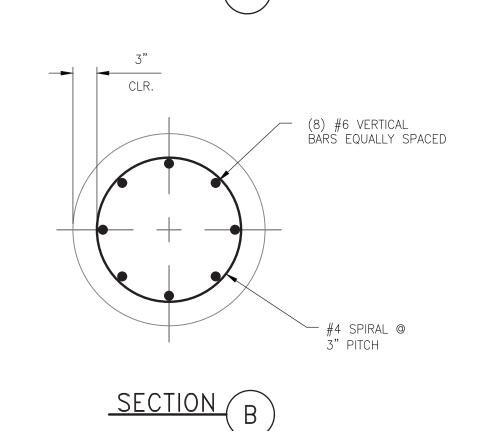

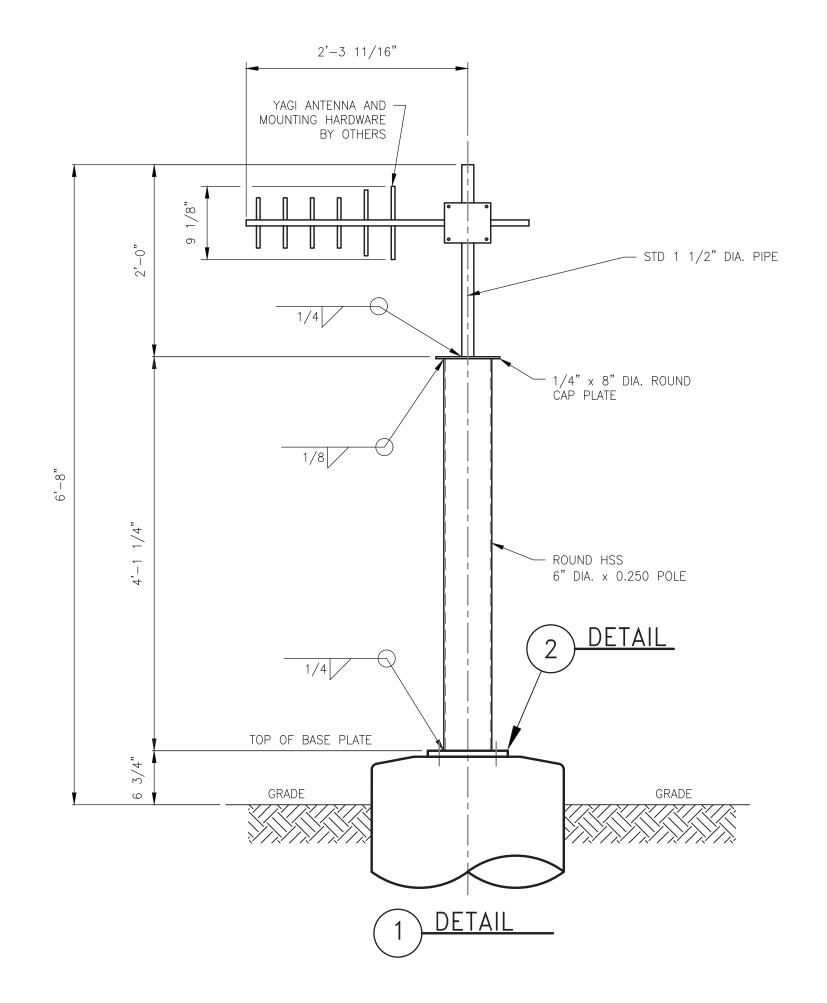

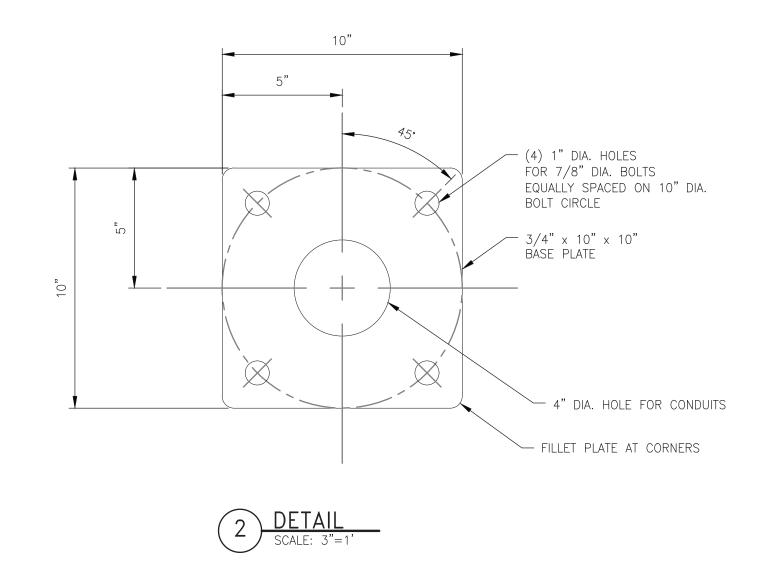

DRAWN CHECKED PRJ APV SCG APV ENG FILE NO

DRAWING NUMBER	REFERENCE DRAWING DESCRIPTION
33091-1001-D-PIP	DRAWING LIST

NOTES:

1. SEE DWG. 33091-4001-D-STR FOR STRUCTURAL NOTES.

ISSUED FOR BID OCTOBER 10, 2019

ENEngineering 626 WILSHIRE BOULEVARD, SUITE 1020 LOS ANGELES, CA 90017 TEL. 213.725.5052 WWW.ENENGINEERING.COM

								BY	DATE
								DESIGNED: M. ROHDER	08-03-17
								drawn: S. RUIZ	08-03-17
								CHECKED: A. MARTINEZ	08-08-17
-18	XX	LFS	ММ	BW	*	ISSUED FOR BID	92082.001	proj apv: M. MORIKAWA	08-08-17
-18	GK	LFS	ММ	SJ	*	ISSUED FOR 90% REVIEW	91125.001	SCG ENG APV: B. WITKOWSKI	08-08-17
-17	SR	AM	MM	ES	*	ISSUED FOR PERMIT	91125.001	ENG FILE NO: *	


DESCRIPTION

WOA

A Sempra Energy utility

L-1005 VALVE AUTOMATION
MLV 4 1005-13.20-0
ANTENNA POLE FOUNDATION PLAN
SECTIONS & DETAILS


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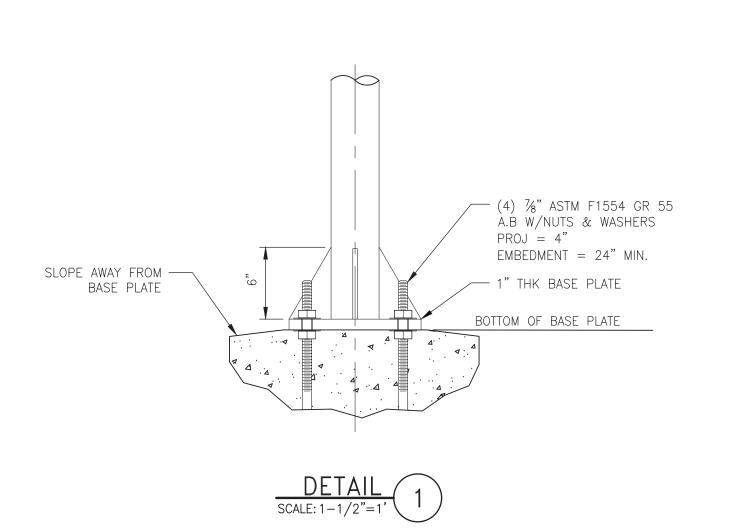


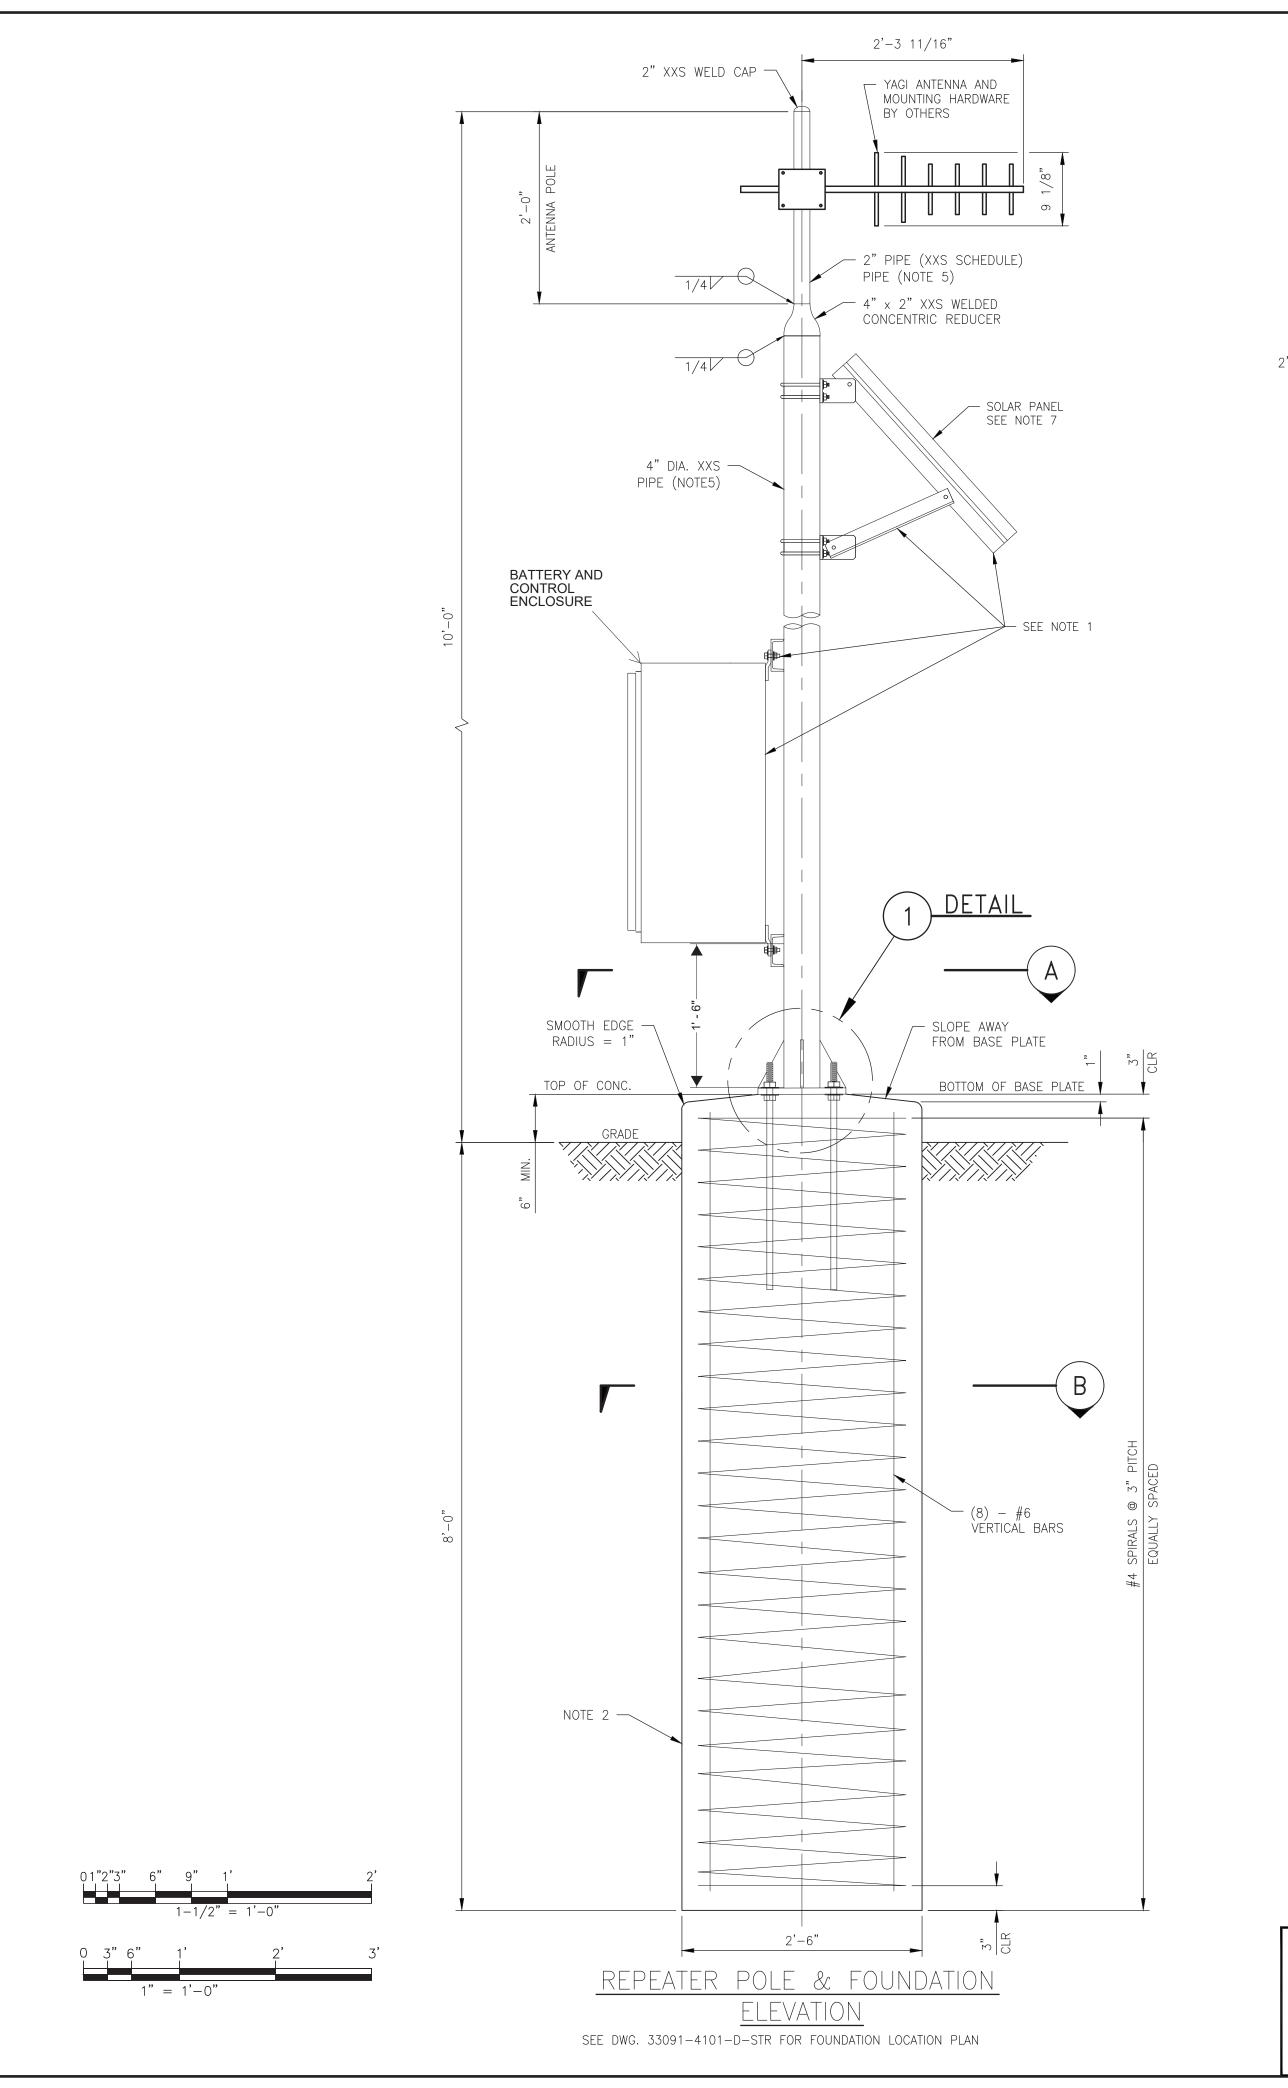
DRAWING NUMBER	REFERENCE DRAWING DESCRIPTION
33091-1001-D-PIP	DRAWING LIST

NOTES:

- 1. THE CONTRACTOR MUST VERIFY ALL MEASUREMENTS AFFECTING HIS WORK AND ASSUME RESPONSIBILITY FOR THEIR CORRECTNESS.
- 2. CONCRETE SHALL HAVE A MINIMUM COMPRESSIVE STRENGTH, f'c= 4000 PSI.
- 3. SEE DWG. 33091-4001-D-STR FOR STRUCTURAL NOTES.
- 4. STRUCTURAL OBSERVATIONS AND SPECIAL INSPECTIONS TO BE PERFORMED PER CBC 2016.
- 5. ALL PIPE SHALL BE HOT DIPPED GALVANIZED.
- 6. MAX. EQUIPMENT WEIGHT = 250 LBS
- 7. SOLAR PANEL TO BE EXCLUDED FROM THIS INSTALLATION



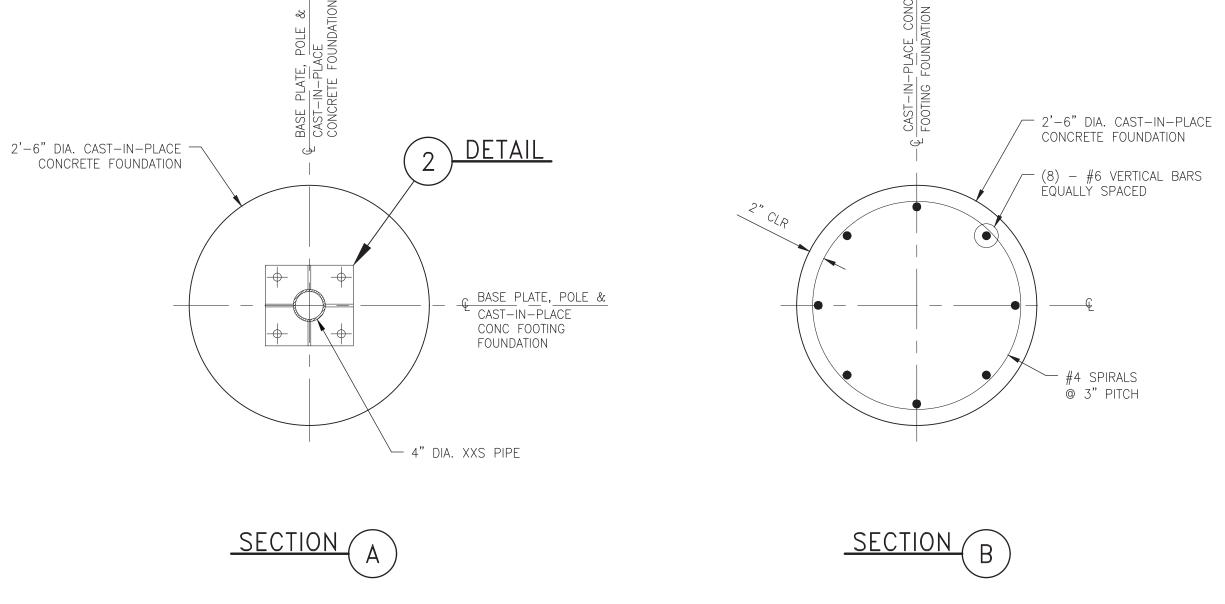

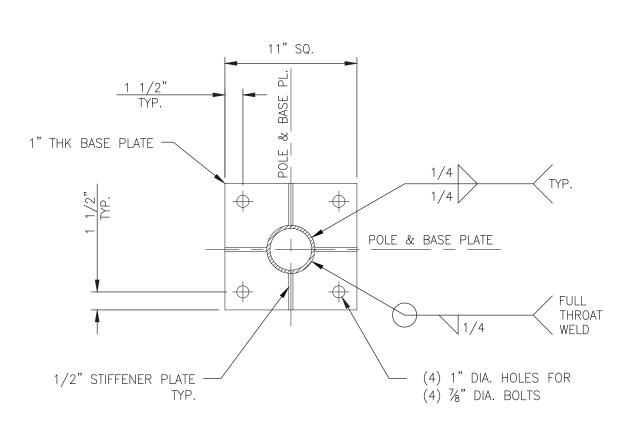

ISSUED FOR BID

OCTOBER 10, 2019

EN*E*ngineering 626 WILSHIRE BOULEVARD, SUITE 1020 LOS ANGELES, CA 90017 TEL. 213.725.5052 WWW.ENENGINEERING.COM


								BY	DATE
								DESIGNED: M. ROHDER	08-03-17
								drawn: J. GARCIA	08-03-17
								CHECKED: A. MARTINEZ	08-08-17
-XX-18	XX	LFS	ММ	BW	*	ISSUED FOR BID	92082.001	proj apv: M. MORIKAWA	08-08-17
-21-18	CJ	LFS	ММ	SJ	*	ISSUED FOR 90% REVIEW	92082.001	SCG ENG APV: B. WITKOWSKI	08-08-17
-10-17	SR	LFS	MM	ES	*	ISSUED FOR PERMIT	92082.001	ENG FILE NO: *	

DRAWN CHECKED PRJ APV SCG APV ENG FILE NO

(SoCalGas A Sempra Energy utility

L-1005 VALVE AUTOMATION ORTEGA RIDGE REPEATER SITE REPEATER POLE FOUNDATION SECTIONS & DETAILS

33091-4102-D-STR WOA: 92082.00

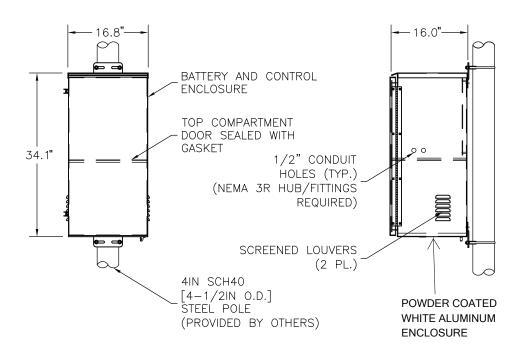



OWNERSHIP

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SB50-0454-SES



SITE NUMBER/ID:

(E) 28' A.G.L. AMERON POLE 1C128, AC POWER

PROJECT SUMMARY: SHEET INDEX: **DESCRIPTION:** SITE ADDRESS: SHEET NO: VARIOUS APPLICANT: TITLE SHEET T-1 SOUTHERN CALIFORNIA GAS CO. 555 W. 5TH ST., 17TH FLOOR, LOS ANGELES, CA 90013 REPRESENTATIVE: OLIVIA GUTIERREZ **GENERAL NOTES** T-2 **ELEVATIONS** PHONE: (213) 244-2201 A-1 PROPERTY OWNER: DCU BOX DETAILS A-2 A-3 MATERIALS LIST ELECTRICAL DIAGRAM PUBLIC RIGHT OF WAY LATITUDE: XX.YYYYYYYY LONGITUDE: -YYY.XXXXXXXX





REVISION HISTORY

REVISION A: INITIAL DESIGN

CONSULTING TEAM:

OCCUPANCY CLASSIFICATION: UNMANNED UTILITY WIRELESS FACILITY

SOUTHERN CALIFORNIA GAS CO. PROPOSES TO INSTALL ACLARA

EQUIPMENT MOUNTED 26'-0" ABOVE GROUND LEVEL ON A EXISTING 28'-0" A.G.L. CONCRETE UTILITY POLE.

SAC/ZONING/PERMITTING:

ZONING CLASSIFICATION:

CONSTRUCTION TYPE: PROJECT DESCRIPTION:

SOUTHERN CALIFORNIA GAS CO. OLIVIA GUTIERREZ 555 W. 5TH ST., 17TH FLOOR LOS ANGELES, CA 90013

CONTRACTOR

PHONE: (213) 244-2201

AM ORTEGA CONSTRUCTION CONTACT: SEAN RAMOS 224 N. SHERMAN AVENUE CORONA, CA 92882 PHONE: (951) 360-1352

CONSTRUCTION PROJECT MANAGER

SOUTHERN CALIFORNIA GAS CO. OLIVIA GUTIERREZ 555 W. 5TH ST., 17TH FLOOR LOS ANGELES CA 90013 PHONE: (213) 244-2201

NETWORK CONSTRUCTION ENGINEER

SOUTHERN CALIFORNIA GAS CO. JUAN MALDONADO 555 W. 5TH ST., 17TH FLOOR LOS ANGELES, CA 90013

APPROVALS:

SIGNATURE

DATE

THE FOLLOWING PARTIES HEREBY APPROVE AND ACCEPT THESE DOCUMENTS AND AUTHORIZE THE CONTRACTOR TO PROCEED WITH THE CONSTRUCTION DESCRIBED HEREIN. ALL CONSTRUCTION DOCUMENTS ARE SUBJECT TO REVIEW BY THE LOCAL BUILDING DEPARTMENT AND ANY CHANGES AND MODIFICATIONS THEY MAY IMPOSE.

PRINT NAME

LANDLORD	PUBLIC R.O.W.				
PRECON. MGR					_
DEVELOP. MGR					_
CONST. MGR					_
PROJECT. MGR					_
SR. RF ENGINEER					_
RF ENGINEER					
OPERATIONS		•			_
SAC REP.		•			_

APPLICABLE CODES:


PERMIT #:

2015 GREENBOOK STANDARD SPECS. FOR PUBLIC WORKS CONSTRUCTION 2015 CITY CONSTRUCTION STANDARD DETAILS ANSI/TIA/FIA-222-F LIFE SAFETY CODE NEPA-101 2017 NATIONAL ELECTRIC CODE CITY/COUNTY ORDINANCES

DESIGNER: J.M. CHECKED BY: J.M. SCALE: AS SHOWN

T-1

Α

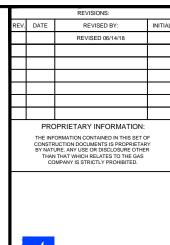



ADVANCED METER THE GAS COMPANY TOWER 555 W. 5TH STREET LOS ANGELES, CA 90013

PROJECT INFORMATION:

SOUTHERN CALIFORNIA EDISON

28' CONCRETE

AC POLE ATTACHMENT PHOTO CELL TAP

SHEET TITLE:

TITLE SHEET

LICENSURE:

INTENT

- THIS CONSTRUCTION DRAWINGS DESCRIBE THE WORK TO BE DONE AND THE MATERIALS TO BE FURNISHED FOR CONSTRUCTION.
- THE INTENTION OF THE DOCUMENT IS TO INCLUDE ALL LABOR AND MATERIALS REASONABLY NECESSARY FOR THE PROPER EXECUTION AND COMPLETION OF THE WORK AS STIPULATED IN THE CONTRACT.
- 3. MINOR DEVIATIONS FROM THE DESIGN LAYOUT ARE ANTICIPATED AND SHALL BE CONSIDERED AS PART OF THE WORK. NO CHANGES THAT ALTER THE CHARACTER OF THE WORK WILL BE MADE OR PERMITTED BY THE OWNER WITHOUT ISSUING A CHANGE ORDER.
- 4. THE DRAWINGS ARE GRAPHIC AND PICTORIAL PORTIONS OF THE CONTRACT DOCUMENTS SHOWING THE DESIGN, LOCATION AND DIMENSIONS OF THE WORK, GENERALLY, INCLUDING PLANS, ELEVATIONS, SECTIONS, DETAILS, SCHEDULES AND DIAGRAMS.
- IN CASE OF INCONSISTENCY BETWEEN OTHER PARTS OF THE CONTRACT, THE CONTRACTOR SHALL PERFORM THE WORK IN ACCORDANCE WITH THE OWNER'S INTERPRETATION.
- 6. WHERE DRAWINGS REFER TO STANDARD SPECIFICATIONS, THE LATEST OR MOST RECENT EDITION SHALL APPLY.

CHANGE ORDER PROCEDURE

1. CHANGE ORDER MAY BE INITIATED BY THE OWNER AND/OR THE CONTRACTOR INVOLVED. THE CONTRACTOR, UPON VERBAL REQUEST FROM THE OWNER SHALL PREPARE A WRITTEN PROPOSAL DESCRIBING THE CHANGE IN WORK OR MATERIALS AND ANY CHANGES IN THE CONTRACT AMOUNT AND PRESENT TO THE OWNER WITHIN 72 HOURS FOR APPROVAL. SUBMIT REQUESTS FOR SUBSTITUTIONS IN THE FORM AND IN ACCORDANCE WITH PROCEDURES REQUIRED FOR CHANGE ORDER PROPOSALS. ANY CHANGES IN THE SCOPE OF WORK OR MATERIALS WHICH ARE PERFORMED BY THE CONTRACTOR WITHOUT A WRITTEN CHANGE ORDER AS DESCRIBED AND APPROVED BY THE OWNER SHALL PLACE FULL RESPONSIBILITY OF THESE ACTIONS ON THE CONTRACTOR.

CODE COMPLIANCE

 ALL WORK SHALL BE IN ACCORDANCE WITH APPLICABLE LOCAL, STATE AND FEDERAL REGULATIONS. THESE SHALL INCLUDE BUT NOT BE LIMITED TO THE LATEST VERSION OF THE FOLLOWING:

2015 GREENBOOK STANDARD SPECS. FOR PUBLIC WORKS CONSTRUCTION 2015 CITY CONSTRUCTION STANDARD DETAILS 2016 CALIFORNIA BUILDING CODE

2017 NATIONAL ELECTRIC CODE

ANSI/TIA/EIA-222-F LIFE SAFETY CODE NFPA-101
CITY AND COUNTY ORDINANCES

ADMINISTRATION

- BEFORE THE COMMENCEMENT OF ANY WORK, THE CONTRACTOR WILL ASSIGN A PROJECT MANAGER WHO WILL ACT AS A SINGLE POINT OF CONTACT FOR ALL PERSONNEL INVOLVED IN THIS PROJECT. THIS PROJECT MANAGER WILL BE DEVELOPING A MASTER SCHEDULE FOR THE PROJECT WHICH WILL BE SUBMITTED TO THE OWNER PRIOR TO THE COMMENCEMENT OF ANY WORK.
- 2. SUBMIT A BAR TYPE PROGRESS CHART NOT MORE THAN THREE (3) DAYS AFTER THE DATE ESTABLISHED FOR COMMENCEMENT OF THE WORK ON THE SCHEDULE, INDICATING A TIME BAR FOR EACH MAJOR CATEGORY OF WORK TO BE PERFORMED AT THE SITE, PROPERLY SEQUENCED AND COORDINATED WITH OTHER ELEMENTS OF WORK AND SHOWING COMPLETION OF THE WORK SUFFICIENTLY IN ADVANCE OF THE DATE ESTABLISHED FOR SUBSTANTIAL COMPLETION OF THE SITE.
- PRIOR TO COMMENCING CONSTRUCTION, THE OWNER SHALL SCHEDULE AN ON-SITE MEETING WITH ALL MAJOR PARTIES. THIS WOULD INCLUDE BUT NOT LIMITED TO, THE OWNER, PROJECT MANAGER, CONTRACTOR, AND LAND OWNER REPRESENTATIVE.
- 4. THE CONTRACTOR SHALL BE EQUIPPED WITH SOME MEANS OF CONSTANT COMMUNICATIONS, SUCH AS A MOBILE PHONE OR BEEPER. THIS EQUIPMENT WILL NOT BE SUPPLIED BY THE OWNER, NOR WILL WIRELESS SERVICE BE ARRANGED.
- DURING CONSTRUCTION, THE CONTRACTOR MUST ENSURE THAT EMPLOYEES AND SUBCONTRACTORS WEAR HARD HATS AT ALL TIMES. THE CONTRACTOR WILL COMPLY WITH ALL SCG SAFETY REQUIREMENTS IN THEIR AGREEMENT.
- 6. PROVIDE WRITTEN DAILY UPDATES AND PHOTOGRAPHS OF ON-SITE PROGRESS TO THE PROJECT MANAGER VIA E-MAIL.
- 7. A COMPLETE INVENTORY OF CONSTRUCTION MATERIALS AND EQUIPMENT IS REQUIRED PRIOR TO THE START OF CONSTRUCTION.
- NOTIFY THE OWNER / PROJECT MANAGER IN WRITING NO LESS THAN 48 HOURS IN ADVANCE OF CONCRETE POURS, TOWER ERECTIONS, AND EQUIPMENT CABINET PLACEMENTS.
- CLOSEOUT PACKAGE IS DUE COMPLETE WITH DETAILED TOP PHOTOS UPON SITE PUNCHWALK WITH PROJECT MANAGER (SEE PROJECT MANAGER FOR SAMPLE CLOSEOUT PACKAGE).

WARRANTIES AND BONDS

- THE CONTRACTOR IS RESPONSIBLE FOR APPLICATION AND PAYMENT OF CONTRACTOR LICENSES AND BONDS.
- 2. SEE MASTER CONTRACTOR SERVICES AGREEMENT FOR ADDITIONAL DETAILS.

GENERAL NOTES

1. IDEMNIFICATION CLAUSE: THE CONTRACTOR AGREES AND SHALL:

ASSUME SOLE AND COMPLETE RESPONSIBILITY OF THE JOBSITE CONDITIONS DURING THE COURSE OF CONSTRUCTION OF THIS PROJECT, INCLUDING THE SAFETY OF ALL PERSONS AND PROPERTIES. THAT THESE REQUIREMENTS SHALL APPLY CONTINUOUSLY AND NOT BE LIMITED TO NORMAL WORKING HOURS AND CONDITIONS. THE CONTRACTOR FURTHER AGREES TO DEFEND INDEMNITY AND HOLD SOCAL GAS REPRESENTATIVES AND ENGINEERS HARMLESS FROM ANY AND ALL LIABILITY, REAL OR ALLEGED IN CONNECTION WITH THE PERFORMANCE OF THE WORK ON THIS PROJECT.

- PRIOR TO THE BEGINNING OF ANY CONSTRUCTION AND THROUGHOUT THE COURSE OF CONSTRUCTION WORK, THE CONTRACTOR SHALL FULLY COMPLY WITH "CALIFORNIA OCCUPATIONAL SAFETY AND HEALTH" ACT OF 1973 INCLUDING ALL REVISIONS AND AMENDMENTS THERETO.
- ALL WORK SHALL CONFORM TO THE LATEST EDITION OF GO 95, 128, AND THE STANDARD "SPECIFICATIONS FOR PUBLIC WORKS CONSTRUCTION", AS ADOPTED BY THE CITY, COUNTY OR STATE AS MODIFIED BY STANDARD PLANS AND ADDENDUM.
- 4. THE EXISTENCE AND LOCATION OF UTILITIES AND OTHER AGENCIES FACILITIES AS SHOWN HEREON ARE OBTAINED BY A SEARCH OF AVAILABLE RECORDS. OTHER FACILITIES MAY EXIST, THE CONTRACTOR SHALL VERIEV PRIOR TO THE START OF CONSTRUCTION AND SHALL USE EXTREME CARE AND PROTECTIVE MEASURES TO PREVENT DAMAGE TO THESE FACILITIES. THE CONTRACTOR IS RESPONSIBLE FOR THE PROTECTION OF ALL UTILITY OR AGENCY FACILITIES WITHIN THE LIMITS OF WORK, WHETHER THEY ARE SHOWN ON THIS PLAN OR NOT.
- THE CONTRACTOR SHALL NOTIFY UNDERGROUND SERVICE ALERT (800) 227-2600, AT LEAST TWO WORKING DAYS PRIOR TO THE START OF ANY EXCAVATION.
- THE CONTRACTOR SHALL NOTIFY THE CITY, COUNTY OR STATE ENGINEER INSPECTION DEPARTMENT (213) 482-7030, AT LEAST TWO WORKING DAYS BEFORE THE START OF ANY WORK REQUIRING THEIR INVOLVEMENT.
- ALL WORK AREA AND STREET TRAFFIC CONTROL SHALL BE IN ACCORDANCE WITH THE SPECIFICATIONS OF THE WORK AREA TRAFFIC CONTROL BOOK AND SPECIFICATIONS FROM THE CITY, COUNTY OR STATE.
- 8. THE CITY, COUNTY OR STATE SHALL SPECIFY THE EXPIRATION PERIOD OF THE PERMIT FOR THIS CONSTRUCTION PROJECT.
- THE MINIMUM COVER FOR ALL CONDUITS PLACED UNDERGROUND SHALL BE 36 INCHES TO THE FINISHED GRADE AT ALL TIMES.
- 10. ALL SHRUBS, PLANTS OR TREES THAT HAVE BEEN DAMAGED OR DISTURBED DURING THE COURSE OF THE WORK, SHALL BE REPLANTED AND/OR REPLACED SO AS TO RESTORE THE WORK SITE TO ITS ORIGINAL CONDITION.
- 11. VAULTS, PEDESTALS, CONDUITS AND OTHER TYPES OF SUBSTRUCTURE ARE EITHER SPECIFIED ON THIS PLAN OR WILL BE SPECIFIED BY THE CONSTRUCTION ENGINEER. ANY AND ALL DEVATIONS FROM THE SPECIFIED TYPES OF MATERIAL MUST BE APPROVED BY THE SYSTEM ENGINEER, IN WINTING DECODE INSTALLATION THEFORE
- ALL RECONSTRUCTION, RESURFACING, PAVEMENT DELINEATION AND OTHER IMPROVEMENTS ARE TO BE RESTORED TO THE SAME OR IMPROVED CONDITION BASED ON GENERAL NOTE NO. 3 ABOVE.

INSURANCE AND BONDS

- THE CONTRACTOR SHALL AT THEIR OWN EXPENSE CARRY AND MAINTAIN FOR THE DURATION OF THE PROJECT ALL INSURANCE AS REQUIRED AND LISTED.
- 2. THE CONTRACTOR SHALL NOT COMMENCE WITH THEIR WORK UNTIL THEY HAVE PRESENTED AN ORIGINAL CERTIFICATE OF INSURANCE STATING ALL COVERAGES TO THE OWNER.
- 3. THE OWNER SHALL BE NAMED AS AN ADDITIONAL INSURED ON ALL POLICIES.
- 4. REFER TO THE MASTER AGREEMENT FOR REQUIRED INSURANCE LIMITS.

CLEAN UP

- THE CONTRACTOR SHALL AT ALL TIMES KEEP THE SITE FREE FROM ACCUMULATION OF WASTE MATERIALS OR RUBBISH CAUSED BY THEIR EMPLOYEES AT WORK. AT THE COMPLETION OF THE WORK, THEY SHALL REMOVE ALL RUBBISH FROM AND ABOUT THE BUILDING AREA, INCLUDING ALL THEIR TOOLS, SCAFFOLDING AND SURPLUS MATERIALS AND SHALL LEAVE THEIR WORK CLEAN AND READY FOR USE.
- 2. VISUALLY INSPECT EXTERIOR SURFACES AND REMOVE ALL TRACES OF SOIL, WASTE MATERIALS, SMUDGES AND OTHER FOREIGN MATTER.
- 3. REMOVE ALL TRACES OF SPLASHED MATERIALS FROM ADJACENT SURFACES.
- IF NECESSARY TO ACHIEVE A UNIFORM DEGREE OF CLEANLINESS, HOSE DOWN THE EXTERIOR OF THE STRUCTURE.

SUBSTANTIAL COMPLETION

- 1. SUBSTANTIAL COMPLETION IS THE STAGE OF WORK IS SUFFICIENTLY COMPLETE IN ACCORDANCE EITH THE CONTRACT SO THE OWNER CAN FULLY UTILIZE THE WORK FOR ITS INTENDED USE. SUCH TIME, CONTRACTOR SHALL SUBMIT TO OWNER A REQUEST FOR FINAL PAYMENT AND FINAL COMPLETION REPORT ITEMIZING AND DETAILED INVENTORY OF WORK TO COMPLETION AND AS-BUILT DOCUMENTS/DRAWINGS.
- OWNER WILL ONLY RELEASE FINAL PAYMENT UPON SATISFACTORY REVIEW AND CONTRACTOR COMPLIANCE OF THE FINAL PAYMENT REQUIREMENTS.

CONFLICTS

- 1. THE CONTRACTOR SHALL BE RESPONSIBLE FOR VERIFICATION OF ALL MEASUREMENTS AT THE SITE BEFORE ORDERING ANY MATERIALS OR DOING ANY WORK. NO EXTRA CHARGE OR COMPENSATION SHALL BE ALLOWED DUE TO DIFFERENCE BETWEEN ACTUAL DIMENSIONS AND DIMENSIONS INDICATED IN THE CONSTRUCTION DRAWINGS. ANY SUCH DISCREPANCY IN DIMENSION WHICH MAY BE FOUND SHALL BE SUBMITTED TO THE OWNER FOR CONSIDERATION BEFORE THE CONTRACTOR PROCEEDS WITH THE WORK IN THE AFFECTED AREAS.
- THE BIDDER, IF AWARDED THE CONTRACT, WILL NOT BE ALLOWED ANY EXTRA COMPENSATION BY REASON OF ANY MATTER OR THING CONCERNING WHICH BIDDER MIGHT HAVE FULLY INFORMED THEMSELVES PRIOR TO THE BIDDING.
- 3. NO PLEA OF IGNORANCE OF CONDITIONS THAT EXIST, OR OF DIFFICULTIES OR CONDITIONS THAT MAY BE ENCOUNTERED OR OF ANY OTHER RELEVANT MATTER CONCERNING THE WORK TO BE PERFORMED IN THE EXECUTION OF THE WORK WILL BE ACCEPTED AS AS EXCUSE FOR ANY FAILURE OR OMISSION ON THE PART OF THE CONTRACTOR TO FULFILL EVERY DETAIL OF ALL REQUIREMENTS OF THE CONTRACT DOCUMENTS GOVERNING THE WORK.

STRUCTURAL NOTES

1. DESIGN CRITERIA:

2013 CALIFORNIA BUILDING CODE. ASCE 7-10 MINIMUM DESIGN LOADS FOR BUILDINGS OTHER STRUCTURES.

INTERNATIONAL BUILDING CODE (IBC) 2012 TIA-222 G STANDARD. 2013 AASHTO LTS - 6TH EDITION.

- DURING CONSTRUCTION, THE CONTRACTOR SHALL NOTIFY THE ENGINEER
 OF ANY UNUSUAL OR UNFORESEEN CONDITION PRIOR TO CONTINUING
 WITH CONSTRUCTION. SHOULD ANY CONDITION ARISE WHERE THE INTENT
 OF THE DRAWINGS IS IN DOUBT, OR WHERE THERE APPEARS TO BE
 DISCREPANCY BETWEEN THE DRAWINGS AND THE CONDITION IN THE
 FIELD, THE ENGINEER SHALL BE NOTIFIED PRIOR TO CONTINUING
 THE WORK.
- 3. PORTLAND CEMENT SHALL CONFORM TO ASTM C-150 TYPE II.
 AGGREGATE FOR STONE CONCRETE SHALL CONFORM TO ASTM C-33.
 AGGREGATE FOR LIGHTWEIGHT CONCRETE SHALL CONFORM TO ASTM C-330.
 AGGREGATE ASTM C-33: MAXIMUM SIZE 1 ½" FOR FOOTINGS AND
 1" FOR ALL OTHER WORK.
- 4. ALL REINFORCING BARS, ANCHOR BOLTS, PRESTRESSING TENDONS AND ALL OTHER CONCRETE INSERTS SHALL BE WELL SECURED IN POSITION PRIOR TO PLACING CONCRETE.
- THE MAXIMUM SLUMP SHALL BE BETWEEN THE RANGE OF 3" TO 5" FOR FOOTINGS, SLABS ON EARTH AND MASS CONCRETE.

STANDARD SYMBOLS

	BUILDING
©	BOLLARD
CATV	CABLE TV LINE
	CENTER LINE
	CONCRETE BLOCK WALL
	CURB, GUTTER & SIDEWALK
	DRIVEWAY
—·—EOP—·—	EDGE OF PAVEMENT
— · —EOD— · —	EDGE OF DIRT
EV	ELECTRIC VAULT
	FENCE
xx	CHAINLINK FENCE
•	FIRE HYDRANT
——— GAS ———	GAS LINE
	GAS VALVE
———GV———	GATE VALVE
×	GUY POLE
\otimes	JOINT POLE
MH	MANHOLE
OIL	OIL LINE
PWR	POWER LINE
——— P_———	PROPERTY LINE
РВ	PULLBOX
+++++++++++++++++++++++++++++++++++++++	RAILROAD TRACK
	RETAINING WALL
ROW	RIGHT OF WAY
s	SANITARY SEWER
———SD———	STORM DRAIN LINE
STL	STREET LIGHT LINE
þ	STREET SIGN
	SERVICE PEDESTAL
TEL	TELCO LINE
w	WATER LINE
(WM)	WATER METER

REVISED 06/14/18 A

REVISED BY

EV. DATE

PROPRIETARY INFORMATION:

THE INFORMATION CONTAINED IN THIS SET OF CONSTRUCTION DOCUMENTS IS PROPRIETARY BY NATURE. ANY USE OR DISCLOSURE OTHER THAN THAT WHICH RELATES TO THE GAS COMPANY IS STRICTLY PROHIBITED.





THE GAS COMPANY TOWER 555 W. 5TH STREET

LOS ANGELES, CA 90013

PROJECT INFORMATION:

SOUTHERN CALIFORNIA EDISON

28' CONCRETE

AC POLE ATTACHMENT PHOTO CELL TAP

SHEET TITLE:

GENERAL NOTES & SYMBOLS

LICENSURE:

DESIGNER: J.M.

CAD DRAFTING: A.J.


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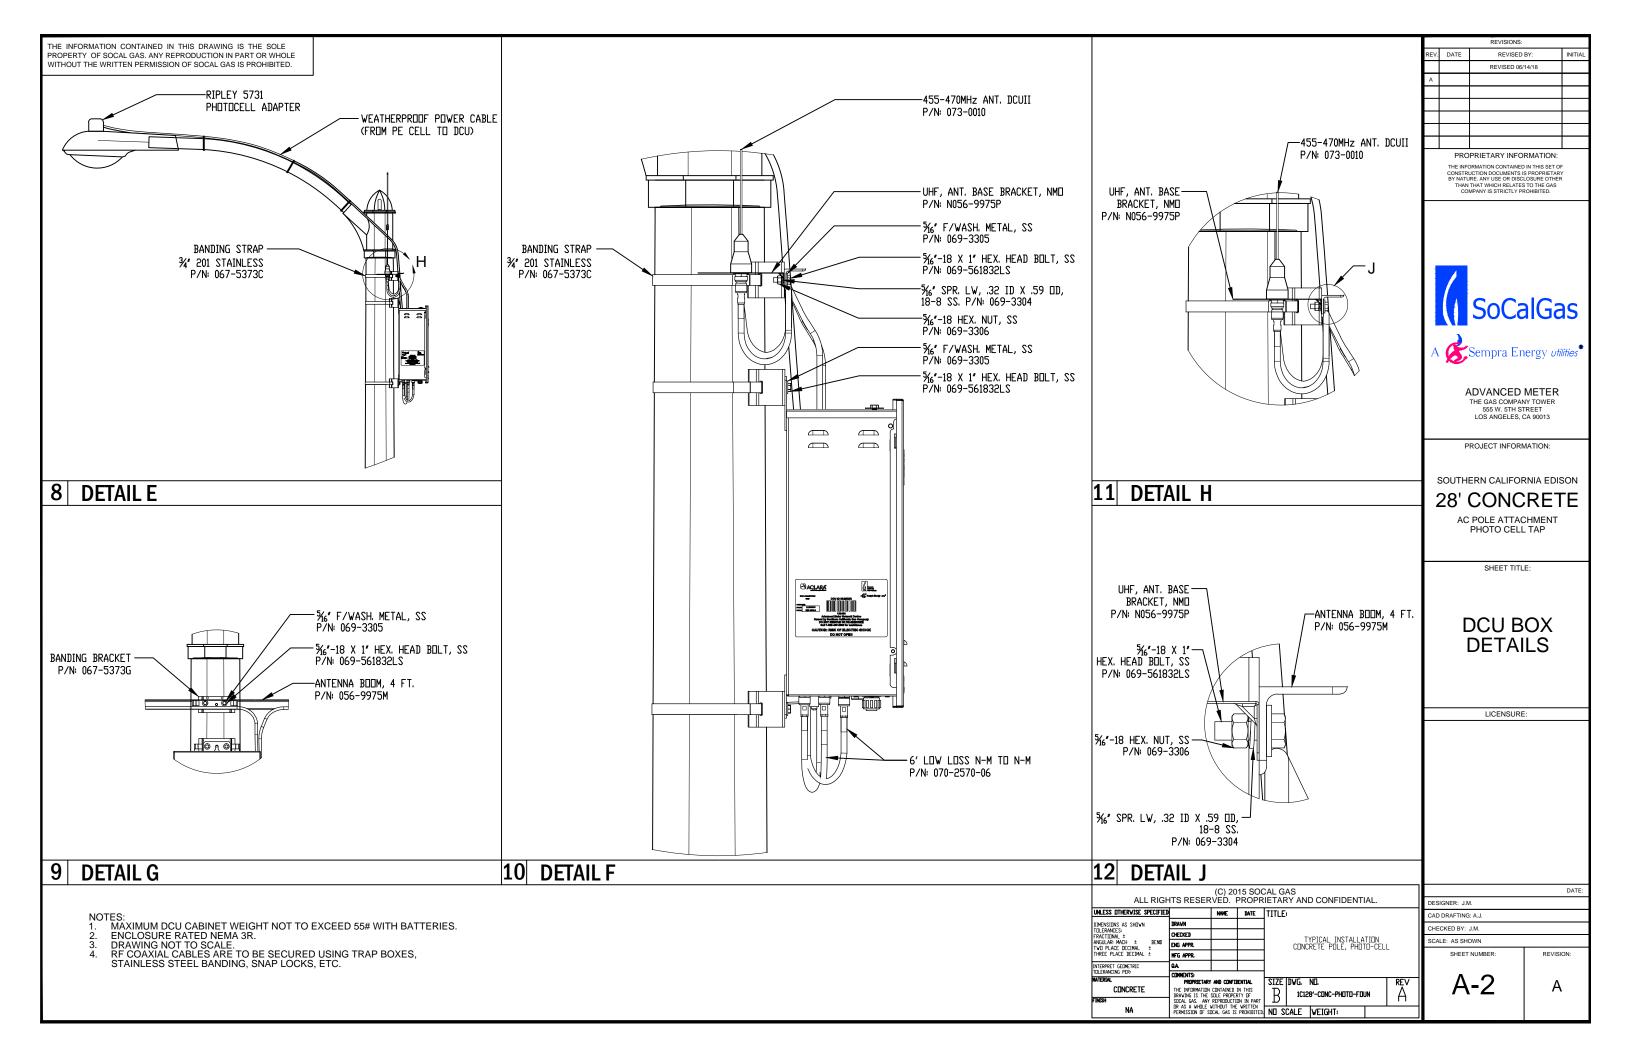
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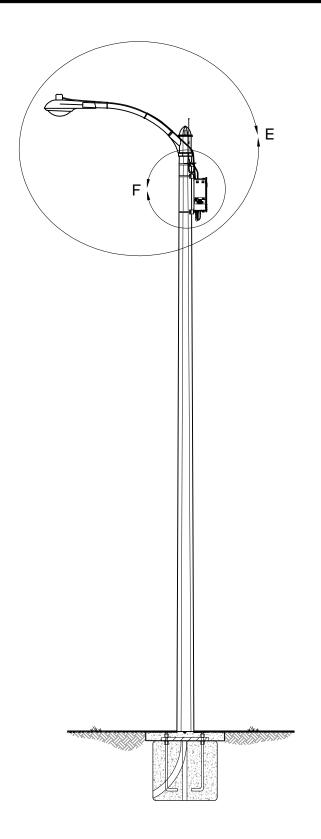
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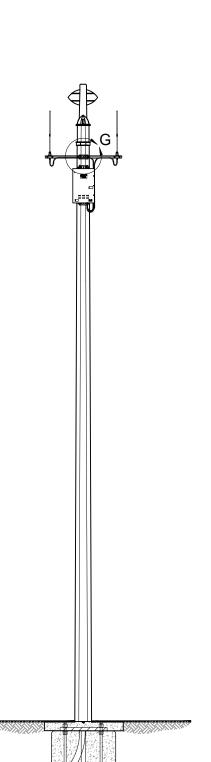
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		MATERIALS LIST				
ITEM NO.	PART NUMBER	DESCRIPTION	QTY.			
1	11700-CELL-AC-SCG	DCU (DATA COLLECTION UNIT) CABINET	1			
2	109-9975D	UHF ANT BASE ASSY	2			
3	073-0010	455-470MHz ANTENNAS/LAIRD ANTENNAS	2			
4	056-9975M	ANTENNA BOOM, 4 FT	1			
5	109-10700-02	MTG KIT, METAL/CONCRETE POLE, AC	1			
	069-561832LS	5/16-18 X 1", HEX HEAD BOLT,SS	12			
	069-3304	5/16 " SPR LW, .32 ID X .59 OD, 18-8 SS	12			
	069-3305	5/16 F/WASH METAL, SS	12			
	069-3306	5/16-18 HEX NUT SS	12			
	067-5373D	BANDING CLAMP $\frac{3}{4}$ SS 201, UB256	6			
	067-5373G	BANDING BRACKET	3			
	067-5373C	BANDING STRAP $\frac{3}{4}$ "X.02" A302 SS	3			
	070-2570-06	6' COAX CABLES BETWEEN ANTENNAS & DCU	2			
*6	098-0054	CABLE MGMT. BRACKETS (TRAP BOXES)	AS NEEDED			
*7	TBD	SNAP-IN CLAMP	AS NEEDED			
*8	098-0056	LMT-400 2 HOLE BOOM CLAMP	AS NEEDED			
*9	098-0057	LMT-400 4 HOLE BOOM CLAMP	AS NEEDED			
*10	084-0119	FUSION TAPE	AS NEEDED			
*11	*11 TBD RIPLEY 5731 PHOTOCELL ADAPTER 1					
*CON	*CONTRACTOR SUPPLIED MATERIALS					





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REV.	DATE	REVISED BY:	INITIAL				
		REVISED 06/14/18					
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ADVANCED METER
THE GAS COMPANY TOWER
555 W. 5TH STREET
LOS ANGELES, CA 90013

PROJECT INFORMATION:

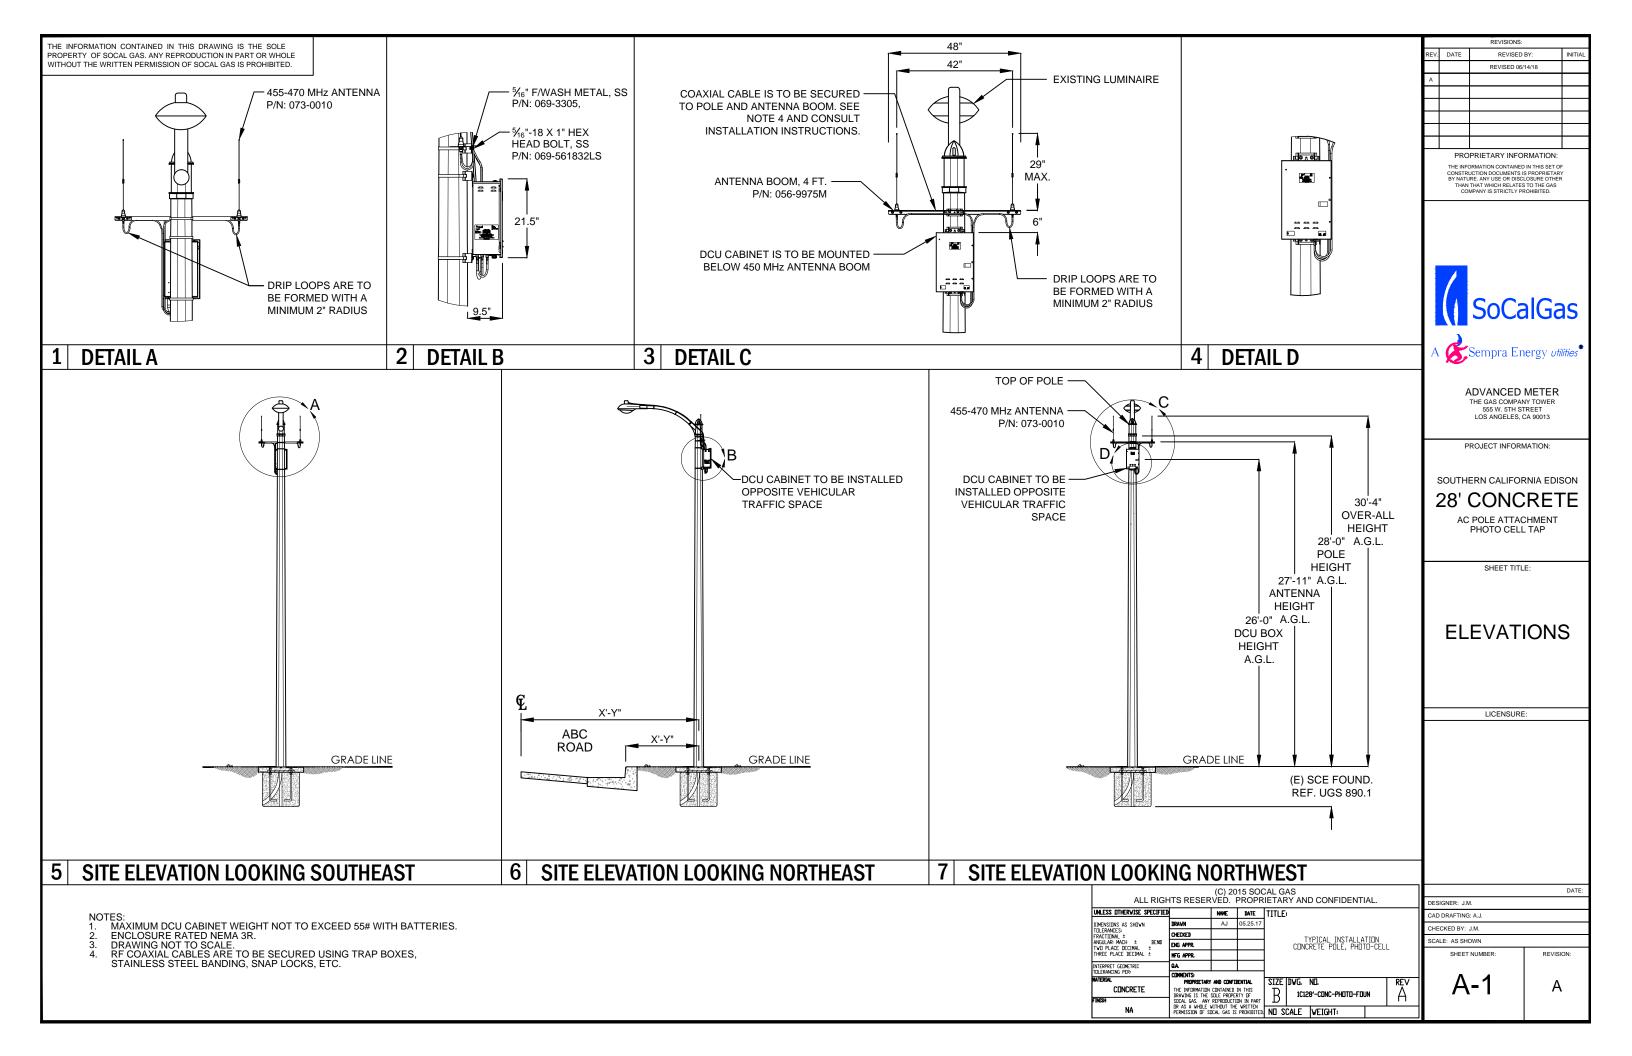SOUTHERN CALIFORNIA EDISON

28' CONCRETE

AC POLE ATTACHMENT PHOTO CELL TAP

SHEET TITLE:

MATERIALS LIST

LICENSURE:

NOTES:
1. MAXIMUM DCU CABINET WEIGHT NOT TO EXCEED 55# WITH BATTERIES.
2. ENCLOSURE RATED NEMA 3R.
3. DRAWING NOT TO SCALE.
4. RF COAXIAL CABLES ARE TO BE SECURED USING TRAP BOXES, STAINLESS STEEL BANDING, SNAP LOCKS, ETC.


(C) 2015 SOCAL GAS ALL RIGHTS RESERVED. PROPRIETARY AND CONFIDENTIAL. NAME DATE TITLE: UNLESS OTHERVISE SPECIFIED DIMENSIONS AS SHOWN
TOLLERANCES:
FRACTIONAL ±
ANGULAR MACH ± BEND
TVD PLACE DECIMAL ±
THREE PLACE DECIMAL ± CHECKED TYPICAL INSTALLATION CONCRETE POLE, PHOTO-CELL ENG APPR. MFG APPR. INTERPRET GEOMETRIC TOLERANCING PER: COMENTS
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PERMISSION OF SIZEL AGS IS PROHIBITED

NO. SCALE VEIGHT: CONCRETE B 1C128'-CONC-PHOTO-FOUN

·	DATE:
DESIGNER: J.M.	
CAD DRAFTING: A.J.	
CHECKED BY: J.M.	
SCALE: AS SHOWN	
SHEET NUMBER:	REVISION:
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CONFIGURATION	ALWAYS ON PHOTOCONTROL MAINTAINS NORMAL OPERATION
NOMINAL VOLTAGE 50/60 Hz	120
VOLTAGE RANGE	105 - 135
BASE	STANDARD 3-PRONG TWIST-LOCK PER ANSI C136.10
HOUSING	3-1/2" DIAMETER POLYPROPYLENE
CORD LENGTH	5 FEET (STANDARD) - OTHER CORD LENGTHS AVAILABLE
CORD CONNECTION *	w/ PIGTAIL, 2-PRONG RECEPTACLE, OR 3-POLE FEMALE MINI-LINK
CIRCUIT BREAKER	10 AMP, AUTO-RESET
LOAD RATING	10 AMP
OPERATING TEMPERATURE	-40C TO +70C (-40F TO +158F)
PHOTOCONTROL	NOT INCLUDED. SOLD SEPARATELY
DIELECTRIC STRENGTH	5000 VOLTS BETWEEN CURRECT CARRYING PARTS & METAL SURFACES
*CORD CONNECTION OPTIONS	OPTION CODE (ADD TO END OF MODEL NUMBER)
PIGTAIL	-1
2-PRONG RECEPTACLE	-2
3-POLE FEMALE MINI-LINK	-3

RIPLEY 5731-05

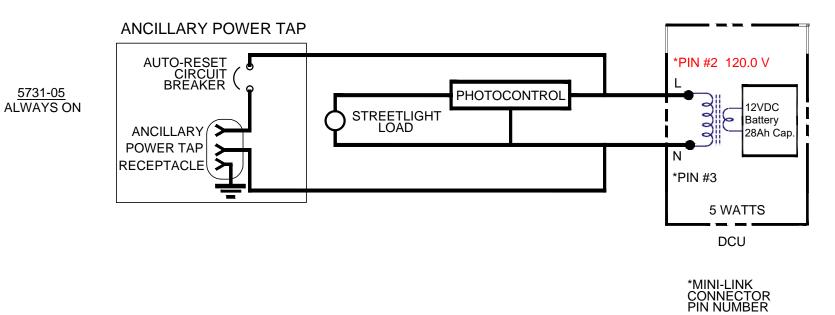

STREET LIGHT PHOTOCELL TAP

<u>5731-05</u>

- NOTES:
 1. MAXIMUM DCU CABINET WEIGHT NOT TO EXCEED 55# WITH BATTERIES.
 2. ENCLOSURE RATED NEMA 3R.
 3. DRAWING NOT TO SCALE.
 4. RF COAXIAL CABLES ARE TO BE SECURED USING TRAP BOXES, STAINLESS STEEL BANDING, SNAP LOCKS, ETC.

NOTES:

- 1. TAP CONDUCTORS SHALL COMPLY WITH NEC ART. 240.21(A)(B) TAP RULE.
- 2. IT IS ASSUMED THAT AMPLE POWER CAPACITY IS AVAILABLE AT THE STREET LIGHT FEEDER FOR THE ADDITIONAL LOAD

REVISIONS:						
REV.	DATE	REVISED BY:	INITIAL			
		REVISED 06/14/18				
Α						

PROPRIETARY INFORMATION:

THE INFORMATION CONTAINED IN THIS SET OF CONSTRUCTION DOCUMENTS IS PROPRIETARY BY NATURE. ANY USE OR DISCLOSURE OTHER THAN THAT WHICH RELATES TO THE GAS COMPANY IS STRICTLY PROHIBITED.





ADVANCED METER
THE GAS COMPANY TOWER
555 W. 5TH STREET
LOS ANGELES, CA 90013

PROJECT INFORMATION:

SOUTHERN CALIFORNIA EDISON

28' CONCRETE

AC POLE ATTACHMENT PHOTO CELL TAP

SHEET TITLE:

ELECTRICAL DIAGRAM

LICENSURE:

(C) 2015 SOCAL GAS										
ALL RIGHTS RESERVED. PROPRIETARY AND CONFIDENTIAL.									DESIGNER: J.M.	
UNLESS OTHERVISE SPECIFIED		NAME	DATE	TITLE	TITLE:			CAD DRAFTING:	A.J.	
DIMENSIONS AS SHOWN TOLERANCES: FRACTIONAL ± ANGULAR: MACH ± BEND TVD PLACE DECIMAL ± THREE PLACE DECIMAL ±	DRAVN								CHECKED BY: J.	М.
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	DESIGNER: J.M.						
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