

1	REV:	DATE/BY:	REVISION DESCRIPTION:
П	0	FXC 03/05/2013	ISSUED FOR REVIEW
	1	SA 03/19/2013	ISSUED FOR APPROVAL
	2	FXC 03/27/2013	ISSUED FOR FINAL

Civil Engineer CONNELL DESIGN GROUP, LLC CONSULTING CIVIL ENGINEERS

CLIENT:



STAMP:

SITE INFO:

MON03m1 VERIZON MONTECITO-MON03m1

SITE ADDRESS: THOMAS BROS PAGE 997 GRID C2 ROW ADJACENT WEST SIDE OF SHEFFIELD DRIVE (ADJACENT TO 2165 BIRNAM WOOD DR) SANTA BARBARA, CA 93108 LAT: 34.430908 LONG: -119.605144


SHEET TITLE:

DETAILS


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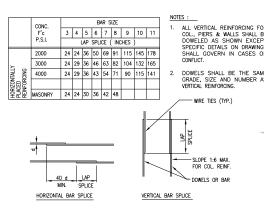
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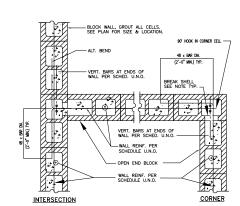
CMU DETAIL @ TOP / END



TYP. BAR BEND RADIUS

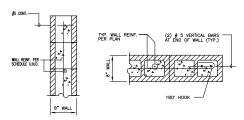


TYP. BAR LAP SPLICE

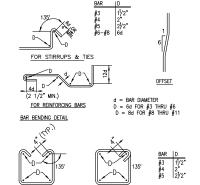

BLOCK LAYOUT SHOWN IS DIAGRAMMATIC, ACTUAL CONDITION WILL WARY PER RUNNING BOND PATTERN, USE APPROPRIATE UNITS OR BREAK CMU SHELL AS REQUIRED, FOR REPROPRISING PLACEMENT AND ELOW OF CROUT

CMU DETAIL @ CORNER / INTERSECTION

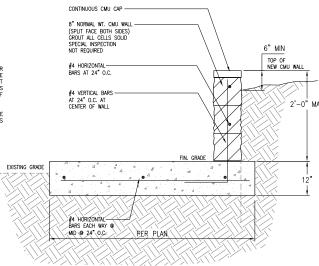

Power

AlphaCell™

GXL GelCell Batteries








NEW 195 GXL and 220 GXL:

- > High-performance Silver Alloy for maximum life expectancy
- Longer runtime for demanding outdoor environments
- 100% runtime capacity out-of-box No cycling required
- Maintenance-free threaded inserts No periodic retorquing
- Available with 4 and 5 year full warranties
- Wide operating temperature range

Alpha's standby battery offering incorporates Gel for thermal dissipation to ensure optimal life performance for your particular Broadband, Traffic or Wi-fi application. AlphaCell Batteries provide the longest runtimes and the best longevity in today's demanding outdoor applications and are backed by Alpha's industry-leading, non-prorated hassle-free warranties.

Alpha Technologies member of The விழிம் Group?



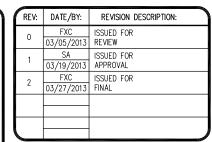

ENGINEER/CONSULTANT:



CLIENT:



STAMP:

SITE INFO:

SITE NAME:

MON03m1 VERIZON MONTECITO-MON03m1

SITE ADDRESS: THOMAS BROS PAGE 997 GRID C2 ROW ADJACENT WEST SIDE OF SHEFFIELD DRIVE (ADJACENT TO 2165 BIRNAM WOOD DR) SANTA BARBARA, CA 93108 LAT: 34.430908 LONG: -119.605144

SHEET TITLE:

BATTERY SPECS


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SHEET NUMBER:

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NOT USED N.T.S. | 1 BATTERY SPECIFICATIONS N.T.S. | 2 |



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BATTERY SPECS

DRAWING INFO:

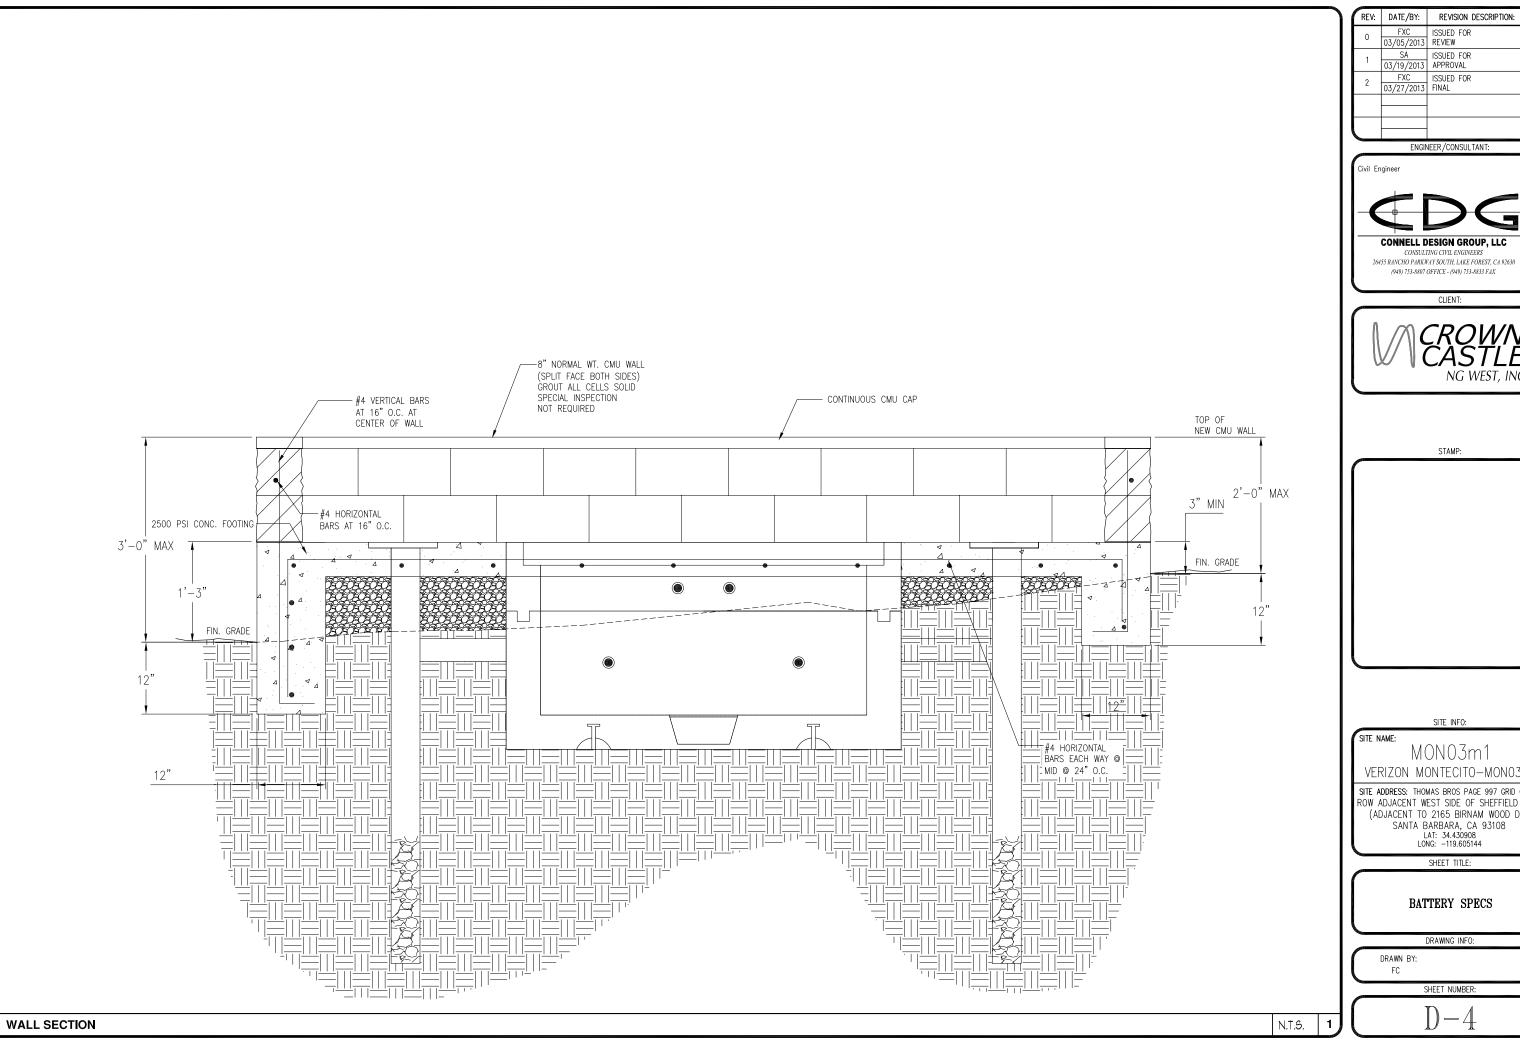FC

- . APPROVAL OF THESE PLANS BY THE CITY ENGINEER DOES NOT AUTHORIZE ANY WORK TO BE PERFORMED UNTIL A PERMIT HAS
- 2. UPON ISSUANCE OF A PERMIT, NO WORK WILL BE PERMITTED ON WEEKENDS OR HOLIDAYS WITHOUT PERMISSION FROM THE
- 3, THE APPROVAL OF THIS PLAN OR ISSUANCE OF A PERMIT BY THE LOCAL JURISDICTION DOES NOT AUTHORIZE THE SUBDIVIDER AND OWNER TO VIOLATE ANY FEDERAL. STATE OR CITY LAWS, ORDINANCES, REGULATIONS, OR POLICIES, INCLUDING, BUT NOT LIMITED TO, THE FEDERAL ENDANGERED SPECIES ACT OF 1973 AND AMENDMENTS THERETO (16 USC SECTION 1531 ET.SEQ.)
- 4. THE CONTRACTOR SHALL BE RESPONSIBLE FOR SURVEY MONUMENTS AND/OR VERTICAL CONTROL BENCHMARKS WHICH ARE IN THE CONTROLLOR STAIL BE RESPONSIBLE FOR SURVEY MONOMENTS AND/OR VERTICAL CONTROL BENCHMARKS WHICH ARE DISTURBED OR DESTROYED BY CONSTRUCTION A LAND SURVEYOR MUST FIELD LOCATE, REFERENCE, AND/OR PRESERVE ALL HISTORICAL OR CONTROLLING MONUMENTS PRIOR TO ANY EARTHWORK. IF DESTROYED, SUCH MONUMENTS SHALL BE REPLACED WITH APPROPRIATE MONUMENTS BY A LAND SURVEYORS, A CORNER RECORD OR RECORD OF SURVEY, AS APPROPRIATE, SHALL BE FIELD AS REQUIRED BY THE PROFESSIONAL LAND SURVEYORS ACT. IF ANY VERTICAL CONTROL IS TO BE DISTINGED OR DESTROYED, THE LOCAL JURISDICTION FIELD SURVEY SECTION MUST BE NOTIFIED, IN WRITING, AT LEAST 3 DAYS PRIOR TO THE CONSTRUCTION. THE CONTRACTOR WILL BE RESPONSIBLE FOR THE COST OF REPLACING ANY VERTICAL CONTROL BENCHMARKS
- 5. IMPORTANT NOTICE: SECTION 4216 OF THE GOVERNMENT CODE REQUIRES A DIG ALERT IDENTIFICATION NUMBER BE ISSUED BEFORE A "PERMIT TO EXCAVATE" WILL BE VALID. FOR YOUR DIG ALERT I.D. NUMBER, CALL UNDERGROUND SERVICE ALERT, TWO
- 6. CONTRACTOR SHALL BE RESPONSIBLE FOR THE POTHOLE AND LOCATING OF ALL EXISTING UTILITIES THAT CROSS THE PROPOSED TRENCH LINE AND MUST MAINTAIN 1' MINIMUM VERTICAL CLEARANCE.
- 7. CONTRACTOR SHALL SUBMIT TO THE LOCAL JURISDICTION, A CONSTRUCTION PLAN TO PROTECT WATER MAINS PRIOR TO COMMENCING CONSTRUCTION.
- 8. CONTRACTOR SHALL REPLACE OR REPAIR ALL TRAFFIC SIGNAL LOOPS, CONDUIT, AND LANE STRIPING DAMAGED DURING
- 9. CONTRACTOR SHALL NOTIFY THE LOCAL JURISDICTION. A MINIMUM OF 48 HOURS PRIOR TO COMMENCING WORK WITHIN 10' OF
- 10. THIS PROJECT WILL BE INSPECTED BY ENGINEERING AND CAPITAL PROJECTS DEPARTMENT, FIELD ENGINEERING DIVISION.
- 11. AS-BUILT DRAWINGS MUST BE SUBMITTED TO THE CITY RESIDENT ENGINEER PRIOR TO THE ACCEPTANCE OF THIS PROJECT. 12. PUBLIC IMPROVEMENT SUBJECT TO DESUETUDE OR DAMAGE." IF REPAIR OR REPLACEMENT OF SUCH PUBLIC IMPROVEMENTS IS REQUIRED. THE OWNER SHALL OBTAIN THE REQUIRED PERMITS FOR WORK IN THE PUBLIC RIGHT-OFWAY, SATISFACTORY TO TH
- 13. PRIOR TO ANY DISTURBANCE TO THE SITE, EXCLUDING UTILITY MARKS-OUTS AND SURVEYING, THE CONTRACTOR SHALL MAKE ARRANGEMENTS FOR A PRE-CONSTRUCTION MEETING WITH THE LOCAL JURISDICTION FIELD ENGINEERING DIMSION.
- 14. PRIOR TO THE COMMENCEMENT OF ANY CONSTRUCTION SHOWN ON THESE PLANS. IT IS THE SOLE RESPONSIBILITY OF THE CONTRACTOR TO COORDINATE. THE CONTRACTOR IS RESPONSIBLE TO ATTEND THE LOCAL JURISDICTIONS MONTHLY UTILITY COORDINATION COMMITTEE THE CONSTRUCTION ACTIVITIES WITH THE CITY AND ALL OTHER CONTRACTORS SO THAT NO TRENCH IS CUT WITHIN ANY OF THE CITY STREETS THAT HAVE BEEN CONSTRUCTED, REPAIRED, OR SLURRY SEALED WITHIN THREE YEARS OF THE STREET CONSTRCTUION/RESURFACING DATE.
- 15. MANHOLES OR COVERS SHALL BE LABELED "CROWN CASTLE" OR "CROWN CASTLE NG WEST".
- 16. CONTRACTOR SHALL IMPLEMENT AN EROSION AND SEDIMENT CONTROL PROCRAM DURING THE PROJECT CONSTRUCTION ACTIVITIES PROGRAM SHALL MEET THE APPLICABLE REQUIREMENTS OF THE STATE WATER RESOURCE CONTROL BOARD
- 17. THE CONTRACTOR SHALL HAVE EMERGENCY MATERIALS AND EQUIPMENT ON HAND FOR UNFORESEEN SITUATIONS, SUCH AS DAMAGE TO UNDERGROUND WATER, SEWER, AND STORM DRAIN FACILITIES WHEREBY FLOWS MAY GENERATE EROSION AND SEDIMENT

SPECIAL NOTES

THE FOLLOWING NOTES ARE PROVIDED TO GIVE DIRECTIONS TO THE CONTRACTOR BY THE ENGINEER OF WORK. THE CITY ENGINEER'S SIGNATURE ON THESE PLANS DOES NOT CONSTITUTE APPROVAL OF THESE NOTES AND THE CITY WILL NOT BE RESPONSIBLE FOR THEIR ENFORCEMENT.

- THE CONTRACTOR SHALL VERIFY THE LOCATION EXISTING UNDERGROUND UTILITIES INCLUDING SEWER LATERALS AND WATER
 SERVICES TO INDIVIDUAL LOTS BOTH VERTICAL AND HORIZONTAL PRIOR TO COMMENCING IMPROVEMENT OPERATIONS.
- 2. CONTRACTOR SHALL MAKE EXPLORATION EXCAVATIONS AND LOCATE EXISTING FACILITIES SUFFICIENTLY AHEAD OF CONSTRUCTION TO PERMIT REVISIONS OF PLANS IF REVISION IS NECESSARY BECAUSE OF LOCATION OF EXISTING UTILITIES.
- 3. LOCATION AND ELEVATIONS OF IMPROVEMENTS. TO BE MET BY WORK, SHALL BE CONFIRMED BY FIELD MEASUREMENT PRIOR TO
- 4. GRADES SHOWN ARE FINISH GRADES, CONTRACTOR SHALL DETERMINE NECESSARY SUB GRADE ELEVATIONS AND SHALL CONSTRUCT SMOOTH TRANSITION BETWEEN FINISH GRADES SHOWN.
- 5. Contractor agrees that he shall assume sole responsibility for job site condition during the course of construction of this project, including safety of all persons and property: that this provision shall apply CONTINUOUSLY AND NOT BE LIMITED TO NORMAL WORKING HOURS; AND THAT THE CONTRACTOR SHALL DEFEND, INDEMNIFY AND HOLD THE OWNER AND THE ENGINEER HARMLESS FROM ANY AND ALL LIABILITY. REAL OR ALLEGED IN CONNECTION WITH THI PERFORMANCE OF WORK ON THIS PROJECT, EXPECTING FOR LIABILITY ARISING FROM SOLE NEGLIGENCE OF THE OWNER OR THE
- 6. THE CONTRACTOR SHALL BE TOTALLY RESPONSIBLE FOR COMPLIANCE WITH THE PROVISIONS OF THE STATE OF CALIFORNIA SAFETY
- 7. THE LOCATIONS OF ALL EXISTING UTILITIES SHOWN ON THESE PLANS ARE FROM EXISTING RECORDS AND CORROBORATED, WHERE POSSIBLE WITH FIELD TIES. THE CONTRACTOR IS RESPONSIBLE FOR CONFIRMING THE LOCATIONS SHOWN, BOTH HORIZONTALLY AND VERTICALLY, PRIOR TO CONSTRUCTION. IF EXISTING LOCATIONS VARY SUBSTANTIALLY FROM THE PLANS, THE ENGINEER SHOULD BE NOTIFIED TO MAKE ANY CONSTRUCTION CHANGES REQUIRED.
- 8. THE CONTRACTOR SHALL PROVIDE TEMPORARY SUPPORT FOR ALL SEWER AND WATER MAIN UNDER CROSSING IN ACCORDANCE WITH PART 1 SECTION 5-2 OF THE STANDARD SPECIFICATION.
- 9. THE CONTRACTOR SHALL REPLACE OR REPAIR ALL TRAFFIC SIGNAL LOOPS, CONDUITS, AND LANE STRIPING DAMAGED DURING
- 10. THE CONTRACTOR SHALL SUBMIT WORK PLANS FOR ALL BORE OPERATIONS TWO WEEKS PRIOR TO COMMENCING WORK.
- 11. CONTRACTOR SHALL BE RESPONSIBLE FOR THE POTHOLE AND LOCATING OF ALL EXISTING UTILITIES THAT CROSS THE PROPOSED
- 12. AS-BUILT DRAWINGS MUST BE SUBMITTED TO THE CITY ENGINEER PRIOR TO ACCEPTANCE OF THIS PROJECT



CONSTRUCTION CHANGE TABLE CHANGE DATE EFFECTED OR ADDED SHEET NUMBERS

CROWN CASTLE NG WEST, INC

VERIZON MONTECITO-MON05 R.O.W. SOUTH SIDE OF PARK LN (ADJACENT TO 985 PARK LN) SANTA BARBARA, CA 93108



☆ LIGHT POLE ELEVATION REF. — E — ELECT. CONDUIT GROUND BUS BAR MECH. GRND. CONN O FOUNDATION SECTION REF. CADWELD SPOT ELEV. ELECTRIC BOX -- — PROP./LEASE LINE MYERS PEDESTAL ▲ SET POINT TELEPHONE BOX MATCH LINE VAULT STANDARD 2'X3' A REVISION EXISTING SERVE SIDEWALK FLA EXISTING SERVICE POLE — WORK POINT

(x) DETAIL REF.

SYMBOLS, LINETYPES AND HATCH PATTERNS

— T — TELE, CONDUIT

— — CENTERLINE

APPLICABLE CODES

SIDEWALK FLAG

ALL WORK SHALL COMPLY WITH THE FOLLOWING APPLICABLE CODES:

- IN THE EVENT OF CONFLICT, THE MOST RESTRICTIVE CODE SHALL PREVAIL

PROJECT DESCRIPTION

PROJECT CONSISTS OF INSTALLATION OF

- 1. (2) OMNI ANTENNAS ON EXISTING UTILITY POLE
- 2. EQUIPMENT SHROUD ON EXISTING POLE
- 3. EQUIPMENT PEDESTAL W/ BBU AND ELECTRICAL METER AT BASE OF

SHEET INDEX:

STEEL POLE

TITLE SHEET	T-1 - SHEET 1 OF 9
TOPOGRAPHIC SURVEY	C-1 - SHEET 2 OF 9
SITE PLAN	A-1 - SHEET 3 OF 9
PROPOSED ELEVATIONS	A-2 - SHEET 4 OF 9
GRADING PLAN	A-3 - SHEET 5 OF 9
DETAILS	D-1 - SHEET 6 OF 9
DETAILS	D-2 - SHEET 7 OF 9
DETAILS	D-3 - SHEET 8 OF 9
DETAILS	D-4 - SHEET 9 OF 9

EROSION AND SEDIMENT CONTROL NOTES

TEMPORARY EROSION/SEDIMENT CONTROL, PRIOR TO COMPLETION OF FINAL IMPROVEMENTS. SHALL BE PERFORMED BY THE CONTRACTOR OR QUALIFIED PERSON AS INDICATED BELOW:

- 1. ALL REQUIREMENTS OF THE LOCAL JURISDICTION "LAND DEVELOPMENT MANUAL, STORM WATER STANDARDS" MUST BE INCORPORATED INTO THE DESIGN AND CONSTRUCTION OF THE PROPOSED GRADING/IMPROVEMENTS CONSISTENT WITH THE APPROVED STORM WATER AND/OR WATER POLLUTION CONTROL PLAN (WPCP).
- 2. FOR STORM DRAIN INLETS, PROVIDE A GRAVEL BAG SILT BASIN IMMEDIATELY UPSTREAM OF INLET AS INDICATED ON DETAILS.
- 3. FOR INLETS LOCATED AT SUMPS ADJACENT TO TOP OF SLOPES, THE CONTRACTOR SHALL ENSURE THAT WATER DRAINING TO THE SUMP IS DIRECTED INTO THE INLET AND THAT A MINIMUM OF 1.00" FREEBOARD EXISTS AND IS MAINTAINED ABOVE THE TOP OF THE INLET. IF FREEBOARD IS NOT PROVIDED BY GRADING SHOWN ON THESE PLANS, THE CONTRACTOR SHALL PROVIDE IT VIA TEMPORARY MEASURES, I.E. GRAVEL BAGS OR DIKES.
- 4. THE CONTRACTOR OR QUALIFIED PERSON SHALL BE RESPONSIBLE FOR CLEANUP OF SILT AND MUD ON ADJACENT STREET(S) AND STORM DRAIN SYSTEM DUE TO CONSTRUCTION
- 5. THE CONTRACTOR OR QUALIFIED PERSON SHALL CHECK AND MAINTAIN ALL LINED AND UNLINED DITCHES AFTER EACH RAINFALL.
- 6. THE CONTRACTOR SHALL REMOVE SILT AND DEBRIS AFTER EACH MAJOR RAINFALL.
- EQUIPMENT AND WORKERS FOR EMERGENCY WORK SHALL BE MADE AVAILABLE AT ALL TIMES DURING THE RAINY SEASON, ALL NECESSARY MATERIALS SHALL BE STOCKPILED ON SITE AT CONVENIENT LOCATIONS TO FACILITATE RAPID CONSTRUCTION OF TEMPORARY DEVICES WHEN RAIN IS IMMINENT.
- 8. THE CONTRACTOR SHALL RESTORE ALL EROSION/SEDIMENT CONTROL MEASURES TO WORKING ORDER TO THE SATISFACTION OF THE CITY ENGINEER OR RESIDENT ENGINEER AFTER EACH RUN-OFF PRODUCING RAINFALL.
- THE CONTRACTOR SHALL INSTALL ADDITIONAL EROSION CONTROL MEASURES AS MAY BE REQUIRED BY THE RESIDENT ENGINEER DUE TO UNCOMPLETED GRADING OPERATIONS OR UNFORESEEN CIRCUMSTANCES, WHICH MAY ARISE.
- 10. THE CONTRACTOR SHALL BE RESPONSIBLE AND SHALL TAKE NECESSARY PRECAUTIONS TO PREVENT PUBLIC TRESPASS ONTO AREAS WHERE IMPOUNDED WATERS CREATE A HAZARDOUS CONDITION.
- 11. ALL EROSION/SEDIMENT CONTROL MEASURES PROVIDED PER THE APPROVED GRADING PLAN SHALL BE INCORPORATED HEREON. ALL EROSION/SEDIMENT CONTROL FOR INTERIM CONDITIONS SHALL BE DONE TO THE SATISFACTION OF THE RESIDENT ENGINEER. 12 CRADED AREAS AROUND THE PROJECT PERIMETER MUST DRAIN AWAY FROM THE FACE
- 13. ALL REMOVABLE PROTECTIVE DEVICES SHOWN SHALL BE IN PLACE AT THE END OF EACH
- 14. THE CONTRACTOR SHALL ONLY GRADE, INCLUDING CLEARING AND GRUBBING FOR THE AREAS FOR WHICH THE CONTRACTOR OR QUALIFIED PERSON CAN PROVIDE
- 15. THE CONTRACTOR SHALL ARRANGE FOR WEEKLY MEETINGS DURING OCTOBER 1ST TO APRIL 30TH FOR PROJECT TEAM (GENERAL CONTRACTOR, QUALIFIED PERSON, EROSION CONTROL SUBCONTRACTOR IF ANY, ENGINEER OF WORK, OWNER AND THE RESIDENT ENGINEER) TO EVALUATE THE ADEQUACY OF THE EROSION/SEDIMENT CONTROL MEASURES AND OTHER RELATED CONSTRUCTION ACTIVITIES.

TRAFFIC CONTROL NOTES

OF THE SLOPE AT THE CONCLUSION OF EACH WORKING DAY.

FROSION/SEDIMENT CONTROL MEASURES.

THE CONTRACTOR SHALL SUBMIT A TRAFFIC CONTROL PLAN (11" X 17") FOR APPROVAL PRIOR TO STARTING WORK. THE PLAN SHOULD BE SUBMITTED TO THE TRAFFIC CONTROL PERMIT COUNTER. CONTRACTOR SHALL OBTAIN A TRAFFIC CONTROL PERMIT A MINIMUM OF TWO (2) WORKING DAYS PRIOR TO STARTING WORK, AND A MINIMUM FIVE (5) DAYS IF WORK WILL AFFECT A BUS STOP OR AN EXISTING TRAFFIC SIGNAL, OR IF WORK WILL REQUIRE A

FOOTAGE TOTALS	
ASPHALT CUT	-
DIRT TRENCH	-
PUNCH THRU	-
BORE	-
TOTAL	-
R&R SWF TOTAL	_

PROJECT DICTIONARY

R.O.W. SOUTH SIDE OF PARK LN SITE ADDRESS: (ADJACENT TO 985 PARK LN) SANTA BARBARA, CA 93108

CROWN CASTLE NG WEST, INC 2125 WRIGHT AVE. SUITE #C9 LA VERNE, CA 91750

CONTACT: HEIDI PAYNE PHONE: (949) 300-9493

CONNELL DESIGN GROUP, LLC CIVIL ENGINEER: 26455 RANCHO PARKWAY SOUTH LAKE FOREST, CA 92630 CONTACT: FRANK CARTER (949) 310-8233 PHONE

(949) 753-8833 FAX

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ENGINEER/CONSULTANT:



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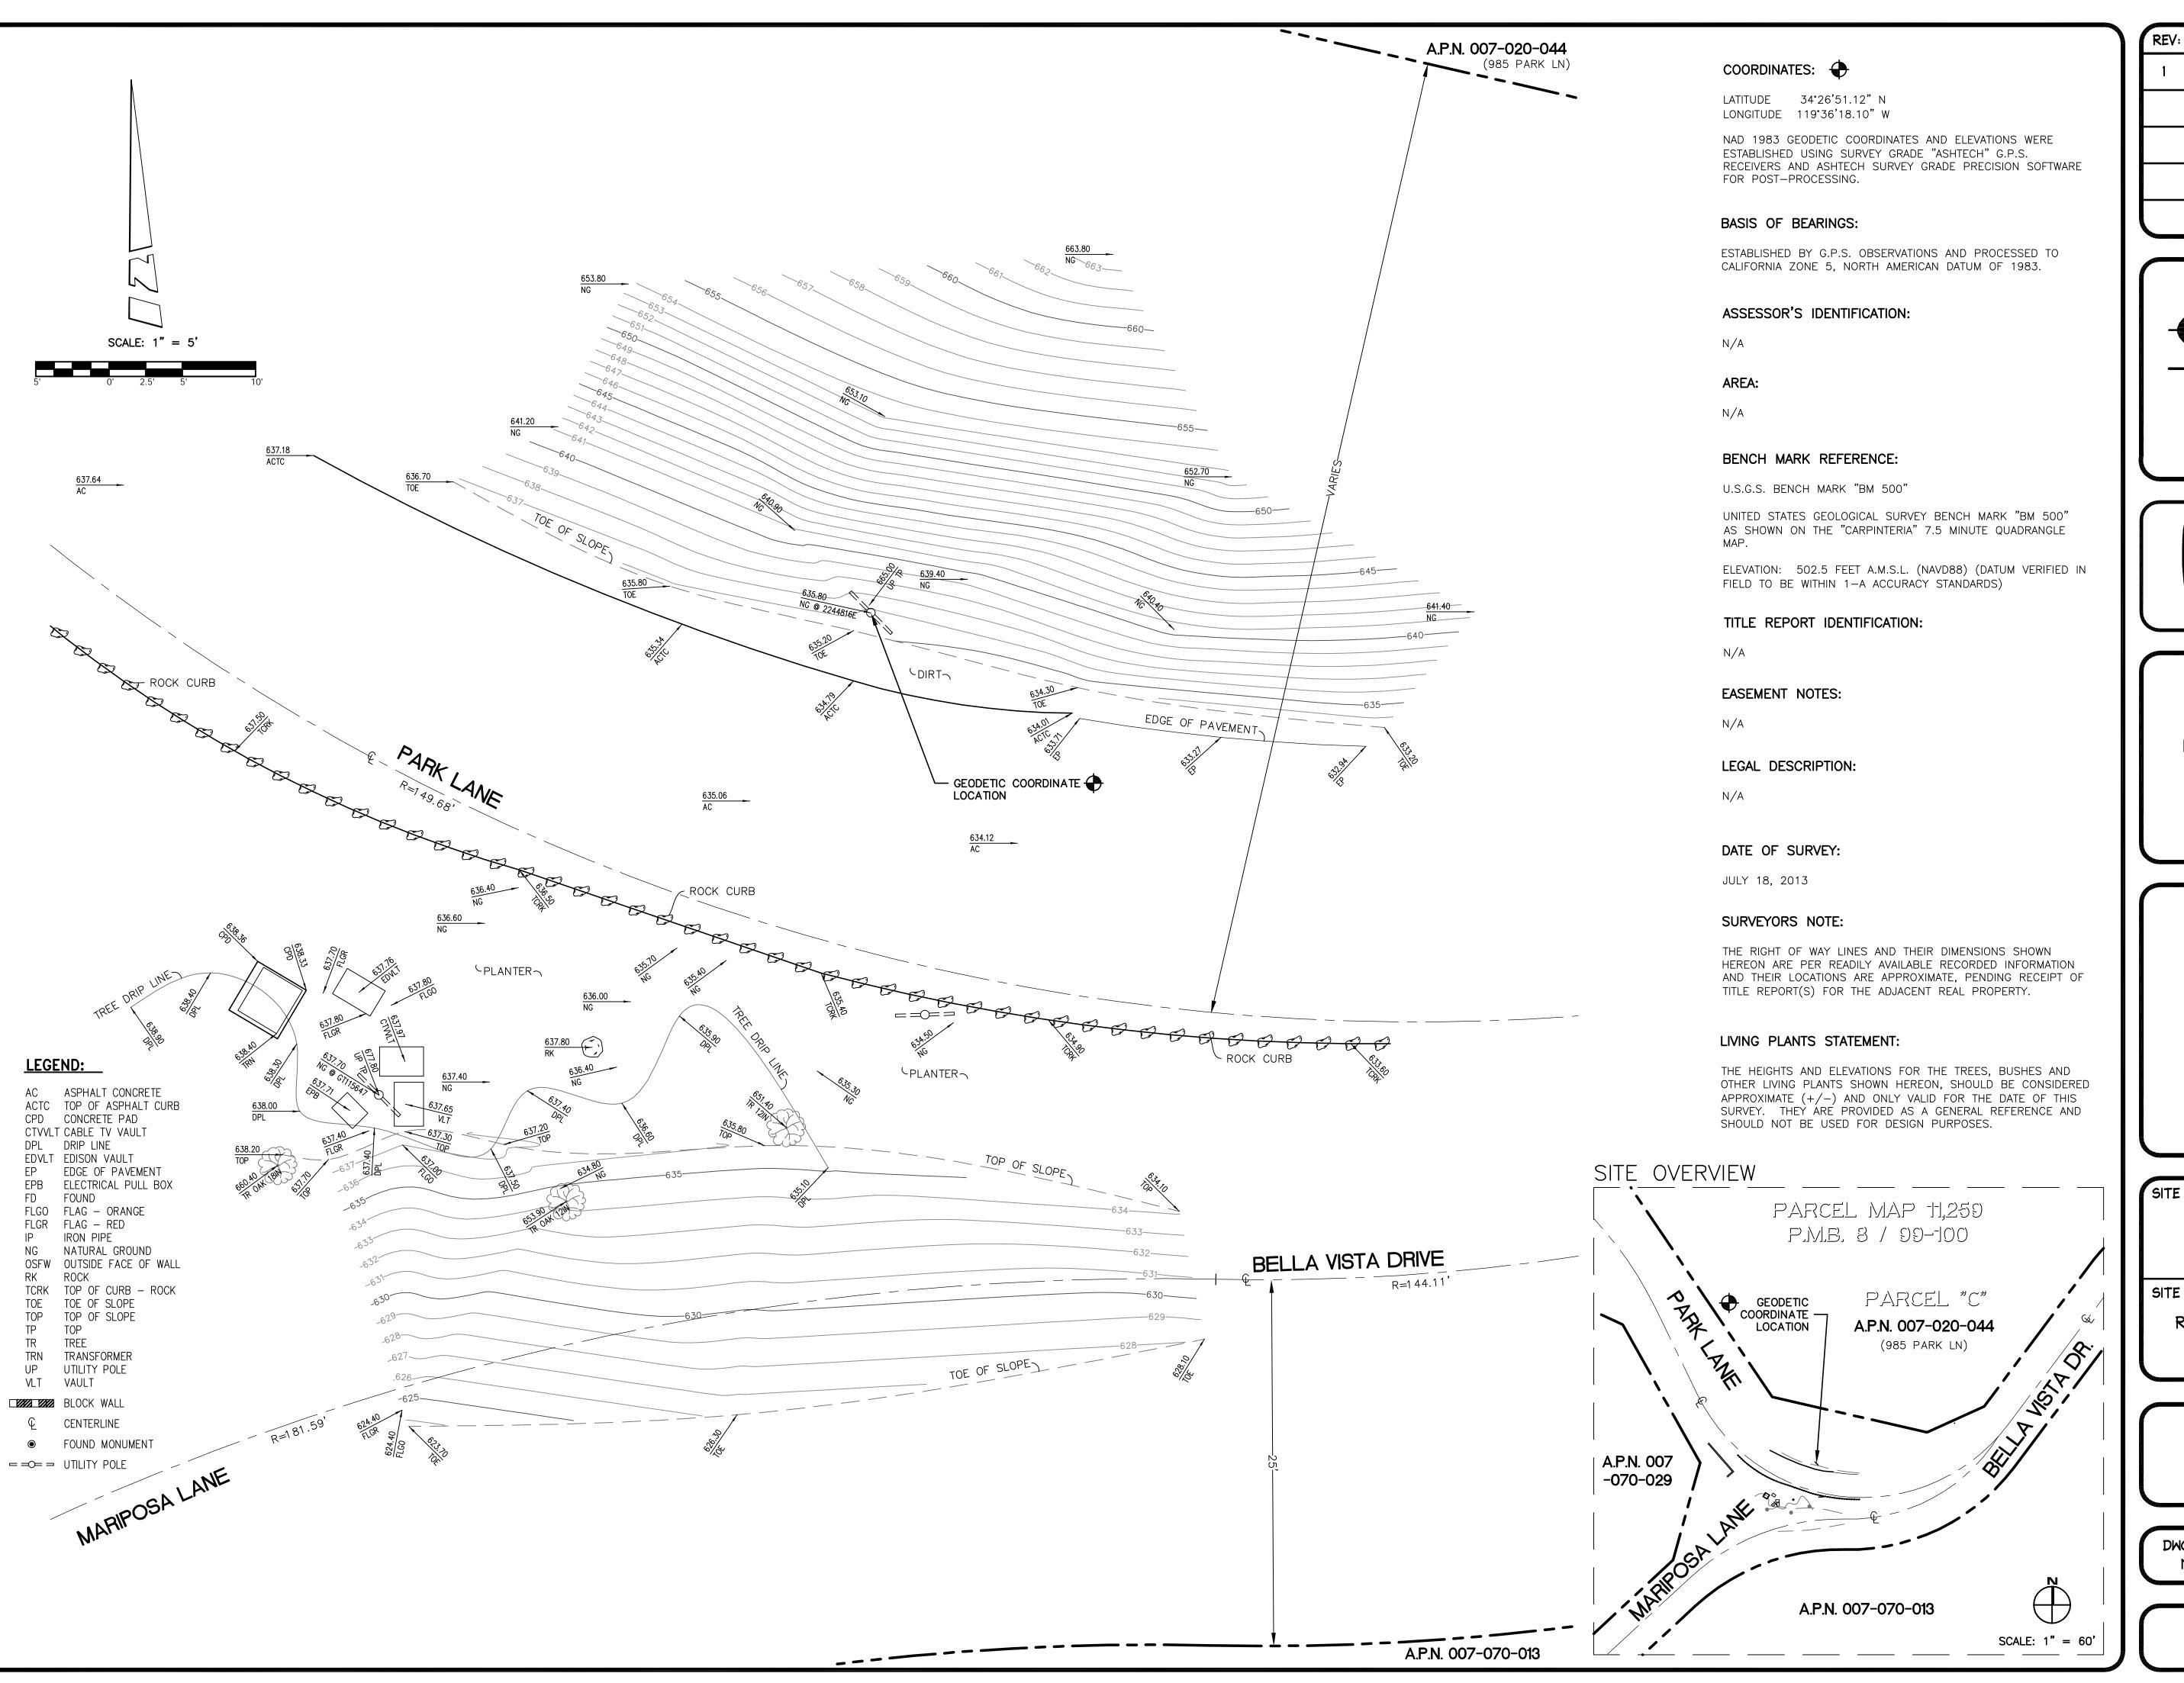
MON05 VERIZON MONTECITO-MON05

SITE ADDRESS: THOMAS BROS PAGE 987 GRID C7 R.O.W. SOUTH SIDE OF PARK LN (ADJACENT TO 985 PARK LN) SANTA BARBARA, CA 93108 LAT: 34.44746* LONG: -119.60497

SHEET TITLE:

TITLE SHEET

DRAWING INFO:



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	1	07/26/13	ISSUED FOR REVIEW	
		MDL/JA		
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26455 RANCHO PKWY. SOUTH

LAKE FOREST, CA 92630-8326 (949) 753-8807 OFFICE - (949) 753-8833 FAX

SITE BUILDER:



SURVEYOR:

BERT HAZE

AND ASSOCIATES, INC.

LAND SURVEYING & MAPPING

3188 AIRWAY AVENUE, SUITE K1


COSTA MESA, CALIFORNIA 92626

714 557-1567 OFFICE

714 557-1568 FAX

JN. 706.220

STAMP:

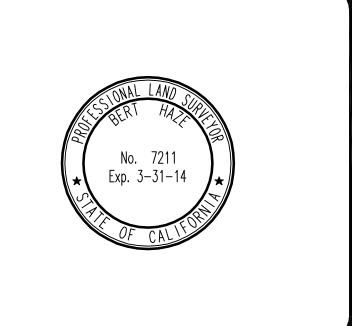

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MON05 VERIZON MONTECITO-MON05

SITE ADDRESS:

R.O.W. NORTH SIDE OF PARK LN (ADJACENT TO 985 PARK LN) SANTA BARBARA, CA 93108

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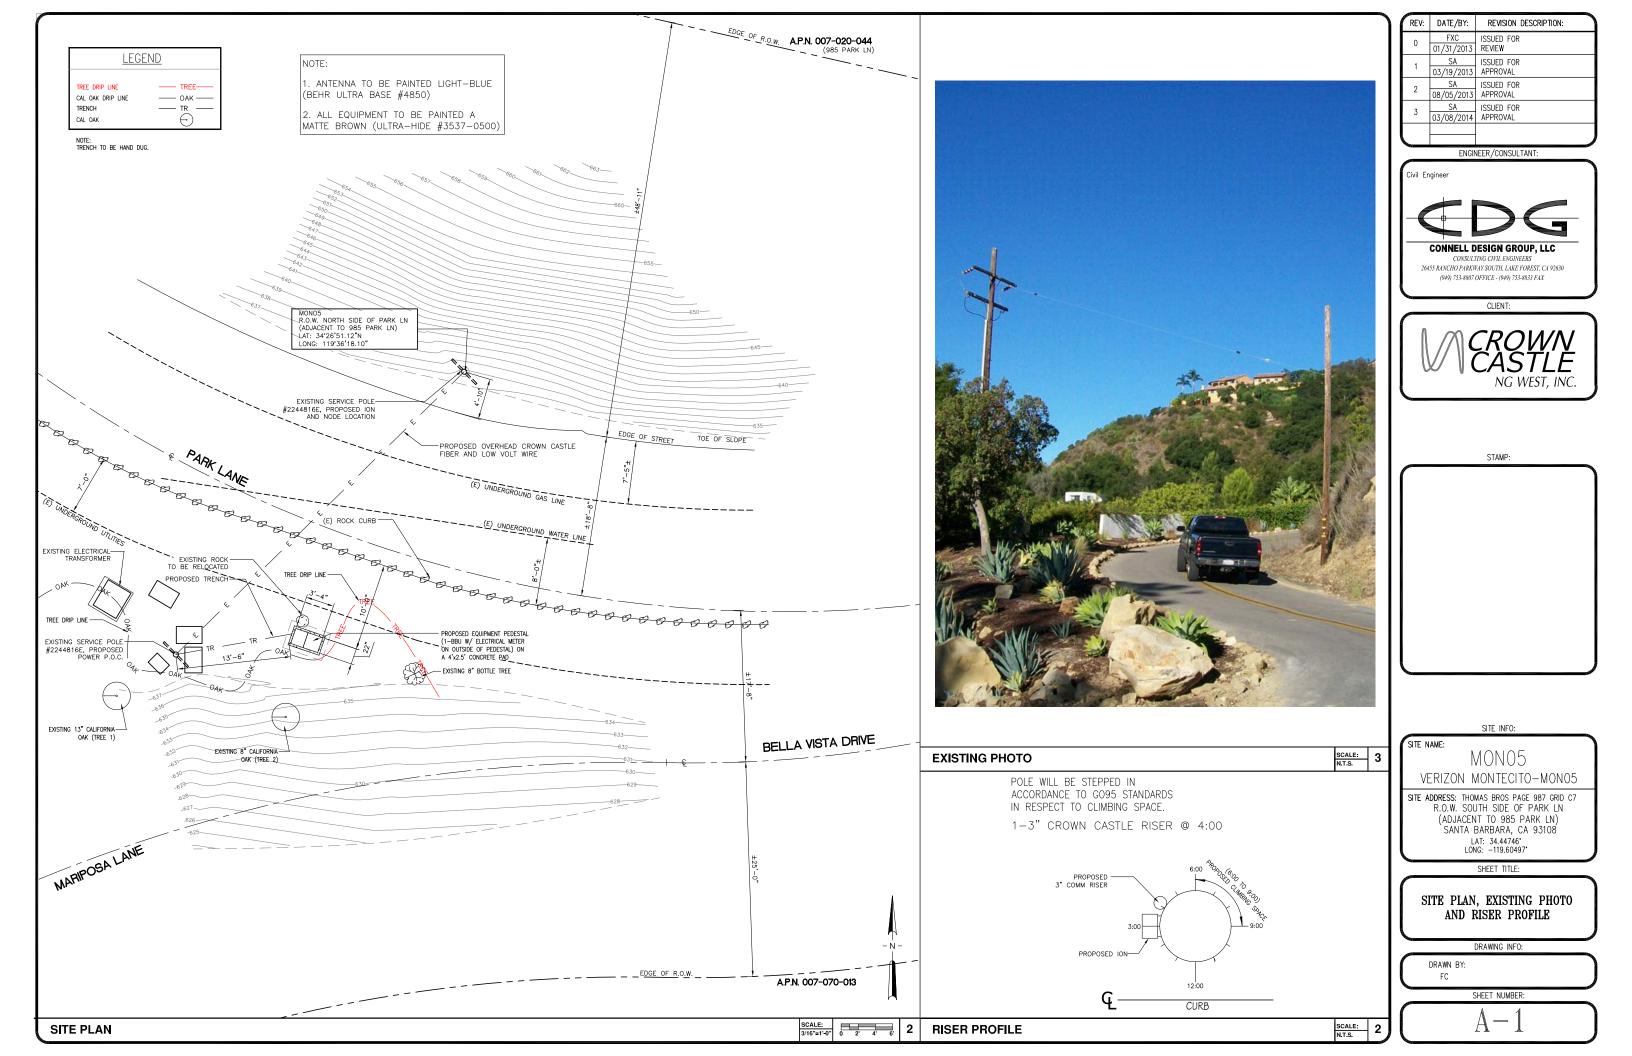
TOPOGRAPHIC SURVEY


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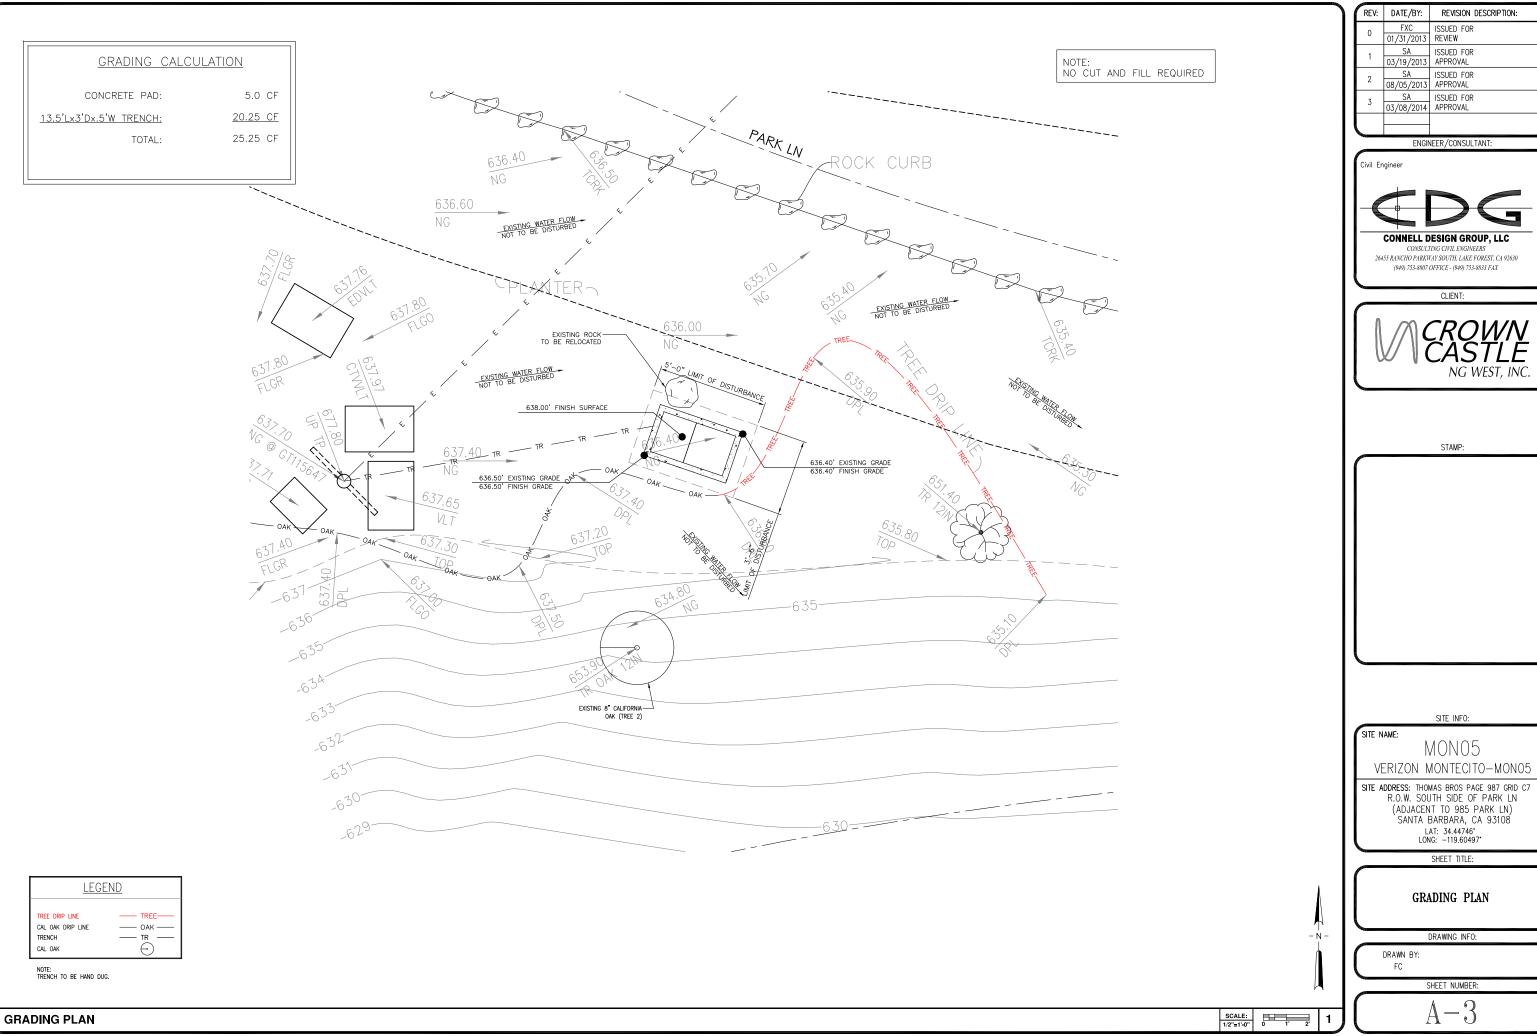
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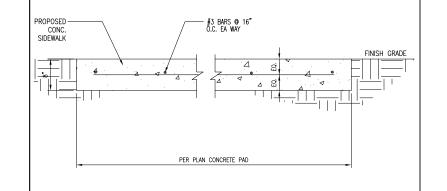
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VERIZON MONTECITO-MON05

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1 | CONCRETE PAD **UN-USED** N.T.S. N.T.S.

Electrical Power Supply Mains power, Vac . 1100 max. Power consumption, Watts < 750 @ normal operation 700 MHz SISO/MIMO Frequency range, MHz 698 to 716/776 to 787 728 to 757 Output power per carrier*, dBm Number of Carriers 1 850 MHz Frequency range, MHz 824 to 849 20W for Cell, 869 to 894 Output power per carrier*, dBm 700MHz MIMO Analog GSM 43 37 37

37 37 36

40 *

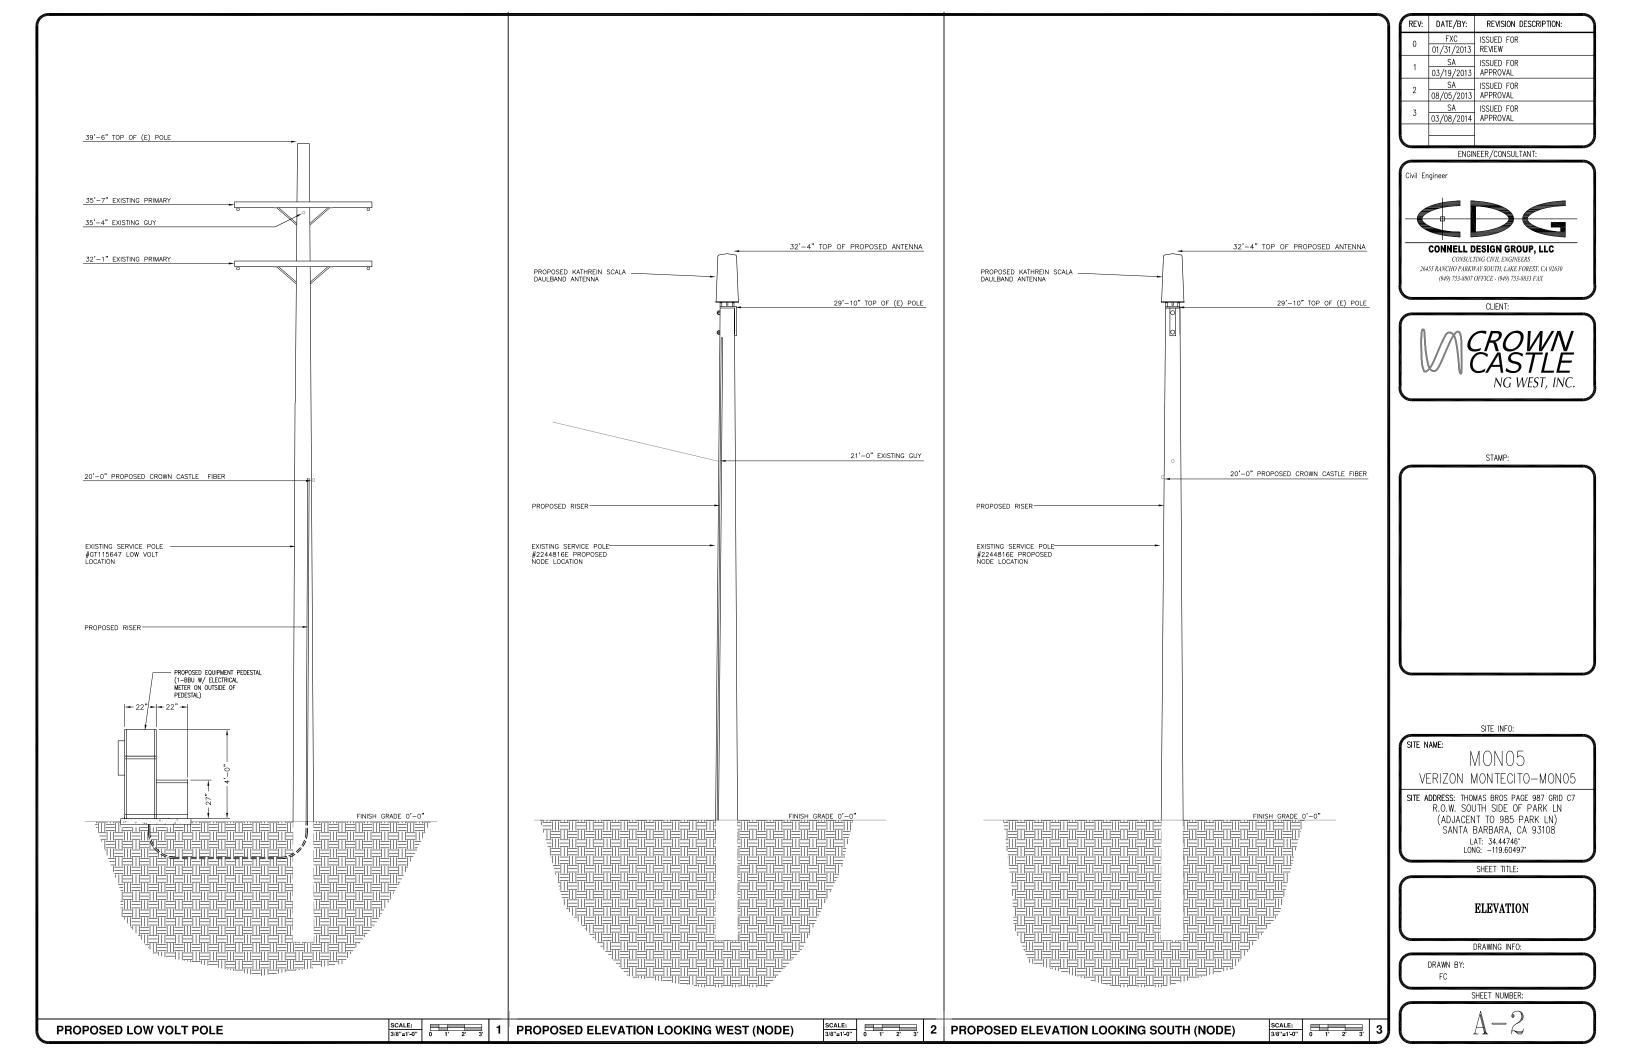43


43 43

CDMA

LTE



GSM LTE

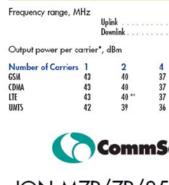



ION-M7P/7P/85P/19P

PCS bands and

. +6 max.

40 (88.2)

1850 to 1915

1930 to 1995

Mechanical**** Height, width, depth, mm (in) . 817 x 245 x 218 (32.2 x 9.6 x 8.6)

Page 1, February 27, 2013 Company Confidential

Weight, kg (lb)

NATIVE DIRT 3" DUCT

* TRENCH TO BE BACK FILL WITH NATIVE MATERIAL & COMPACTED TO 90% OR BETTER & REPLACE LANDSCAPING IN KIND.





- > Compact enclosure design provides ideal fit for locations where aesthetics are important
- > Light-weight powder coated aluminum construction offers superior corrosion resistant properties
- > Large sun shield, reduces solar heat loading inside the cabinet
- > 180° stainless steel piano-hinged door (with two locking open positions) make installation and maintenance easy and convenient
- > Thermostat controlled filtered fan cooling and louvered vents ensure reliable operation in high temperature environments
- > Various mounting options (including pole mount) make this highly versatile in space constrained mobile broadband applications

Alpha's Multi Mount Outdoor Enclosure (MMOE) - Telecom, is a cost-effective and versatile enclosure ideal for space constrained locations. The Multi Mourt can be pole, host, wall or pedestal mourted and can accommodate Alpha's FDM UPS and up to four Alpha'0el™ 850XL or 195 GWL front terminal batteries. With a small form factor, the Multi Mourt is the perfect choice for locations where confined space necessitate oreative installation options.



Alpha Multi Mount Outdoor Enclosure - Telecom

Dimensions:	
mm	
Inones:	27H x 22W x 18D
Neight:	27.2kg (60/bs)
Construction:	High strength corrosion resistant auminum
Finish:	Powder coated white color
Equipment space:	EIA standard 19", 5FIU space with one
	batlery shelf
Cable entrance:	Bottom of enclosure: 1 x 0" diameter
	knock-out
	(216' trade tize) 4 x 1.125' diameter knock-out
	(M, page cipe)
Hinge type:	Stainless steel plano hinge
Door prop:	Aluminum rod, 2 locking open positions
Door latch:	Belloore 216 compression look with paglock
	bracket
HVAC Specifica	tions
Contract of the Contract of th	
Cooling	Thermostat controlled 48/do fan, 100 cfm or

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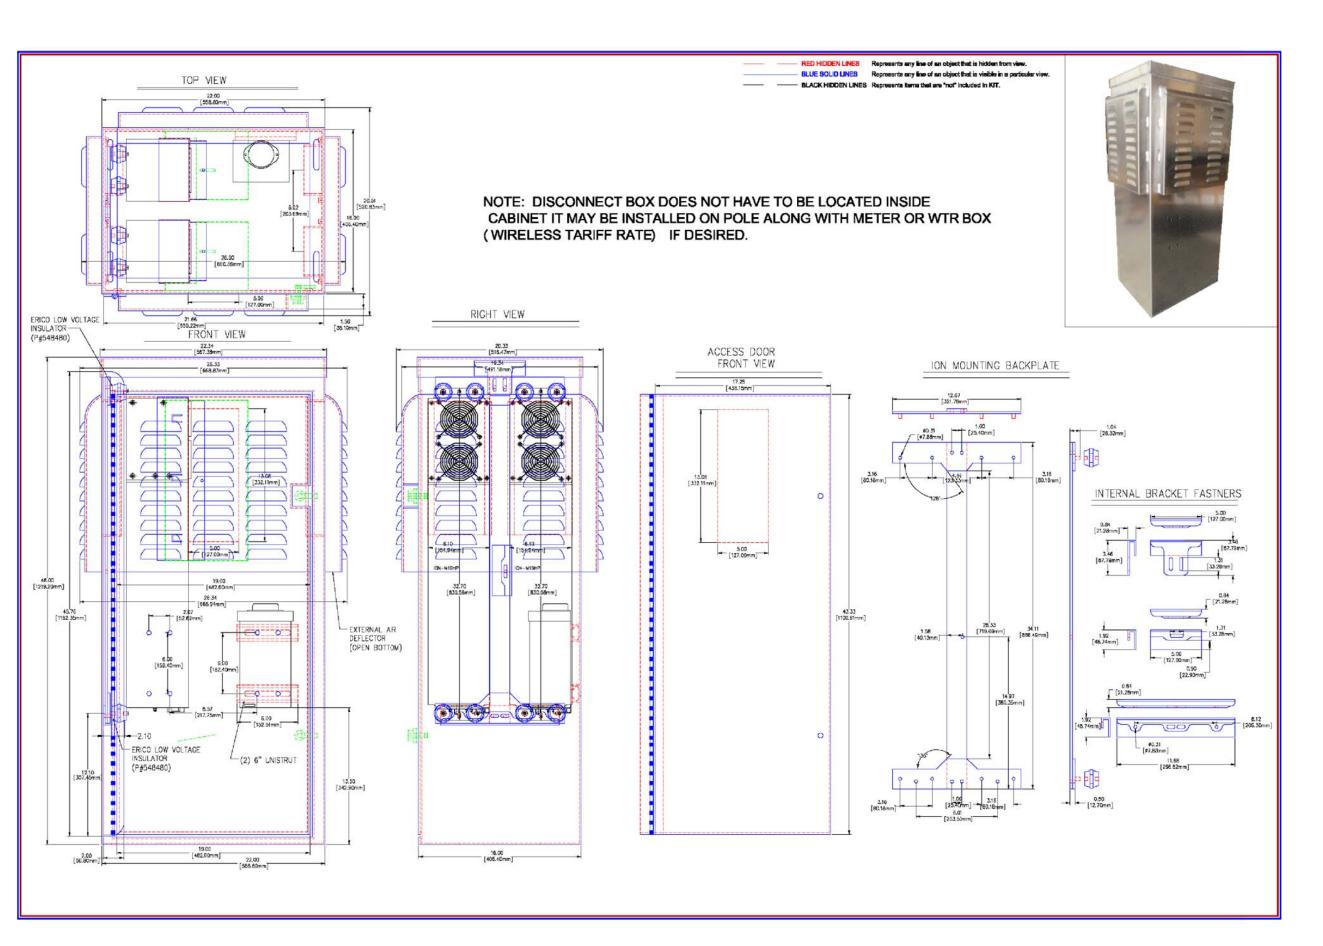
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N.T.S. 2 TRENCH PEDESTAL SPECIFICATIONS N.T.S. ION-M7P/7P/85P/19P



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CONNELL DESIGN GROUP, LLC

CONSULTING CIVIL ENGINEERS
26455 RANCHO PARKWAY SOUTH, LAKE FOREST, CA 92630

(949) 753-8807 OFFICE - (949) 753-8833 FAX

CLIENT:



STAMP:

SITE INFO:

MON05

VERIZON MONTECITO—MONO5

SITE ADDRESS: THOMAS BROS PAGE 987 GRID C7
R.O.W. SOUTH SIDE OF PARK LN
(ADJACENT TO 985 PARK LN)

(ADJACENT TO 985 PARK LN) SANTA BARBARA, CA 93108 LAT: 34.44746' LONG: -119.60497'

SHEET TITLE:

DETAILS

DRAWING INFO:


DRAWN BY FC

SHEET NUMBER:

D-2

ANTENNA MOUNT

N.T.S.

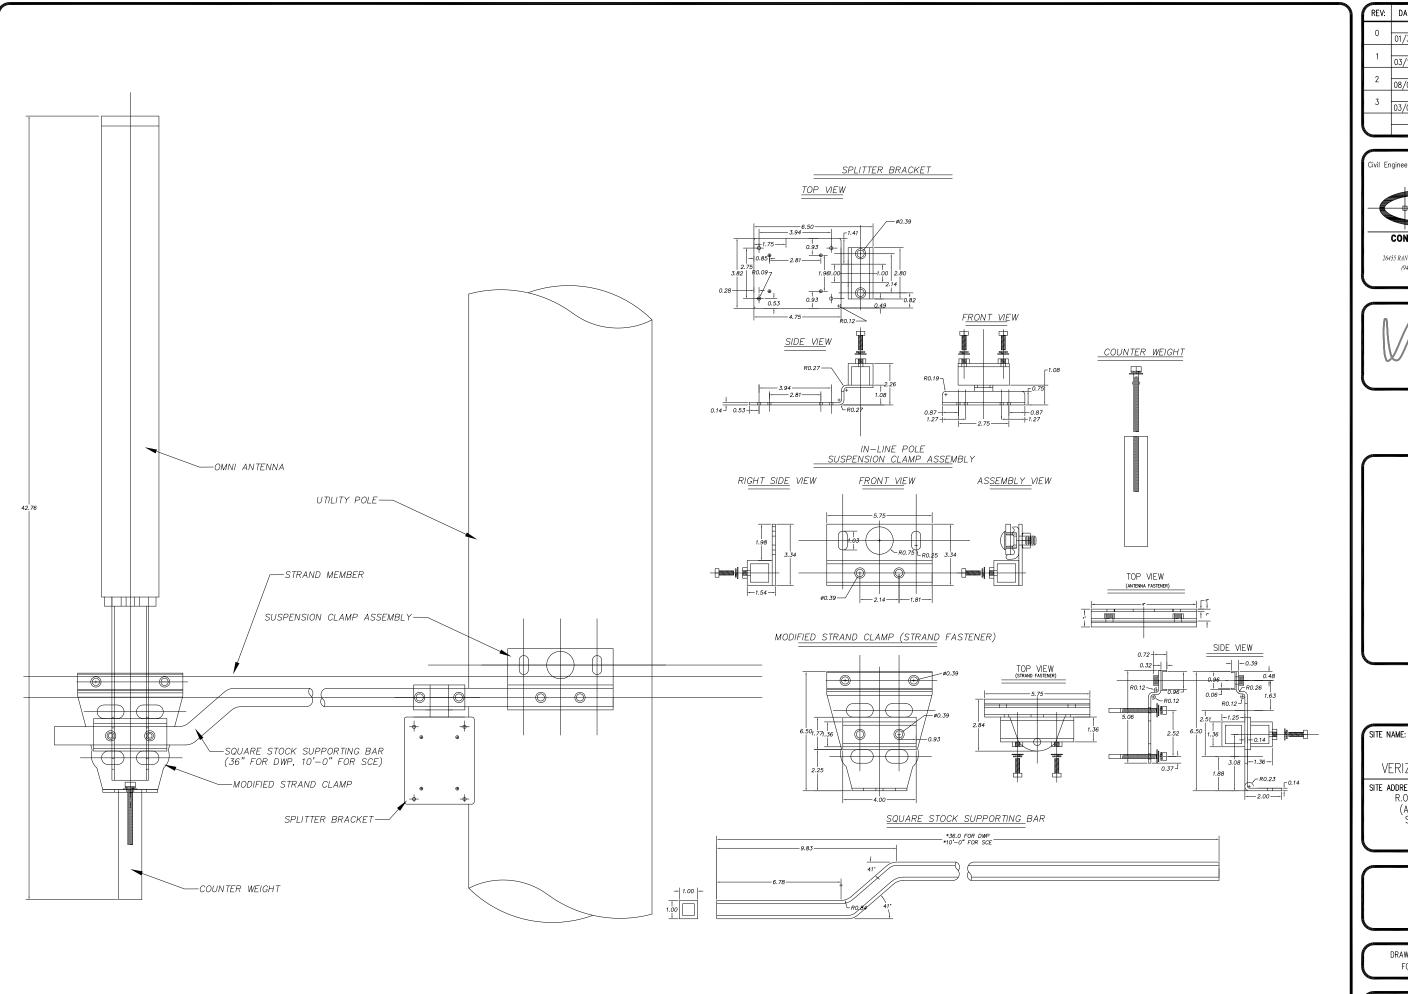

ANTENNA MOUNT

	REV:	DATE/BY:	REVISION DESCRIPTION:
	0	FXC 01/31/2013	ISSUED FOR REVIEW
	1	SA 03/19/2013	ISSUED FOR APPROVAL
	2	SA 08/05/2013	ISSUED FOR APPROVAL
	3	SA 03/08/2014	ISSUED FOR APPROVAL

ENGINEER/CONSULTANT:

Civil Engineer

CONNELL DESIGN GROUP, LLC
CONSULTING CIVIL ENGINEERS

26455 RANCHO PARKWAY SOUTH, LAKE FOREST, CA 92630 (949) 753-8807 OFFICE - (949) 753-8833 FAX

CLIENT:



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SITE INFO:

MON05

VERIZON MONTECITO—MONO5

E ADDRESS: THOMAS BROS PAGE 987 GRID C7

SITE ADDRESS: THOMAS BROS PAGE 987 GRID C7
R.O.W. SOUTH SIDE OF PARK LN
(ADJACENT TO 985 PARK LN)
SANTA BARBARA, CA 93108
LAT: 34.44746'
LONG: -119.60497'

SHEET TITLE:

DETAILS

DRAWING INFO:

RAWN BY: FC

N.T.S.

SHEET NUMBER:

[]-3



840 10510 840 10511

Dualband 700 MHz X-pol Omni Antenna

Kathrein's dual band antennas are ready for 3G and 4G applications, covering all existing wireless bands as well as all spectrum under consideration for future systems.


- · Wide band operation.
- · Exceptional intermodulation characteristics.
- · High strength fiberglass radome.

General enecifications

	20042 - 2023 - 11 1 1 1 1 1 1 1 1 1 1 1 1 1 1 1 1 1		
cy range	698–894 MHz 1710–2170 MHz		
698-894 MHz 1710-2170 MHz	5 dBi (with 3–5 dB nulls, typical) 8 dBi (with 6–8 dB nulls, typical)		
	<1.5:1		
ice	50 ohms		
dulation (2x20w)	IM3: <-150 dBc		
tion	+45° upper and lower band -45° upper and lower band		
or	4 x 7-16 DIN female		
intrasystem intersystem	>30 dB >40 dB (698–894 // 1710–2170 MHz)		
m input power 698-894 MHz 1710-2170 MHz	250 watts (at 50°C) 200 watts (at 50°C)		
color	Brown or gray		
	45 lb (20.4 kg)		
	24 inches (609 mm)		
diameter	16 inches (407 mm)		
ad	at 93 mph (150kph) 32 lbf (138 N)		
rvival rating*	100 mph (160 kph)		
dimensions	32 x 20 x 19 inches (813 x 508 x 483 mm)		
y weight	52 lb (23.6 kg)		
9	Designed to be mounted on top of a utility pole using a custom mounting bracket supplied by the customer.		
	1710–2170 MHz ace dulation (2x20w) tion or intrasystem intersystem input power 698–894 MHz		




698-894 MHz

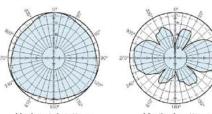

Horizontal pattern ±45°-polarization 880 MHz

Vertical pattern ±45°-polarization 880 MHz

1710-2170 MHz

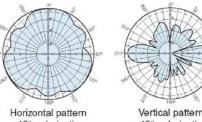




Vertical pattern ±45°-polarization 1945 MHz

Kathrein Inc., Scala Division Post Office Box 4580 Medford, OR 97501 (USA) Phone: (541) 779-6500 Fax: (541) 779-3991 Email: communications@kathrein.com Internet: www.kathrein-scala.com

Alpha Cell General Specifications Service Life: Runtime (minutes)²: Sealed VRLA: Valve regulated lead a Extreme Extreme Low Threaded insert 1/4" - 20 UNC Heat Resistant: Hydrogen Emission: Terminals: Specifications4 Model: Typical Runtime (minutes)*: Cetis Per Unit: Voltage Per Unit: Voltage Per Unit: Conductance Value: Max. Discharge Current (A): Short Clircuit Current (A): 10 Second Volta @ 100A: Ohms Impedance 60Hz: Nominal Capacity at 20hrs: (to 1.75VPC) Nominal Capacity at 20hrs: (to 1.75VPC) BCI Group Size: Weight (bi/Kprimals (in/mm): Weight (bi/Kprimals (in/mm): Unith (in/mm)*: Depth (in/mm)*: Operating Temperature Range 195 GAL 195 6 6 12.8 1100 900 2600 11.3 0.0050 100Ah 102Ah 31 67/30.5 8.48/215 4 13.42/340.9 6.80/172.7 6 12.8 1000 800 2500 11.2 0.0055 86 87 27 63/28.6 8.05/204.5 12.5/317.8 6.83/173.4 Operating Temperature Range Discharge: -40 to 71°C (-40 to 160°F) -23 to 60°C (-9.4 to 140°F) 13.5 to 13.8 -40 to 71°C (-40 to 160°F) -23 to 60°C (-9.4 to 140°F) 13.5 to 13.8 Charge (with temp compensation) ded for best results. Max. allowed = 4% P-P Typical Standby Time in Minutes @ 25°C/77°F 8 balleres "Above calculations based on an ACloadwith a 90 cable plant power fact. For contact information visit www.alpha.com The Alpha Group > North America Latin & South America

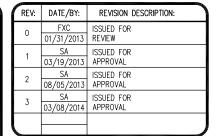

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Civil Engineer CONNELL DESIGN GROUP, LLC

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CLIENT:

STAMP:

SITE INFO:

SITE NAME: MON05 VERIZON MONTECITO-MON05

SITE ADDRESS: THOMAS BROS PAGE 987 GRID C7 R.O.W. SOUTH SIDE OF PARK LN (ADJACENT TO 985 PARK LN) SANTA BARBARA, CA 93108 LAT: 34.44746* LONG: -119.60497

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DETAILS

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FC

SHEET NUMBER:

N.T.S. **BATTERY SPECIFICATIONS** N.T.S. **ANTENNA SPECIFICATIONS**

^{*} Mechanical design is based on environmental conditions as stipulated in TIA-222-G-2 (December 2009) and/or ETS 300 019-1-4 which include the static mechanical load imposed on an antenna by wind at maximum velocity. See the Engineering Section of the catalog for further details.

- . APPROVAL OF THESE PLANS BY THE CITY ENGINEER DOES NOT AUTHORIZE ANY WORK TO BE PERFORMED UNTIL A PERMIT HAS
- 2. UPON ISSUANCE OF A PERMIT, NO WORK WILL BE PERMITTED ON WEEKENDS OR HOLIDAYS WITHOUT PERMISSION FROM THE
- 3, THE APPROVAL OF THIS PLAN OR ISSUANCE OF A PERMIT BY THE LOCAL JURISDICTION DOES NOT AUTHORIZE THE SUBDIVIDER AND OWNER TO VIOLATE ANY FEDERAL. STATE OR CITY LAWS, ORDINANCES, REGULATIONS, OR POLICIES, INCLUDING, BUT NOT LIMITED TO, THE FEDERAL ENDANGERED SPECIES ACT OF 1973 AND AMENDMENTS THERETO (16 USC SECTION 1531 ET.SEQ.)
- 4. THE CONTRACTOR SHALL BE RESPONSIBLE FOR SURVEY MONUMENTS AND/OR VERTICAL CONTROL BENCHMARKS WHICH ARE DISTURBED OR DESTROYED BY CONSTRUCTION. A LAND SURVEYOR MUST FIELD LOCATE, REFERENCE, AND/OR PRESERVE ALL HISTORICAL OR CONTROLLING MONUMENTS PRIOR TO ANY EARTHWORK. IF DESTROYED, SUCH MONUMENTS SHALL BE REPLACED WITH APPROPRIATE MONUMENTS BY A LAND SURVEYOR, A CORNER RECORD OR RECORD OF SURVEY, AS APPROPRIES, SHALL BE FIELD AS REQUIRED BY THE PROFESSIONAL LAND SURVEYORS ACT. IF ANY VERTICAL CONTROL IS TO BE DISTURBED OR DESTROYED. THE LOCAL JURISDICTION FIELD SURVEY SECTION MUST BE NOTIFIED. IN WRITING, AT LEAST 3 DAYS PRIOR TO THE CONSTRUCTION. THE CONTRACTOR WILL BE RESPONSIBLE FOR THE COST OF REPLACING ANY VERTICAL CONTROL BENCHMARKS
- 5. IMPORTANT NOTICE: SECTION 4216 OF THE GOVERNMENT CODE REQUIRES A DIG ALERT IDENTIFICATION NUMBER BE ISSUED BEFORE A "PERMIT TO EXCAVATE" WILL BE VALID. FOR YOUR DIG ALERT I.D. NUMBER, CALL UNDERGROUND SERVICE ALERT, TWO
- 6. CONTRACTOR SHALL BE RESPONSIBLE FOR THE POTHOLE AND LOCATING OF ALL EXISTING UTILITIES THAT CROSS THE PROPOSED TRENCH LINE AND MUST MAINTAIN 1' MINIMUM VERTICAL CLEARANCE.
- 7. CONTRACTOR SHALL SUBMIT TO THE LOCAL JURISDICTION, A CONSTRUCTION PLAN TO PROTECT WATER MAINS PRIOR TO COMMENCING CONSTRUCTION.
- 8. CONTRACTOR SHALL REPLACE OR REPAIR ALL TRAFFIC SIGNAL LOOPS, CONDUIT, AND LANE STRIPING DAMAGED DURING
- 9. CONTRACTOR SHALL NOTIFY THE LOCAL JURISDICTION. A MINIMUM OF 48 HOURS PRIOR TO COMMENCING WORK WITHIN 10' OF
- 10. THIS PROJECT WILL BE INSPECTED BY ENGINEERING AND CAPITAL PROJECTS DEPARTMENT, FIELD ENGINEERING DIVISION.
- 11. AS-BUILT DRAWINGS MUST BE SUBMITTED TO THE CITY RESIDENT ENGINEER PRIOR TO THE ACCEPTANCE OF THIS PROJECT. 12. PUBLIC IMPROVEMENT SUBJECT TO DESUETUDE OR DAMAGE." IF REPAIR OR REPLACEMENT OF SUCH PUBLIC IMPROVEMENTS IS REQUIRED, THE OWNER SHALL OBTAIN THE REQUIRED PERMITS FOR WORK IN THE PUBLIC RIGHT-OFWAY, SATISFACTORY TO THI
- 13. PRIOR TO ANY DISTURBANCE TO THE SITE, EXCLUDING UTILITY MARKS-OUTS AND SURVEYING, THE CONTRACTOR SHALL MAKE ARRANGEMENTS FOR A PRE-CONSTRUCTION MEETING WITH THE LOCAL JURISDICTION FIELD ENGINEERING DIVISION.
- 14. PRIOR TO THE COMMENCEMENT OF ANY CONSTRUCTION SHOWN ON THESE PLANS. IT IS THE SOLE RESPONSIBILITY OF THE CONTRACTOR TO COORDINATE. THE CONTRACTOR IS RESPONSIBLE TO ATTEND THE LOCAL JURISDICTIONS MONTHLY UTILITY COORDINATION COMMITTEE THE CONSTRUCTION ACTIVITIES WITH THE CITY AND ALL OTHER CONTRACTORS SO THAT NO TRENCH IS CUT WITHIN ANY OF THE CITY STREETS THAT HAVE BEEN CONSTRUCTED, REPAIRED, OR SLURRY SEALED WITHIN THREE YEARS OF THE STREET CONSTRCTUION/RESURFACING DATE.
- 15. MANHOLES OR COVERS SHALL BE LABELED "CROWN CASTLE" OR "CROWN CASTLE NG WEST".
- 16. CONTRACTOR SHALL IMPLEMENT AN EROSION AND SEDIMENT CONTROL PROCRAM DURING THE PROJECT CONSTRUCTION ACTIVITIES PROGRAM SHALL MEET THE APPLICABLE REQUIREMENTS OF THE STATE WATER RESOURCE CONTROL BOARD
- 17. THE CONTRACTOR SHALL HAVE EMERGENCY MATERIALS AND EQUIPMENT ON HAND FOR UNFORESEEN SITUATIONS, SUCH AS DAMAGE TO UNDERGROUND WATER, SEWER, AND STORM DRAIN FACILITIES WHEREBY FLOWS MAY GENERATE EROSION AND SEDIMENT

SPECIAL NOTES

THE FOLLOWING NOTES ARE PROVIDED TO GIVE DIRECTIONS TO THE CONTRACTOR BY THE ENGINEER OF WORK. THE CITY ENGINEER'S SIGNATURE ON THESE PLANS DOES NOT CONSTITUTE APPROVAL OF THESE NOTES AND THE CITY WILL NOT BE RESPONSIBLE FOR THEIR ENFORCEMENT.


- THE CONTRACTOR SHALL VERIFY THE LOCATION EXISTING UNDERGROUND UTILITIES INCLUDING SEWER LATERALS AND WATER
 SERVICES TO INDIVIDUAL LOTS BOTH VERTICAL AND HORIZONTAL PRIOR TO COMMENCING IMPROVEMENT OPERATIONS.
- 2. CONTRACTOR SHALL MAKE EXPLORATION EXCAVATIONS AND LOCATE EXISTING FACILITIES SUFFICIENTLY AHEAD OF CONSTRUCTION TO PERMIT REVISIONS OF PLANS IF REVISION IS NECESSARY BECAUSE OF LOCATION OF EXISTING UTILITIES.
- 3. LOCATION AND ELEVATIONS OF IMPROVEMENTS. TO BE MET BY WORK, SHALL BE CONFIRMED BY FIELD MEASUREMENT PRIOR TO
- 4. GRADES SHOWN ARE FINISH GRADES, CONTRACTOR SHALL DETERMINE NECESSARY SUB GRADE ELEVATIONS AND SHALL CONSTRUCT SMOOTH TRANSITION BETWEEN FINISH GRADES SHOWN.
- 5. Contractor agrees that he shall assume sole responsibility for job site condition during the course of construction of this project, including safety of all persons and property: that this provision shall apply CONTINUOUSLY AND NOT BE LIMITED TO NORMAL WORKING HOURS; AND THAT THE CONTRACTOR SHALL DEFEND, INDEMNIFY AND HOLD THE OWNER AND THE ENGINEER HARMLESS FROM ANY AND ALL LIABILITY. REAL OR ALLEGED IN CONNECTION WITH THI PERFORMANCE OF WORK ON THIS PROJECT, EXPECTING FOR LIABILITY ARISING FROM SOLE NEGLIGENCE OF THE OWNER OR THE
- 6. THE CONTRACTOR SHALL BE TOTALLY RESPONSIBLE FOR COMPLIANCE WITH THE PROVISIONS OF THE STATE OF CALIFORNIA SAFETY
- 7. THE LOCATIONS OF ALL EXISTING UTILITIES SHOWN ON THESE PLANS ARE FROM EXISTING RECORDS AND CORROBORATED, WHERE POSSIBLE WITH FIELD TIES. THE CONTRACTOR IS RESPONSIBLE FOR CONFIRMING THE LOCATIONS SHOWN, BOTH HORIZONTALLY AND VERTICALLY, PRIOR TO CONSTRUCTION. IF EXISTING LOCATIONS VARY SUBSTANTIALLY FROM THE PLANS, THE ENGINEER SHOULD BE NOTIFIED TO MAKE ANY CONSTRUCTION CHANGES REQUIRED.
- 8. THE CONTRACTOR SHALL PROVIDE TEMPORARY SUPPORT FOR ALL SEWER AND WATER MAIN UNDER CROSSING IN ACCORDANCE WITH PART 1 SECTION 5-2 OF THE STANDARD SPECIFICATION.
- 9. THE CONTRACTOR SHALL REPLACE OR REPAIR ALL TRAFFIC SIGNAL LOOPS, CONDUITS, AND LANE STRIPING DAMAGED DURING
- 10. THE CONTRACTOR SHALL SUBMIT WORK PLANS FOR ALL BORE OPERATIONS TWO WEEKS PRIOR TO COMMENCING WORK.
- 11. CONTRACTOR SHALL BE RESPONSIBLE FOR THE POTHOLE AND LOCATING OF ALL EXISTING UTILITIES THAT CROSS THE PROPOSED
- 12. AS-BUILT DRAWINGS MUST BE SUBMITTED TO THE CITY ENGINEER PRIOR TO ACCEPTANCE OF THIS PROJECT




CONSTRUCTION CHANGE TABLE CHANGE DATE EFFECTED OR ADDED SHEET NUMBERS

CROWN CASTLE NG WEST, INC

VERIZON MONTECITO-MON06m1 R.O.W. SOUTH SIDE OF LILAC DR. (ADJACENT TO 730 LILAC DR) SANTA BARBARA, CA 93108

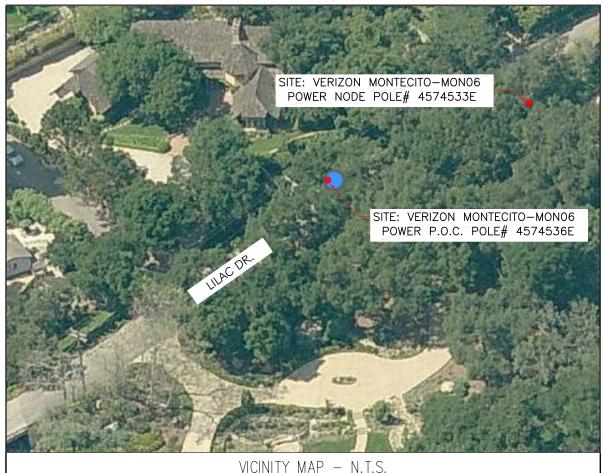

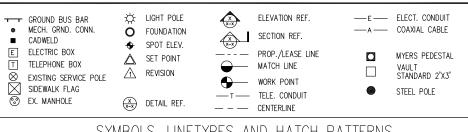

SYMBOLS, LINETYPES AND HATCH PATTERNS

APPLICABLE CODES

ALL WORK SHALL COMPLY WITH THE FOLLOWING APPLICABLE CODES:

- IN THE EVENT OF CONFLICT, THE MOST RESTRICTIVE CODE SHALL PREVAIL

PROJECT DESCRIPTION

PROJECT CONSISTS OF INSTALLATION OF:

- 1. (2) OMNI ANTENNA & EQUIPMENT SHROUD ON EXISTING UTILITY POLE
- 2. EQUIPMENT PEDESTAL W/ BBU AND ELECTRICAL METER

SHEET INDEX: T-1 - SHEET 1 OF 8 A-1 - SHEET 2 OF 8 TITLE SHEET SITE PLAN PROPOSED ELEVATIONS - SHEET 3 OF 8 - SHEET 4 OF 8 GRADING PLAN DETAILS D-1 - SHEET 5 OF 8 D-2 - SHFFT 6 OF 8 DETAILS DETAILS DETAILS D-4 - SHEET 8 OF 8

EROSION AND SEDIMENT CONTROL NOTES

TEMPORARY EROSION/SEDIMENT CONTROL, PRIOR TO COMPLETION OF FINAL IMPROVEMENTS. SHALL BE PERFORMED BY THE CONTRACTOR OR QUALIFIED PERSON AS INDICATED BELOW:

- 1. ALL REQUIREMENTS OF THE LOCAL JURISDICTION "LAND DEVELOPMENT MANUAL, STORM WATER STANDARDS" MUST BE INCORPORATED INTO THE DESIGN AND CONSTRUCTION OF THE PROPOSED GRADING/IMPROVEMENTS CONSISTENT WITH THE APPROVED STORM WATER AND/OR WATER POLLUTION CONTROL PLAN (WPCP).
- 2. FOR STORM DRAIN INLETS, PROVIDE A GRAVEL BAG SILT BASIN IMMEDIATELY UPSTREAM OF INLET AS INDICATED ON DETAILS.
- 3. FOR INLETS LOCATED AT SUMPS ADJACENT TO TOP OF SLOPES, THE CONTRACTOR SHALL ENSURE THAT WATER DRAINING TO THE SUMP IS DIRECTED INTO THE INLET AND THAT A MINIMUM OF 1.00" FREEBOARD EXISTS AND IS MAINTAINED ABOVE THE TOP OF THE INLET. IF FREEBOARD IS NOT PROVIDED BY GRADING SHOWN ON THESE PLANS, THE CONTRACTOR SHALL PROVIDE IT VIA TEMPORARY MEASURES, I.E. GRAVEL BAGS OR DIKES.
- 4. THE CONTRACTOR OR QUALIFIED PERSON SHALL BE RESPONSIBLE FOR CLEANUP OF SILT AND MUD ON ADJACENT STREET(S) AND STORM DRAIN SYSTEM DUE TO CONSTRUCTION
- 5. THE CONTRACTOR OR QUALIFIED PERSON SHALL CHECK AND MAINTAIN ALL LINED AND UNLINED DITCHES AFTER EACH RAINFALL.
- 6. THE CONTRACTOR SHALL REMOVE SILT AND DEBRIS AFTER EACH MAJOR RAINFALL.
- EQUIPMENT AND WORKERS FOR EMERGENCY WORK SHALL BE MADE AVAILABLE AT ALL TIMES DURING THE RAINY SEASON, ALL NECESSARY MATERIALS SHALL BE STOCKPILED ON SITE AT CONVENIENT LOCATIONS TO FACILITATE RAPID CONSTRUCTION OF TEMPORARY DEVICES WHEN RAIN IS IMMINENT.
- 8. THE CONTRACTOR SHALL RESTORE ALL EROSION/SEDIMENT CONTROL MEASURES TO WORKING ORDER TO THE SATISFACTION OF THE CITY ENGINEER OR RESIDENT ENGINEER AFTER EACH RUN-OFF PRODUCING RAINFALL.
- THE CONTRACTOR SHALL INSTALL ADDITIONAL EROSION CONTROL MEASURES AS MAY BE REQUIRED BY THE RESIDENT ENGINEER DUE TO UNCOMPLETED GRADING OPERATIONS OR UNFORESEEN CIRCUMSTANCES, WHICH MAY ARISE.
- 10. THE CONTRACTOR SHALL BE RESPONSIBLE AND SHALL TAKE NECESSARY PRECAUTIONS TO PREVENT PUBLIC TRESPASS ONTO AREAS WHERE IMPOUNDED WATERS CREATE A HAZARDOUS CONDITION.
- 11. ALL EROSION/SEDIMENT CONTROL MEASURES PROVIDED PER THE APPROVED GRADING PLAN SHALL BE INCORPORATED HEREON. ALL EROSION/SEDIMENT CONTROL FOR INTERIM CONDITIONS SHALL BE DONE TO THE SATISFACTION OF THE RESIDENT ENGINEER. 12 CRADED AREAS AROUND THE PROJECT PERIMETER MUST DRAIN AWAY FROM THE FACE
- OF THE SLOPE AT THE CONCLUSION OF EACH WORKING DAY. 13. ALL REMOVABLE PROTECTIVE DEVICES SHOWN SHALL BE IN PLACE AT THE END OF EACH
- 14. THE CONTRACTOR SHALL ONLY GRADE, INCLUDING CLEARING AND GRUBBING FOR THE AREAS FOR WHICH THE CONTRACTOR OR QUALIFIED PERSON CAN PROVIDE FROSION/SEDIMENT CONTROL MEASURES.
- 15. THE CONTRACTOR SHALL ARRANGE FOR WEEKLY MEETINGS DURING OCTOBER 1ST TO APRIL 30TH FOR PROJECT TEAM (GENERAL CONTRACTOR, QUALIFIED PERSON, EROSION CONTROL SUBCONTRACTOR IF ANY, ENGINEER OF WORK, OWNER AND THE RESIDENT ENGINEER) TO EVALUATE THE ADEQUACY OF THE EROSION/SEDIMENT CONTROL MEASURES AND OTHER RELATED CONSTRUCTION ACTIVITIES.

TRAFFIC CONTROL NOTES

WORKING DAY WHEN RAIN IS IMMINENT.

THE CONTRACTOR SHALL SUBMIT A TRAFFIC CONTROL PLAN (11" X 17") FOR APPROVAL PRIOR TO STARTING WORK. THE PLAN SHOULD BE SUBMITTED TO THE TRAFFIC CONTROL PERMIT COUNTER. CONTRACTOR SHALL OBTAIN A TRAFFIC CONTROL PERMIT A MINIMUM OF TWO (2) WORKING DAYS PRIOR TO STARTING WORK, AND A MINIMUM FIVE (5) DAYS IF WORK WILL AFFECT A BUS STOP OR AN EXISTING TRAFFIC SIGNAL, OR IF WORK WILL REQUIRE A

FOOTAGE TOTALS		
ASPHALT CUT	-	
DIRT TRENCH	-	
PUNCH THRU	-	
BORE	-	
TOTAL	-	
R&R SWF TOTAL	_	

PROJECT DICTIONARY

R.O.W. EAST SIDE OF LILAC DR. SITE ADDRESS: (ADJACENT TO 727 LILAC DR) SANTA BARBARA, CA 93108

APPLICANT: CROWN CASTLE NG WEST, LLC 2125 WRIGHT AVE, SUITE #C9 LA VERNE, CA 91750 CONTACT: HEIDI PAYNE

PHONE: (949) 300-9493 CIVIL ENGINEER:

CONNELL DESIGN GROUP, LLC 26455 RANCHO PARKWAY SOUTH LAKE FOREST, CA 92630 CONTACT: FRANK CARTER (949) 310-8233 PHONE (949) 753-8833 FAX

REVISION DESCRIPTION: DATE/BY: ISSUED FOR 02/10/2014 REVIEW FXC ISSUED FOR

ENGINEER/CONSULTANT:



CLIENT:

(949) 753-8807 OFFICE - (949) 753-8833 FAX



STAMP



SITE INFO:

MON06m1 VERIZON MONTECITO-MON06m1


SITE ADDRESS: THOMAS BROS PAGE xxx GRID xx R.O.W. EAST SIDE OF LILAC DR. (ADJACENT TO 730 LILAC DR) SANTA BARBARA, CA 93108[°] LAT: 34.4431514* LONG: 119.6076583*

SHEET TITLE:

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	REV:	DATE/BY:	REVISION DESCRIPTION:
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CONSULTING CIVIL ENGINEERS 26455 RANCHO PKWY. SOUTH LAKE FOREST, CA 92630-8326 (949) 753-8807 OFFICE - (949) 753-8833 FAX

SITE BUILDER:

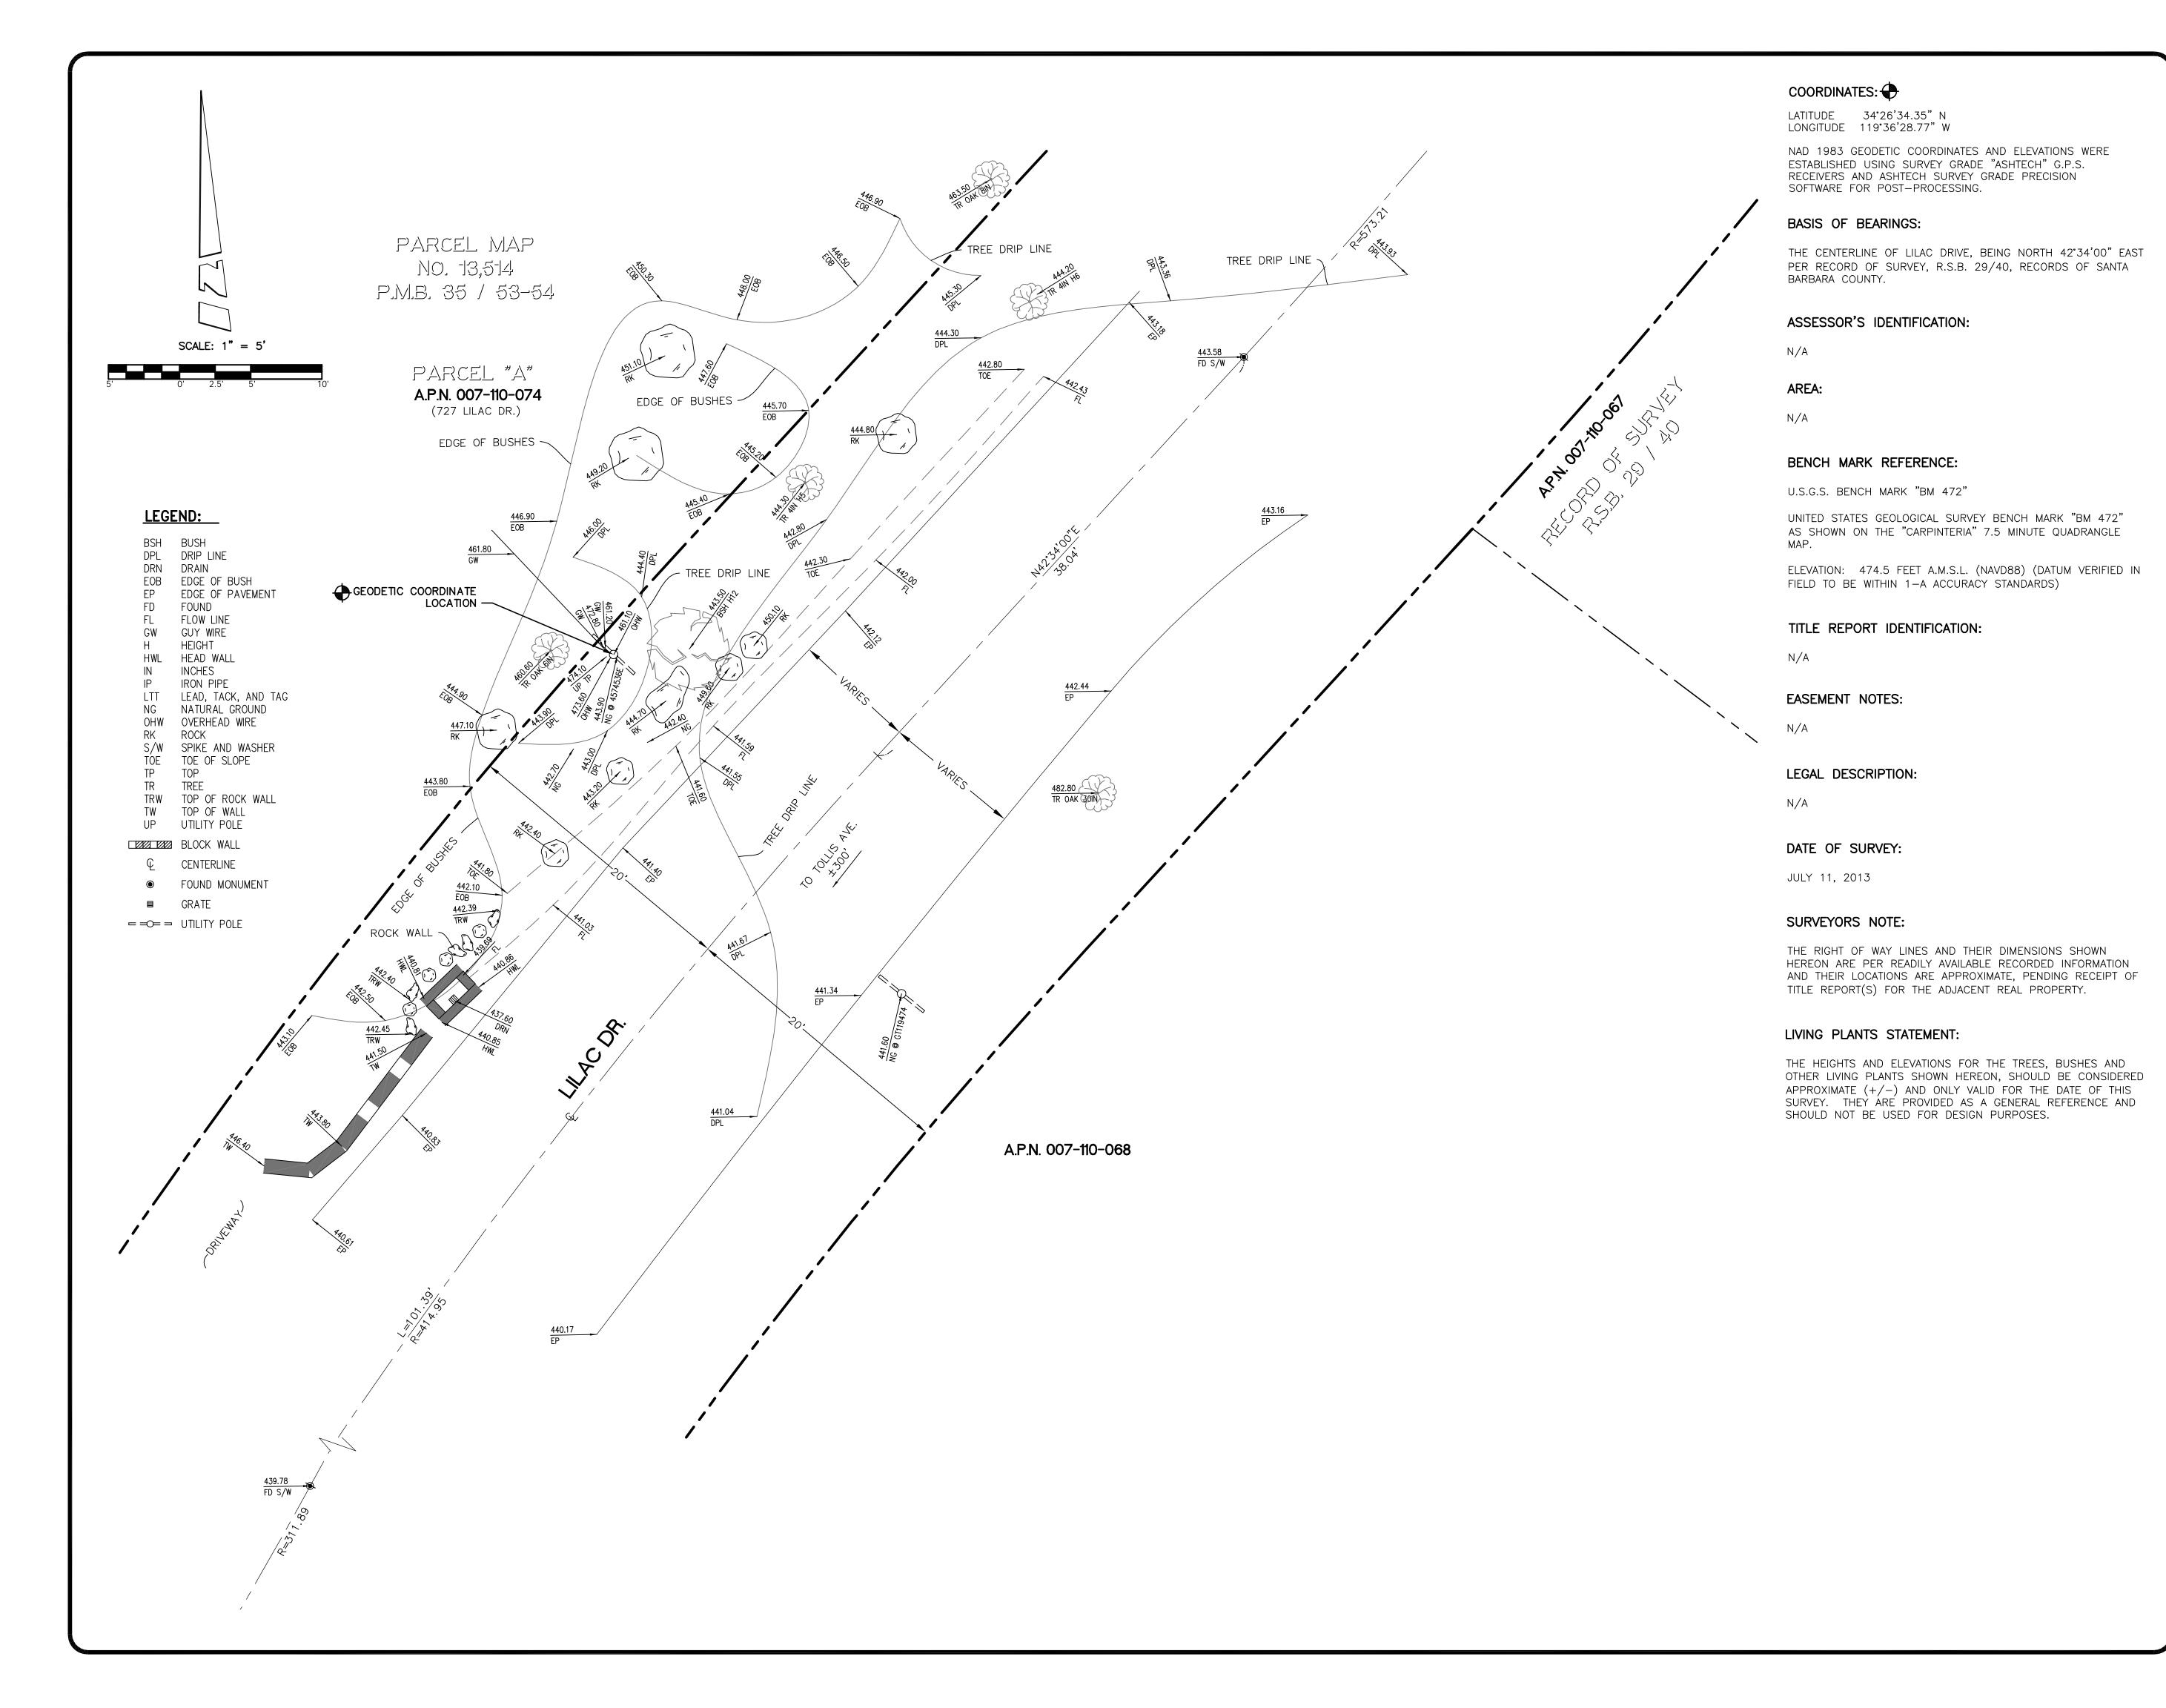

SURVEYOR:

BERT FLAZE

AND ASSOCIATES, INC.

LAND SURVEYING & MAPPING

3188 AIRWAY AVENUE, SUITE K1

COSTA MESA, CALIFORNIA 92626

714 557-1567 OFFICE

714 557-1568 FAX

JN. 706.221

STAMP:



SITE INFO:

SITE NAME:

MON06 VERIZON MONTECITO-MON06

SITE ADDRESS:

R.O.W. WEST SIDE OF LILAC DR (ADJACENT TO 727 LILAC DR) SANTA BARBARA, CA 93108

SHEET TITLE:

TOPOGRAPHIC SURVEY


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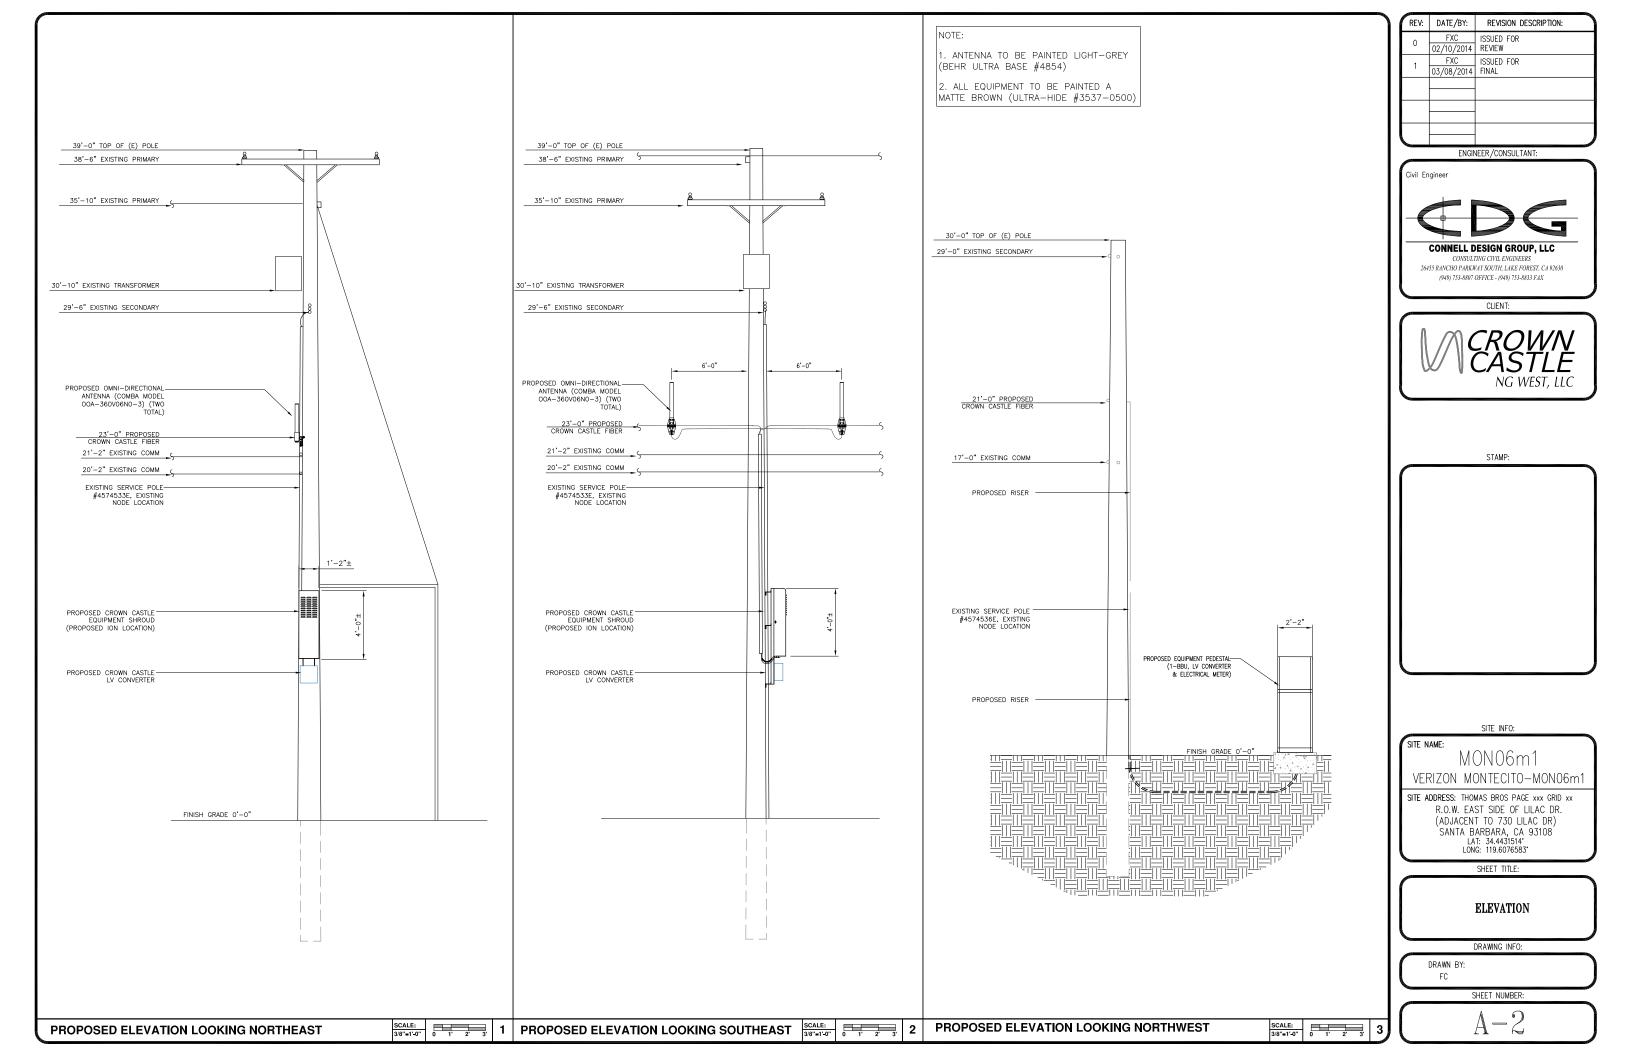
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DWG. NAME:	DRAWN BY:	DATE:


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Civil Engineer

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CROWN CASTLE NG WEST, LLC

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MON06m1 VERIZON MONTECITO-MON06m1

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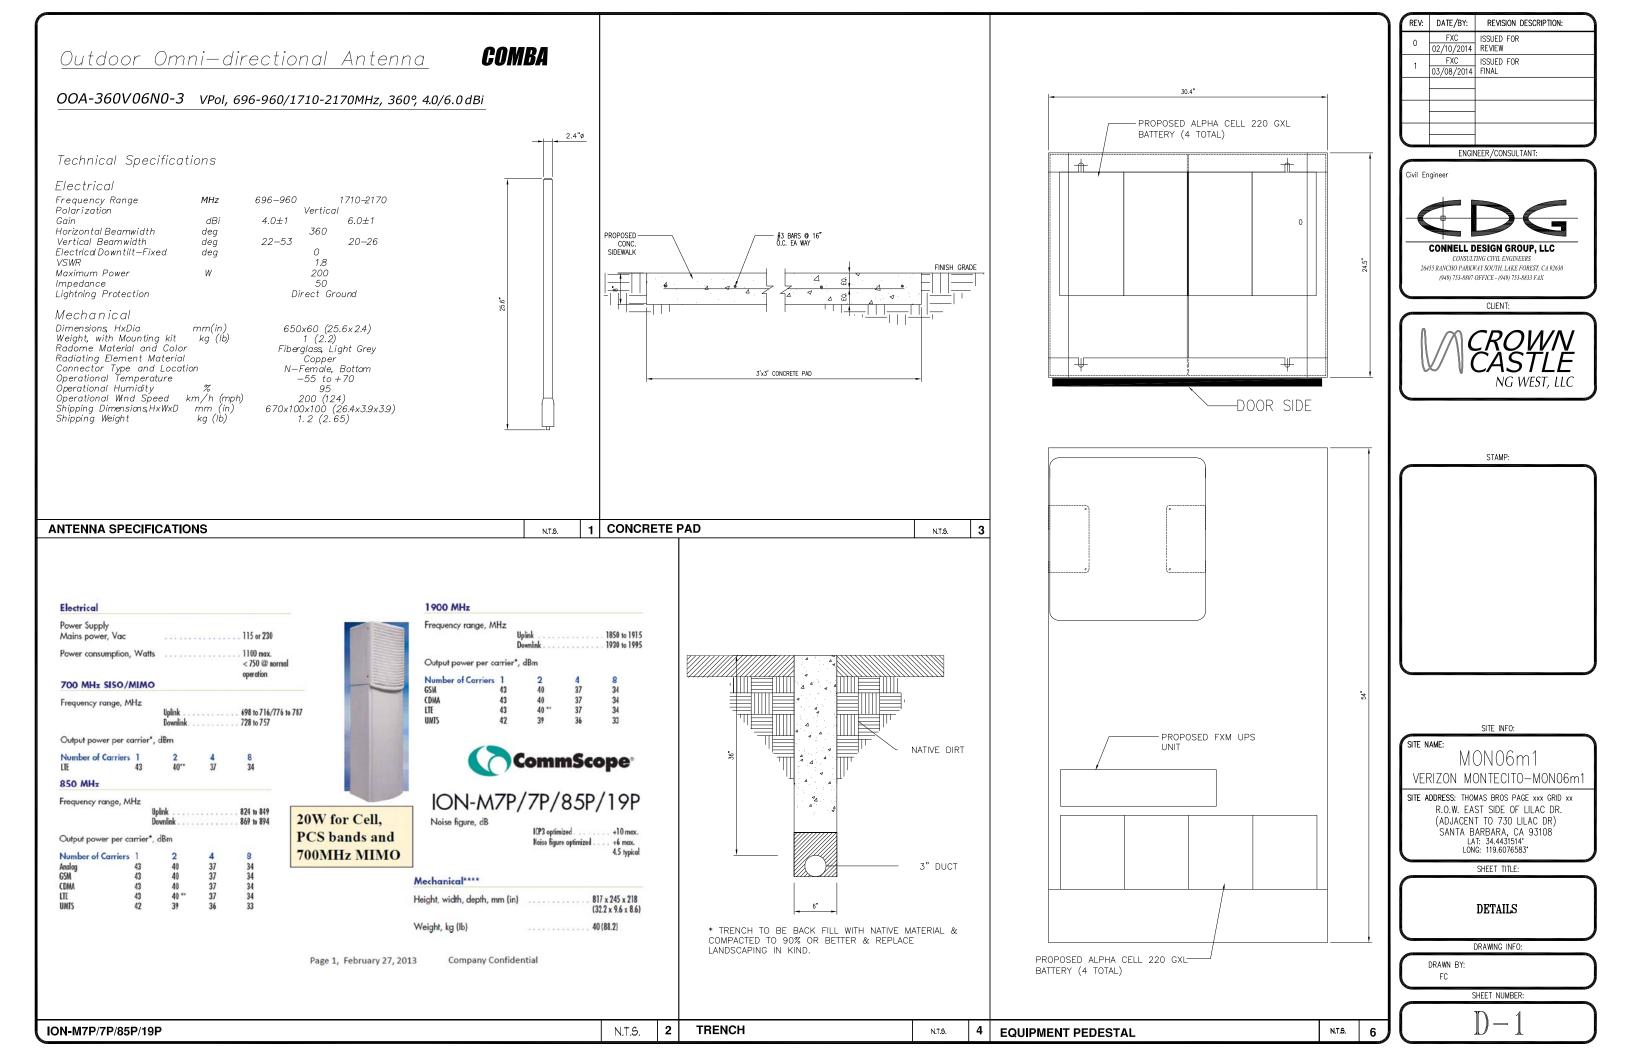
GRADING PLAN

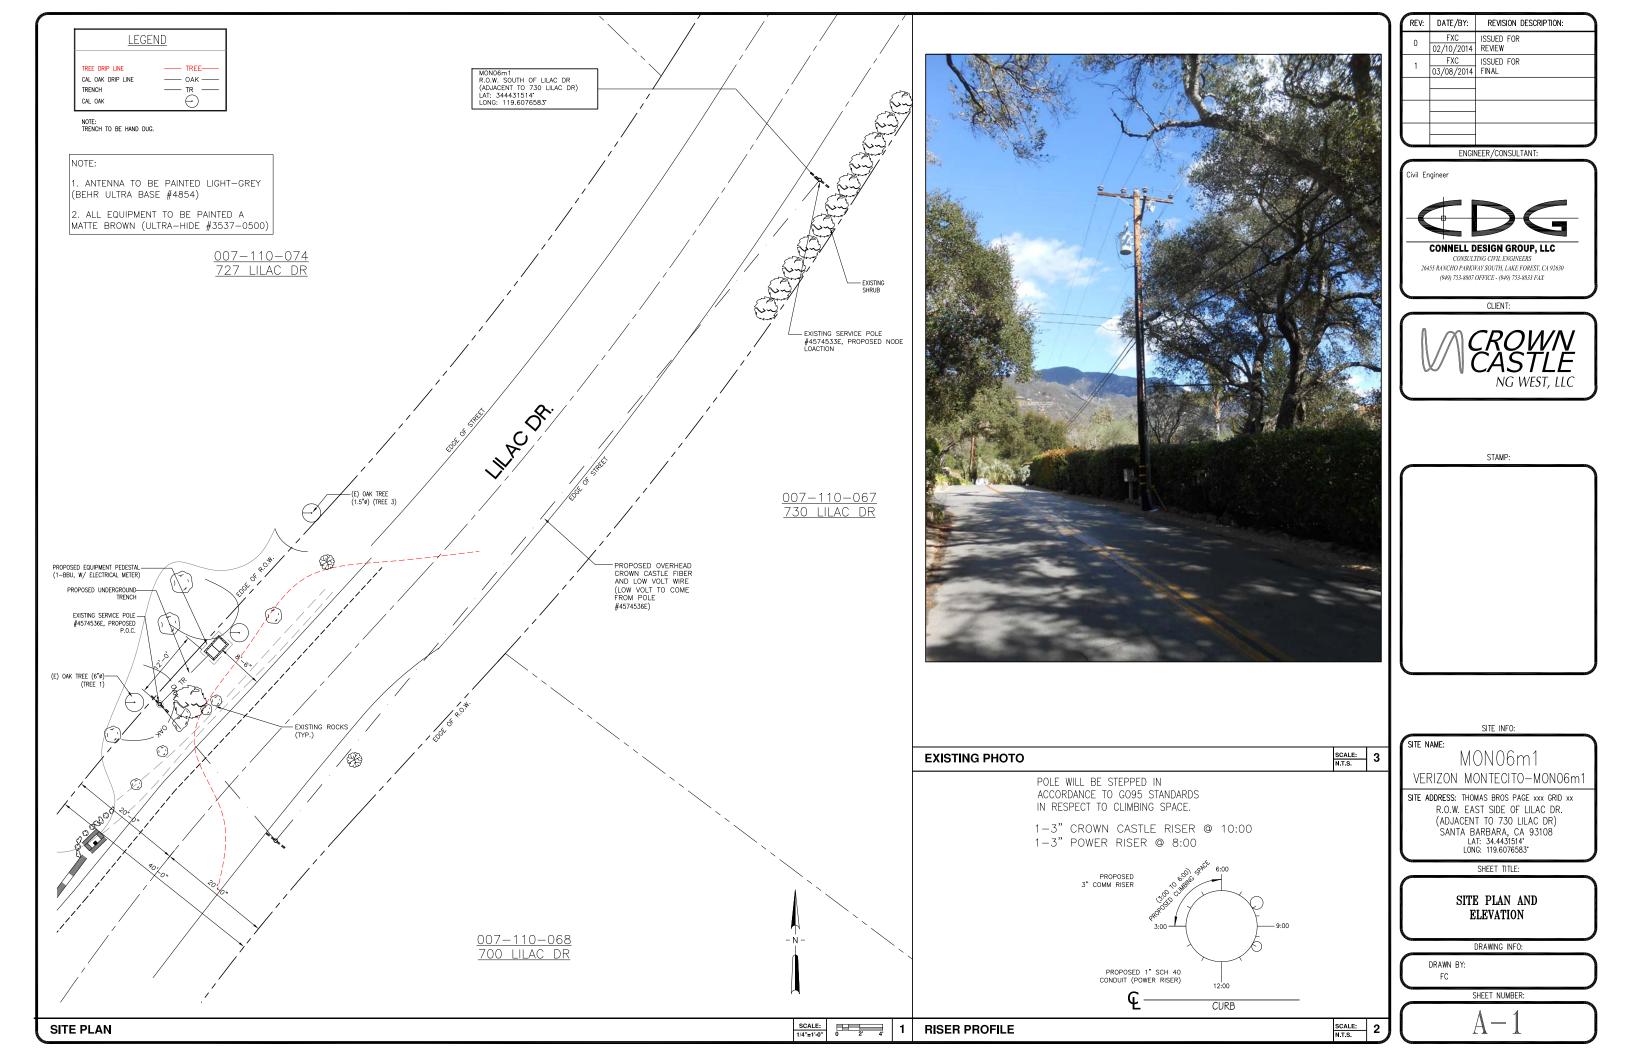
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ANTENNA MOUNT
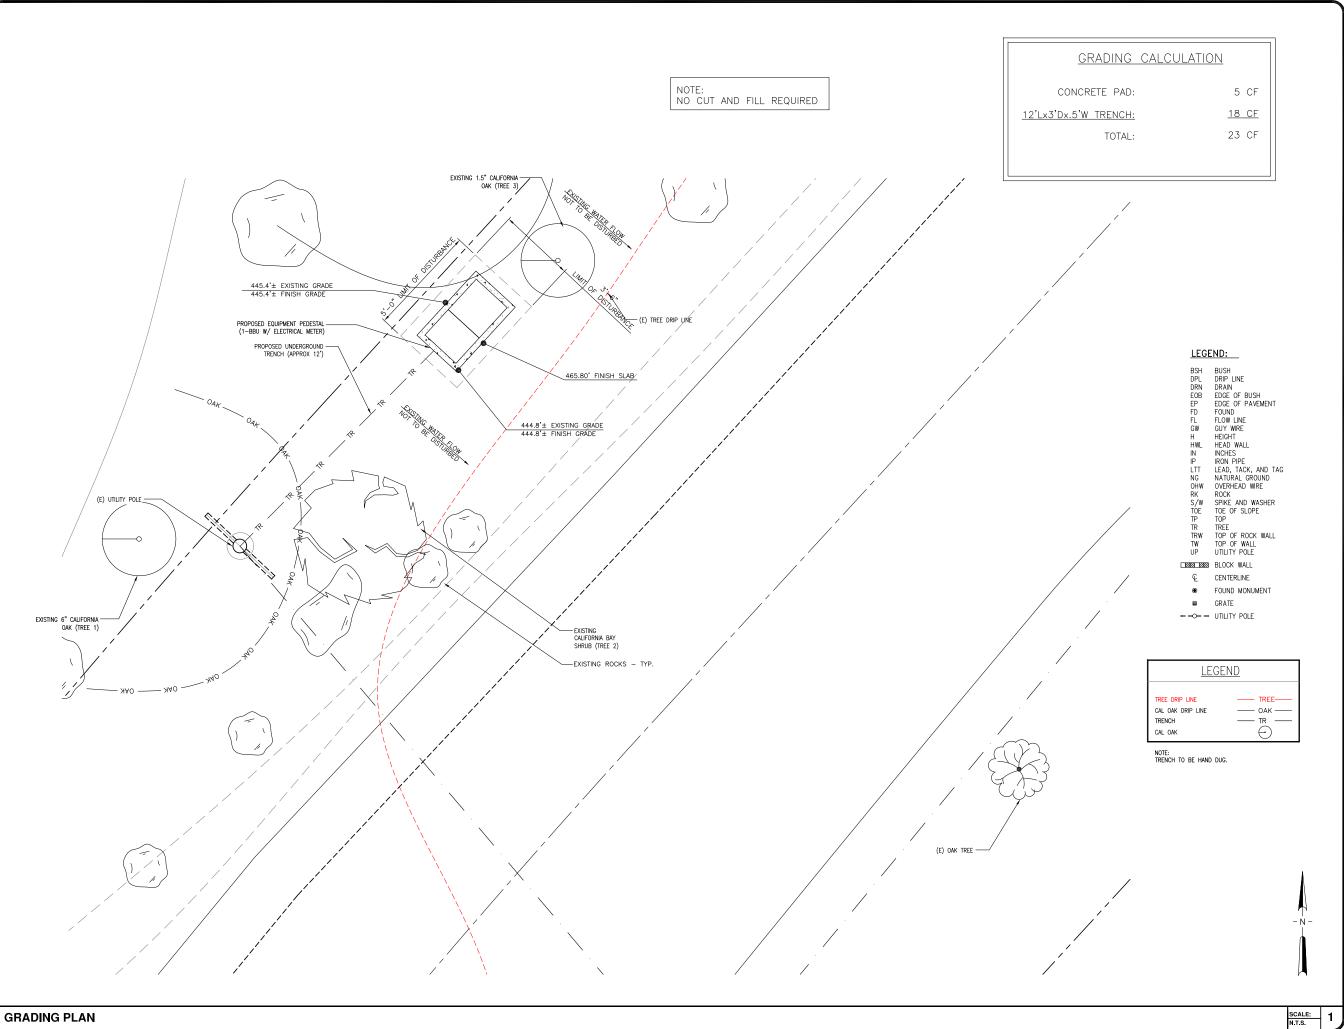
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ENGINEER/CONSULTANT:

Civil Engineer CONNELL DESIGN GROUP, LLC

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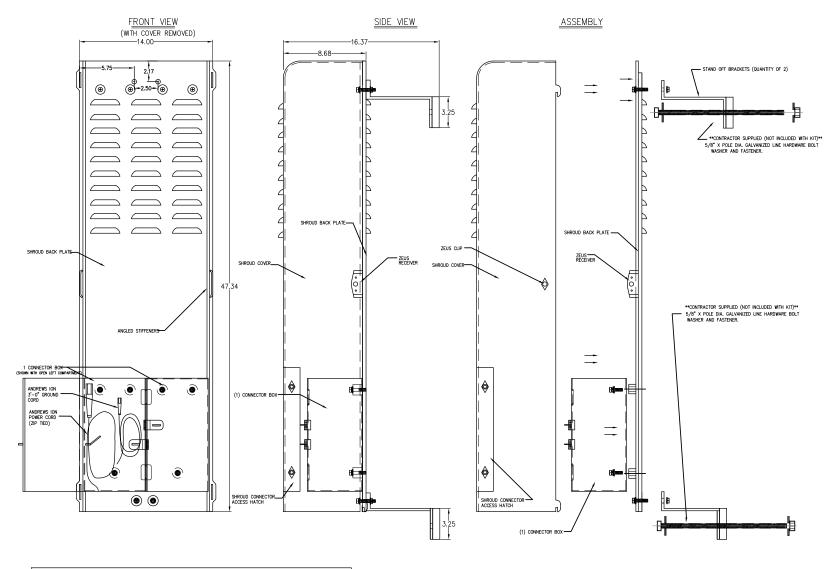
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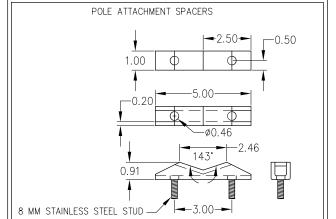
DETAILS


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CLIENT:

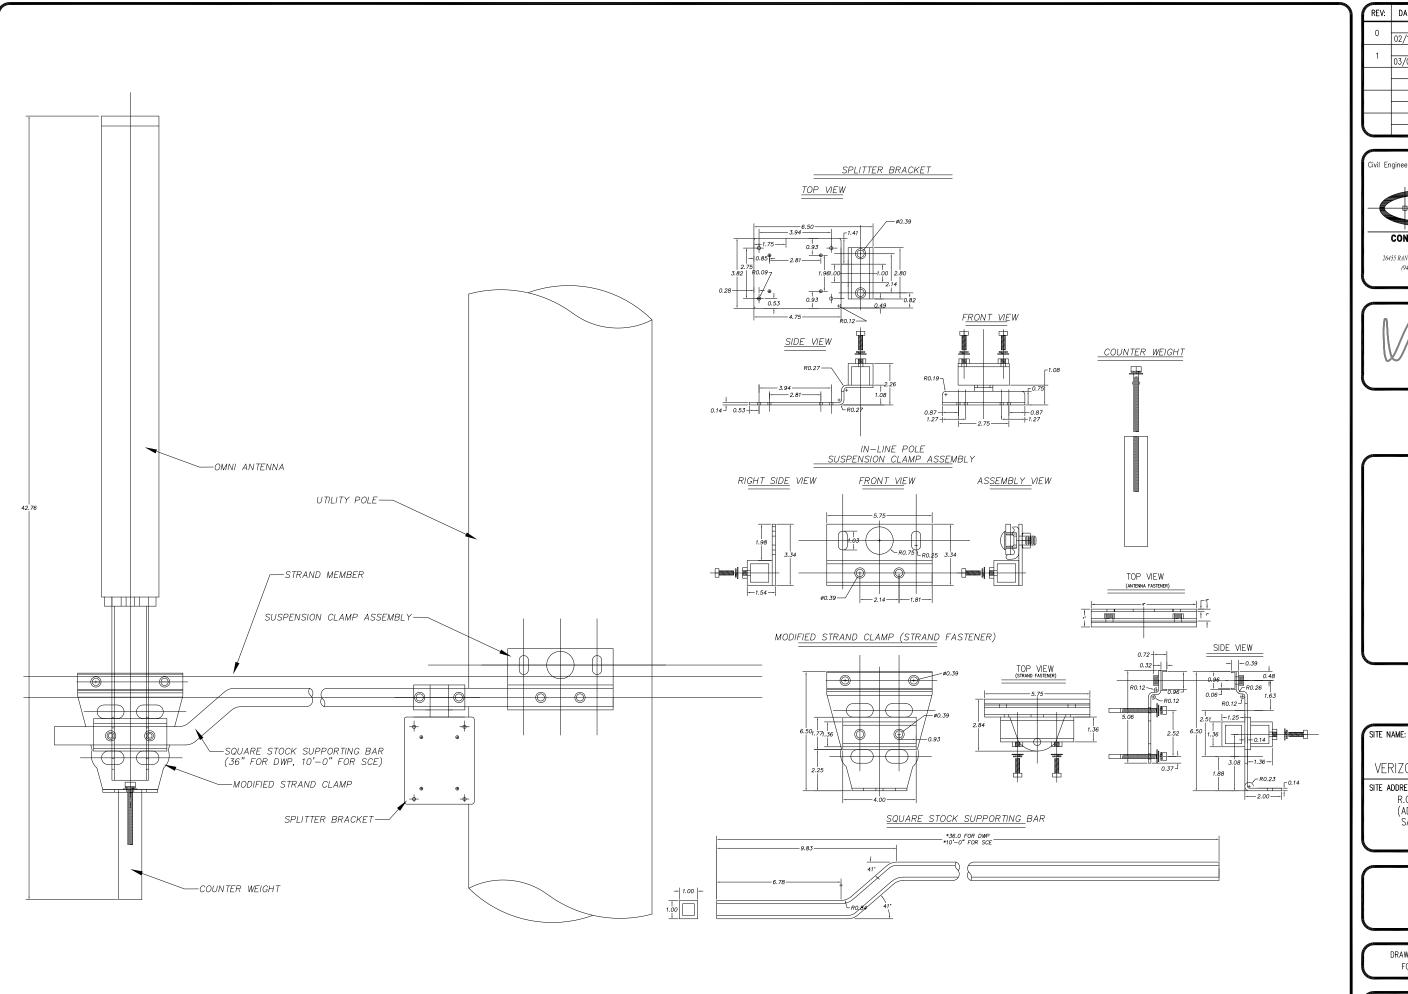STAMP:

SITE INFO:

SITE NAME:

MON06m1 VERIZON MONTECITO-MON06m1

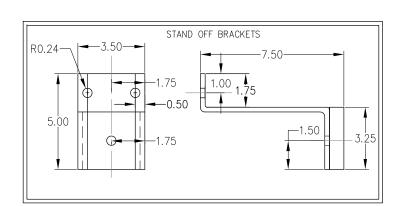SITE ADDRESS: THOMAS BROS PAGE xxx GRID xx R.O.W. EAST SIDE OF LILAC DR. (ADJACENT TO 730 LILAC DR) SANTA BARBARA, CA 93108 LAT: 34.4431514* LONG: 119.6076583*

SHEET TITLE:

DETAILS


DRAWING INFO:

FC

SHEET NUMBER:

SHROUD DETAIL

NNTISS.

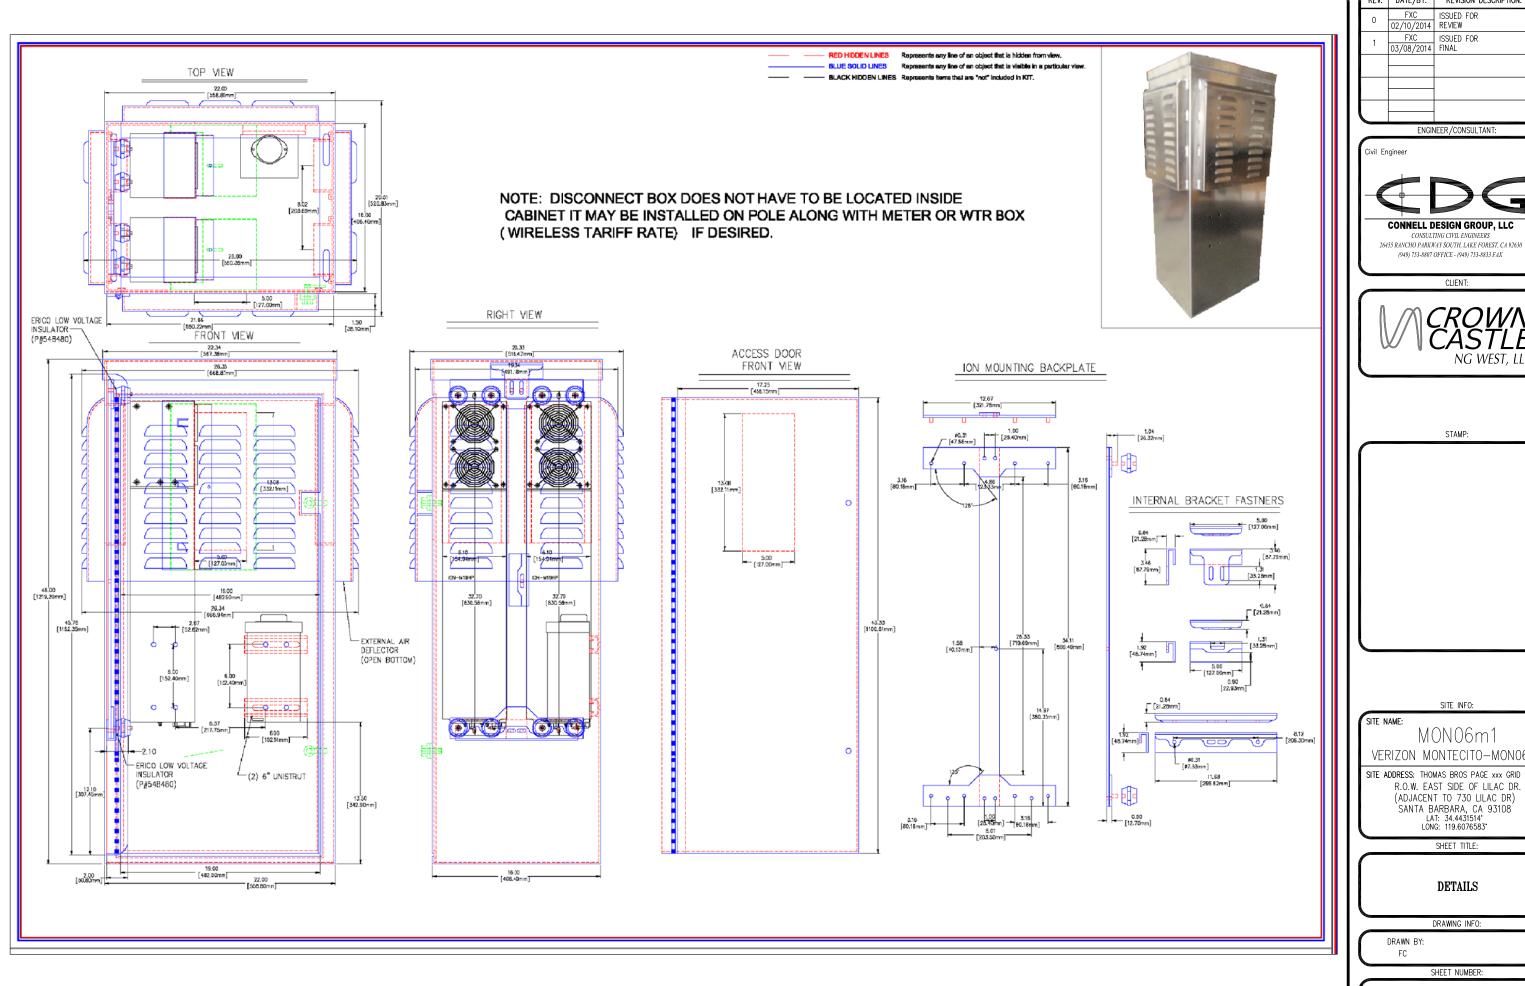

PEDESTAL SPECIFICATIONS

۱	REV:	DATE/BY:	REVISION DESCRIPTION:
	0	FXC 02/10/2014	ISSUED FOR REVIEW
	1	FXC 03/08/2014	ISSUED FOR FINAL

ENGINEER/CONSULTANT:

CONNELL DESIGN GROUP, LLC

CLIENT:

(949) 753-8807 OFFICE - (949) 753-8833 FAX



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MON06m1 VERIZON MONTECITO-MON06m1

SITE ADDRESS: THOMAS BROS PAGE xxx GRID xxR.O.W. EAST SIDE OF LILAC DR. (ADJACENT TO 730 LILAC DR)
SANTA BARBARA, CA 93108
LAT: 34.4431514*
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- 3. THE APPROVAL OF THIS PLAN OR ISSUANCE OF A PERMIT BY THE LOCAL JURISDICTION DOES NOT AUTHORIZE THE SUBDIVIDER AND OWNER TO VIOLATE ANY FEDERAL, STATE OR CITY LAWS, ORDINANCES, REGULATIONS, OR POLICIES, INCLUDING, BUT NOT LIMITED TO, THE FEDERAL ENDANGERED SPECIES ACT OF 1973 AND AMENDMENTS THERETO (16 USC SECTION 1531 ET.SEQ.).
- 4. THE CONTRACTOR SHALL BE RESPONSIBLE FOR SURVEY MONUMENTS AND/OR VERTICAL CONTROL BENCHMARKS WHICH ARE DISTURBED OR DESTROYED BY CONSTRUCTION. A LAND SURVEYOR MUST FIELD LOCATE, REFERENCE, AND/OR PRESERVE ALL HISTORICAL OR CONTROLLING MONUMENTS PRIOR TO ANY EARTHWORK. IF DESTROYED, SUCH MONUMENTS SHALL BE REPLACED WITH APPROPRIATE MONUMENTS BY A LAND SURVEYOR, A CORNER RECORD OR RECORD OF SURVEY, AS APPROPRIATE, SHALL BE FIELD AS REQUIRED BY THE PROFESSIONAL LAND SURVEYORS ACT. IF ANY VERTICAL CONTROL IS TO BE DISTURBED OR DESTROYED, THE LOCAL JURISDICTION FIELD SURVEY SECTION MUST BE NOTIFIED, IN WRITING, AT LEAST 3 DAYS PRIOR TO THE CONSTRUCTION. THE CONTRACTOR WILL BE RESPONSIBLE FOR THE COST OF REPLACING ANY VERTICAL CONTROL BENCHMARKS
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- 11. AS-BUILT DRAWINGS MUST BE SUBMITTED TO THE CITY RESIDENT ENGINEER PRIOR TO THE ACCEPTANCE OF THIS PROJECT. 12. PUBLIC IMPROVEMENT SUBJECT TO DESUETUDE OR DAMAGE." IF REPAIR OR REPLACEMENT OF SUCH PUBLIC IMPROVEMENTS IS REQUIRED, THE OWNER SHALL OBTAIN THE REQUIRED PERMITS FOR WORK IN THE PUBLIC RIGHT-OFWAY, SATISFACTORY TO THE PERMIT - ISSUING AUTHORITY.
- 13. PRIOR TO ANY DISTURBANCE TO THE SITE, EXCLUDING UTILITY MARKS-OUTS AND SURVEYING, THE CONTRACTOR SHALL MAKE ARRANGEMENTS FOR A PRE-CONSTRUCTION MEETING WITH THE LOCAL JURISDICTION FIELD ENGINEERING DIVISION.
- 14. PRIOR TO THE COMMENCEMENT OF ANY CONSTRUCTION SHOWN ON THESE PLANS. IT IS THE SOLE RESPONSIBILITY OF THE CONTRACTOR TO COORDINATE. THE CONTRACTOR IS RESPONSIBLE TO ATTEND THE LOCAL JURISDICTIONS MONTHLY UTILITY COORDINATION COMMITTEE THE CONSTRUCTION ACTIVITIES WITH THE CITY AND ALL OTHER CONTRACTORS SO THAT NO TRENCH IS CUT WITHIN ANY OF THE CITY STREETS THAT HAVE BEEN CONSTRUCTED, REPAIRED, OR SLURRY SEALED WITHIN THREE YEARS OF THE STREET CONSTRCTUION/RESURFACING DATE.
- 15. MANHOLES OR COVERS SHALL BE LABELED "CROWN CASTLE" OR "CROWN CASTLE NG WEST".
- 16 CONTRACTOR SHALL IMPLEMENT AN EROSION AND SEDIMENT CONTROL PROCRAM DURING THE PROJECT CONSTRUCTION ACTIVITIES PROGRAM SHALL MEET THE APPLICABLE REQUIREMENTS OF THE STATE WATER RESOURCE CONTROL BOAR
- 17. THE CONTRACTOR SHALL HAVE EMERGENCY MATERIALS AND EQUIPMENT ON HAND FOR UNFORESEEN SITUATIONS, SUCH AS DAMAGE TO UNDERGROUND WATER, SEWER, AND STORM DRAIN FACILITIES WHEREBY FLOWS MAY GENERATE EROSION AND SEDIMENT

SPECIAL NOTES

THE FOLLOWING NOTES ARE PROVIDED TO GIVE DIRECTIONS TO THE CONTRACTOR BY THE ENGINEER OF WORK. THE CITY ENGINEER'S SIGNATURE ON THESE PLANS DOES NOT CONSTITUTE APPROVAL OF THESE NOTES AND THE CITY WILL NOT BE RESPONSIBLE FOR THEIR ENFORCEMENT.

- THE CONTRACTOR SHALL VERIFY THE LOCATION EXISTING UNDERGROUND UTILITIES INCLUDING SEWER LATERALS AND WATER
 SERVICES TO INDIVIDUAL LOTS BOTH VERTICAL AND HORIZONTAL PRIOR TO COMMENCING IMPROVEMENT OPERATIONS.
- 2. CONTRACTOR SHALL MAKE EXPLORATION EXCAVATIONS AND LOCATE EXISTING FACILITIES SUFFICIENTLY AHEAD OF CONSTRUCTION TO PERMIT REVISIONS OF PLANS IF REVISION IS NECESSARY BECAUSE OF LOCATION OF EXISTING UTILITIES.
- 3. LOCATION AND ELEVATIONS OF IMPROVEMENTS, TO BE MET BY WORK, SHALL BE CONFIRMED BY FIELD MEASUREMENT PRIOR TO
- 4. GRADES SHOWN ARE FINISH GRADES, CONTRACTOR SHALL DETERMINE NECESSARY SUB GRADE ELEVATIONS AND SHALL CONSTRUCT SMOOTH TRANSITION BETWEEN FINISH GRADES SHOWN.
- CONTRACTOR AGREES THAT HE SHALL ASSUME SOLE RESPONSIBILITY FOR JOB SITE CONDITION DURING THE COURSE OF CONSTRUCTION OF THIS PROJECT, INCLUDING SAFETY OF ALL PERSONS AND PROPERTY: THAT THIS PROVISION SHALL APPLY CONTINUOUSLY AND NOT BE LIMITED TO NORMAL WORKING HOURS; AND THAT THE CONTRACTOR SHALL DEFEND, INDEMNIFY AND HOLD THE OWNER AND THE ENGINEER HARMLESS FROM ANY AND ALL LIABILITY, REAL OR ALLEGED IN CONNECTION WITH THE PERFORMANCE OF WORK ON THIS PROJECT, EXPECTING FOR LIABILITY ARISING FROM SOLE NEGLIGENCE OF THE OWNER OR THE
- 6. THE CONTRACTOR SHALL BE TOTALLY RESPONSIBLE FOR COMPLIANCE WITH THE PROVISIONS OF THE STATE OF CALIFORNIA SAFETY
- 7. THE LOCATIONS OF ALL EXISTING UTILITIES SHOWN ON THESE PLANS ARE FROM EXISTING RECORDS AND CORROBORATED, WHERE POSSIBLE WITH FIELD TIES. THE CONTRACTOR IS RESPONSIBLE FOR CONFIRMING THE LOCATIONS SHOWN, BOTH HORIZONTALLY AND VERTICALLY, PRIOR TO CONSTRUCTION. IF EXISTING LOCATIONS VARY SUBSTANTIALLY FROM THE PLANS, THE ENGINEER SHOULD BE NOTIFIED TO MAKE ANY CONSTRUCTION CHANGES REQUIRED.
- 8. THE CONTRACTOR SHALL PROVIDE TEMPORARY SUPPORT FOR ALL SEWER AND WATER MAIN UNDER CROSSING IN ACCORDANCE WITH PART 1 SECTION 5-2 OF THE STANDARD SPECIFICATION.
- 9. THE CONTRACTOR SHALL REPLACE OR REPAIR ALL TRAFFIC SIGNAL LOOPS, CONDUITS, AND LANE STRIPING DAMAGED DURING
- 10. THE CONTRACTOR SHALL SUBMIT WORK PLANS FOR ALL BORE OPERATIONS TWO WEEKS PRIOR TO COMMENCING WORK.
- 11. CONTRACTOR SHALL BE RESPONSIBLE FOR THE POTHOLE AND LOCATING OF ALL EXISTING UTILITIES THAT CROSS THE PROPOSED
- 12. AS-BUILT DRAWINGS MUST BE SUBMITTED TO THE CITY ENGINEER PRIOR TO ACCEPTANCE OF THIS PROJECT



CONSTRUCTION CHANGE TABLE CHANGE DATE EFFECTED OR ADDED SHEET NUMBERS

CROWN CASTLE NG WEST, INC

VERIZON MONTECITO-MON07 R.O.W. SOUTH SIDE OF BELLE VISTA DR (ADJACENT TO 2395 BELLE VISTA DR) SANTA BARBARA, CA 93108



•	GROUND BUS BAR MECH. GRND. CONN. CADWELD	☆ O	LIGHT POLE FOUNDATION SPOT ELEV.	X X X X X-x	ELEVATION REF. SECTION REF.		ELECT. CONDUIT COAXIAL CABLE
	ELECTRIC BOX TELEPHONE BOX EXISTING SERVICE POLE SIDEWALK FLAG EX. MANHOLE	\(\lambda \) \(\lambda \) \(\lambda \) \(\lambda \)	SET POINT REVISION DETAIL REF.	——————————————————————————————————————	PROP./LEASE LINE MATCH LINE WORK POINT TELE. CONDUIT CENTERLINE	□ □	MYERS PEDESTAL VAULT STANDARD 2'X3' STEEL POLE
	CV	MRAI	C LINET	VDEC VI	UD HATCH	DATTERNIC	

SIMBULS, LINETIPES AND HATCH PATTERNS

APPLICABLE CODES

ALL WORK SHALL COMPLY WITH THE FOLLOWING APPLICABLE CODES:

- IN THE EVENT OF CONFLICT, THE MOST RESTRICTIVE CODE SHALL PREVAIL

PROJECT DESCRIPTION

PROJECT CONSISTS OF INSTALLATION OF

- 1. (2) OMNI ANTENNAS ON EXISTING UTILITY POLE 2. EQUIPMENT SHROUD ON EXISTING POLE
- 3. EQUIPMENT PEDESTAL W/ BBU AND ELECTRICAL METER AT BASE OF

SHEET INDEX:

TITLE SHEET T-1 - SHEET 1 OF 5 SITE PLAN A-1 - SHEET 2 OF 5 PROPOSED ELEVATIONS A-2 - SHEET 3 OF 5 D-1 - SHEET 4 OF 5 DETAILS D-2 - SHEET 5 OF 5

EROSION AND SEDIMENT CONTROL NOTES

TEMPORARY EROSION/SEDIMENT CONTROL, PRIOR TO COMPLETION OF FINAL IMPROVEMENTS. SHALL BE PERFORMED BY THE CONTRACTOR OR QUALIFIED PERSON AS INDICATED BELOW:

- 1. ALL REQUIREMENTS OF THE LOCAL JURISDICTION "LAND DEVELOPMENT MANUAL, STORM WATER STANDARDS" MUST BE INCORPORATED INTO THE DESIGN AND CONSTRUCTION OF THE PROPOSED GRADING/IMPROVEMENTS CONSISTENT WITH THE APPROVED STORM WATER AND/OR WATER POLLUTION CONTROL PLAN (WPCP).
- 2. FOR STORM DRAIN INLETS, PROVIDE A GRAVEL BAG SILT BASIN IMMEDIATELY UPSTREAM OF INLET AS INDICATED ON DETAILS.
- 3. FOR INLETS LOCATED AT SUMPS ADJACENT TO TOP OF SLOPES, THE CONTRACTOR SHALL ENSURE THAT WATER DRAINING TO THE SUMP IS DIRECTED INTO THE INLET AND THAT A MINIMUM OF 1.00" FREEBOARD EXISTS AND IS MAINTAINED ABOVE THE TOP OF THE INLET. IF FREEBOARD IS NOT PROVIDED BY GRADING SHOWN ON THESE PLANS, THE CONTRACTOR SHALL PROVIDE IT VIA TEMPORARY MEASURES, I.E. GRAVEL BAGS OR DIKES.
- 4. THE CONTRACTOR OR QUALIFIED PERSON SHALL BE RESPONSIBLE FOR CLEANUP OF SILT AND MUD ON ADJACENT STREET(S) AND STORM DRAIN SYSTEM DUE TO CONSTRUCTION
- 5. THE CONTRACTOR OR QUALIFIED PERSON SHALL CHECK AND MAINTAIN ALL LINED AND UNLINED DITCHES AFTER EACH RAINFALL.
- 6. THE CONTRACTOR SHALL REMOVE SILT AND DEBRIS AFTER EACH MAJOR RAINFALL.
- EQUIPMENT AND WORKERS FOR EMERGENCY WORK SHALL BE MADE AVAILABLE AT ALL TIMES DURING THE RAINY SEASON, ALL NECESSARY MATERIALS SHALL BE STOCKPILED ON SITE AT CONVENIENT LOCATIONS TO FACILITATE RAPID CONSTRUCTION OF TEMPORARY DEVICES WHEN RAIN IS IMMINENT.
- 8. THE CONTRACTOR SHALL RESTORE ALL EROSION/SEDIMENT CONTROL MEASURES TO WORKING ORDER TO THE SATISFACTION OF THE CITY ENGINEER OR RESIDENT ENGINEER AFTER EACH RUN-OFF PRODUCING RAINFALL.
- THE CONTRACTOR SHALL INSTALL ADDITIONAL EROSION CONTROL MEASURES AS MAY BE REQUIRED BY THE RESIDENT ENGINEER DUE TO UNCOMPLETED GRADING OPERATIONS OR UNFORESEEN CIRCUMSTANCES, WHICH MAY ARISE.
- 10. THE CONTRACTOR SHALL BE RESPONSIBLE AND SHALL TAKE NECESSARY PRECAUTIONS TO PREVENT PUBLIC TRESPASS ONTO AREAS WHERE IMPOUNDED WATERS CREATE A HAZARDOUS CONDITION.
- 11. ALL EROSION/SEDIMENT CONTROL MEASURES PROVIDED PER THE APPROVED GRADING PLAN SHALL BE INCORPORATED HEREON. ALL EROSION/SEDIMENT CONTROL FOR INTERIM CONDITIONS SHALL BE DONE TO THE SATISFACTION OF THE RESIDENT ENGINEER. 12 CRADED AREAS AROUND THE PROJECT PERIMETER MUST DRAIN AWAY FROM THE FACE
- OF THE SLOPE AT THE CONCLUSION OF EACH WORKING DAY. 13. ALL REMOVABLE PROTECTIVE DEVICES SHOWN SHALL BE IN PLACE AT THE END OF EACH
- 14. THE CONTRACTOR SHALL ONLY GRADE, INCLUDING CLEARING AND GRUBBING FOR THE AREAS FOR WHICH THE CONTRACTOR OR QUALIFIED PERSON CAN PROVIDE EROSION/SEDIMENT CONTROL MEASURES.
- 15 THE CONTRACTOR SHALL ARRANGE FOR WEEKLY MEETINGS DURING OCTORER 1ST TO APRIL 30TH FOR PROJECT TEAM (GENERAL CONTRACTOR, QUALIFIED PERSON, EROSION CONTROL SUBCONTRACTOR IF ANY, ENGINEER OF WORK, OWNER AND THE RESIDENT ENGINEER) TO EVALUATE THE ADEQUACY OF THE EROSION/SEDIMENT CONTROL MEASURES AND OTHER RELATED CONSTRUCTION ACTIVITIES.

TRAFFIC CONTROL NOTES

WORKING DAY WHEN RAIN IS IMMINENT.

THE CONTRACTOR SHALL SUBMIT A TRAFFIC CONTROL PLAN (11" X 17") FOR APPROVAL PRIOR TO STARTING WORK. THE PLAN SHOULD BE SUBMITTED TO THE TRAFFIC CONTROL PERMIT COUNTER. CONTRACTOR SHALL OBTAIN A TRAFFIC CONTROL PERMIT A MINIMUM OF TWO (2) WORKING DAYS PRIOR TO STARTING WORK, AND A MINIMUM FIVE (5) DAYS IF WORK WILL AFFECT A BUS STOP OR AN EXISTING TRAFFIC SIGNAL, OR IF WORK WILL REQUIRE A

FOOTAGE TOTALS		
ASPHALT CUT	-	
DIRT TRENCH	-	
PUNCH THRU	-	
BORE	-	
TOTAL	=	
R&R SWF TOTAL	-	

PROJECT DICTIONARY

R.O.W. SOUTH SIDE OF BELLE VISTA DR SITE ADDRESS: (ADJACENT TO 2395 BELLE VISTA DR) SANTA BARBARA, CA 93108

APPLICANT: CROWN CASTLE NG WEST, INC 2125 WRIGHT AVE. SUITE #C9 LA VERNE, CA 91750 CONTACT: HEIDI PAYNE

PHONE: (949) 300-9493

CONNELL DESIGN GROUP, LLC 26455 RANCHO PARKWAY SOUTH LAKE FOREST, CA 92630 CONTACT: FRANK CARTER (949) 310-8233 PHONE

(949) 753-8833 FAX

REVISION DESCRIPTION: DATE/BY: ISSUED FOR 02/06/2014 REVIEW FXC ISSUED FOR

ENGINEER/CONSULTANT:



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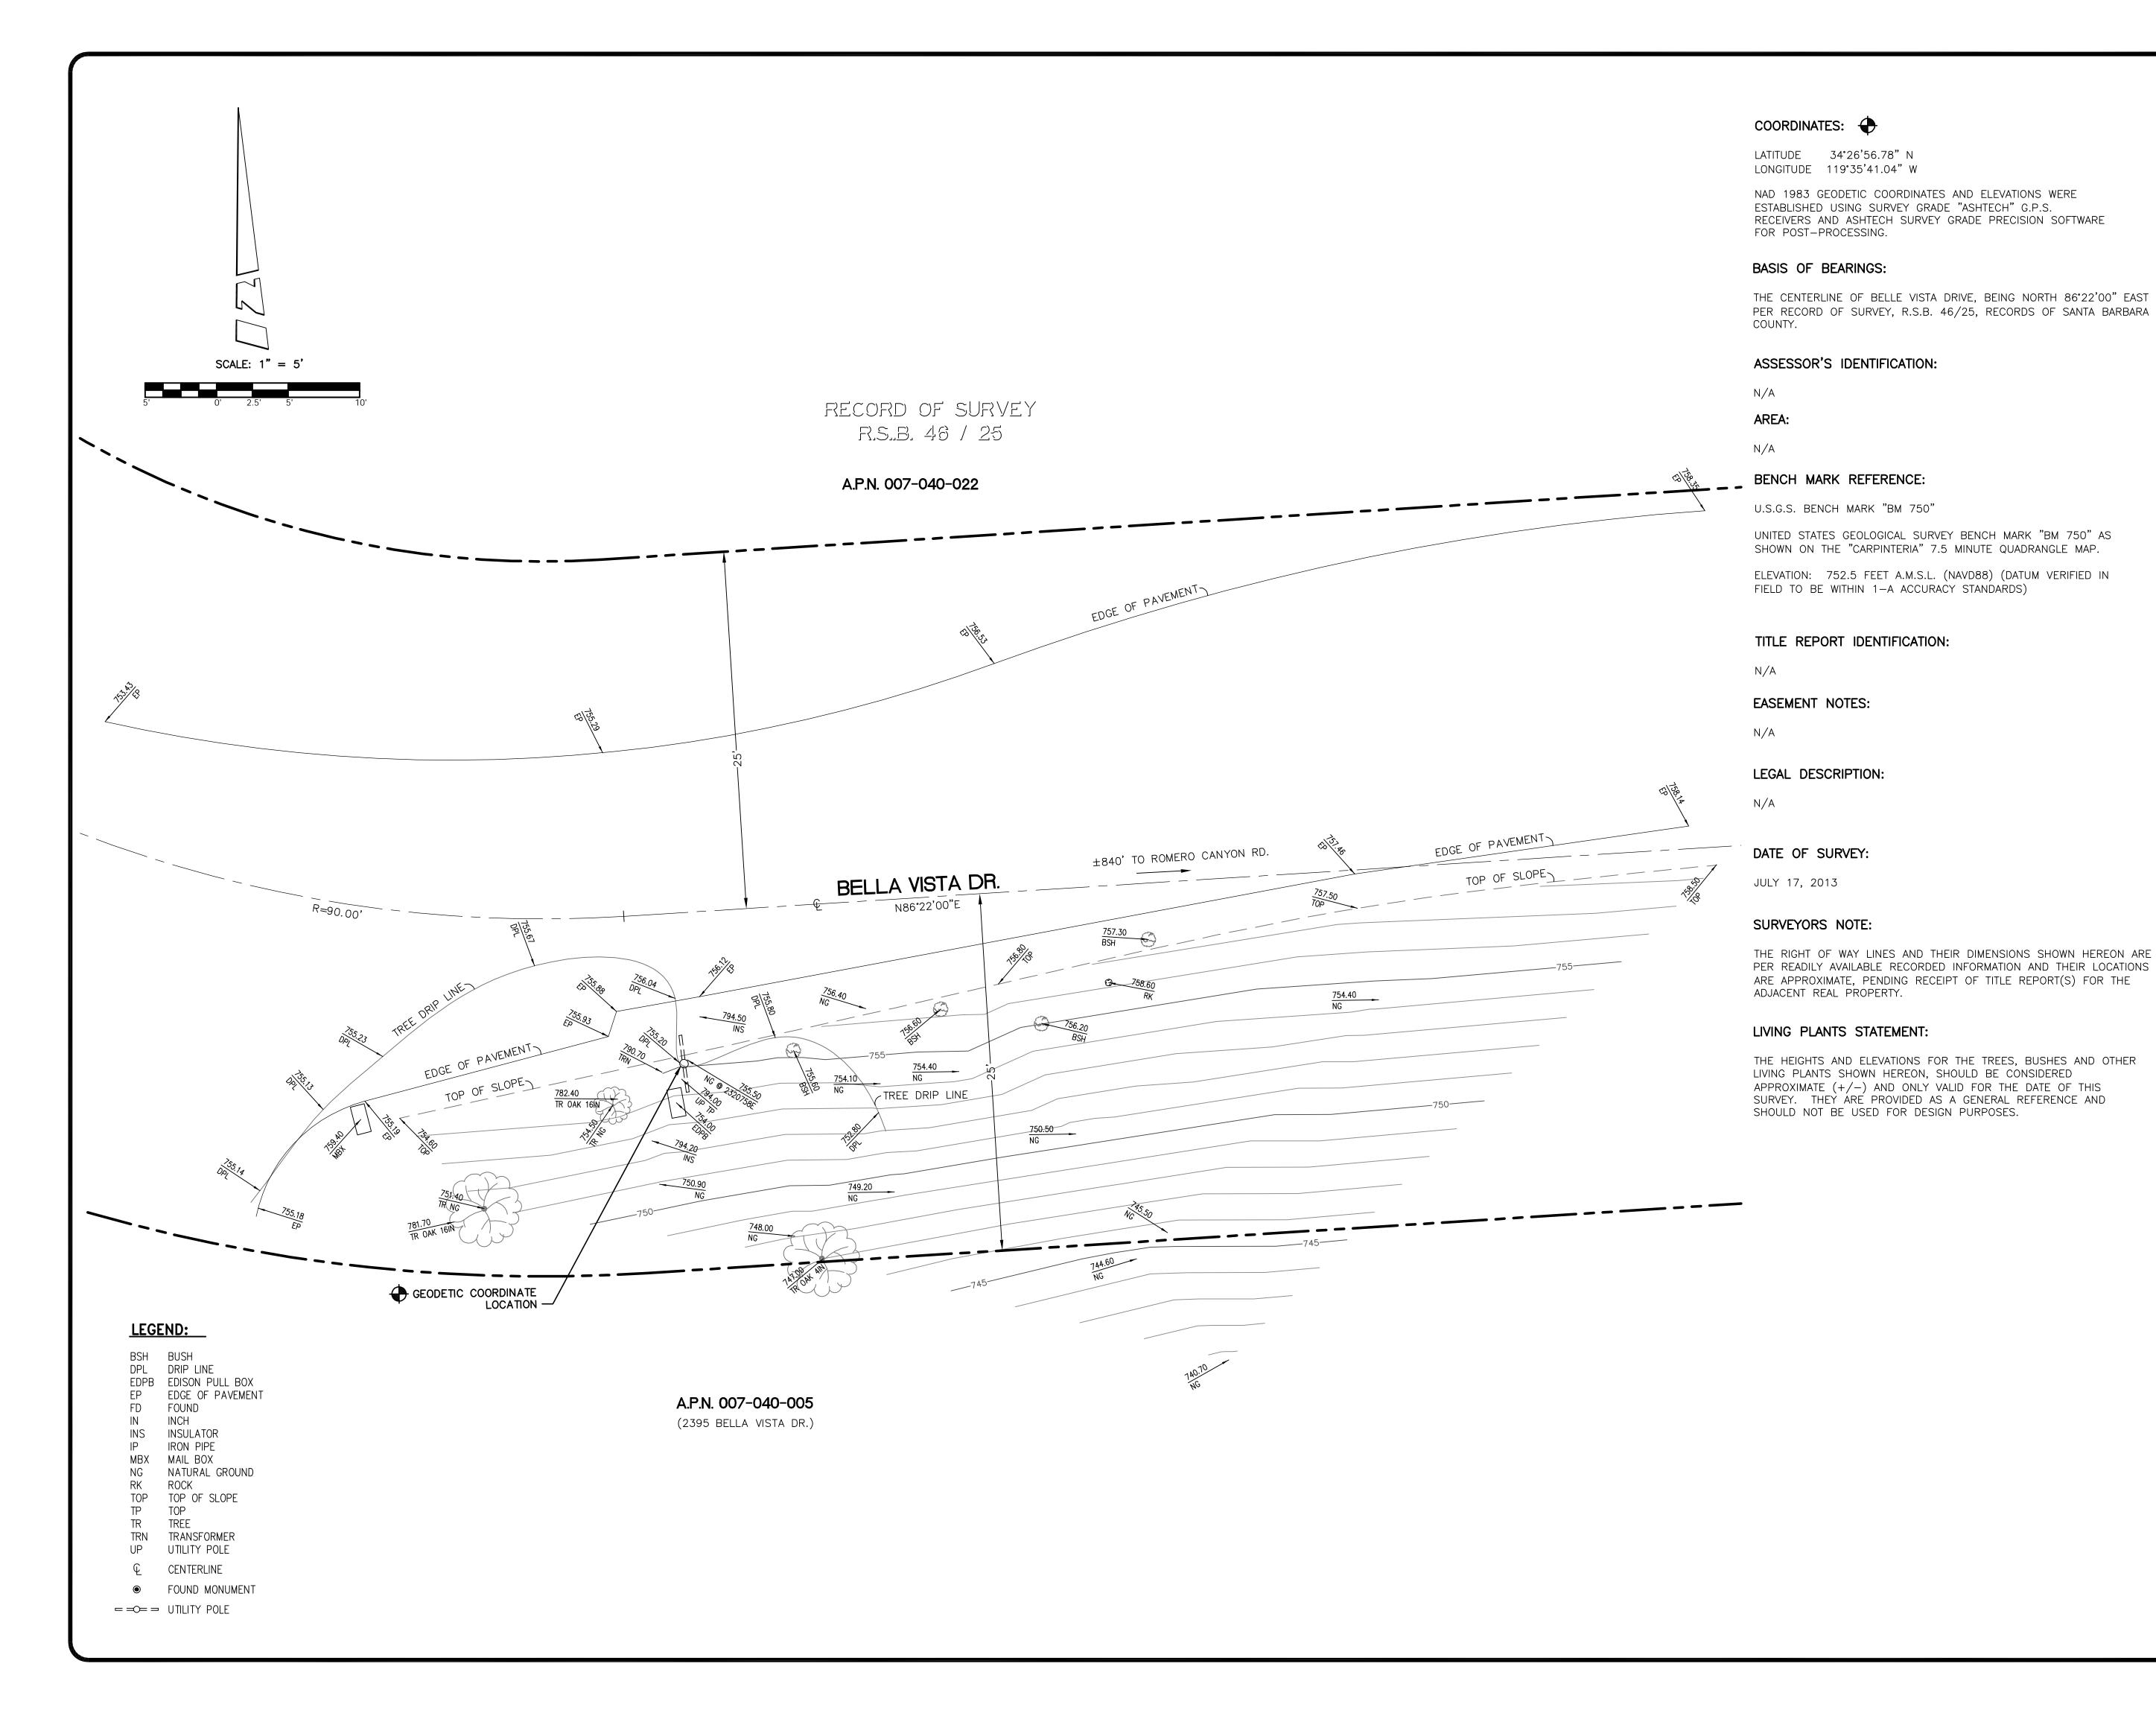
SITE INFO:

MON07 VERIZON MONTECITO-MON07

SITE ADDRESS: THOMAS BROS PAGE 987 GRID D-7 R.O.W. SOUTH SIDE OF BELLE VISTA DR (ADJACENT TO 2395 BELLE VISTA DR) SANTA BARBARA, CA 93108 LAT: 34.449106 LONG: -119.594733

> SHEET TITLE: TITLE SHEET

DRAWING INFO:



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-	Quantum Control		



LAKE FOREST, CA 92630-8326

(949) 753-8807 OFFICE - (949) 753-8833 FAX

SITE BUILDER:



SURVEYOR:

BERT HAZE

AND ASSOCIATES, INC.

LAND SURVEYING & MAPPING

3188 AIRWAY AVENUE, SUITE K1

COSTA MESA, CALIFORNIA 92626

714 557-1567 OFFICE

714 557-1568 FAX

JN. 706.222

STAMP:



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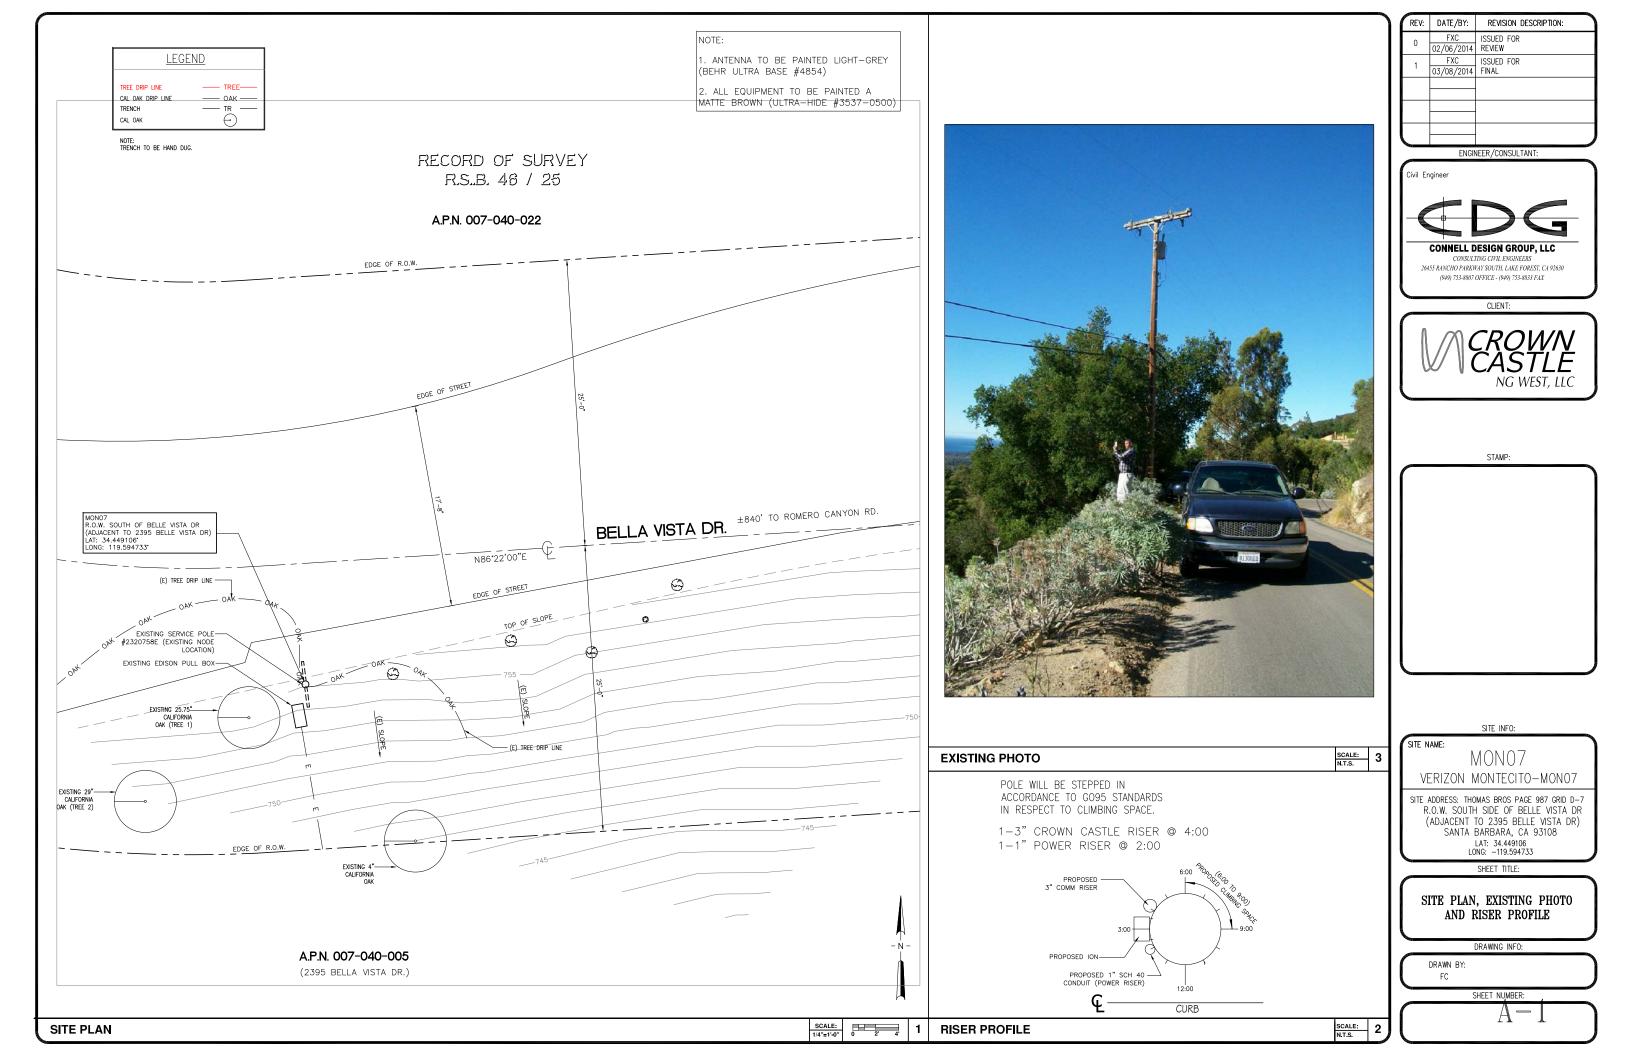
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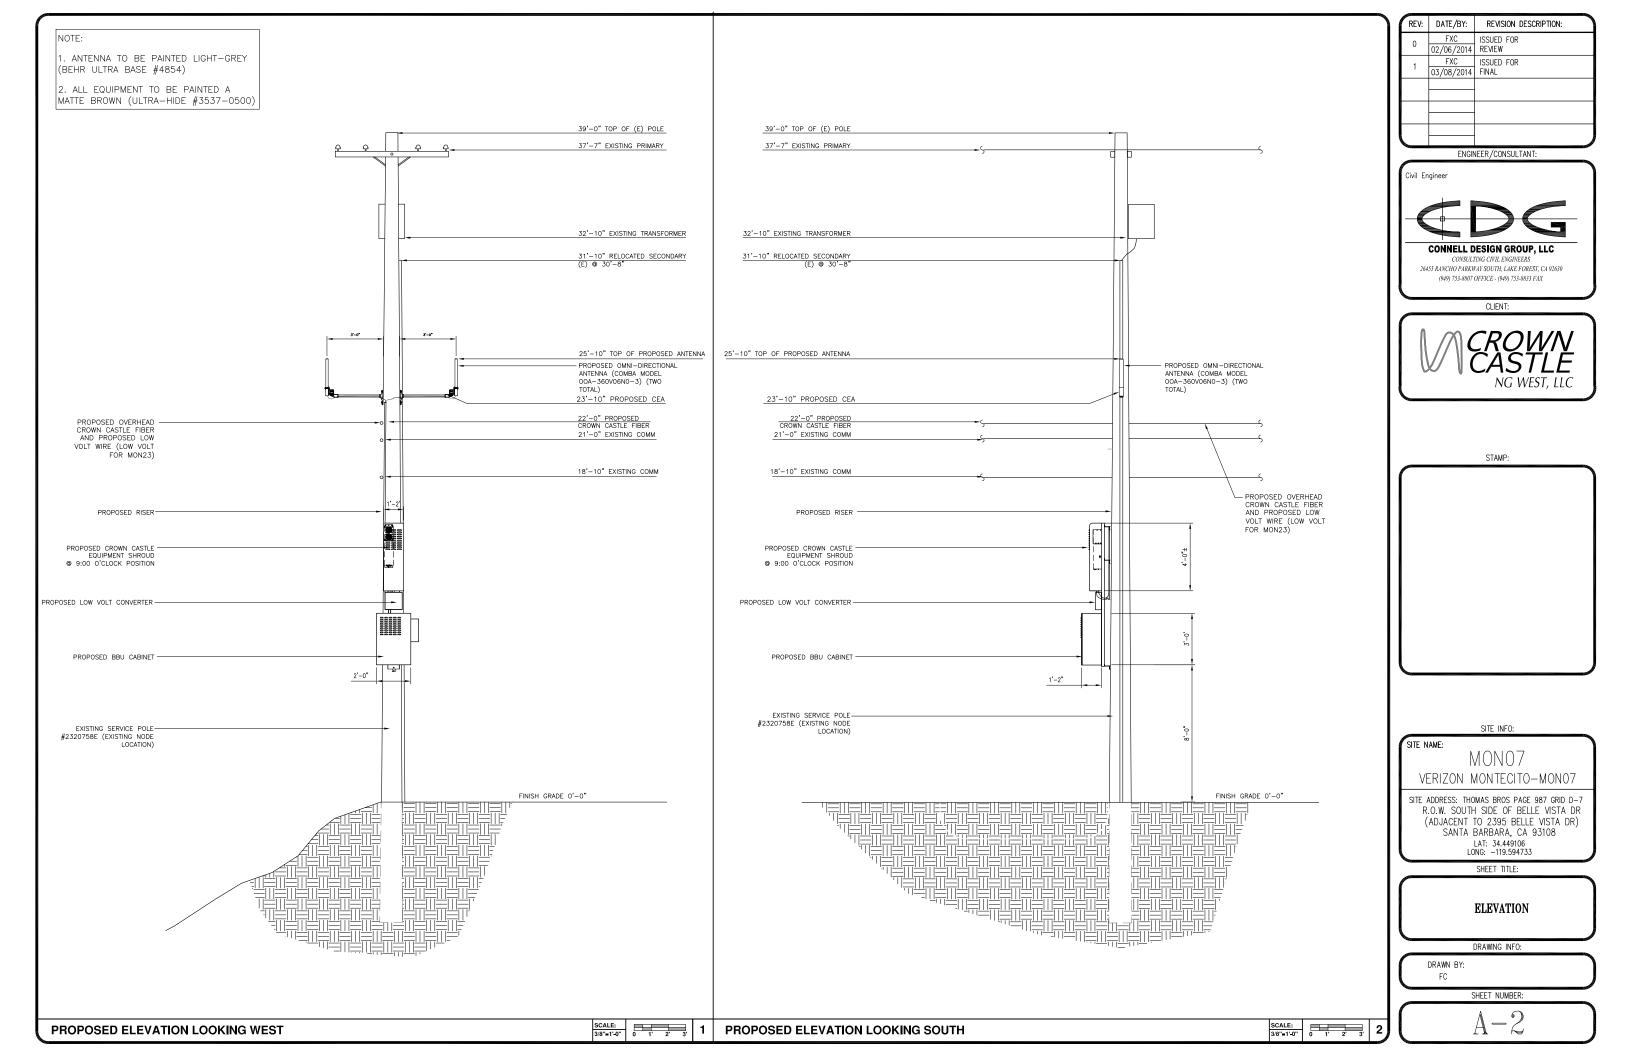
TOPOGRAPHIC SURVEY

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MON07	MDL	07/25/13
DWG. NAME:	DRAWN BY:	DATE:

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Outdoor Omni-directional Antenna

COMBA

OOA-360V06N0-3 VPol, 696-960/1710-2170MHz, 360°, 4.0/6.0 dBi


Technical Specifications

Electrical

Frequency Range	MHz	696-960	1710-2170
Polarization		Ver	tical
Gain	dBi	4.0±1	6.0±1
Horizontal Beamwidth	deg	36	<i>50</i>
Vertical Beamwidth	deg	22-53	20-26
Electrical Downtilt-Fixed	deg	()
VSWR			1.8
Maximum Power	W	2	00
Impedance			50
Lightning Protection		Direc	t Ground

Mechanical

Dimensions, HxDia Weight, with Mounting kit Radome Material and Color Radiating Element Material Connector Type and Location Operational Temperature Operational Humidity Operational Wind Speed km/h (mph)
Shipping Dimensions, HxWxD mm (in)
Shipping Weight kg (lb)

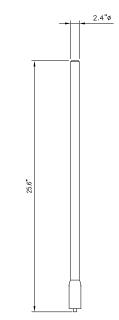

N.T.S.


ANTENNA SPECIFICATIONS

650x60 (25.6x2.4)

1 (2.2) Fiberglass, Light Grey

200 (124) 670x100x100 (26.4x3.9x3.9) 1.2 (2.65)

Copper N-Female, Bottom -55 to +70 95

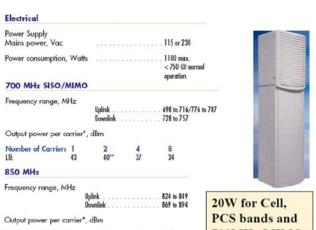



700MHz MIMO


Noise figure, dB

Height, width, depth, mm (in) 817 x 245 x 218 40 (88.2) Weight, kg (lb)

Page 1, February 27, 2013 Company Confidential

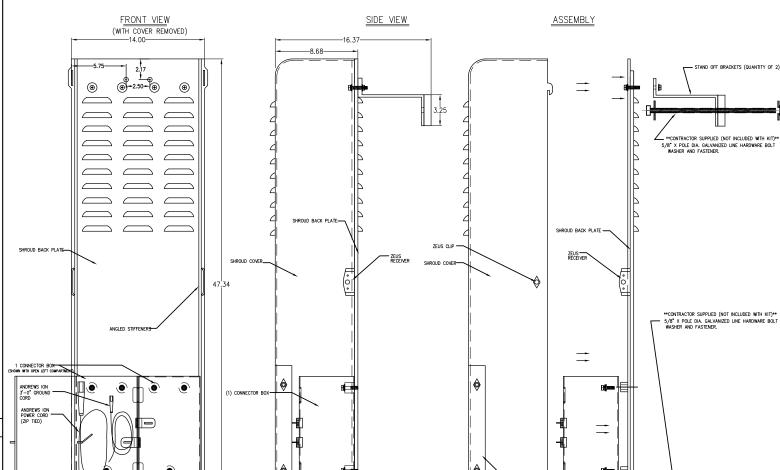

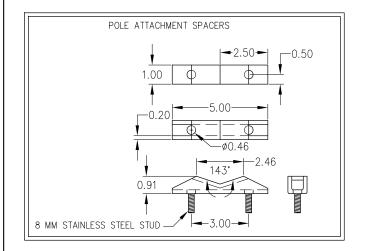

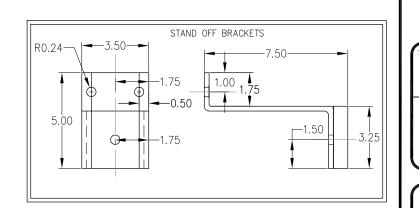

SHROUD CONNECTOR -

	REV:	DATE/BY:	REVISION DESCRIPTION:
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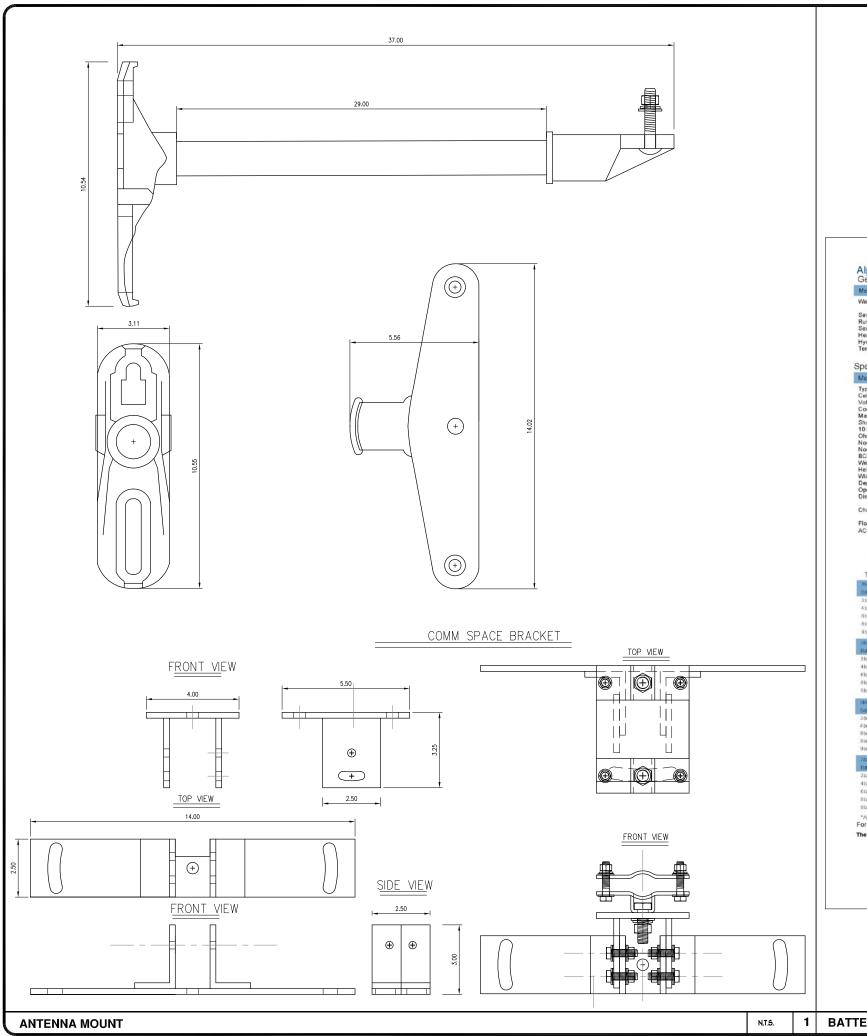
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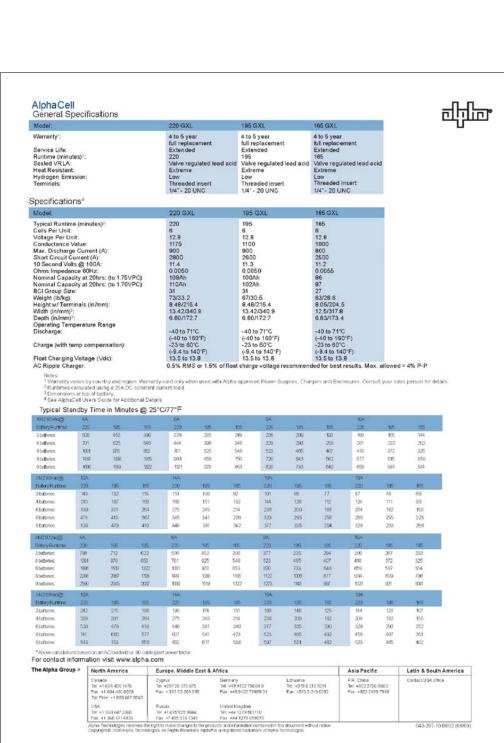
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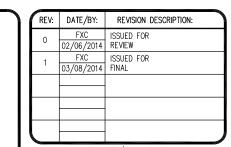
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ION-M7P/7P/85P/19P N.T.S. SHROUD DETAIL N.T.S.







Civil Engineer

CONNELL DESIGN GROUP, LLC

CONSULTING CIVIL ENGINEERS 26455 RANCHO PARKWAY SOUTH, LAKE FOREST, CA 92630 (949) 753-8807 OFFICE - (949) 753-8833 FAX

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SPECIAL NOTES

THE FOLLOWING NOTES ARE PROVIDED TO GIVE DIRECTIONS TO THE CONTRACTOR BY THE ENGINEER OF WORK. THE CITY ENGINEER'S SIGNATURE ON THESE PLANS DOES NOT CONSTITUTE APPROVAL OF THESE NOTES AND THE CITY WILL NOT BE RESPONSIBLE FOR THEIR ENFORCEMENT.


- THE CONTRACTOR SHALL VERIFY THE LOCATION EXISTING UNDERGROUND UTILITIES INCLUDING SEWER LATERALS AND WATER SERVICES TO INDIVIDUAL LOTS BOTH VERTICAL AND HORIZONTAL PRIOR TO COMMENCING IMPROVEMENT OPERATIONS.
- 2. CONTRACTOR SHALL MAKE EXPLORATION EXCAVATIONS AND LOCATE EXISTING FACILITIES SUFFICIENTLY AHEAD OF CONSTRUCTION TO PERMIT REVISIONS OF PLANS IF REVISION IS NECESSARY BECAUSE OF LOCATION OF EXISTING UTILITIES.
- 3. LOCATION AND ELEVATIONS OF IMPROVEMENTS, TO BE MET BY WORK, SHALL BE CONFIRMED BY FIELD MEASUREMENT PRIOR TO
- 4. GRADES SHOWN ARE FINISH GRADES, CONTRACTOR SHALL DETERMINE NECESSARY SUB GRADE ELEVATIONS AND SHALL CONSTRUCT SMOOTH TRANSITION BETWEEN FINISH GRADES SHOWN.
- 5. Contractor agrees that he shall assume sole responsibility for job site condition during the course of construction of this project, including safety of all persons and property: that this provision shall apply CONTINUOUSLY AND NOT BE LIMITED TO NORMAL WORKING HOURS; AND THAT THE CONTRACTOR SHALL DEFEND, INDEMNIFY AND HOLD THE OWNER AND THE ENGINEER HARMLESS FROM ANY AND ALL LIABILITY, REAL OR ALLEGED IN CONNECTION WITH THE PERFORMANCE OF WORK ON THIS PROJECT, EXPECTING FOR LIABILITY ARISING FROM SOLE NEGLIGENCE OF THE OWNER OR THE
- 6. THE CONTRACTOR SHALL BE TOTALLY RESPONSIBLE FOR COMPLIANCE WITH THE PROVISIONS OF THE STATE OF CALIFORNIA SAFETY
- 7. THE LOCATIONS OF ALL EXISTING UTILITIES SHOWN ON THESE PLANS ARE FROM EXISTING RECORDS AND CORROBORATED, WHERE POSSIBLE WITH FIELD TIES. THE CONTRACTOR IS RESPONSIBLE FOR CONFIRMING THE LOCATIONS SHOWN, BOTH HORIZONTALLY AND VERTICALLY, PRIOR TO CONSTRUCTION. IF EXISTING LOCATIONS VARY SUBSTANTIALLY FROM THE PLANS, THE ENGINEER SHOULD BE NOTIFIED TO MAKE ANY CONSTRUCTION CHANGES REQUIRED.
- 8. THE CONTRACTOR SHALL PROVIDE TEMPORARY SUPPORT FOR ALL SEWER AND WATER MAIN UNDER CROSSING IN ACCORDANCE WITH PART 1 SECTION 5-2 OF THE STANDARD SPECIFICATION.
- 9. THE CONTRACTOR SHALL REPLACE OR REPAIR ALL TRAFFIC SIGNAL LOOPS, CONDUITS, AND LANE STRIPING DAMAGED DURING
- 10. THE CONTRACTOR SHALL SUBMIT WORK PLANS FOR ALL BORE OPERATIONS TWO WEEKS PRIOR TO COMMENCING WORK.
- 11. CONTRACTOR SHALL BE RESPONSIBLE FOR THE POTHOLE AND LOCATING OF ALL EXISTING UTILITIES THAT CROSS THE PROPOSED
- 12. AS-BUILT DRAWINGS MUST BE SUBMITTED TO THE CITY ENGINEER PRIOR TO ACCEPTANCE OF THIS PROJECT




CONSTRUCTION CHANGE TABLE CHANGE DATE EFFECTED OR ADDED SHEET NUMBERS

CROWN CASTLE NG WEST, INC

VERIZON MONTECITO-MON08 R.O.W. EAST SIDE OF SHEFFIELD DR (ADJACENT TO 336 SHEFFIELD DR) SANTA BARBARA, CA 93108

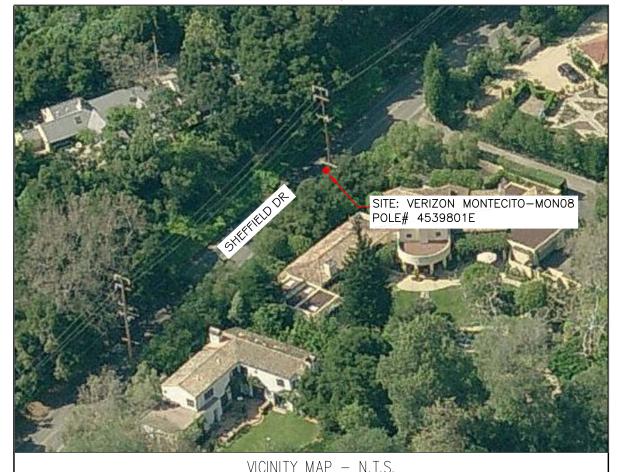

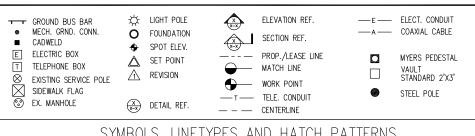

SYMBOLS, LINETYPES AND HATCH PATTERNS

APPLICABLE CODES

ALL WORK SHALL COMPLY WITH THE FOLLOWING APPLICABLE CODES:

- IN THE EVENT OF CONFLICT, THE MOST RESTRICTIVE CODE SHALL PREVAIL

PROJECT DESCRIPTION

PROJECT CONSISTS OF INSTALLATION OF

- . (2) OMNI ANTENNA ON EXISTING UTILITY POLE
- 2. EQUIPMENT SHROUD ON EXISTING POLE
- 3. EQUIPMENT PEDESTAL W/ BBU AND ELECTRICAL METER AT BASE OF

SHFFT INDEX

011661	II V D L / V ·
TITLE SHEET	T-1 - SHEET 1 OF 7
SITE PLAN	A-1 - SHEET 2 OF 7
PROPOSED ELEVATIONS	A-2 - SHEET 3 OF 7
GRADING PLAN	A-3 - SHEET 4 OF 7
DETAILS	D-1 - SHEET 5 OF 7
DETAILS	D-2 - SHEET 6 OF 7

D-3 - SHEET 7 OF 7

EROSION AND SEDIMENT CONTROL NOTES

TEMPORARY EROSION/SEDIMENT CONTROL, PRIOR TO COMPLETION OF FINAL IMPROVEMENTS. SHALL BE PERFORMED BY THE CONTRACTOR OR QUALIFIED PERSON AS INDICATED BELOW:

- 1. ALL REQUIREMENTS OF THE LOCAL JURISDICTION "LAND DEVELOPMENT MANUAL, STORM WATER STANDARDS" MUST BE INCORPORATED INTO THE DESIGN AND CONSTRUCTION OF THE PROPOSED GRADING/IMPROVEMENTS CONSISTENT WITH THE APPROVED STORM WATER AND/OR WATER POLLUTION CONTROL PLAN (WPCP).
- 2. FOR STORM DRAIN INLETS, PROVIDE A GRAVEL BAG SILT BASIN IMMEDIATELY UPSTREAM OF INLET AS INDICATED ON DETAILS.
- 3. FOR INLETS LOCATED AT SUMPS ADJACENT TO TOP OF SLOPES, THE CONTRACTOR SHALL ENSURE THAT WATER DRAINING TO THE SUMP IS DIRECTED INTO THE INLET AND THAT A MINIMUM OF 1.00" FREEBOARD EXISTS AND IS MAINTAINED ABOVE THE TOP OF THE INLET. IF FREEBOARD IS NOT PROVIDED BY GRADING SHOWN ON THESE PLANS, THE CONTRACTOR SHALL PROVIDE IT VIA TEMPORARY MEASURES, I.E. GRAVEL BAGS OR DIKES.
- 4. THE CONTRACTOR OR QUALIFIED PERSON SHALL BE RESPONSIBLE FOR CLEANUP OF SILT AND MUD ON ADJACENT STREET(S) AND STORM DRAIN SYSTEM DUE TO CONSTRUCTION
- 5. THE CONTRACTOR OR QUALIFIED PERSON SHALL CHECK AND MAINTAIN ALL LINED AND UNLINED DITCHES AFTER EACH RAINFALL.
- 6. THE CONTRACTOR SHALL REMOVE SILT AND DEBRIS AFTER EACH MAJOR RAINFALL.
- EQUIPMENT AND WORKERS FOR EMERGENCY WORK SHALL BE MADE AVAILABLE AT ALL TIMES DURING THE RAINY SEASON, ALL NECESSARY MATERIALS SHALL BE STOCKPILED ON SITE AT CONVENIENT LOCATIONS TO FACILITATE RAPID CONSTRUCTION OF TEMPORARY DEVICES WHEN RAIN IS IMMINENT.
- 8. THE CONTRACTOR SHALL RESTORE ALL EROSION/SEDIMENT CONTROL MEASURES TO WORKING ORDER TO THE SATISFACTION OF THE CITY ENGINEER OR RESIDENT ENGINEER AFTER EACH RUN-OFF PRODUCING RAINFALL.
- THE CONTRACTOR SHALL INSTALL ADDITIONAL EROSION CONTROL MEASURES AS MAY BE REQUIRED BY THE RESIDENT ENGINEER DUE TO UNCOMPLETED GRADING OPERATIONS OR UNFORESEEN CIRCUMSTANCES, WHICH MAY ARISE.
- 10. THE CONTRACTOR SHALL BE RESPONSIBLE AND SHALL TAKE NECESSARY PRECAUTIONS TO PREVENT PUBLIC TRESPASS ONTO AREAS WHERE IMPOUNDED WATERS CREATE A HAZARDOUS CONDITION.
- 11. ALL EROSION/SEDIMENT CONTROL MEASURES PROVIDED PER THE APPROVED GRADING PLAN SHALL BE INCORPORATED HEREON. ALL EROSION/SEDIMENT CONTROL FOR INTERIM CONDITIONS SHALL BE DONE TO THE SATISFACTION OF THE RESIDENT ENGINEER.
- 12 CRADED AREAS AROUND THE PROJECT PERIMETER MUST DRAIN AWAY FROM THE FACE OF THE SLOPE AT THE CONCLUSION OF EACH WORKING DAY.
- 13. ALL REMOVABLE PROTECTIVE DEVICES SHOWN SHALL BE IN PLACE AT THE END OF EACH WORKING DAY WHEN RAIN IS IMMINENT.
- 14. THE CONTRACTOR SHALL ONLY GRADE, INCLUDING CLEARING AND GRUBBING FOR THE AREAS FOR WHICH THE CONTRACTOR OR QUALIFIED PERSON CAN PROVIDE FROSION/SEDIMENT CONTROL MEASURES.
- 15. THE CONTRACTOR SHALL ARRANGE FOR WEEKLY MEETINGS DURING OCTOBER 1ST TO APRIL 30TH FOR PROJECT TEAM (GENERAL CONTRACTOR, QUALIFIED PERSON, EROSION CONTROL SUBCONTRACTOR IF ANY, ENGINEER OF WORK, OWNER AND THE RESIDENT ENGINEER) TO EVALUATE THE ADEQUACY OF THE EROSION/SEDIMENT CONTROL MEASURES AND OTHER RELATED CONSTRUCTION ACTIVITIES.

TRAFFIC CONTROL NOTES

THE CONTRACTOR SHALL SUBMIT A TRAFFIC CONTROL PLAN (11" X 17") FOR APPROVAL PRIOR TO STARTING WORK. THE PLAN SHOULD BE SUBMITTED TO THE TRAFFIC CONTROL PERMIT COUNTER. CONTRACTOR SHALL OBTAIN A TRAFFIC CONTROL PERMIT A MINIMUM OF TWO (2) WORKING DAYS PRIOR TO STARTING WORK, AND A MINIMUM FIVE (5) DAYS IF WORK WILL AFFECT A BUS STOP OR AN EXISTING TRAFFIC SIGNAL, OR IF WORK WILL REQUIRE A

FOOTAGE TOTALS	
ASPHALT CUT	-
DIRT TRENCH	-
PUNCH THRU	-
BORE	-
TOTAL	=
R&R SWF TOTAL	_

PROJECT DICTIONARY

R.O.W. EAST SIDE OF SHEFFIELD DR SITE ADDRESS: (ADJACENT TO 336 SHEFFIELD DR) SANTA BARBARA, CA 93108

CROWN CASTLE NG WEST, INC 2125 WRIGHT AVE. SUITE #C9 LA VERNE, CA 91750 CONTACT: HEIDI PAYNE

PHONE: (949) 300-9493 CONNELL DESIGN GROUP, LLC CIVIL ENGINEER:

26455 RANCHO PARKWAY SOUTH LAKE FOREST, CA 92630 CONTACT: FRANK CARTER (949) 310-8233 PHONE (949) 753-8833 FAX

۱	REV:	DATE/BY:	REVISION DESCRIPTION:
	0	FXC 02/10/2013	ISSUED FOR REVIEW
	1	SA 03/19/2013	ISSUED FOR APPROVAL
	2	SA 11/05/2013	ISSUED FOR APPROVAL
	3	SA 03/08/2014	ISSUED FOR APPROVAL
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ENGINEER/CONSULTANT:



CLIENT:

(949) 753-8807 OFFICE - (949) 753-8833 FAX



STAMP

SITE INFO:

MON08 VERIZON MONTECITO-MON08


SITE ADDRESS: THOMAS BROS PAGE 997 GRID C3 R.O.W. EAST SIDE OF SHEFFIELD DR (ADJACENT TO 336 SHEFFIELD DR) SANTA BARBARA, CA 93108 LAT: 34.42763 LONG: -119.608736

SHEET TITLE:

TITLE SHEET

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{			

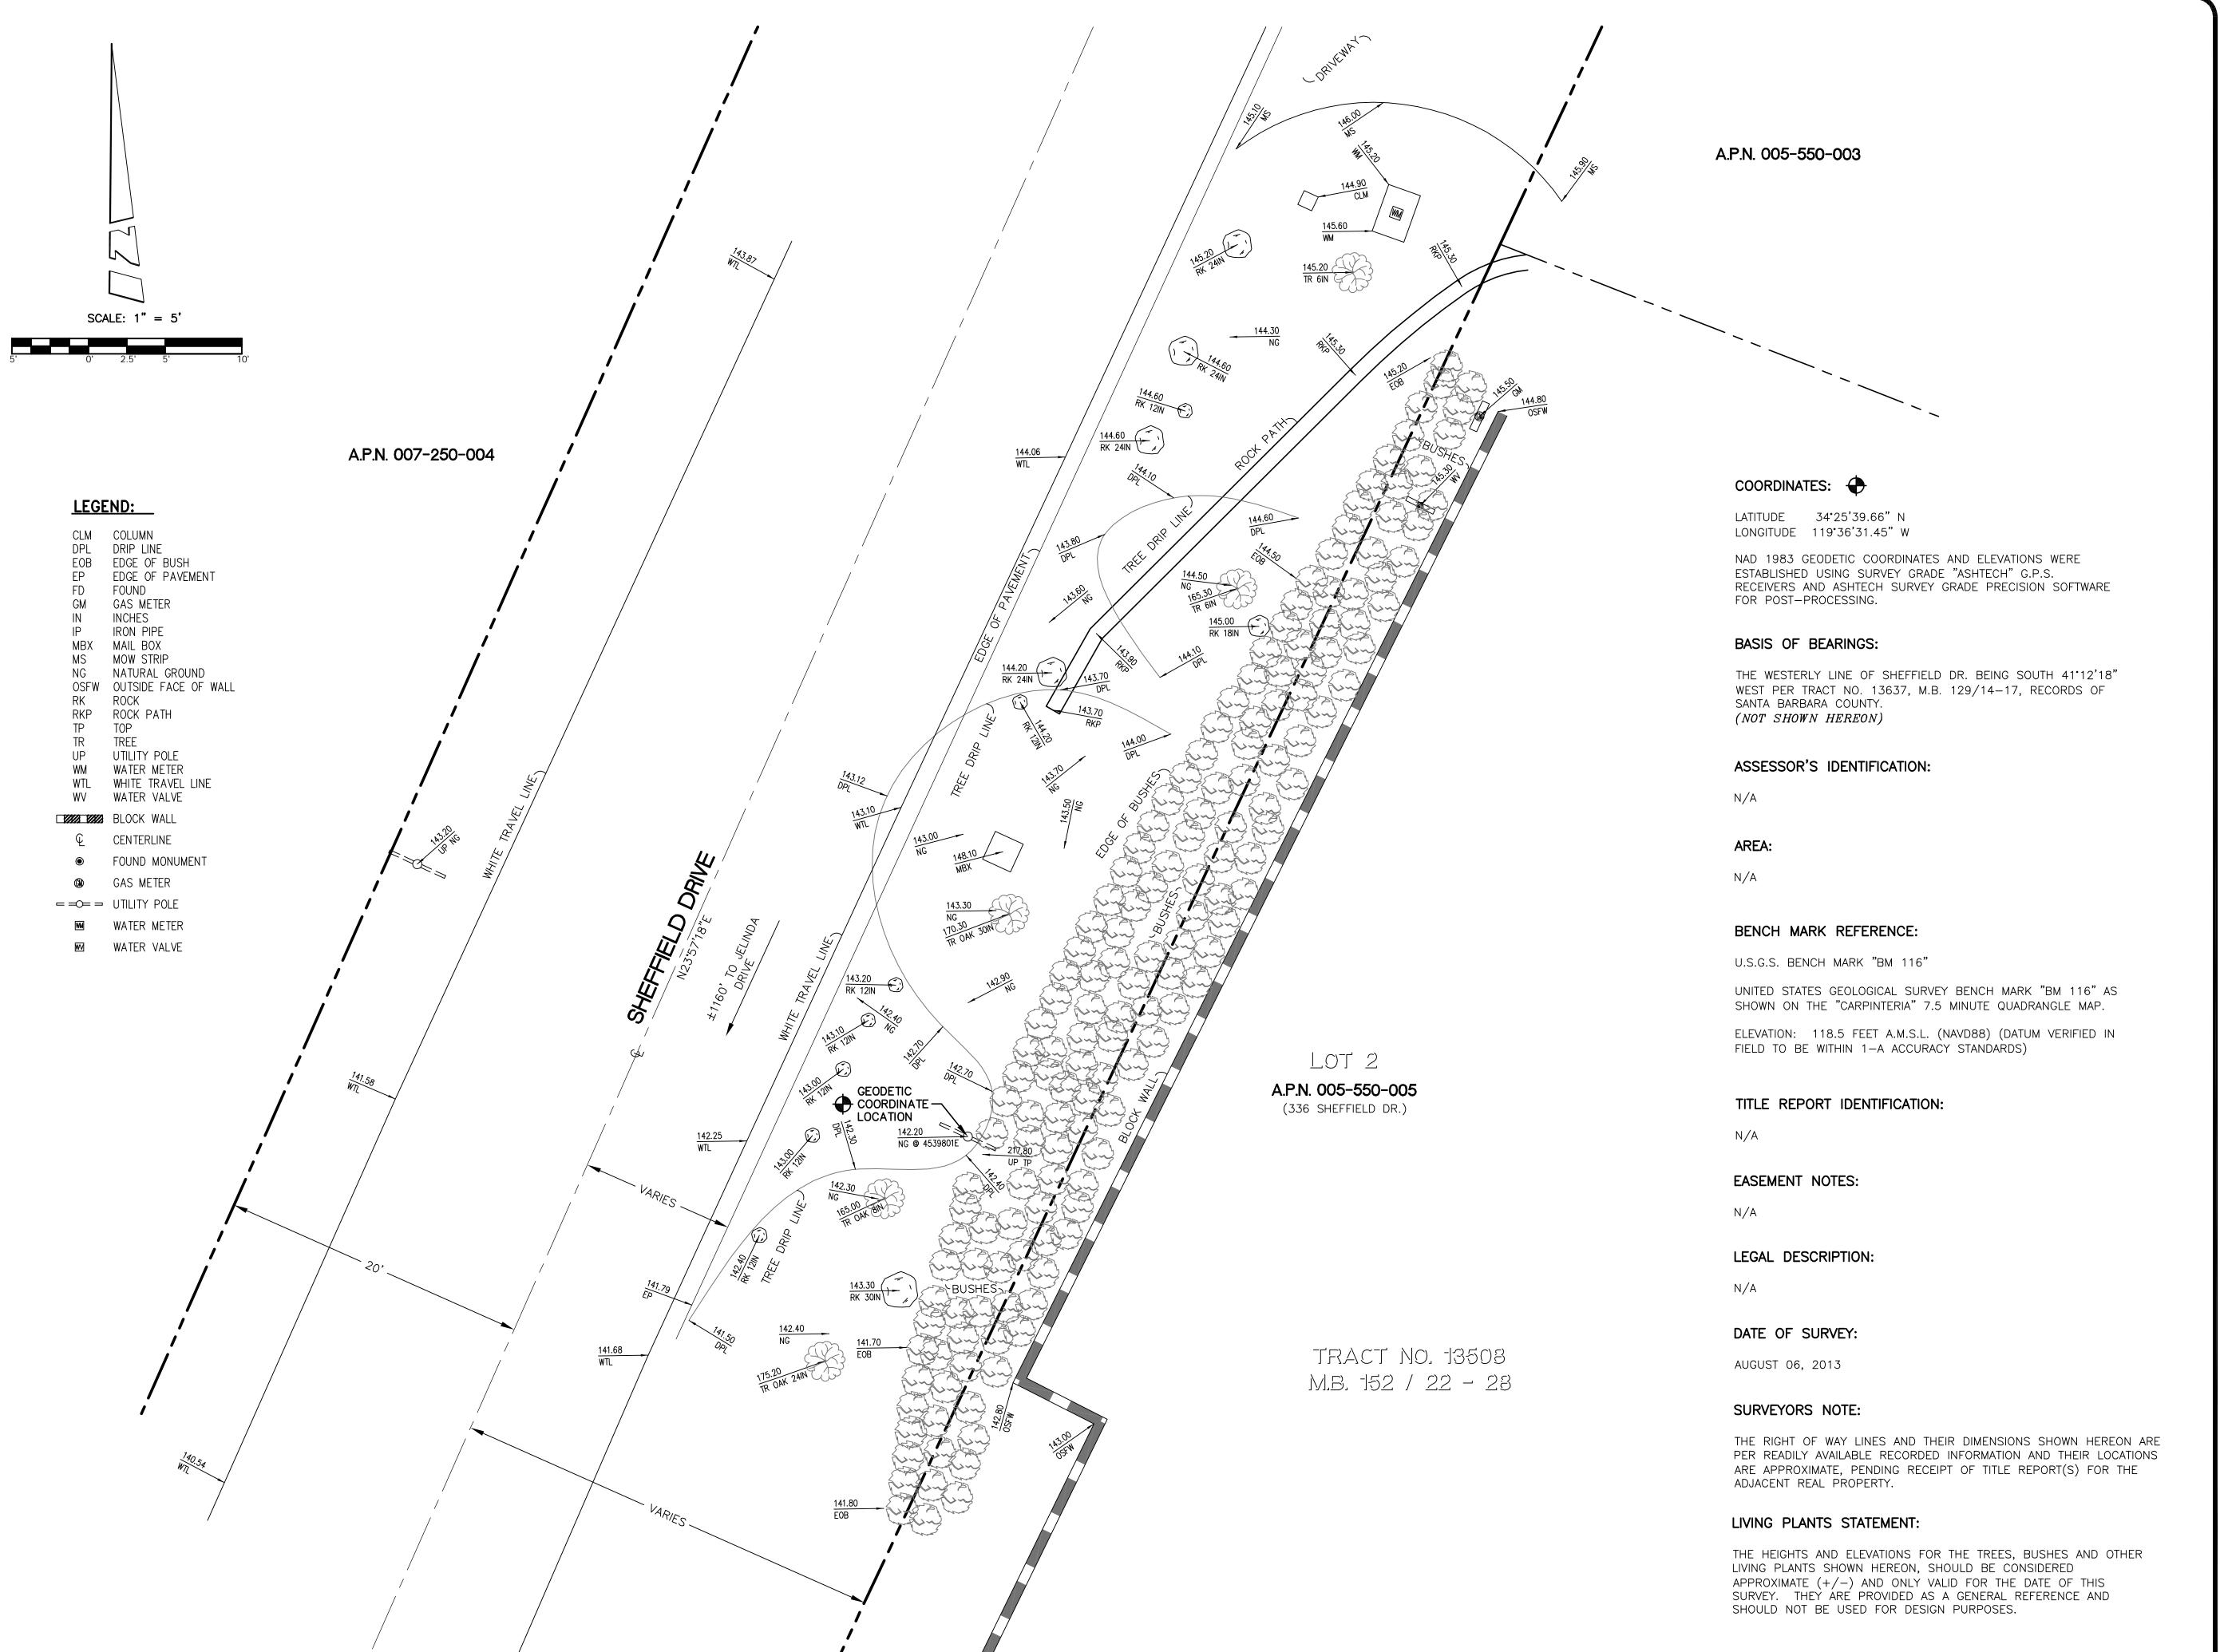

(949) 753-8807 OFFICE - (949) 753-8833 FAX

SITE BUILDER:

26455 RANCHO PKWY. SOUTH LAKE FOREST, CA 92630-8326



SURVEYOR:

BERT HAZE

AND ASSOCIATES, INC.

LAND SURVEYING & MAPPING

3188 AIRWAY AVENUE, SUITE K1

COSTA MESA, CALIFORNIA 92626

714 557-1567 OFFICE

714 557-1568 FAX

JN. 706.223

STAMP:



SITE INFO:

SITE NAME:

MONO8 VERIZON MONTECITO-MONO8

SITE ADDRESS:

R.O.W. EAST SIDE OF SHEFFIELD DR. (ADJACENT TO 336 SHEFFIELD DR.) SANTA BARBARA, CA 93108

SHEET TITLE:


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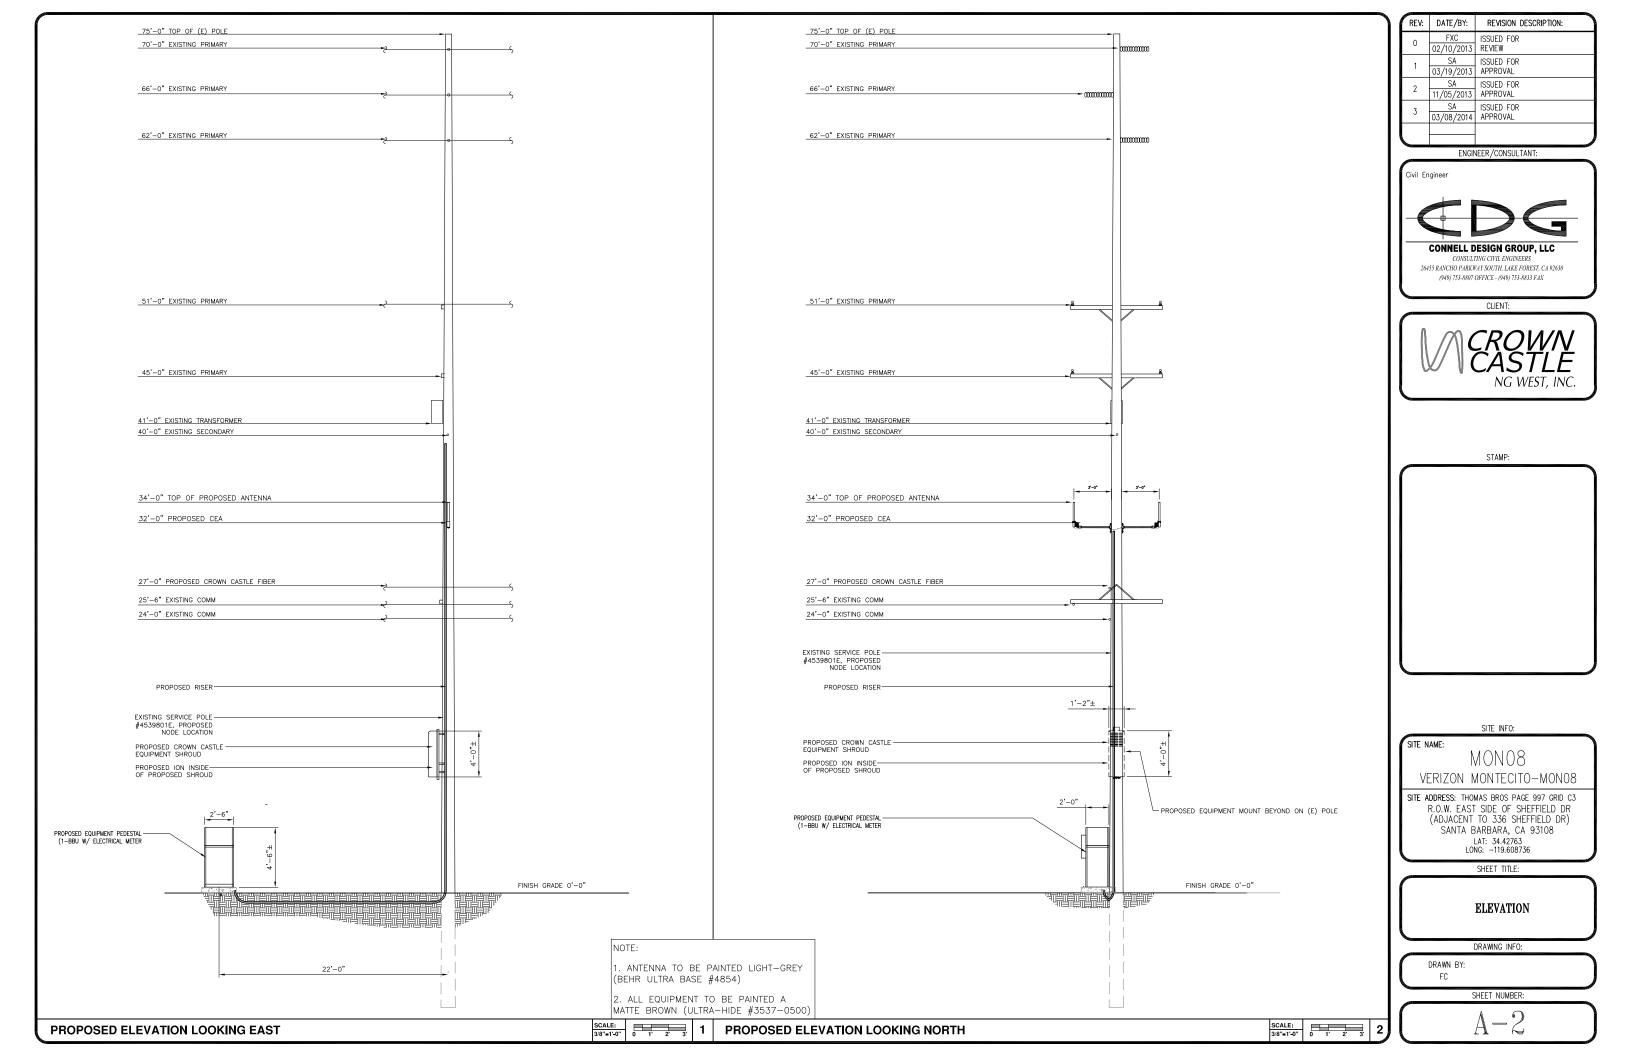
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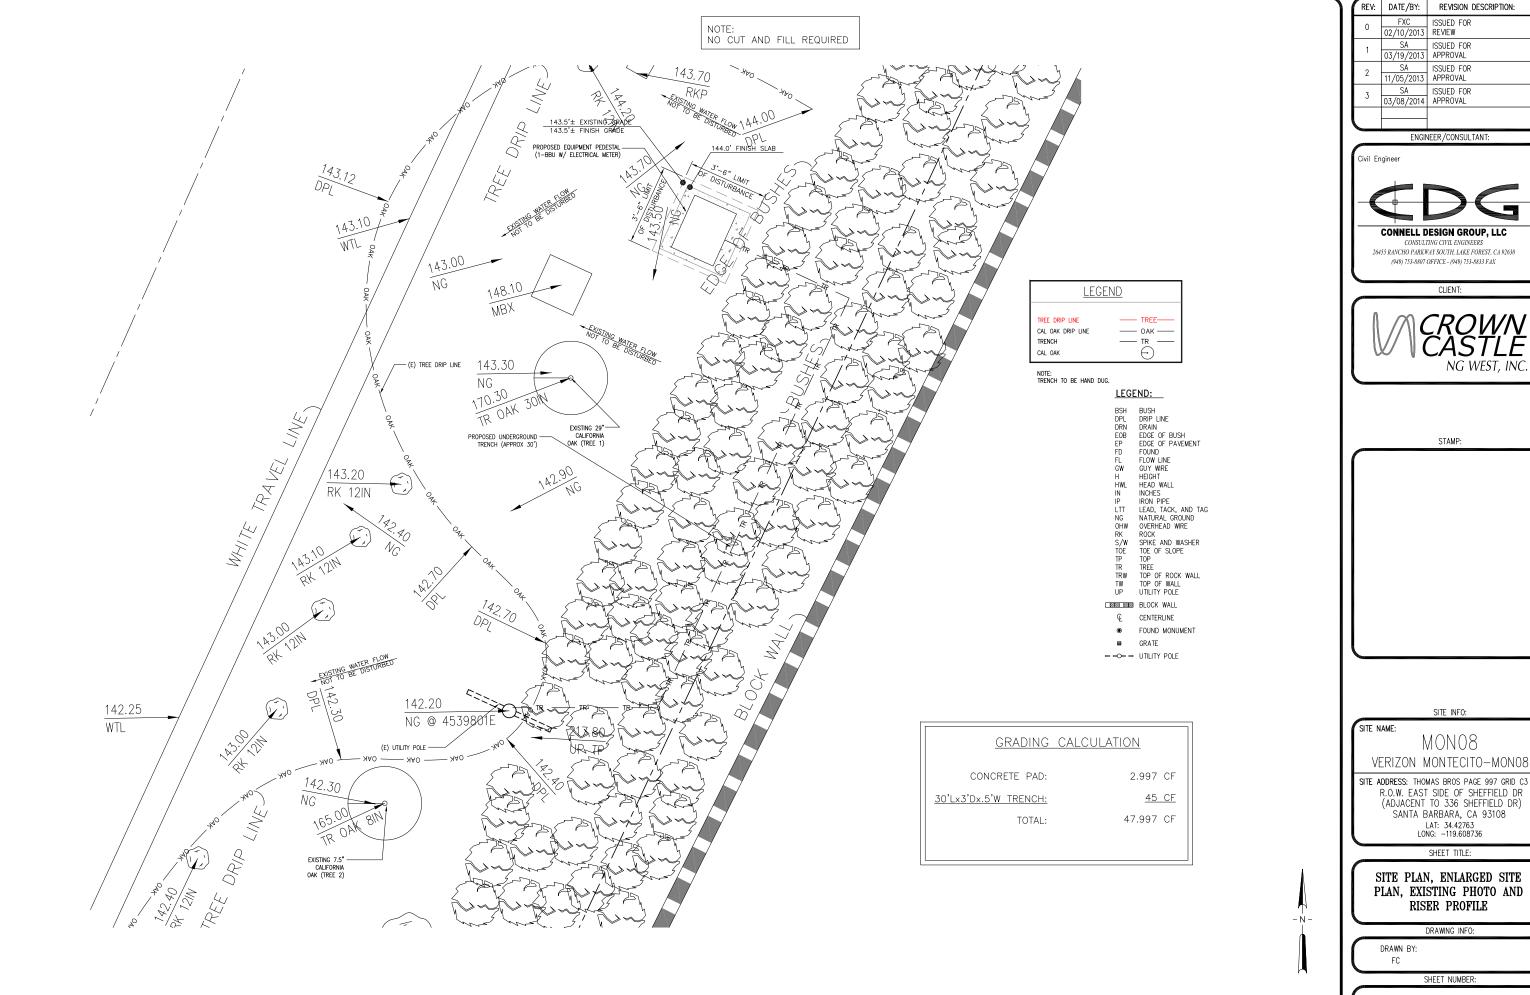
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DWG. NAME:	DRAWN BY:	DATE:

SHEET NUMBER:

OF 1





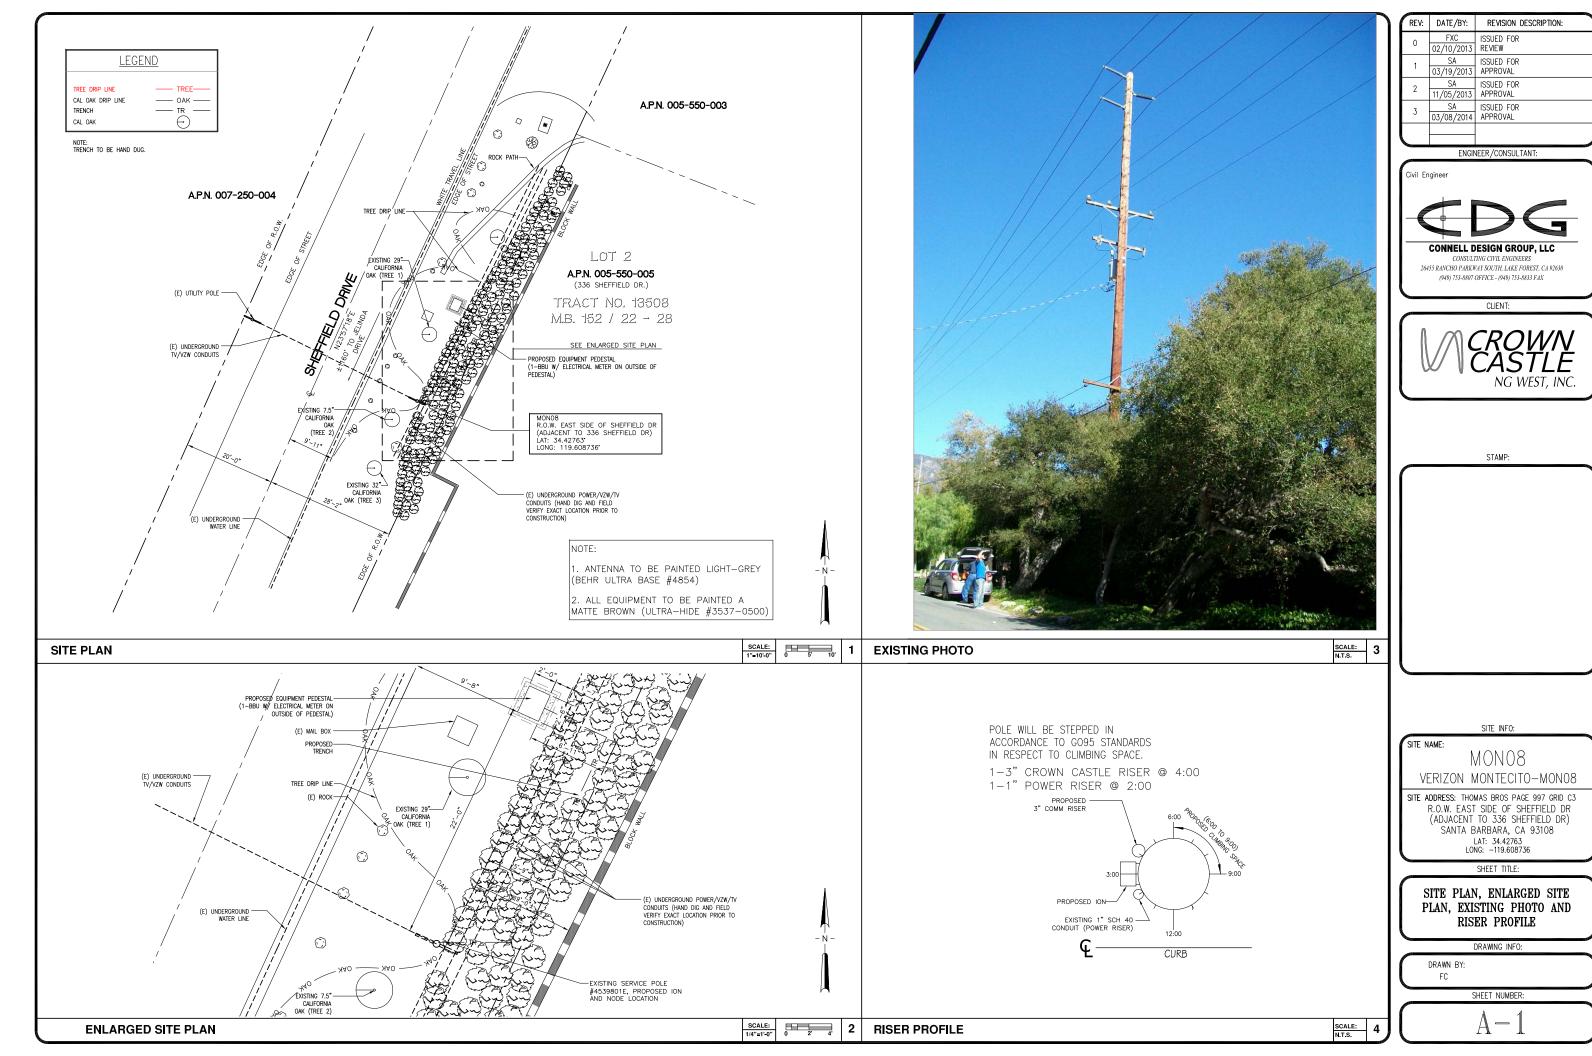

GRADING PLAN

1	1	REV:	DATE/BY:	REVISION DESCRIPTION:	_
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		1	SA 03/19/2013	ISSUED FOR APPROVAL	
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	Ш				

ENGINEER/CONSULTANT:



(949) 753-8807 OFFICE - (949) 753-8833 FAX CLIENT:



STAMP:

SITE INFO:

MON08

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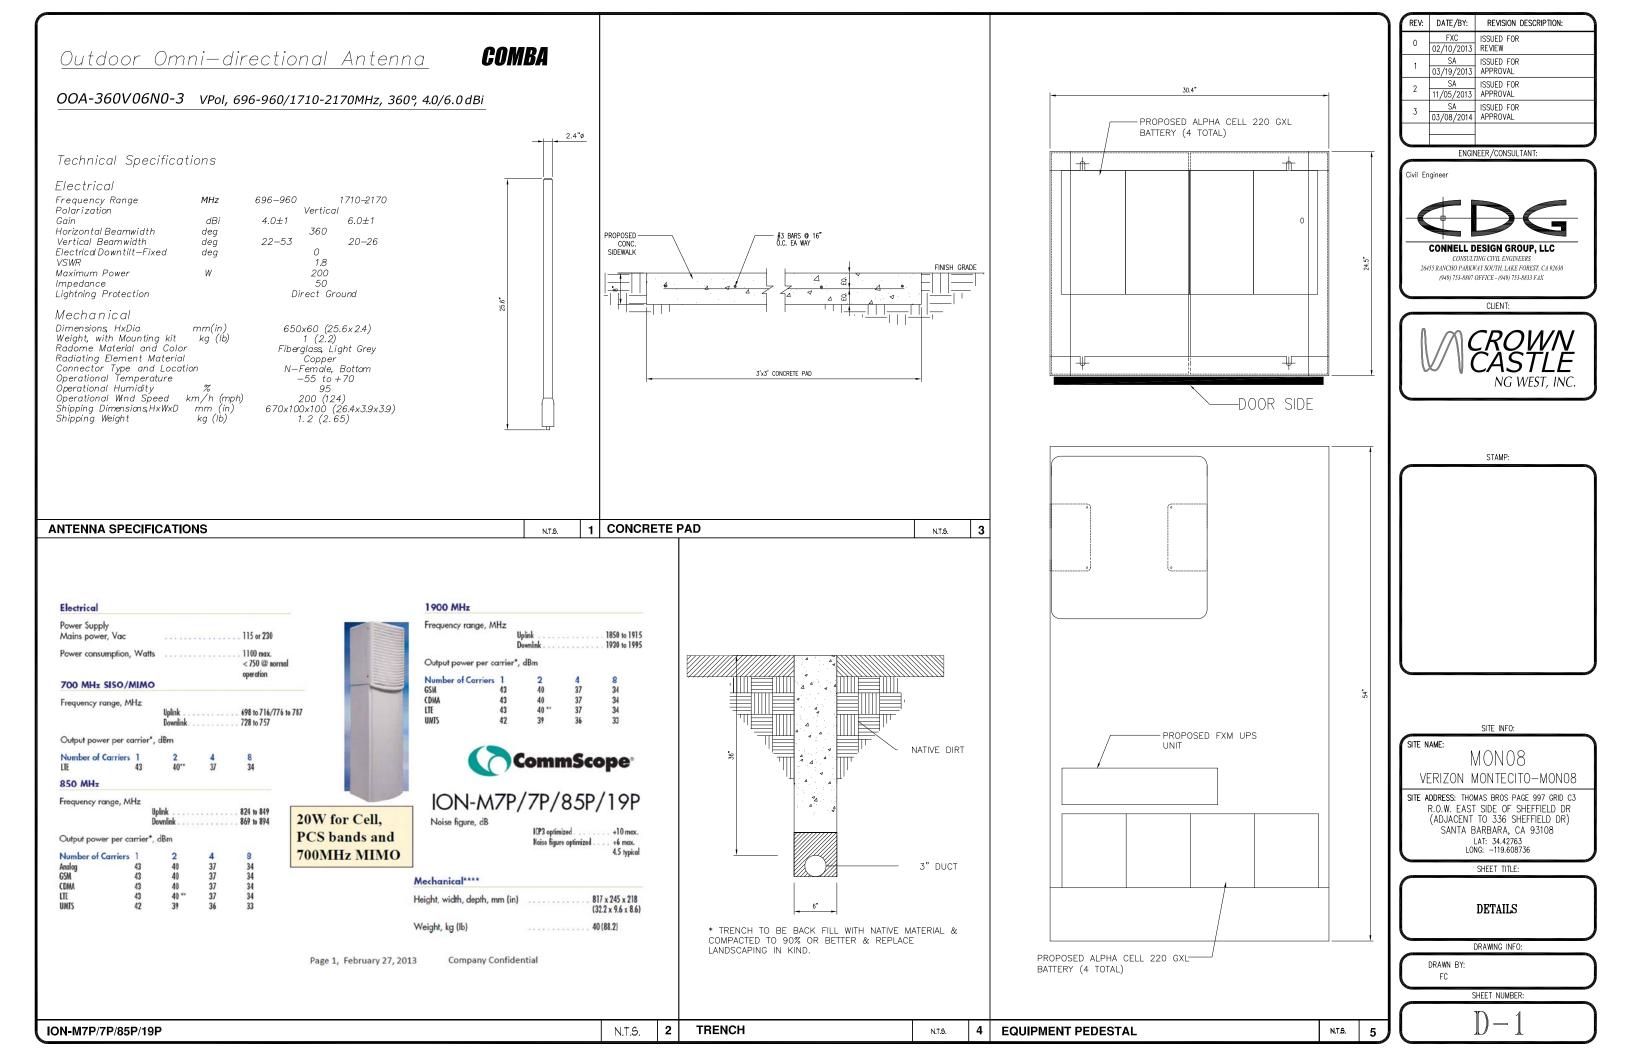
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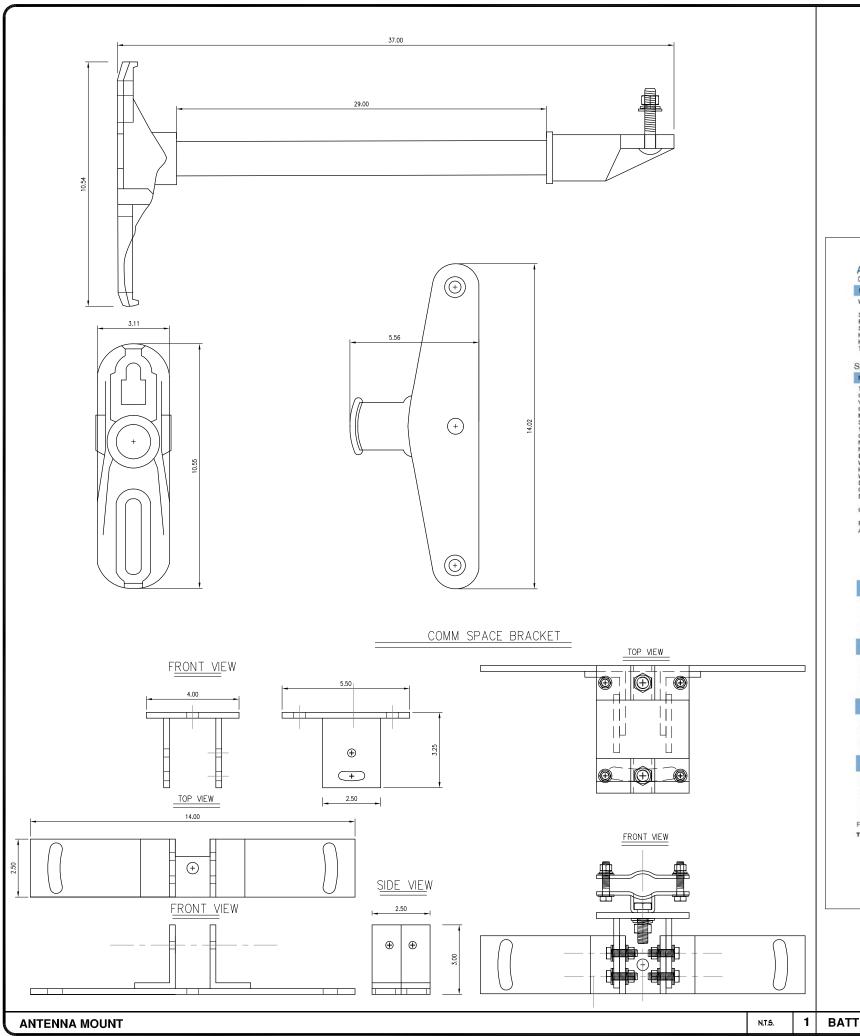
SITE PLAN, ENLARGED SITE PLAN, EXISTING PHOTO AND RISER PROFILE


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REV:	DATE/BY:	REVISION DESCRIPTION:
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Civil Engineer



26455 RANCHO PARKWAY SOUTH, LAKE FOREST, CA 92630 (949) 753-8807 OFFICE - (949) 753-8833 FAX CLIENT:



STAMP:
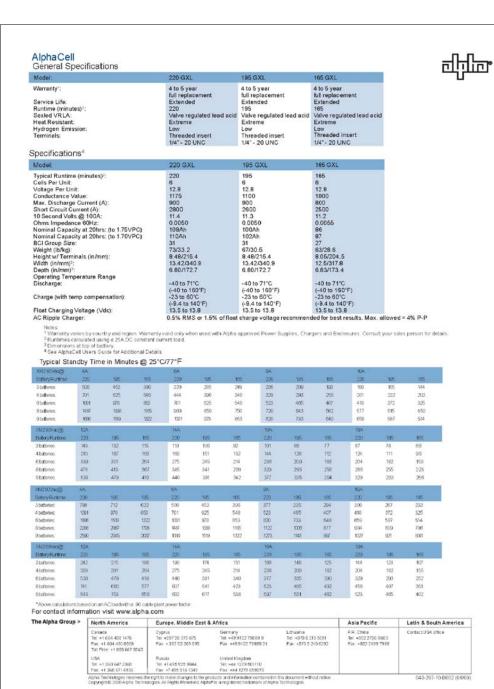
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SITE NAME:

MON08 VERIZON MONTECITO-MON08

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SHEET TITLE:

DETAILS


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BATTERY SPECIFICATIONS

N.T.S.



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Civil Engineer

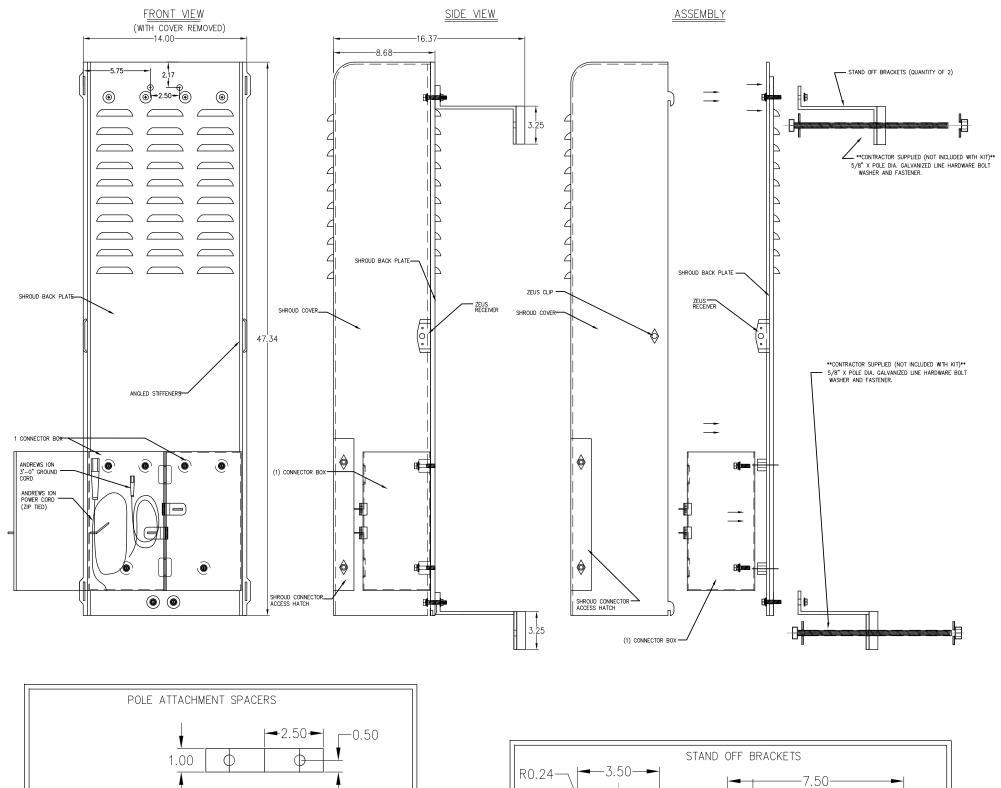

26455 RANCHO PARKWAY SOUTH, LAKE FOREST, CA 92630 (949) 753-8807 OFFICE - (949) 753-8833 FAX CLIENT:



STAMP:



SITE INFO:

SITE NAME:

MONO8 VERIZON MONTECITO-MONO8

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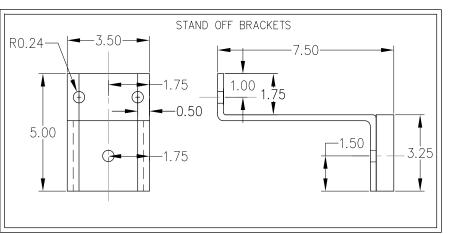
DETAILS

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SHEET NUMBER:

D-3



SHROUD DETAIL

0.91

N.T.S.

- . APPROVAL OF THESE PLANS BY THE CITY ENGINEER DOES NOT AUTHORIZE ANY WORK TO BE PERFORMED UNTIL A PERMIT HAS
- 2. UPON ISSUANCE OF A PERMIT, NO WORK WILL BE PERMITTED ON WEEKENDS OR HOLIDAYS WITHOUT PERMISSION FROM THE
- 3, THE APPROVAL OF THIS PLAN OR ISSUANCE OF A PERMIT BY THE LOCAL JURISDICTION DOES NOT AUTHORIZE THE SUBDIVIDER AND OWNER TO VIOLATE ANY FEDERAL. STATE OR CITY LAWS, ORDINANCES, REGULATIONS, OR POLICIES, INCLUDING, BUT NOT LIMITED TO, THE FEDERAL ENDANGERED SPECIES ACT OF 1973 AND AMENDMENTS THERETO (16 USC SECTION 1531 ET.SEQ.).
- 4. THE CONTRACTOR SHALL BE RESPONSIBLE FOR SURVEY MONUMENTS AND/OR VERTICAL CONTROL BENCHMARKS WHICH ARE DISTURBED OR DESTROYED BY CONSTRUCTION. A LAND SURVEYOR MUST FIELD LOCATE, REFERENCE, AND/OR PRESERVE ALL HISTORICAL OR CONTROLLING MONUMENTS PRIOR TO ANY EARTHWORK. IF DESTROYED, SUCH MONUMENTS SHALL BE REPLACED WITH APPROPRIATE MONUMENTS BY A LAND SURVEYOR, A CORNER RECORD OR RECORD OF SURVEY, AS APPROPRIATE, SHALL BE FIELD AS REQUIRED BY THE PROFESSIONAL LAND SURVEYORS ACT. IF ANY VERTICAL CONTROL IS TO BE DISTURBED OR DESTROYED, THE LOCAL JURISDICTION FIELD SURVEY SECTION MUST BE NOTIFIED, IN WRITING, AT LEAST 3 DAYS PRIOR TO THE CONSTRUCTION. THE CONTRACTOR WILL BE RESPONSIBLE FOR THE COST OF REPLACING ANY VERTICAL CONTROL BENCHMARKS
- 5. IMPORTANT NOTICE: SECTION 4216 OF THE GOVERNMENT CODE REQUIRES A DIG ALERT IDENTIFICATION NUMBER BE ISSUED BEFORE A "PERMIT TO EXCAVATE" WILL BE VALID. FOR YOUR DIG ALERT I.D. NUMBER, CALL UNDERGROUND SERVICE ALERT, TWO
- 6. CONTRACTOR SHALL BE RESPONSIBLE FOR THE POTHOLE AND LOCATING OF ALL EXISTING UTILITIES THAT CROSS THE PROPOSED TRENCH LINE AND MUST MAINTAIN 1' MINIMUM VERTICAL CLEARANCE.
- 7. CONTRACTOR SHALL SUBMIT TO THE LOCAL JURISDICTION, A CONSTRUCTION PLAN TO PROTECT WATER MAINS PRIOR TO
- 8. CONTRACTOR SHALL REPLACE OR REPAIR ALL TRAFFIC SIGNAL LOOPS, CONDUIT, AND LANE STRIPING DAMAGED DURING
- 9. CONTRACTOR SHALL NOTIFY THE LOCAL JURISDICTION. A MINIMUM OF 48 HOURS PRIOR TO COMMENCING WORK WITHIN 10' OF
- 10. THIS PROJECT WILL BE INSPECTED BY ENGINEERING AND CAPITAL PROJECTS DEPARTMENT, FIELD ENGINEERING DIVISION
- 11. AS-BUILT DRAWINGS MUST BE SUBMITTED TO THE CITY RESIDENT ENGINEER PRIOR TO THE ACCEPTANCE OF THIS PROJECT. 12. PUBLIC IMPROVEMENT SUBJECT TO DESUETUDE OR DAMAGE." IF REPAIR OR REPLACEMENT OF SUCH PUBLIC IMPROVEMENTS IS REQUIRED, THE OWNER SHALL OBTAIN THE REQUIRED PERMITS FOR WORK IN THE PUBLIC RIGHT-OFWAY, SATISFACTORY TO TH
- 13. PRIOR TO ANY DISTURBANCE TO THE SITE, EXCLUDING UTILITY MARKS-OUTS AND SURVEYING, THE CONTRACTOR SHALL MAKE ARRANGEMENTS FOR A PRE-CONSTRUCTION MEETING WITH THE LOCAL JURISDICTION FIELD ENGINEERING DIMSION.
- 14. PRIOR TO THE COMMENCEMENT OF ANY CONSTRUCTION SHOWN ON THESE PLANS. IT IS THE SOLE RESPONSIBILITY OF THE CONTRACTOR TO COORDINATE. THE CONTRACTOR IS RESPONSIBLE TO ATTEND THE LOCAL JURISDICTIONS MONTHLY UTILITY COORDINATION COMMITTEE THE CONSTRUCTION ACTIVITIES WITH THE CITY AND ALL OTHER CONTRACTORS SO THAT NO TRENCH IS CUT WITHIN ANY OF THE CITY STREETS THAT HAVE BEEN CONSTRUCTED, REPAIRED, OR SLURRY SEALED WITHIN THREE YEARS OF THE STREET CONSTRCTUION/RESURFACING DATE.
- 15. MANHOLES OR COVERS SHALL BE LABELED "CROWN CASTLE" OR "CROWN CASTLE NG WEST".
- 16. CONTRACTOR SHALL IMPLEMENT AN EROSION AND SEDIMENT CONTROL PROCRAM DURING THE PROJECT CONSTRUCTION ACTIVITIES PROGRAM SHALL MEET THE APPLICABLE REQUIREMENTS OF THE STATE WATER RESOURCE CONTROL BOARD
- 17. THE CONTRACTOR SHALL HAVE EMERGENCY MATERIALS AND EQUIPMENT ON HAND FOR UNFORESEEN SITUATIONS, SUCH AS DAMAGE TO UNDERGROUND WATER, SEWER, AND STORM DRAIN FACILITIES WHEREBY FLOWS MAY GENERATE EROSION AND SEDIMENT

SPECIAL NOTES

THE FOLLOWING NOTES ARE PROVIDED TO GIVE DIRECTIONS TO THE CONTRACTOR BY THE ENGINEER OF WORK. THE CITY ENGINEER'S SIGNATURE ON THESE PLANS DOES NOT CONSTITUTE APPROVAL OF THESE NOTES AND THE CITY WILL NOT BE RESPONSIBLE FOR THEIR ENFORCEMENT.

- THE CONTRACTOR SHALL VERIFY THE LOCATION EXISTING UNDERGROUND UTILITIES INCLUDING SEWER LATERALS AND WATER
 SERVICES TO INDIVIDUAL LOTS BOTH VERTICAL AND HORIZONTAL PRIOR TO COMMENCING IMPROVEMENT OPERATIONS.
- 2. CONTRACTOR SHALL MAKE EXPLORATION EXCAVATIONS AND LOCATE EXISTING FACILITIES SUFFICIENTLY AHEAD OF CONSTRUCTION TO PERMIT REVISIONS OF PLANS IF REVISION IS NECESSARY BECAUSE OF LOCATION OF EXISTING UTILITIES.
- 3. LOCATION AND ELEVATIONS OF IMPROVEMENTS, TO BE MET BY WORK, SHALL BE CONFIRMED BY FIELD MEASUREMENT PRIOR TO
- 4. GRADES SHOWN ARE FINISH GRADES, CONTRACTOR SHALL DETERMINE NECESSARY SUB GRADE ELEVATIONS AND SHALL CONSTRUCT
- 5. CONTRACTOR AGREES THAT HE SHALL ASSUME SOLE RESPONSIBILITY FOR JOB SITE CONDITION DURING THE COURSE OF CONSTRUCTION OF THIS PROJECT, INCLUDING SAFETY OF ALL PERSONS AND PROPERTY: THAT THIS PROVISION SHALL APPLY CONTINUOUSLY AND NOT BE LIMITED TO NORMAL WORKING HOURS; AND THAT THE CONTRACTOR SHALL DEFEND, INDEMNIFY AND HOLD THE OWNER AND THE ENGINEER HARMLESS FROM ANY AND ALL LIABILITY. REAL OR ALLEGED IN CONNECTION WITH THI PERFORMANCE OF WORK ON THIS PROJECT, EXPECTING FOR LIABILITY ARISING FROM SOLE NEGLIGENCE OF THE OWNER OR THE
- 6. THE CONTRACTOR SHALL BE TOTALLY RESPONSIBLE FOR COMPLIANCE WITH THE PROVISIONS OF THE STATE OF CALIFORNIA SAFETY
- 7. THE LOCATIONS OF ALL EXISTING UTILITIES SHOWN ON THESE PLANS ARE FROM EXISTING RECORDS AND CORROBORATED, WHERE POSSIBLE WITH FIELD TIES. THE CONTRACTOR IS RESPONSIBLE FOR CONFIRMING THE LOCATIONS SHOWN, BOTH HORIZONTALLY AND VERTICALLY, PRIOR TO CONSTRUCTION. IF EXISTING LOCATIONS VARY SUBSTANTIALLY FROM THE PLANS, THE ENGINEER SHOULD BE NOTIFIED TO MAKE ANY CONSTRUCTION CHANGES REQUIRED.
- 8. THE CONTRACTOR SHALL PROVIDE TEMPORARY SUPPORT FOR ALL SEWER AND WATER MAIN UNDER CROSSING IN ACCORDANCE WITH PART 1 SECTION 5-2 OF THE STANDARD SPECIFICATION.
- 9. THE CONTRACTOR SHALL REPLACE OR REPAIR ALL TRAFFIC SIGNAL LOOPS, CONDUITS, AND LANE STRIPING DAMAGED DURING
- 10. THE CONTRACTOR SHALL SUBMIT WORK PLANS FOR ALL BORE OPERATIONS TWO WEEKS PRIOR TO COMMENCING WORK.
- 11. CONTRACTOR SHALL BE RESPONSIBLE FOR THE POTHOLE AND LOCATING OF ALL EXISTING UTILITIES THAT CROSS THE PROPOSED
- 12. AS-BUILT DRAWINGS MUST BE SUBMITTED TO THE CITY ENGINEER PRIOR TO ACCEPTANCE OF THIS PROJECT



APPLICABLE CODES

GROUND BUS BAR

CADWELD

EXISTING SERVE SIDEWALK FLA

ELECTRIC BOX

TELEPHONE BOX

SIDEWALK FLAG

EXISTING SERVICE POLE

MECH. GRND. CONN

JAMESON LN

ALL WORK SHALL COMPLY WITH THE FOLLOWING APPLICABLE CODES:

IN THE EVENT OF CONFLICT, THE MOST RESTRICTIVE CODE SHALL PREVAIL

PROJECT DESCRIPTION

VICINITY MAP - N.T.S.

ELEVATION REF.

 $\frac{1}{X-X}$ SECTION REF.

-- — PROP./LEASE LINE

MATCH LINE

— WORK POINT

— T — TELE, CONDUIT

— — CENTERLINE

SYMBOLS, LINETYPES AND HATCH PATTERNS

--- ELECT. CONDUIT

MYERS PEDESTAL

VAULT STANDARD 2'X3'

STEEL POLE

PROJECT CONSISTS OF INSTALLATION OF: 1. (2) OMNI ANTENNAS ON EXISTING UTILITY POLE

2. EQUIPMENT SHROUD ON EXISTING POLE

CROWN CASTLE NG WEST, INC

VERIZON MONTECITO-MON09

R.O.W. NORTH SIDE OF JAMESON LN.

(ADJACENT TO 1790 N JAMESON LN)

SANTA BARBARA, CA 93108

SITE: VERIZON MONTECITO-MON09

POLE# 4438030E

US 101

☆ LIGHT POLE

O FOUNDATION

▲ SET POINT

(x) DETAIL REF.

 \triangle

SPOT ELEV.

3. EQUIPMENT PEDESTAL W/ BBU AND ELECTRICAL METER AT BASE OF

SHEET INDEX T-1 - SHEET 1 OF 7 A-1 - SHEET 2 OF 7 SITE PLAN EXISTING FLEVATIONS A-2 - SHFFT 3 OF 7 A-3 - SHEET 4 OF GRADING PLAN DETAILS D-1 - SHEET 5 OF 7 DETAILS. D-2 - SHEET 6 OF 7 DETAILS D-3 - SHEET 7 OF 7

EROSION AND SEDIMENT CONTROL NOTES

TEMPORARY EROSION/SEDIMENT CONTROL, PRIOR TO COMPLETION OF FINAL IMPROVEMENTS. SHALL BE PERFORMED BY THE CONTRACTOR OR QUALIFIED PERSON AS INDICATED BELOW:

- 1. ALL REQUIREMENTS OF THE LOCAL JURISDICTION "LAND DEVELOPMENT MANUAL, STORM WATER STANDARDS" MUST BE INCORPORATED INTO THE DESIGN AND CONSTRUCTION OF THE PROPOSED GRADING/IMPROVEMENTS CONSISTENT WITH THE APPROVED STORM WATER AND/OR WATER POLLUTION CONTROL PLAN (WPCP).
- 2. FOR STORM DRAIN INLETS, PROVIDE A GRAVEL BAG SILT BASIN IMMEDIATELY UPSTREAM OF INLET AS INDICATED ON DETAILS.
- 3. FOR INLETS LOCATED AT SUMPS ADJACENT TO TOP OF SLOPES, THE CONTRACTOR SHALL ENSURE THAT WATER DRAINING TO THE SUMP IS DIRECTED INTO THE INLET AND THAT A MINIMUM OF 1.00" FREEBOARD EXISTS AND IS MAINTAINED ABOVE THE TOP OF THE INLET. IF FREEBOARD IS NOT PROVIDED BY GRADING SHOWN ON THESE PLANS, THE CONTRACTOR SHALL PROVIDE IT VIA TEMPORARY MEASURES, I.E. GRAVEL BAGS OR DIKES.
- 4. THE CONTRACTOR OR QUALIFIED PERSON SHALL BE RESPONSIBLE FOR CLEANUP OF SILT AND MUD ON ADJACENT STREET(S) AND STORM DRAIN SYSTEM DUE TO CONSTRUCTION
- 5. THE CONTRACTOR OR QUALIFIED PERSON SHALL CHECK AND MAINTAIN ALL LINED AND UNLINED DITCHES AFTER EACH RAINFALL.
- 6. THE CONTRACTOR SHALL REMOVE SILT AND DEBRIS AFTER EACH MAJOR RAINFALL.
- EQUIPMENT AND WORKERS FOR EMERGENCY WORK SHALL BE MADE AVAILABLE AT ALL TIMES DURING THE RAINY SEASON, ALL NECESSARY MATERIALS SHALL BE STOCKPILED ON SITE AT CONVENIENT LOCATIONS TO FACILITATE RAPID CONSTRUCTION OF TEMPORARY DEVICES WHEN RAIN IS IMMINENT.
- 8. THE CONTRACTOR SHALL RESTORE ALL EROSION/SEDIMENT CONTROL MEASURES TO WORKING ORDER TO THE SATISFACTION OF THE CITY ENGINEER OR RESIDENT ENGINEER AFTER EACH RUN-OFF PRODUCING RAINFALL
- THE CONTRACTOR SHALL INSTALL ADDITIONAL EROSION CONTROL MEASURES AS MAY BE REQUIRED BY THE RESIDENT ENGINEER DUE TO UNCOMPLETED GRADING OPERATIONS OR UNFORESEEN CIRCUMSTANCES, WHICH MAY ARISE.
- 10. THE CONTRACTOR SHALL BE RESPONSIBLE AND SHALL TAKE NECESSARY PRECAUTIONS TO PREVENT PUBLIC TRESPASS ONTO AREAS WHERE IMPOUNDED WATERS CREATE A HAZARDOUS CONDITION.
- 11. ALL EROSION/SEDIMENT CONTROL MEASURES PROVIDED PER THE APPROVED GRADING PLAN SHALL BE INCORPORATED HEREON. ALL EROSION/SEDIMENT CONTROL FOR INTERIM CONDITIONS SHALL BE DONE TO THE SATISFACTION OF THE RESIDENT ENGINEER. 12 CRADED AREAS AROUND THE PROJECT PERIMETER MUST DRAIN AWAY FROM THE FACE
- OF THE SLOPE AT THE CONCLUSION OF EACH WORKING DAY. 13. ALL REMOVABLE PROTECTIVE DEVICES SHOWN SHALL BE IN PLACE AT THE END OF EACH
- 14. THE CONTRACTOR SHALL ONLY GRADE, INCLUDING CLEARING AND GRUBBING FOR THE AREAS FOR WHICH THE CONTRACTOR OR QUALIFIED PERSON CAN PROVIDE FROSION/SEDIMENT CONTROL MEASURES.
- 15. THE CONTRACTOR SHALL ARRANGE FOR WEEKLY MEETINGS DURING OCTOBER 1ST TO APRIL 30TH FOR PROJECT TEAM (GENERAL CONTRACTOR, QUALIFIED PERSON, EROSION CONTROL SUBCONTRACTOR IF ANY, ENGINEER OF WORK, OWNER AND THE RESIDENT ENGINEER) TO EVALUATE THE ADEQUACY OF THE EROSION/SEDIMENT CONTROL MEASURES AND OTHER RELATED CONSTRUCTION ACTIVITIES.

TRAFFIC CONTROL NOTES

THE CONTRACTOR SHALL SUBMIT A TRAFFIC CONTROL PLAN (11" X 17") FOR APPROVAL PRIOR TO STARTING WORK. THE PLAN SHOULD BE SUBMITTED TO THE TRAFFIC CONTROL PERMIT COUNTER. CONTRACTOR SHALL OBTAIN A TRAFFIC CONTROL PERMIT A MINIMUM OF TWO (2) WORKING DAYS PRIOR TO STARTING WORK, AND A MINIMUM FIVE (5) DAYS IF WORK WILL AFFECT A BUS STOP OR AN EXISTING TRAFFIC SIGNAL, OR IF WORK WILL REQUIRE A

FOOTAGE TOTALS				
ASPHALT CUT	-			
DIRT TRENCH	-			
PUNCH THRU	-			
BORE	-			
TOTAL	=			
R&R SWF TOTAL	_			

PROJECT DICTIONARY

R.O.W. NORTH SIDE OF JAMESON LN. SITE ADDRESS: (ADJACENT TO 1790 N JAMESON LN) SANTA BARBARA, CA 93108

CROWN CASTLE NG WEST, INC 2125 WRIGHT AVE. SUITE #C9 APPLICANT: LA VERNE, CA 91750 CONTACT: HEIDI PAYNE

PHONE: (949) 300-9493 CIVIL ENGINEER:

CONNELL DESIGN GROUP, LLC 26455 RANCHO PARKWAY SOUTH LAKE FOREST, CA 92630 CONTACT: FRANK CARTER (949) 310-8233 PHONE (949) 753-8833 FAX

DATE /RY: REVISION DESCRIPTION: ISSUED FOR 03/15/2013 REVIEW FXC ISSUED FOR 11/05/2013 FINAL FXC ISSUED FOR 03/08/2014 FINAL

ENGINEER/CONSULTANT:



(949) 753-8807 OFFICE - (949) 753-8833 FAX

CLIENT:



STAMP:

SITE INFO:

MON09

VERIZON MONTECITO-MON09


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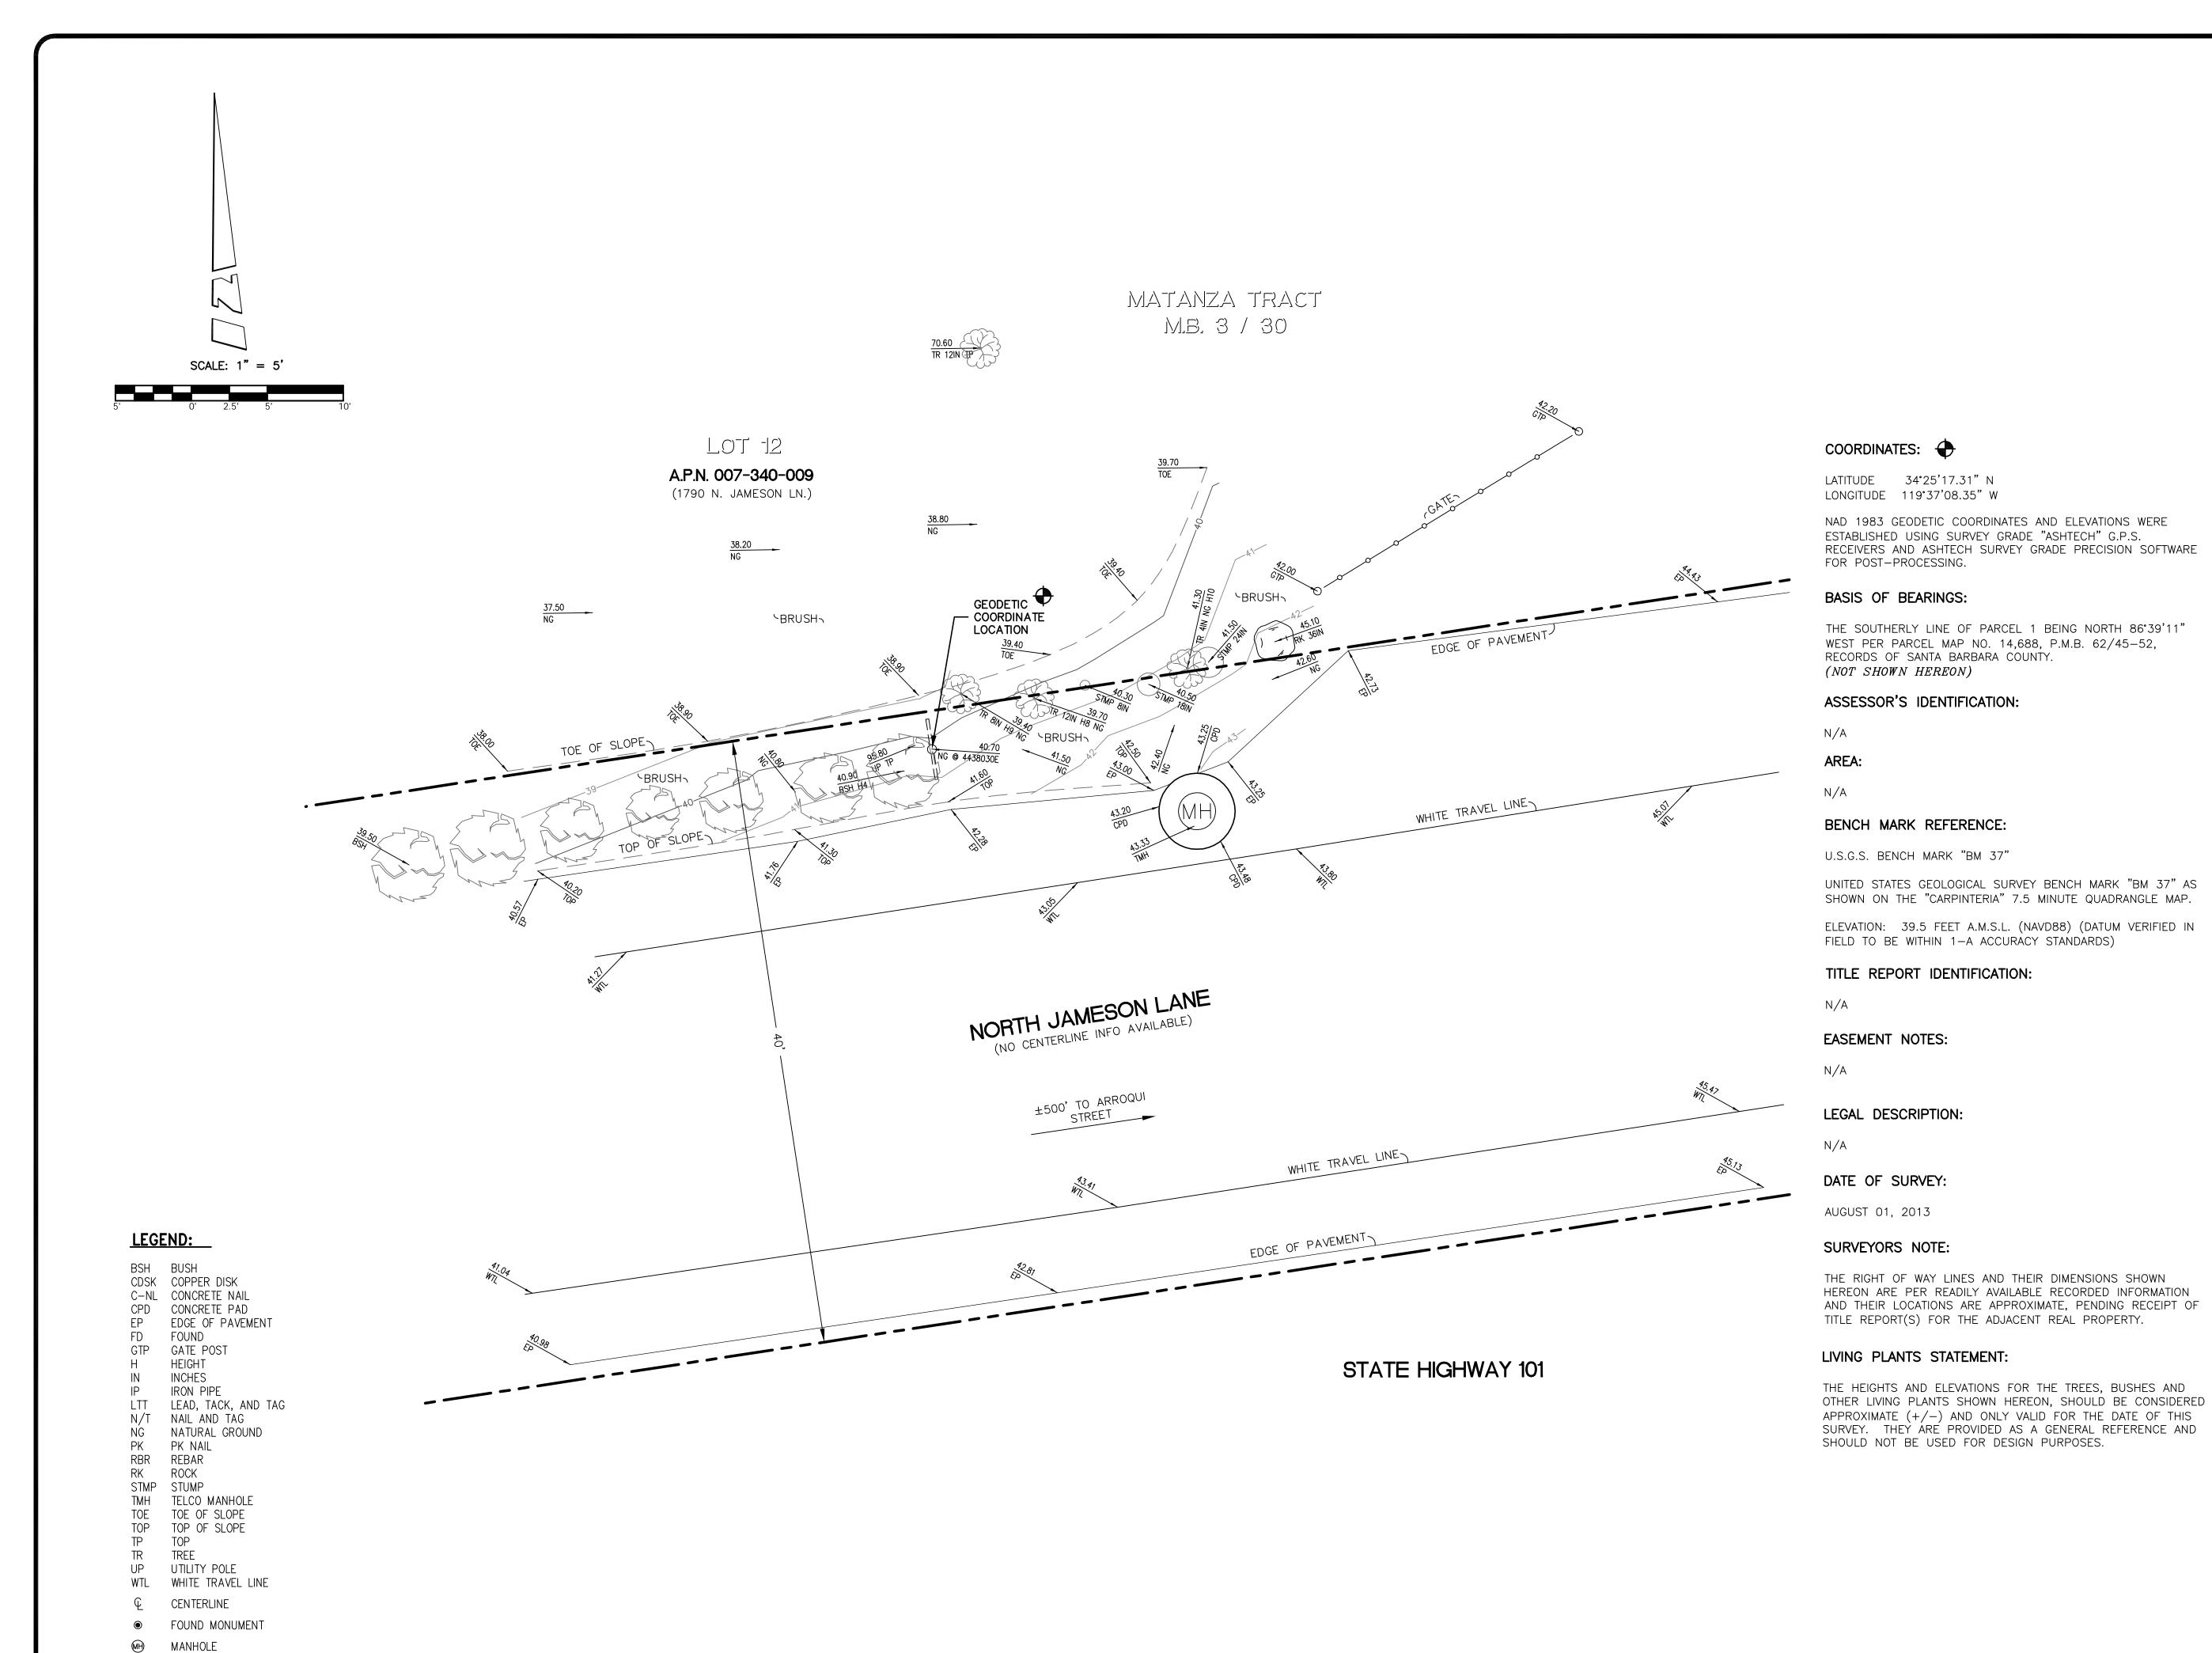
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TITLE SHEET


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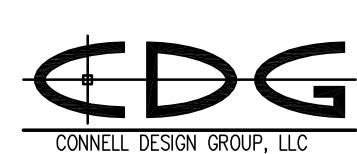
FC





==== UTILITY POLE

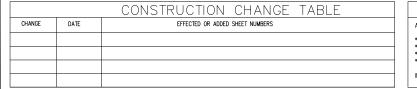

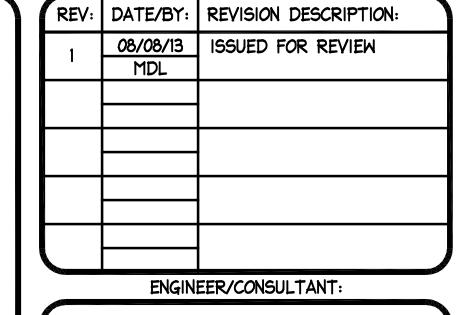

CONSULTING CIVIL ENGINEERS

26455 RANCHO PKWY. SOUTH

LAKE FOREST, CA 92630-8326

(949) 753-8807 OFFICE - (949) 753-8833 FAX

SITE BUILDER:



SURVEYOR:


BERT HAZE

AND ASSOCIATES, INC.

LAND SURVEYING & MAPPING
3188 AIRWAY AVENUE, SUITE K1
COSTA MESA, CALIFORNIA 92626
714 557-1567 OFFICE
714 557-1568 FAX

JN. 706.224

STAMP:

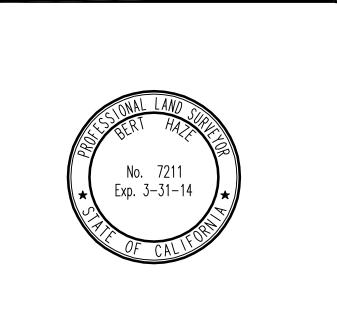

SITE INFO:

SITE NAME:

MONO9 VERIZON MONTECITO-MONO9

SITE ADDRESS:

R.O.W. NORTH SIDE OF N. JAMESON LN (ADJACENT TO 1790 N. JAMESON LN) SANTA BARBARA, CA 93108

SHEET TITLE:


TOPOGRAPHIC SURVEY


DRAWING INFO:

DWG. NAME: DRAWN BY: DATE:
MON09 MDL 08/08/13

SHEET NUMBER:

 $1 \quad \boxed{ } \boxed{ } \boxed{ }$

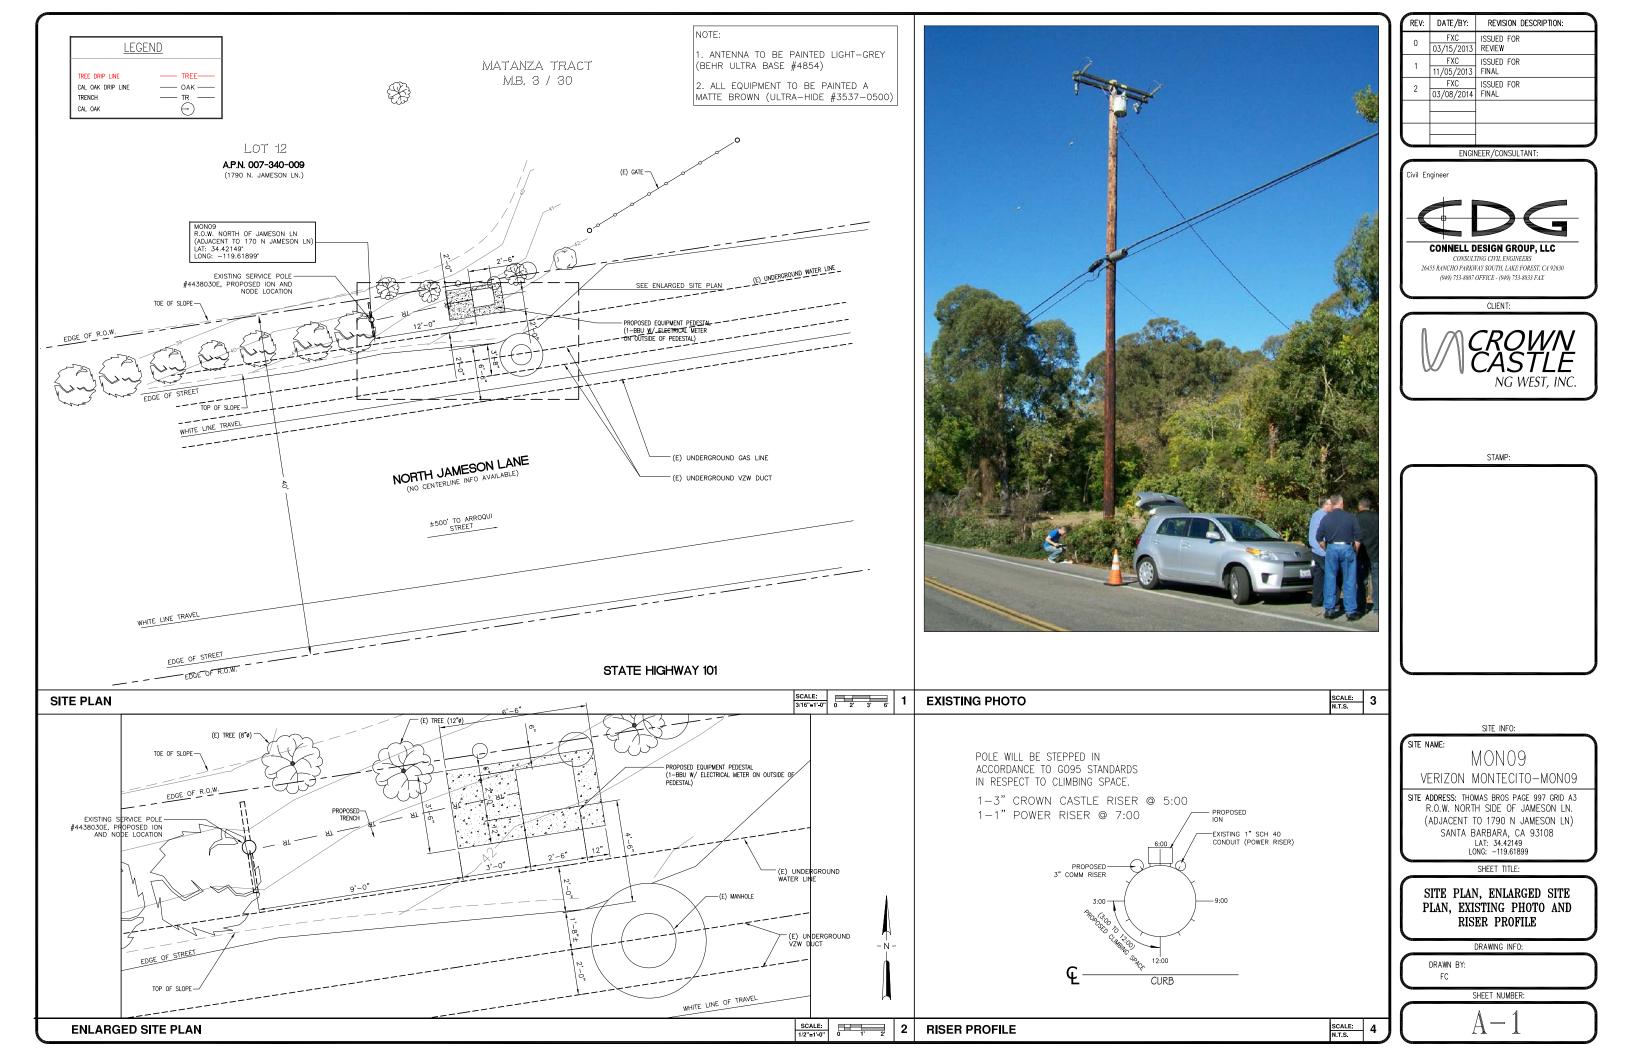

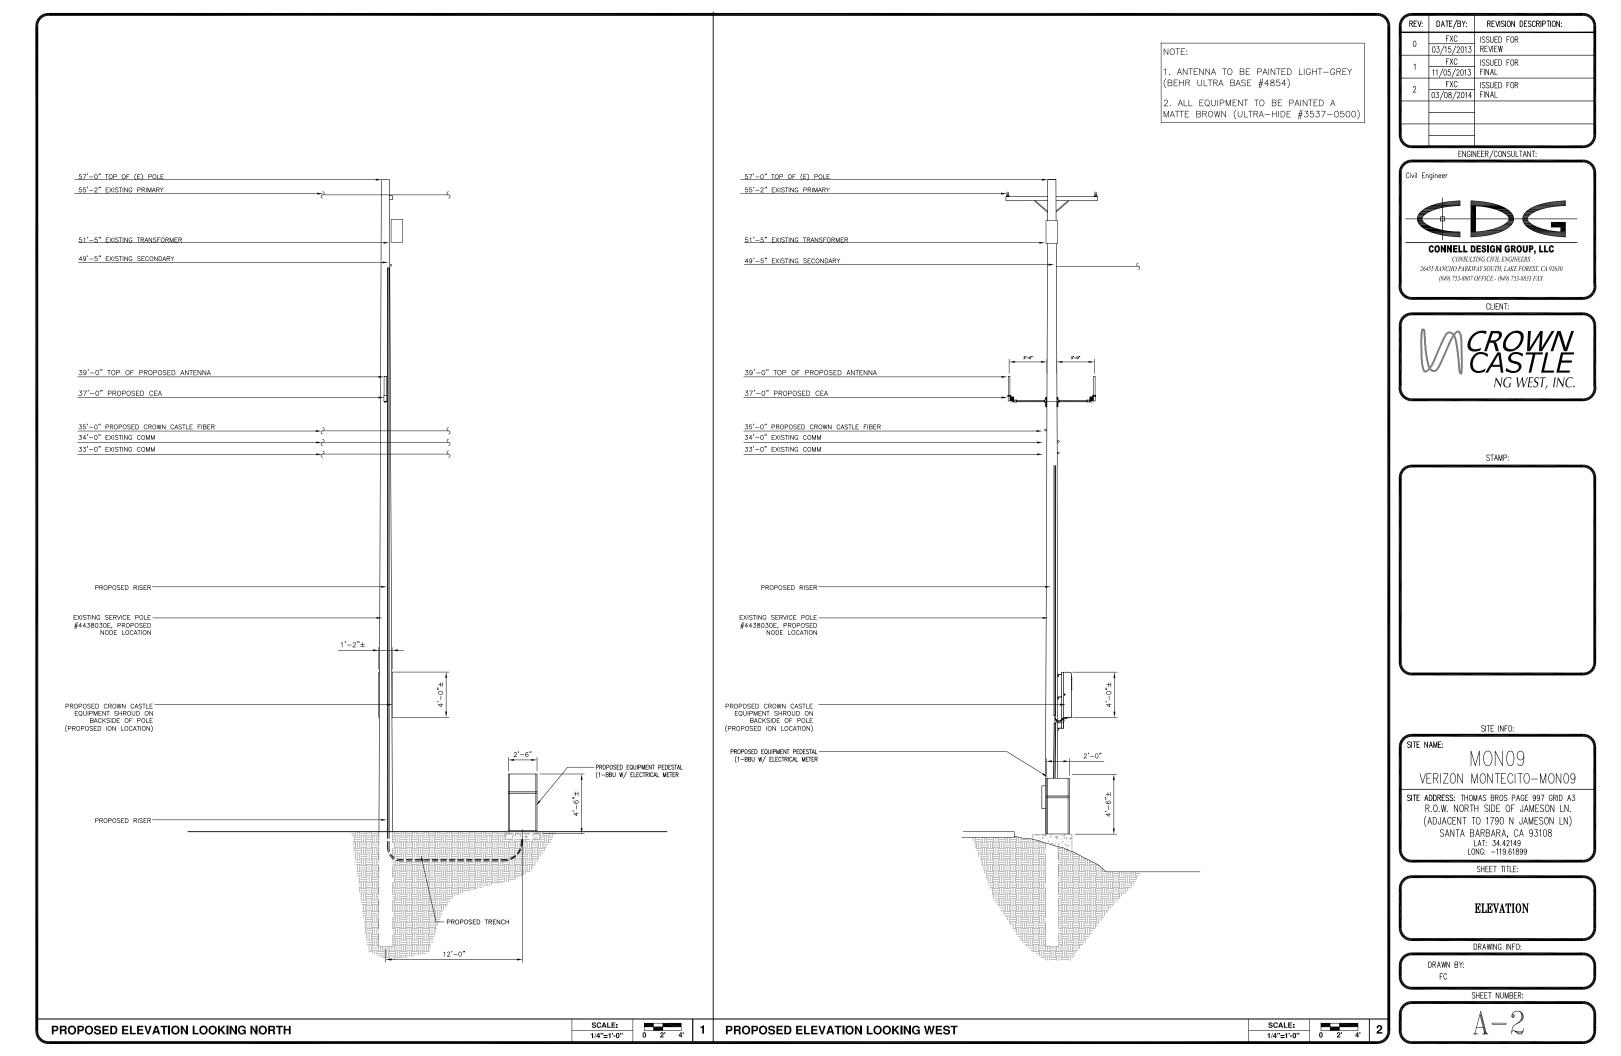

TREE DRIP LINE TREE—
CAL OAK DRIP LINE OAK—
TRENCH TR —
CAL OAK

| NOTE: | NO CUT AND FILL REQUIRED

GRADING CALCULATION

CONCRETE PAD:


2.997 CF

12'Lx3'Dx.5'W TRENCH:

<u>18 CF</u>

TOTAL:

20.997 CF

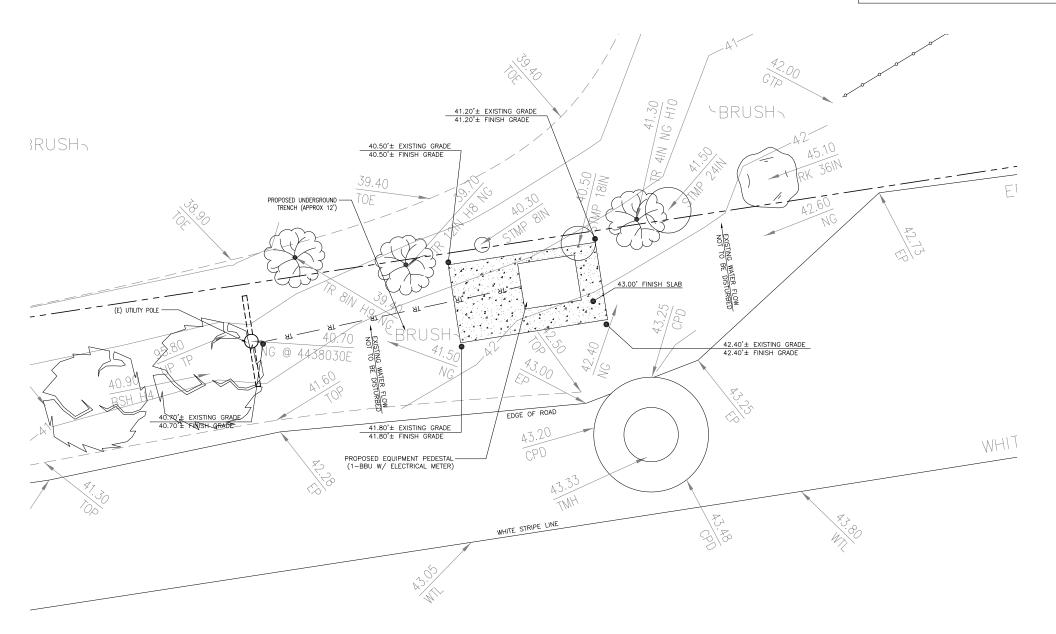

LEGEND:

BSH BUSH
DPL DRIP LINE
DRN DRAIN
EOB EOGE OF BUSH
EP EDGE OF PAVEMENT
FD FOUND
FL FLOW LINE
GW GUY WIRE
H HEIGHT
HWL HEAD WALL
IN INCHES
IP IRON PIPE
LTT LEAD, TACK, AND TAG
NG NATURAL GROUND
OHW OVERHEAD WIRE
RK ROCK
S/W SPIKE AND WASHER
TOE TOE OF SLOPE
TP TOP
TR TREE
TRW TOP OF ROCK WALL
TW TOP OF WALL
UP UTILITY POLE

□2222□2222 BLOCK WALL

© CENTERLINE

● FOUND MONUMENT

■ GRATE

==O== UTILITY POLE

SITE NAME:

REV: DATE/BY:

Civil Engineer

FXC ISSUED FOR 03/08/2014 FINAL

ENGINEER / CONSULTANT:

CONNELL DESIGN GROUP, LLC
CONSULTING CIVIL ENGINEERS
26455 RANCHO PARKWAY SOUTH, LAKE FOREST, CA 92630
(949) 753-8807 OFFICE - (949) 753-8833 FAX

CLIENT:

STAMP:

REVISION DESCRIPTION:

MON09

SITE INFO:

VERIZON MONTECITO—MONO9

SITE ADDRESS: THOMAS BROS PAGE 997 GRID A3
R.O.W. NORTH SIDE OF JAMESON LN.

R.O.W. NORTH SIDE OF JAMESON LN. (ADJACENT TO 1790 N JAMESON LN) SANTA BARBARA, CA 93108 LAT: 34.42149 LONG: -119.61899

SHEET TITLE:

GRADING PLAN

DRAWING INFO:

DRAWN BY: FC

SHEET NUMBER:


A-3

NORTH JAMESON LANE (NO CENTERLINE INFO AVAILABLE)



GRADING PLAN

SCALE: N.T.S.

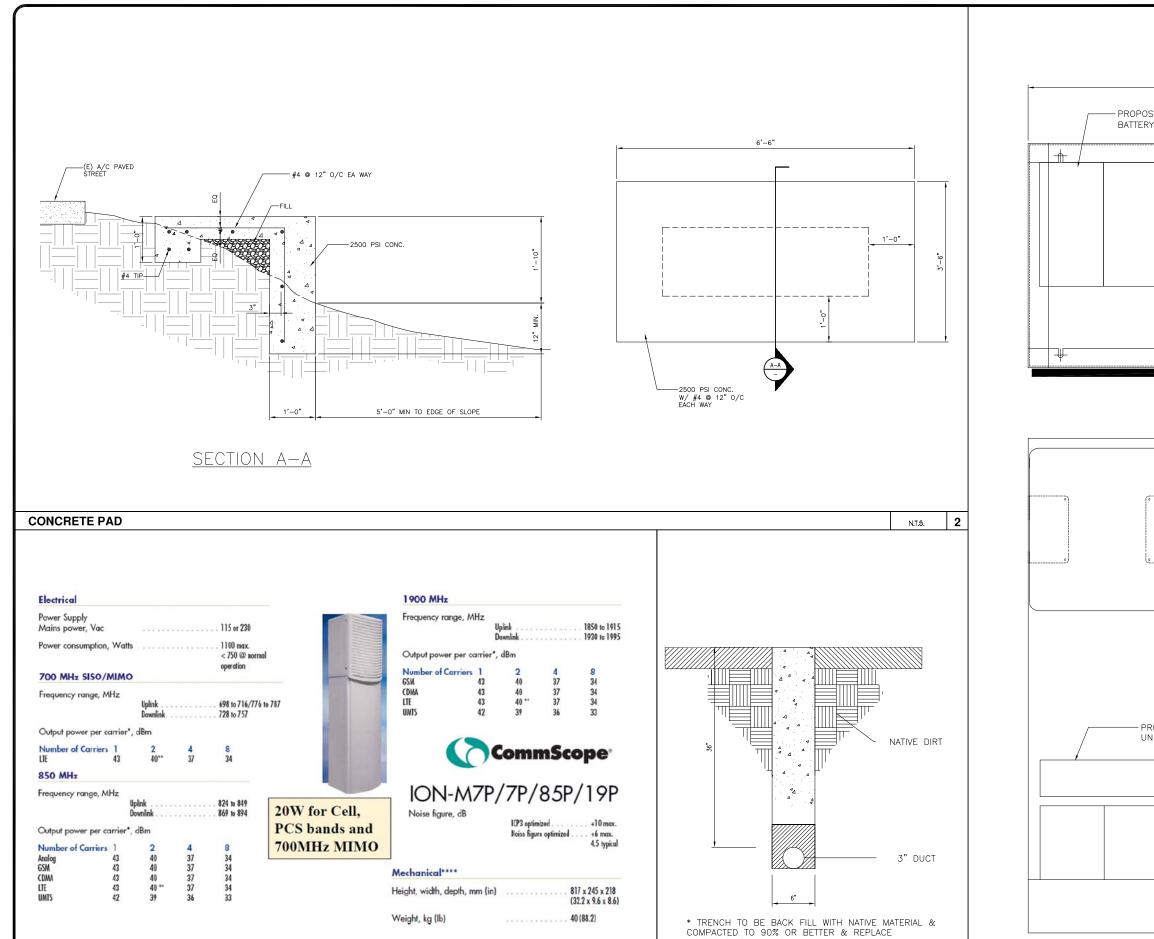


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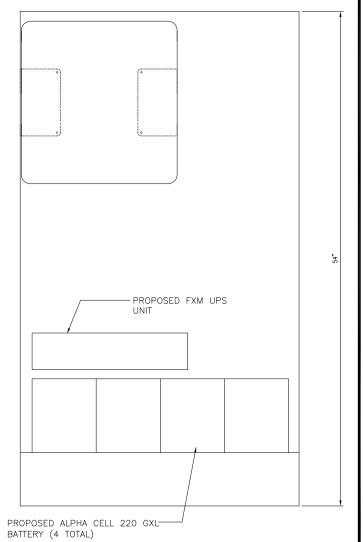
Page 1, February 27, 2013 Company Confidential

ION-M7P/7P/85P/19P

LANDSCAPING IN KIND.

TRENCH



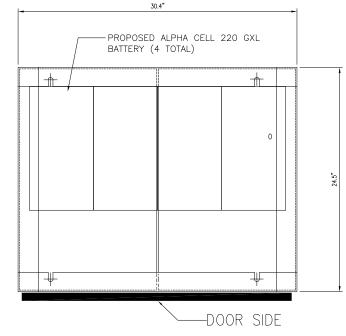

EQUIPMENT PEDESTAL

REV:	DATE/BY:	REVISION DESCRIPTION:
0	FXC 03/15/2013	ISSUED FOR REVIEW
1	FXC 11/05/2013	ISSUED FOR FINAL
2	FXC 03/08/2014	ISSUED FOR FINAL

ENGINEER/CONSULTANT:



CLIENT:

(949) 753-8807 OFFICE - (949) 753-8833 FAX



STAMP:

SITE INFO:

SITE NAME:

MON09 VERIZON MONTECITO-MON09

SITE ADDRESS: THOMAS BROS PAGE 997 GRID A3 R.O.W. NORTH SIDE OF JAMESON LN. (ADJACENT TO 1790 N JAMESON LN) SANTA BARBARA, CA 93108 LAT: 34.42149 LONG: -119.61899

SHEET TITLE:

DETAILS


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DRAWN BY: FC

N.T.S.

SHEET NUMBER:

D-1

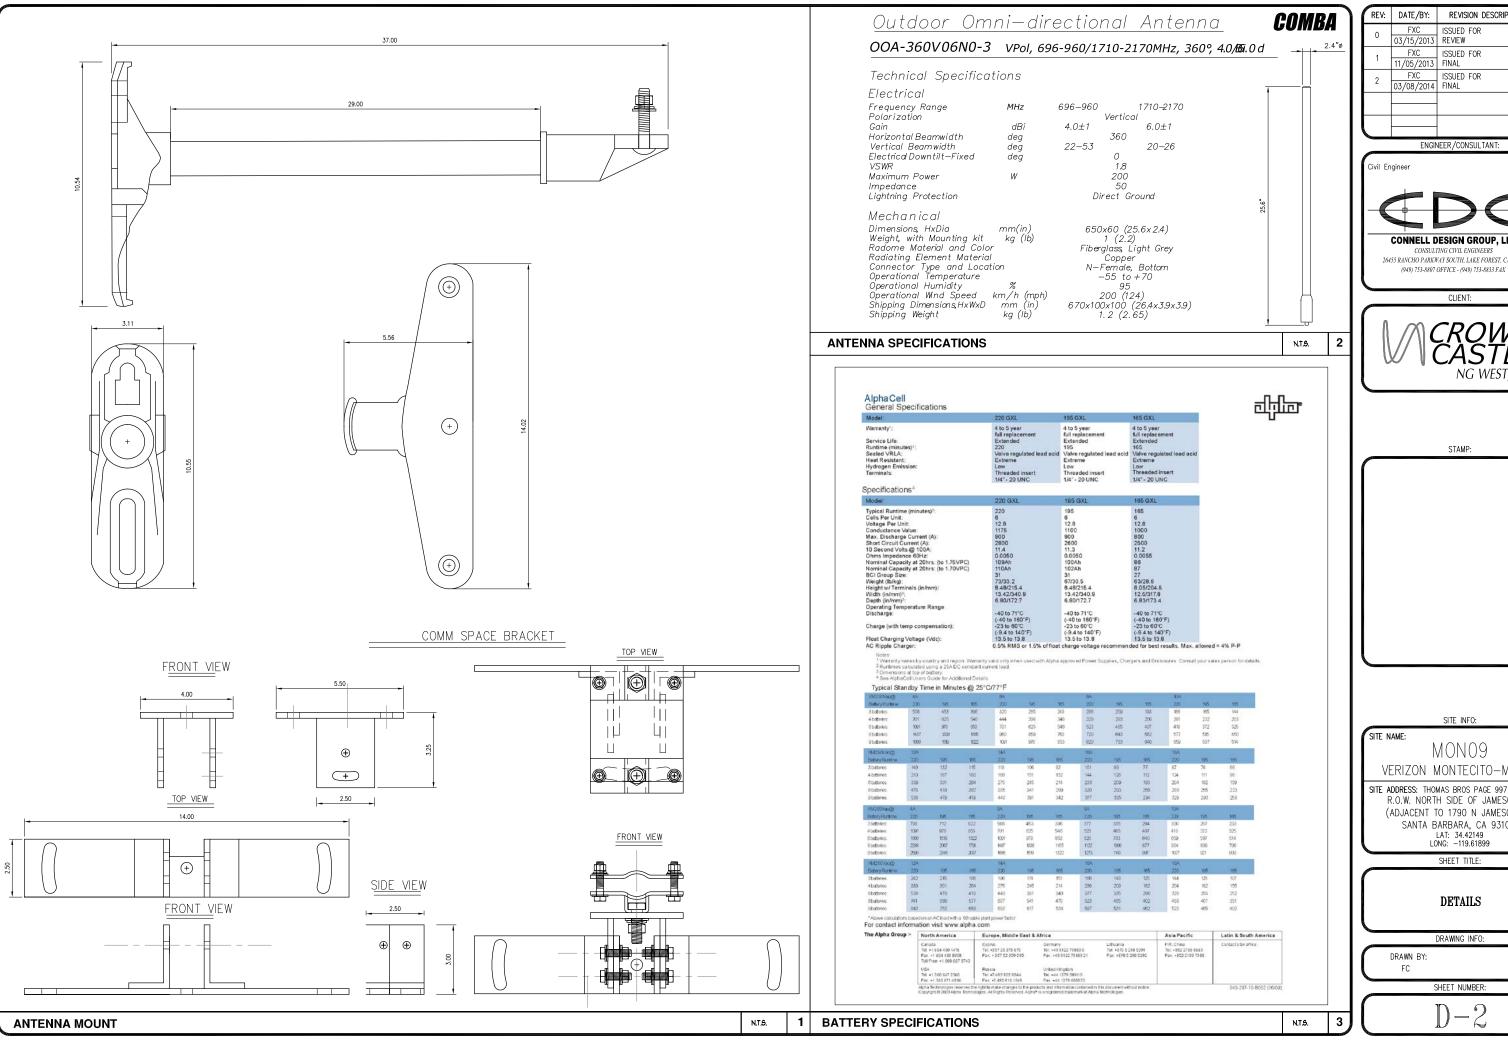

REVISION DESCRIPTION: ISSUED FOR 03/15/2013 REVIEW FXC ISSUED FOR 11/05/2013 FINAL 2 FXC ISSUED FOR 03/08/2014 FINAL

ENGINEER/CONSULTANT:



CLIENT:



STAMP:

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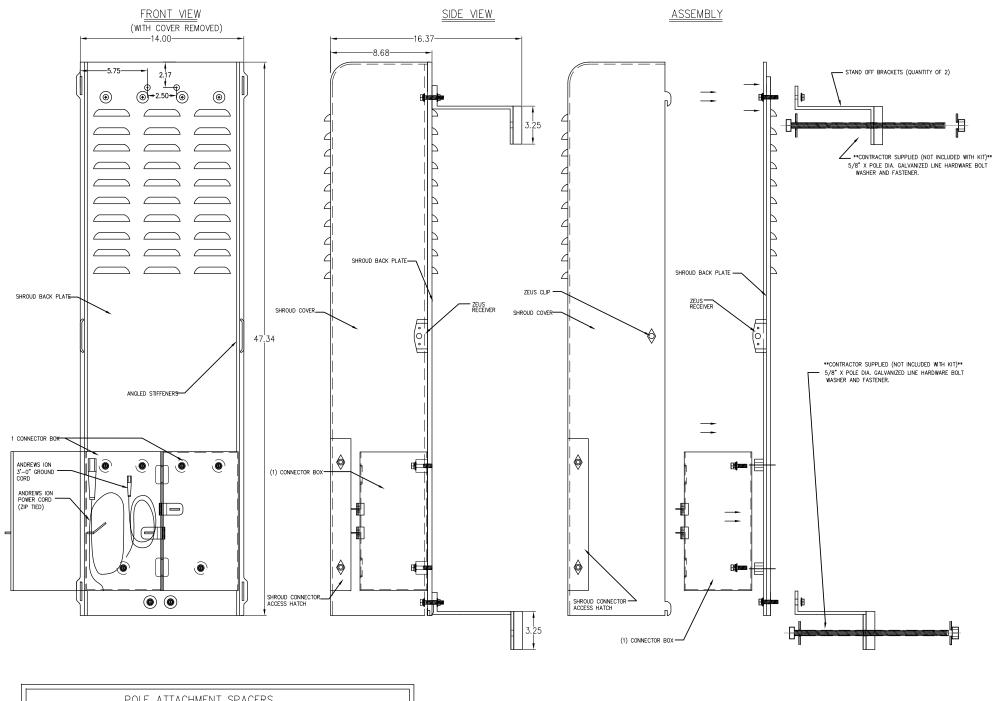
VERIZON MONTECITO-MON09


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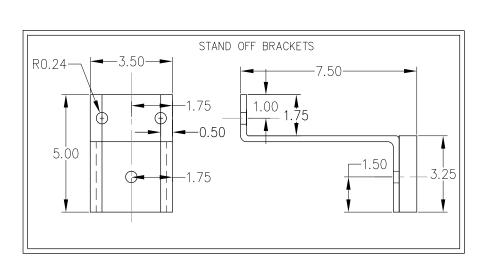
SHEET TITLE:

DETAILS

DRAWING INFO:





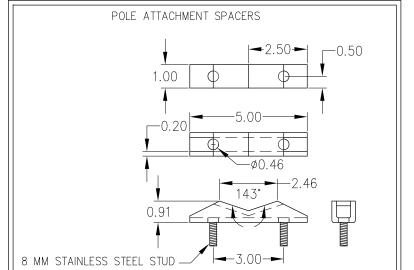

1	1	REV:	DATE/BY:	REVISION DESCRIPTION:
		0	FXC 03/15/2013	ISSUED FOR REVIEW
		1	FXC 11/05/2013	ISSUED FOR FINAL
		2	FXC 03/08/2014	ISSUED FOR FINAL

Civil Engineer



26455 RANCHO PARKWAY SOUTH, LAKE FOREST, CA 92630 (949) 753-8807 OFFICE - (949) 753-8833 FAX



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MON09 VERIZON MONTECITO-MON09

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SHEET TITLE:

DETAILS

DRAWING INFO:

FC

SHEET NUMBER:

SHROUD DETAIL

GENERAL NOTES

- 1. APPROVAL OF THESE PLANS BY THE CITY ENGINEER DOES NOT AUTHORIZE ANY WORK TO BE PERFORMED UNTIL A PERMIT HAS BEEN ISSUED.
- 2. UPON ISSUANCE OF A PERMIT, NO WORK WILL BE PERMITTED ON WEEKENDS OR HOLIDAYS WITHOUT PERMISSION FROM THE ENGINEERING DEPARTMENT
- 3. THE APPROVAL OF THIS PLAN OR ISSUANCE OF A PERMIT BY THE LOCAL JURISDICTION DOES NOT AUTHORIZE THE SUBDIVIDER AND OWNER TO VIOLUTE ANY FEBRUAL, STATE OR CITY LAWS, ORDINANCES, REQULATIONS, OR POLICES, INCLUDING, BUT NOT LIMITED TO, THE FEDERAL ENDANGERED SPICIES ACT OF 1973 AND AMENIMENTS THERETO (16 USC SECTION 153) ELESCO).
- 4. THE CONTRACTOR SHALL BE RESPONSIBLE FOR SURVEY MONUMENTS AND/OR VERTICAL CONTROL BENCHMARKS WHICH ARE DISTURBED OR DESTROYED BY CONSTRUCTION. A LAND SURVEYOR MUST FIELD LOCATE, REFERENCE, AND/OR PRESERVE ALL HISTORICAL OR CONTROLLING MONUMENTS SHALL BE REPLACED WITH APPROPRIATE MONUMENTS BY A LAND SURVEYOR, A CORNER RECORD OR RECORD OF SURVEY, AS APPROPRIATE, SHALL BE FIELD AS REQUIRED BY THE PROFESSIONAL LAND SURVEYORS ACT. IF ANY VERTICAL CONTROL IS TO BE DISTURBED OR DESTROYED, IDEA LOCAL JUNESTO SOLD SURVEY SECTION MUST BE NOTHERD, IN WRITING, AT LEAST 3 DAYS PRIOR TO THE CONSTRUCTION. THE CONTROL OF THE CONTROL BENCHMARKS DESTROYED BY THE CONTROLTOR MULL BE RESPONSIBLE FOR THE COST OF REPLACING ANY VERTICAL CONTROL BENCHMARKS DESTROYED BY THE CONSTRUCTION.
- 5. IMPORTANT NOTICE: SECTION 4216 OF THE GOVERNMENT CODE REQUIRES A DIG ALERT IDENTIFICATION NUMBER BE ISSUED BEFORE A "PERMIT TO EXCAVATE" WILL BE VALID. FOR YOUR DIG ALERT I.D. NUMBER, CALL UNDERGROUND SERVICE ALERT, TWO
- 6. CONTRACTOR SHALL BE RESPONSIBLE FOR THE POTHOLE AND LOCATING OF ALL EXISTING UTILITIES THAT CROSS THE PROPOSED TRENCH LINE AND MUST MAINTAIN 1' MINIMUM VERTICAL CLEARANCE.
- 7. CONTRACTOR SHALL SUBMIT TO THE LOCAL JURISDICTION, A CONSTRUCTION PLAN TO PROTECT WATER MAINS PRIOR TO COMMENCING CONSTRUCTION
- 8. CONTRACTOR SHALL REPLACE OR REPAIR ALL TRAFFIC SIGNAL LOOPS, CONDUIT, AND LANE STRIPING DAMAGED DURING
- 9. CONTRACTOR SHALL NOTIFY THE LOCAL JURISDICTION. A MINIMUM OF 48 HOURS PRIOR TO COMMENCING WORK WITHIN 10' OF
- 10. THIS PROJECT WILL BE INSPECTED BY ENGINEERING AND CAPITAL PROJECTS DEPARTMENT, FIELD ENGINEERING DIVISION.
- 11. AS-BUILT DRAWINGS MUST BE SUBMITTED TO THE CITY RESIDENT ENGINEER PRIOR TO THE ACCEPTANCE OF THIS PROJECT.
- 12. PUBLIC IMPROVEMENT SUBJECT TO DESUETUDE OR DAMAGE." IF REPAIR OR REPLACEMENT OF SUCH PUBLIC IMPROVEMENTS IS REQUIRED, THE OWNER SHALL OBTAIN THE REQUIRED PERMITS FOR WORK IN THE PUBLIC RIGHT-OFWAY, SATISFACTORY TO THE PERMIT ISSUING AUTHORITY.
- 13. PRIOR TO ANY DISTURBANCE TO THE SITE, EXCLUDING UTILITY MARKS-OUTS AND SURVEYING, THE CONTRACTOR SHALL MAKE ARRANGEMENTS FOR A PRE-CONSTRUCTION MEETING WITH THE LOCAL JURISDICTION FIELD ENGINEERING DIVISION.
- 14. PRIOR TO THE COMMENCEMENT OF ANY CONSTRUCTION SHOWN ON THESE PLANS. IT IS THE SOLE RESPONSIBILITY OF THE CONTRACTOR TO COORDINATE. THE CONTRACTOR IS RESPONSIBLE TO ATTEND THE LOCAL JURISDICTIONS MONTHLY UTILITY COORDINATION COMMITTEE THE CONSTRUCTION ACTIVITIES WITH THE CITY AND ALL OTHER CONTRACTORS SO THAT NO TRENCH IS CUT WITHIN ANY OF THE CITY STREETS THAT HAVE BEEN CONSTRUCTED, REPAIRED, OR SLURRY SEALED WITHIN THREE YEARS OF THE STREET CONSTRUCTIONS EQUIPMENT AND THE CITY AND THE CITY AND THE CITY OF THE CITY OF THE CITY OF THE STREET CONSTRUCTIONS EQUIPMENT AND THE CITY OF THE
- 15. MANHOLES OR COVERS SHALL BE LABELED "CROWN CASTLE" OR "CROWN CASTLE NG WEST".
- 16. CONTRACTOR SHALL IMPLEMENT AN EROSION AND SEDIMENT CONTROL PROGRAM DURING THE PROJECT CONSTRUCTION ACTIVITIES. THE PROGRAM SHALL MEET THE APPLICABLE REQUIREMENTS OF THE STATE WATER RESOURCE CONTROL BOARD.
- 17. THE CONTRACTOR SHALL HAVE EMERGENCY MATERIALS AND EQUIPMENT ON HAND FOR UNFORESEEN SITUATIONS, SUCH AS DAMAGE TO UNDERGROUND WATER, SEWER, AND STORM DRAIN FACILITIES WHEREBY FLOWS MAY GENERATE EROSION AND SEDIMENT

SPECIAL NOTES

THE FOLLOWING NOTES ARE PROVIDED TO GIVE DIRECTIONS TO THE CONTRACTOR BY THE ENGINEER OF WORK. THE CITY ENGINEER'S SIGNATURE ON THESE PLANS DOES NOT CONSTITUTE APPROVAL OF THESE NOTES AND THE CITY WILL NOT BE RESPONSIBLE FOR THEIR ENFORMEMENT.


- THE CONTRACTOR SHALL VERIFY THE LOCATION EXISTING UNDERGROUND UTILITIES INCLUDING SEWER LATERALS AND WATER SERVICES TO INDIVIDUAL LOTS BOTH VERTICAL AND HORIZONTAL PRIOR TO COMMENCING IMPROVEMENT OPERATIONS.
- 2. CONTRACTOR SHALL MAKE EXPLORATION EXCAVATIONS AND LOCATE EXISTING FACILITIES SUFFICIENTLY AHEAD OF CONSTRUCTION TO PERMIT REVISIONS OF PLANS IF REVISION IS NECESSARY BECAUSE OF LOCATION OF EXISTING UTILITIES.
- LOCATION AND ELEVATIONS OF IMPROVEMENTS, TO BE MET BY WORK, SHALL BE CONFIRMED BY FIELD MEASUREMENT PRIOR TO CONSTRUCTION OF NEW WORK.
- 4. GRADES SHOWN ARE FINISH GRADES, CONTRACTOR SHALL DETERMINE NECESSARY SUB GRADE ELEVATIONS AND SHALL CONSTRUCT SMOOTH TRANSITION BETWEEN FINISH GRADES SHOWN.
- 5. CONTRACTOR AGREES THAT HE SHALL ASSUME SOLE RESPONSIBILITY FOR JOB SITE CONDITION DURING THE COURSE OF CONSTRUCTION OF THIS PROJECT, INCLUDING SAFETY OF ALL PERSONS AND PROPERTY: THAT THIS PROVISED SHALL APPLY CONTINUOUSLY AND NOT BE UNITED TO NORMAL WORKING HOURS; AND THAT THE CONTRACTOR SHALL DEFEND, INDEMNIFY AND HOLD THE OWNER AND THE ENGINEER HARMLESS FROM ANY AND ALL LIABILITY, REAL OR ALLEGED IN CONNECTION WITH THE PERFORMANCE OF WORK ON THIS PROJECT, EXPECTING FOR LIABILITY ARISING FROM SOLE NEGLIGENCE OF THE OWNER OR THE ENGINEER.
- 6. THE CONTRACTOR SHALL BE TOTALLY RESPONSIBLE FOR COMPLIANCE WITH THE PROVISIONS OF THE STATE OF CALIFORNIA SAFETY ORDERS.
- 7. THE LOCATIONS OF ALL EXISTING UTILITIES SHOWN ON THESE PLANS ARE FROM EXISTING RECORDS AND CORROBORATED, WHERE POSSIBLE WITH FIELD TIES. THE CONTRACTOR IS RESPONSIBLE FOR CONFIRMING THE LOCATIONS SHOWN, BOTH HORIZONTALLY AND VERTICALLY, PROR TO CONSTRUCTION. IF EXISTING LOCATIONS VARY SUBSTANTIALLY FROM THE PLANS, THE ENGINEER SHOULD BE NOTIFIED TO MAKE ANY CONSTRUCTION CHANGES REQUIRED.
- 8. THE CONTRACTOR SHALL PROVIDE TEMPORARY SUPPORT FOR ALL SEWER AND WATER MAIN UNDER CROSSING IN ACCORDANCE WITH PART 1 SECTION 5-2 OF THE STANDARD SPECIFICATION.
- 9. THE CONTRACTOR SHALL REPLACE OR REPAIR ALL TRAFFIC SIGNAL LOOPS, CONDUITS, AND LANE STRIPING DAMAGED DURING CONSTRUCTION.
- 10. THE CONTRACTOR SHALL SUBMIT WORK PLANS FOR ALL BORE OPERATIONS TWO WEEKS PRIOR TO COMMENCING WORK.
- 11. CONTRACTOR SHALL BE RESPONSIBLE FOR THE POTHOLE AND LOCATING OF ALL EXISTING UTILITIES THAT CROSS THE PROPOSED TRENCH LINE AND MUST MAINTAIN 1' MINIMUM VERTICAL CLEARANCE.
- 12. AS-BUILT DRAWINGS MUST BE SUBMITTED TO THE CITY ENGINEER PRIOR TO ACCEPTANCE OF THIS PROJECT.



CONSTRUCTION CHANGE TABLE CHANGE DATE EFFECTED OR ADDED SHEET NUMBERS

CROWN CASTLE NG WEST, INC

VERIZON MONTECITO-MON11m1 R.O.W. WEST SIDE OF LILAC DR. (ADJACENT TO 755 ROMERO CANYON RD) SANTA BARBARA, CA 93108

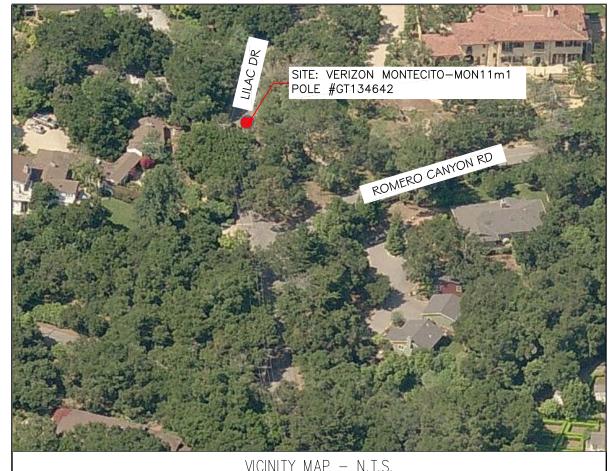

GROUND BUS BAR MECH. GRND. CONN. CADWELD E. ELECTRIC BOX T. TELEPHONE BOX EXISTING SERVICE POLE SIDEWALK FLAG EX. MANHOLE	LIGHT POLE FOUNDATION SPOT ELEV. EXEMPTION REVISION DETAIL REF.	ELEVATION REF. SECTION REF. PROP./LEASE LINE MATCH LINE WORK POINT TELE. CONDUIT CENTERLINE	—E — ELECT. CONDUIT —A — COAXIAL CABLE MYERS PEDESTAL VAULT STANDARD 2'X3' ■ STEEL POLE

SYMBOLS, LINETYPES AND HATCH PATTERNS

APPLICABLE CODES

ALL WORK SHALL COMPLY WITH THE FOLLOWING APPLICABLE CODES:

- 2010 CALIFORNIA BUILDING CODE 2010 CALIFORNIA MECHANICAL CODE
- 010 CALIFORNIA MECHANICAL CODE 010 CALIFORNIA PLUMBING CODE 010 CALIFORNIA FLECTRICAL CODE
- IN THE EVENT OF CONFLICT, THE MOST RESTRICTIVE CODE SHALL PREVAIL

PROJECT DESCRIPTION

PROJECT CONSISTS OF INSTALLATION OF:

1. (2) OMNI DIRECTIONAL ANTENNAS ON EXISTING UTILITY POLE

2. BBU, EQUIPMENT SHROUD AND ION MOUNTED TO EXISTING POLE

SHEET INDEX:

TITLE SHEET T-1 - SHEET 1 0F 6
SITE PLAN A-1 - SHEET 2 0F 6
PROPOSED ELEVATIONS A-2 - SHEET 3 0F 6
DETAILS D-1 - SHEET 4 0F 6
DETAILS D-2 - SHEET 5 0F 6
DETAILS D-3 - SHEET 6 0F 6

EROSION AND SEDIMENT CONTROL NOTES

TEMPORARY EROSION/SEDIMENT CONTROL, PRIOR TO COMPLETION OF FINAL IMPROVEMENTS,
SHALL BE PERFORMED BY THE CONTRACTOR OR QUALIFIED PERSON AS INDICATED BELOW:

- ALL REQUIREMENTS OF THE LOCAL JURISDICTION "LAND DEVELOPMENT MANUAL, STORM WATER STANDARDS" MUST BE INCORPORATED INTO THE DESIGN AND CONSTRUCTION OF THE PROPOSED GRADING/IMPROVEMENTS CONSISTENT WITH THE APPROVED STORM WATER AND/OR WATER POLLUTION CONTROL PLAN (WPCP).
- 2. FOR STORM DRAIN INLETS, PROVIDE A GRAVEL BAG SILT BASIN IMMEDIATELY UPSTREAM OF INLET AS INDICATED ON DETAILS.
- 3. FOR INLETS LOCATED AT SUMPS ADJACENT TO TOP OF SLOPES, THE CONTRACTOR SHALL ENSURE THAT WATER DRAINING TO THE SUMP IS DIRECTED INTO THE INLET AND THAT A MINIMUM OF 1.00° FREEDOARD EXISTS AND IS MAINTAINED ABOVE THO POF THE INLET. IF FREEDOARD IS NOT PROVIDED BY GRADING SHOWN ON THESE PLANS, THE CONTRACTOR SHALL PROVIDE IT VIA TEMPORARY MEASURES, I.E. GRAVEL BAGS OR DIKES.
- THE CONTRACTOR OR QUALIFIED PERSON SHALL BE RESPONSIBLE FOR CLEANUP OF SILT AND MUD ON ADJACENT STREET(S) AND STORM DRAIN SYSTEM DUE TO CONSTRUCTION ACTIVITY.
- 5. THE CONTRACTOR OR QUALIFIED PERSON SHALL CHECK AND MAINTAIN ALL LINED AND UNLINED DITCHES AFTER EACH RAINFALL.
- 6. THE CONTRACTOR SHALL REMOVE SILT AND DEBRIS AFTER EACH MAJOR RAINFALL.
- EQUIPMENT AND WORKERS FOR EMERGENCY WORK SHALL BE MADE AVAILABLE AT ALL
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- 8. THE CONTRACTOR SHALL RESTORE ALL EROSION/SEDIMENT CONTROL MEASURES TO WORKING ORDER TO THE SATISFACTION OF THE CITY ENGINEER OR RESIDENT ENGINEER AFTER EACH RUN-OFF PRODUCING RAINFALL.
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- 10. THE CONTRACTOR SHALL BE RESPONSIBLE AND SHALL TAKE NECESSARY PRECAUTIONS TO PREVENT PUBLIC TRESPASS ONTO AREAS WHERE IMPOUNDED WATERS CREATE A HAZARDOUS CONDITION.
- 11. ALL EROSION/SEDIMENT CONTROL MEASURES PROVIDED PER THE APPROVED GRADING PLAN SHALL BE INCORPORATED HEREON. ALL EROSION/SEDIMENT CONTROL FOR INTERIM CONDITIONS SHALL BE DONE TO THE SATISFACTION OF THE RESIDENT ENGINEER.
- GRADED AREAS AROUND THE PROJECT PERIMETER MUST DRAIN AWAY FROM THE FACE
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 13. ALL REMOVABLE PROTECTIVE DEVICES SHOWN SHALL BE IN PLACE AT THE END OF EACH
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- 15. THE CONTRACTOR SHALL ARRANGE FOR WEEKLY MEETINGS DURING OCTOBER 1ST TO APRIL 30TH FOR PROJECT TEAM (GENERAL CONTRACTOR, QUALIFIED PERSON, EROSION CONTROL SUBCONTRACTOR IF ANY, ENGINEER OF WORK, OWNER AND THE RESIDENT ENGINEER) TO EVALUATE THE ADEQUACY OF THE EROSION/SEDIMENT CONTROL MEASURES AND OTHER RELATED CONSTRUCTION ACTIVITIES.

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EROSION/SEDIMENT CONTROL MEASURES.

THE CONTRACTOR SHALL SUBMIT A TRAFFIC CONTROL PLAN (11" X 17") FOR APPROVAL PRIOR TO STARTING WORK. THE PLAN SHOULD BE SUBMITTED TO THE TRAFFIC CONTROL PERMIT COUNTRE. CONTRACTOR SHALL OBTAIN A TRAFFIC CONTROL PERMIT A MINIMUM OF TWO (2) WORKING DAYS PRIOR TO STARTING WORK, AND A MINIMUM FIVE (5) DAYS IF WORK WILL AFFECT A BUS STOP OR AN EXISTING TRAFFIC SIGNAL, OR IF WORK WILL REQUIRE A ROAD OR ALLEY CLOSURE.

FOOTAGE TOTALS						
ASPHALT CUT	-					
DIRT TRENCH	-					
PUNCH THRU	-					
BORE	-					
TOTAL	=					
R&R SWF TOTAL	_					

PROJECT DICTIONARY

SITE ADDRESS: R.O.W. WEST OF LILAC DR
(ADJACENT TO 755 ROMERO CANYON RD)
SANTA BARBARA, CA 93108

APPLICANT: CROWN CASTLE NG WEST, INC 2125 WRIGHT AVE, SUITE #C9 LA VERNE, CA 91750 CONTACT: HEIDI PAYNE

PHONE: (949) 300-9493

CIVIL ENGINEER: CONNELL DESIGN GROUP,

CONNELL DESIGN GROUP, LLC 26455 RANCHO PARKWAY SOUTH LAKE FOREST, CA 92630 CONTACT: FRANK CARTER (949) 310-8233 PHONE (949) 753-8833 FAX

١	REV:	DATE/BY:	REVISION DESCRIPTION:
I	0	FXC 03/08/2013	ISSUED FOR REVIEW
I	1	SA 03/18/2013	ISSUED FOR APPROVAL
I	2	JPC 09/05/2013	ISSUED FOR APPROVAL
I	3	FC 10/28/2013	ISSUED FOR APPROVAL
I	4	FC 03/08/2013	ISSUED FOR APPROVAL

ENGINEER/CONSULTANT:




CLIENT:

26455 RANCHO PARKWAY SOUTH, LAKE FOREST, CA 92630

(949) 753-8807 OFFICE - (949) 753-8833 FAX



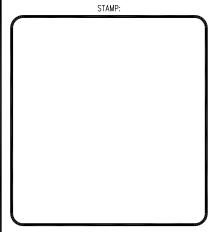

SITE INFO:

SITE NAME:

MON11m1 verizon montecito-mon11m1

SITE ADDRESS: THOMAS BROS PAGE 997 GRID D1

R.O.W. WEST OF LILAC DR
(ADJACENT TO 755 ROMERO CANYON RD)
LAT: 34.44333°
LONG: -119.60114°

SHEET TITLE:


TITLE SHEET

DRAWING INFO:


DRAWN B'

SHEET NUMBER:

T-1

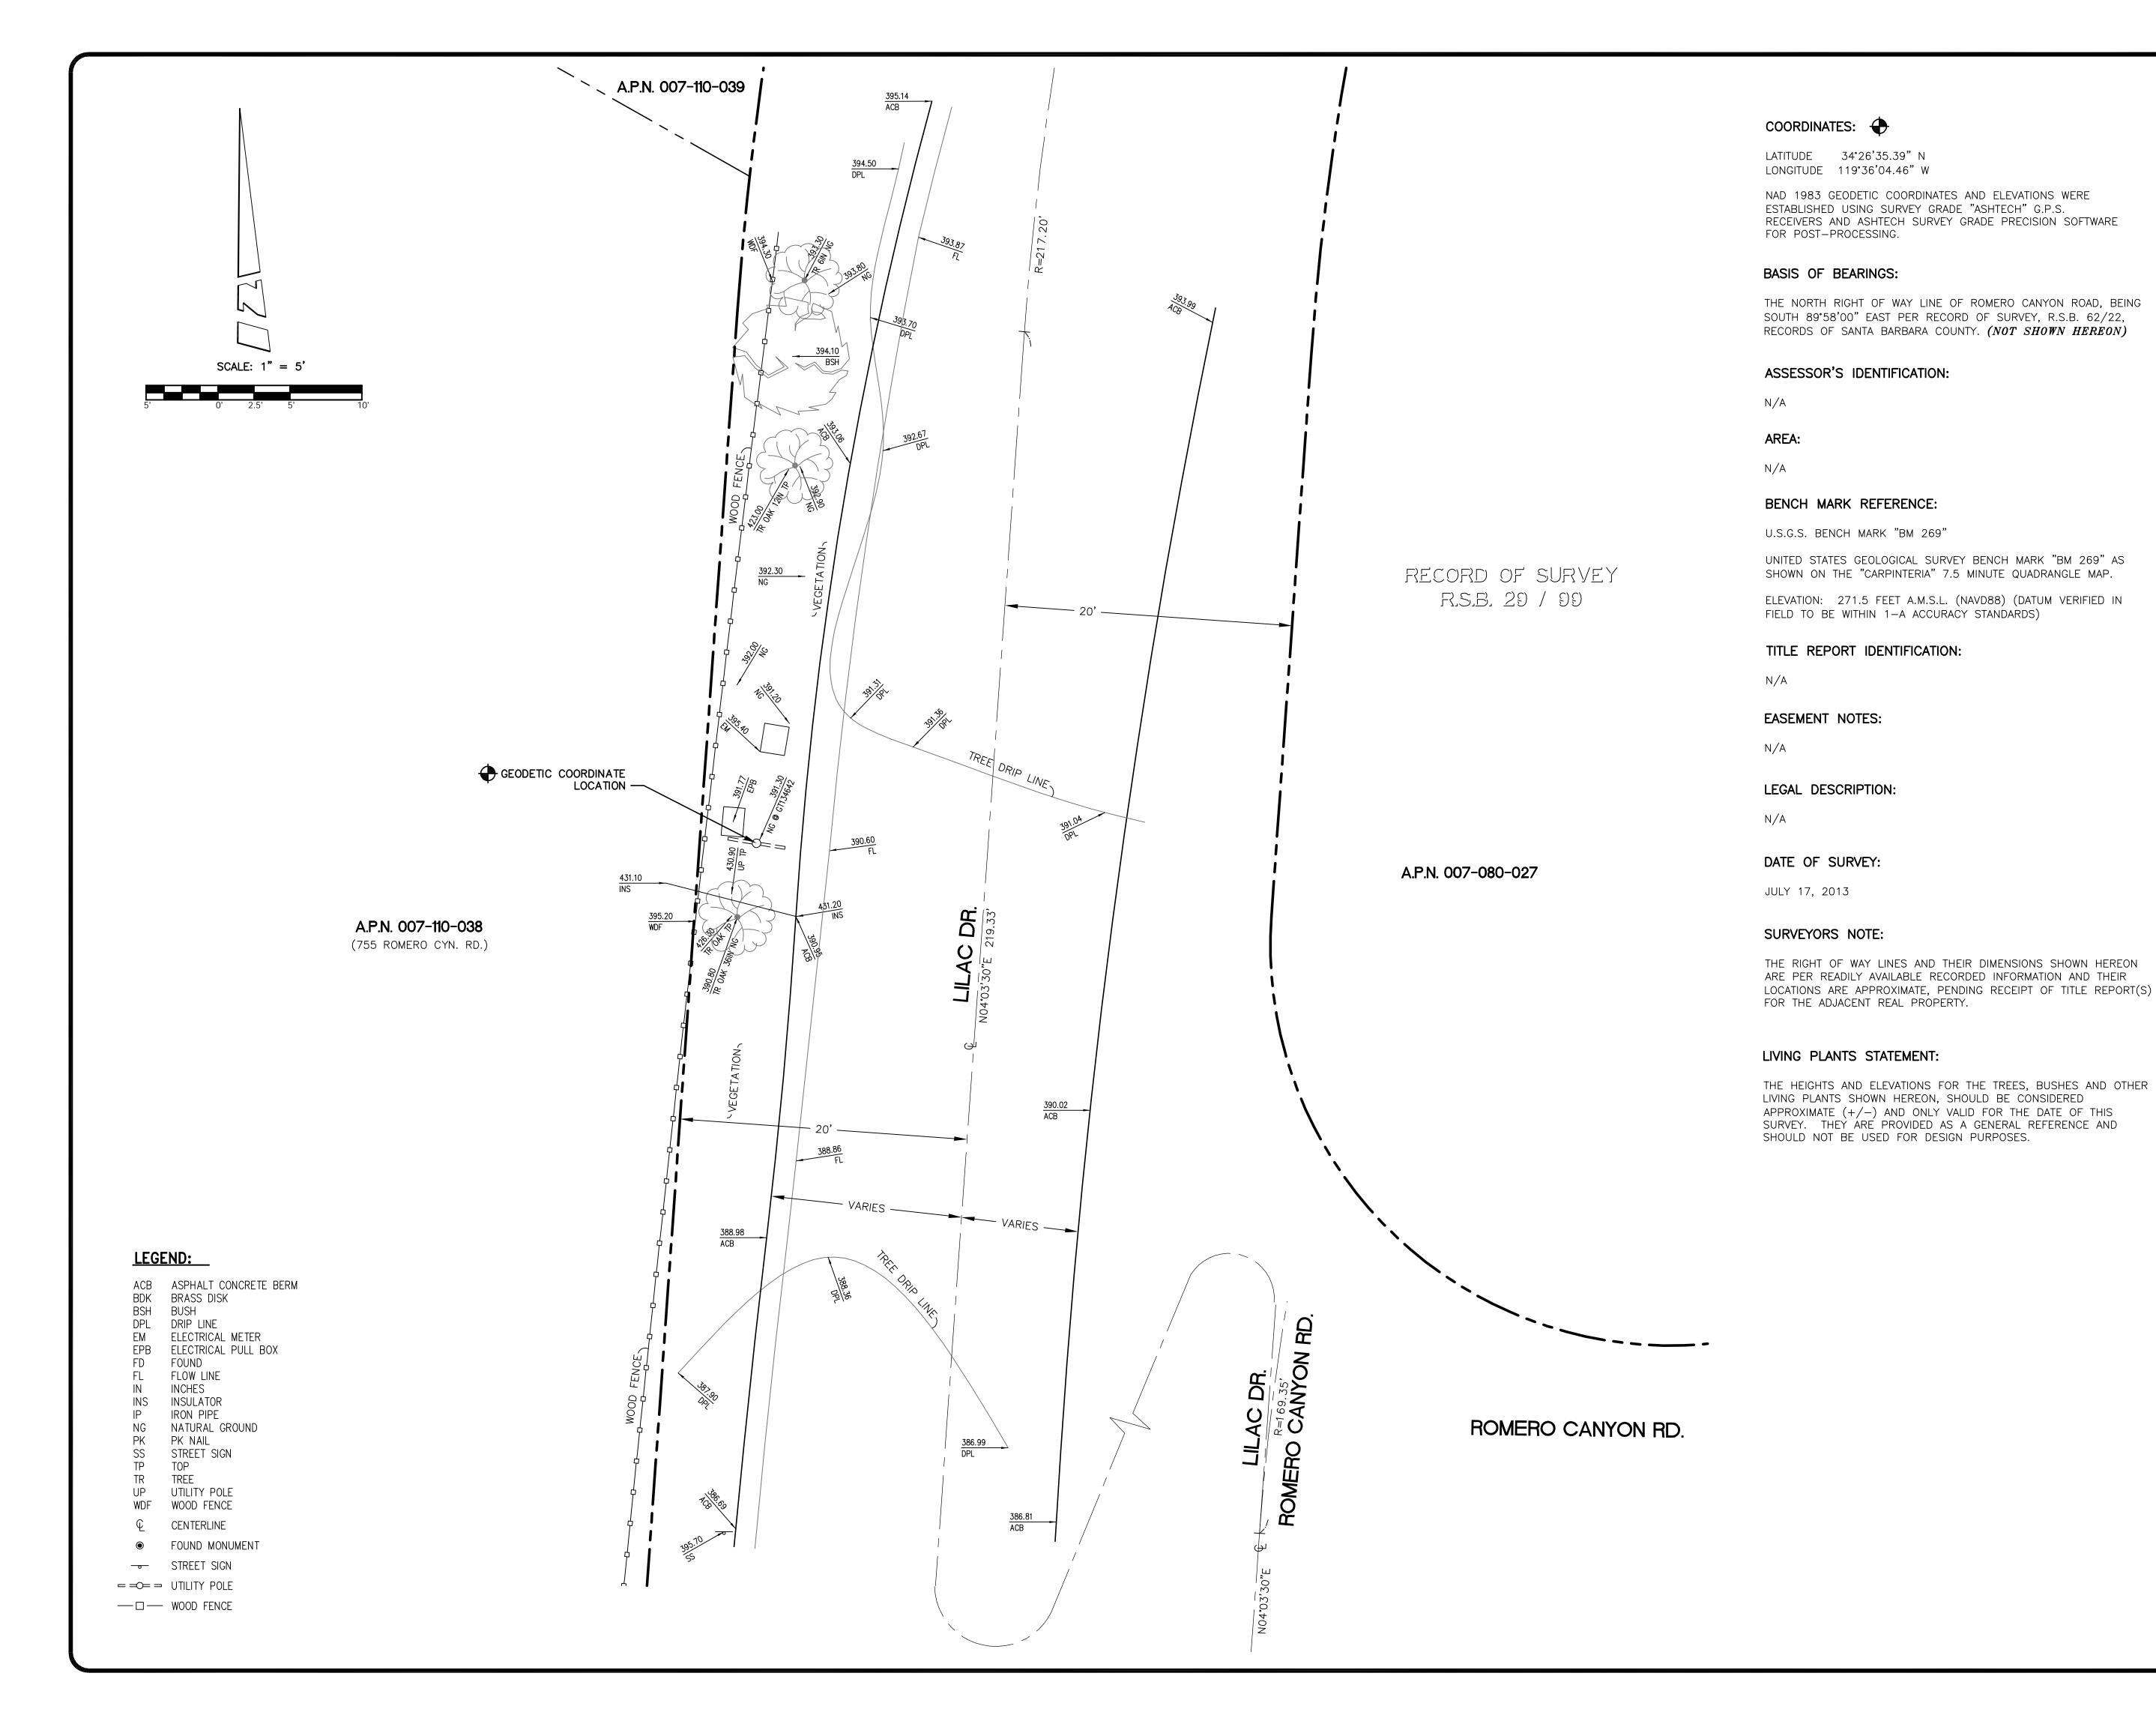

REV:	DATE/BY:	REVISION DESCRIPTION:
1	07/24/13	ISSUED FOR REVIEW
'	MDL/JA	

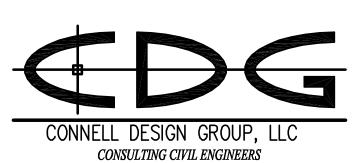

26455 RANCHO PKWY. SOUTH LAKE FOREST, CA 92630-8326 (949) 753-8807 OFFICE - (949) 753-8833 FAX

SITE BUILDER:



SURVEYOR:

BERT HAZE

AND ASSOCIATES, INC.

LAND SURVEYING & MAPPING

3188 AIRWAY AVENUE, SUITE K1

COSTA MESA, CALIFORNIA 92626

714 557-1567 OFFICE

714 557-1568 FAX

JN. 706.225

STAMP:



SITE INFO:

SITE NAME:

MONIIMI
VERIZON MONTECITO-MONIIMI

SITE ADDRESS:

R.O.W. WEST SIDE OF LILAC DR (ADJACENT TO 755 ROMERO CANYON RD) SANTA BARBARA, CA 93108

SHEET TITLE:

TOPOGRAPHIC SURVEY


DRAWING INFO:

DWG. NAME: DRAWN BY: DATE:
MONIIMI MDL 07/24/13

SHEET NUMBER:

. . . .



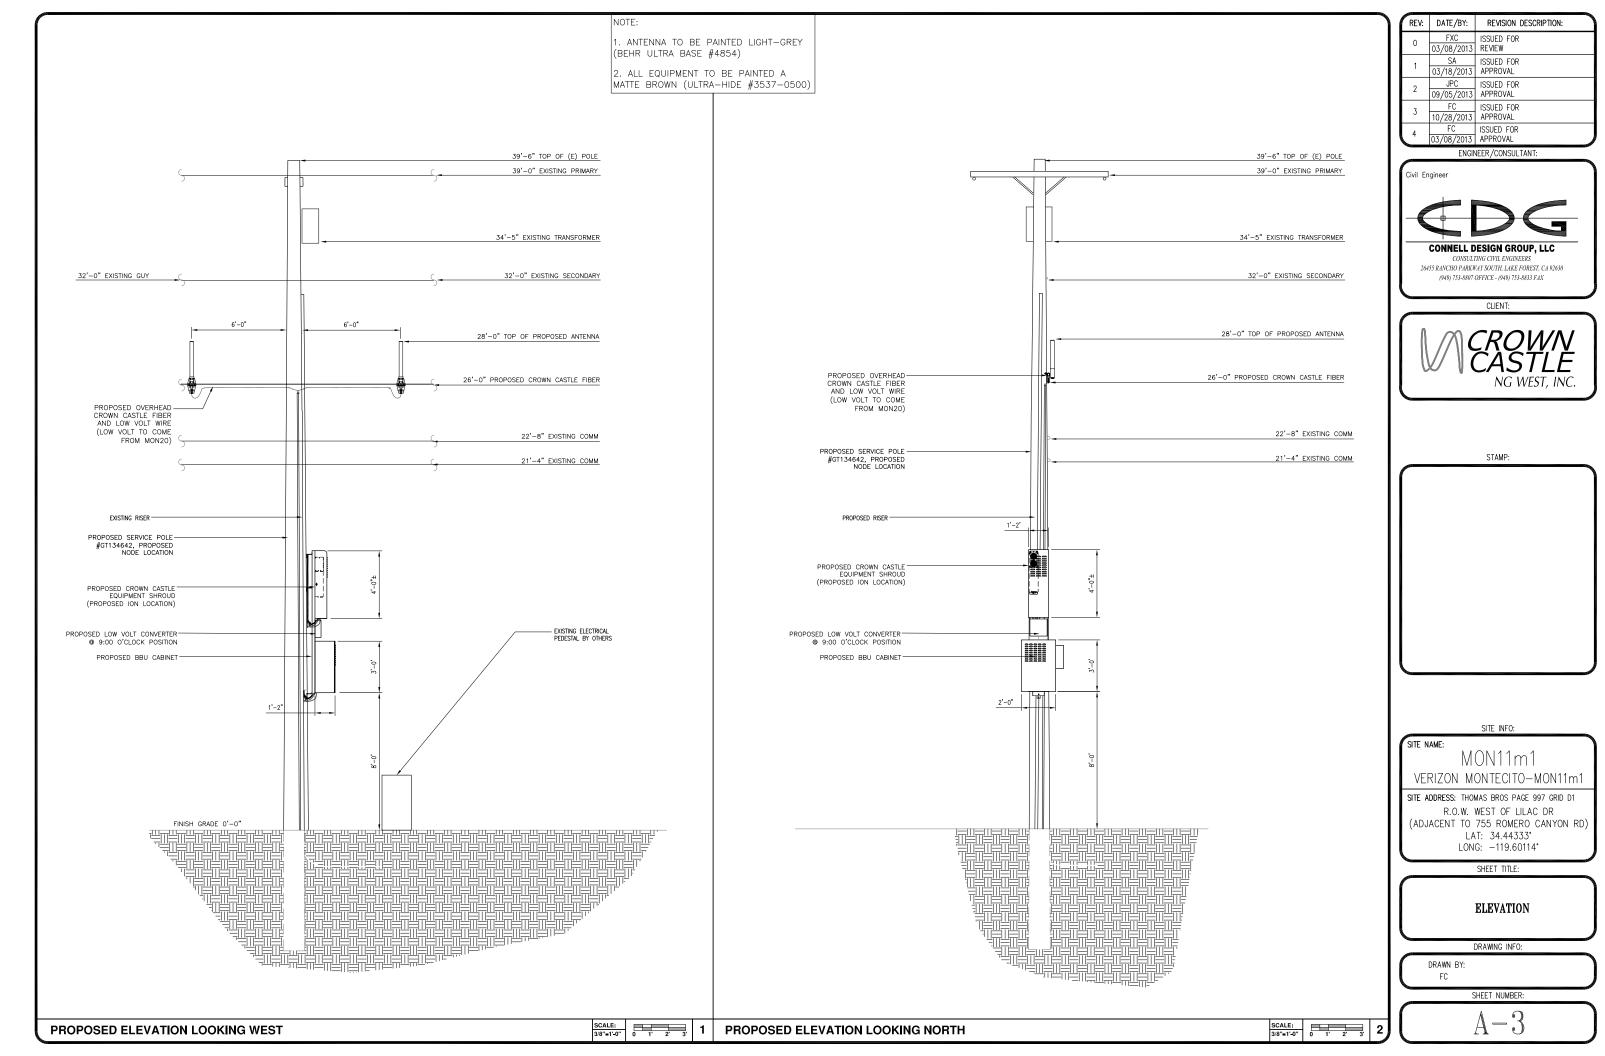

Outdoor Omni-directional Antenna

COMBA

OOA-360V06N0-3 VPol, 696-960/1710-2170MHz, 360°, 4.0/6.0 dBi


Technical Specifications


Electrical

Liocai			
Frequency Range	MHz	696-960	1710–2170
Polarization		Vert.	ical
Gain	dBi	4.0±1	6.0±1
Horizontal Beamwidth	deg	360)
Vertical Beamwidth	deg	22-53	20–26
Electrical Downtilt-Fixed	deg	0	
VSWR	,	1.8	3
Maximum Power	W	20	0
Impedance		50)
Lightning Protection		Direct	Ground
, , , , , , , , , , , , , , , , , , ,			

Mechanical

Dimensions, HxDia Weight, with Mounting kit Radome Material and Color Radiating Element Material Connector Type and Location Operational Temperature Operational Humidity Operational Wind Speed km/h (mph)
Shipping Dimensions, HxWxD mm (in)
Shipping Weight kg (lb)

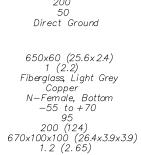

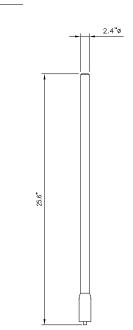

ANTENNA SPECIFICATIONS N.T.S.

Electrical

Power Supply Mains power, Vac . 1100 max. Power consumption, Watts < 750 @ normal operation 700 MHz SISO/MIMO

Frequency range, MHz

698 to 716/776 to 787 728 to 757

Output power per carrier*, dBm

Number of Carriers 1

850 MHz

Frequency range, MHz

-4			824 to 849 869 to 894	
utput power per carri	er*, dBm			
umber of Carriers 1	2	4	8	

Out CDMA

1900 MHz

Frequency range, MHz

1850 to 1915 Output power per carrier*, dBm

Number of Carriers	1	2	4	8
GSM	43	40	37	34
CDMA	43	40	37	34
LTE	43	40 ***	37	34
UMTS	42	39	36	33



ION-M7P/7P/85P/19P

20W for Cell,

PCS bands and 700MHz MIMO Noise figure, dB

Mechanical****

Height, width, depth, mm (in) . 817 x 245 x 218 (32.2 x 9.6 x 8.6) Weight, kg (lb)

Page 1, February 27, 2013 Company Confidential

Alpha Cell

General Specifications

220 GXL	195 GXL	165 GXL
4 to 5 year	4 to 5 year	4 to 5 year
full replacement	full replacement	full replacement
Extended	Extended	Extended
220	195	165
Valve regulated lead acid	Valve regulated lead acid	Valve regulated lead aci
Extreme	Extreme	Extreme
Low	Low	Low
Threaded insert	Threadedinsert	Threaded insert
1/4" - 20 UNC	1/4" - 20 UNC	1/4" - 20 UNC
	4 to 5 year full replacement Extended 220 Valve regulated lead add Extreme Low Threaded insert	4 to 5 year full replacement Extended Extended 220 Valve regulated lead acid Extreme Low Threaded insert 4 to 5 year full replacement Extended 195 Valve regulated lead acid Extreme Low Threaded insert Threaded insert

Specifications4

Model	220 GXL	195 GXL	165 GXL
Typical Runtime (minutes)2:	220	195	165
Cells Fer Unit:	6	6	6
Voltage Per Unit:	12.8	12.8	12.8
Conductance Value:	1175	1100	1000
Max. Discharge Current (A):	900	900	800
Short Circuit Current (A):	2800	2600	2500
10 Second Volts @ 100A:	11.4	11.3	11.2
Ohms mpedance 60Hz:	0.0050	0.0050	0.0055
Nominal Capacity at 20hrs: (to 1.75VPC)	109Ah	100Ah	86
Nominal Capacity at 20hrs: (to 1.70VPC)	110Ah	102Ah	87
BCI Group Size:	31	31	27
Weight (lb/kg):	73/33.2	67/30.5	63/28.6
Heightw/ Terminals (in/mm):	8.48/215.4	8.48/215.4	8.05/204.5
Width (in/mm)3:	13.42/340.9	13.42/340.9	12.5/317.8
Depth (in/mm)3:	6.80/172.7	6.80/172.7	6.83/173.4
Operating Temperature Range			
Discharge:	-40 to 71°C	-40 to 71°C	-40 to 71°C
2007-3000 3	(-40 to 160°F)	(-40 to 160°F)	(-40 to 160°F)
Charge (with temp compensation):	-23 to 60°C	-23 to 60°C	-23 to 60°C
	(-9.4 to 140°F)	(-9.4 to 140°F)	(-9.4 to 140°F)
Float Charging Voltage (Vdc):	13.5 to 13.8	13.5 to 13.8	13.5 to 13.8

AC Ripple Charger: 0.5% RMS or 1.5% of float charge voltage recommended for best results. Max. allowed = 4% P-P

Notes:

1 Warranty varies by country and region. Warranty valid only when used with Alpha approved Power Supplies, Chargers and Enclosures. Consult your sales person for details.

2 Runtimes calculated using a 25A DC constant current load.

3 Demensions at top of battery.

4 See AlphaCell Users Guide for Additional Details.

Typical Standby Time in Minutes @ 25°C/77°F

XM290/ao@	4A			6A			8A			10A		
BatteryRuntme	220	195	165	220	195	165	220	195	165	220	195	165
3 batteres:	508	453	396	320	285	249	236	209	193	186	165	144
4 batteries:	701	625	546	444	396	346	329	293	256	261	232	203
6 batteres:	1091	978	853	701	625	546	523	465	407	418	372	325
8 batteries:	1487	1338	1165	960	859	750	720	643	562	577	515	450
9 batteries:	1686	1519	1322	1091	978	853	820	733	640	659	587	514
XM290/ac@	12A			14A			16A			18A		
Battery Runtime:	220	195	165	220	195	165	220	195	165	220	195	165
3 batteries:	149	132	115	119	106	92	101	89	77	87	78	66
4 batteres:	210	187	163	169	151	132	144	128	112	124	111	96
6 batteres:	339	301	264	275	245	214	236	209	183	204	182	159
8 batteries:	478	419	367	385	341	299	329	293	256	288	255	223
9 batteries:	538	479	419	440	391	342	377	335	294	329	293	256
XM260Vao@	4A			6A			88			10A		
Battery Funtine:	220	195	165	220	195	165	220	195	165	220	195	165
3 batteries:	798	712	622	508	453	396	377	335	294	300	267	233
4 batteries;	1091	978	853	701	625	546	523	465	407	418	372	325
6 betteries:	1686	1519	1322	1091	978	853	820	733	640	659	587	514
8 batteries:	2288	2067	1798	1487	1338	1165	1122	1006	877	904	809	706
9 batteries:	2590	2345	2037	1696	1519	1322	1273	1143	997	1027	921	803
XM260/ao@	12A			14A			16A			18A		
Battery Runtime:	220	195	165	220	195	165	220	195	165	220	195	165
3 batteries:	242	215	188	196	174	151	166	148	125	144	128	107
4.5	339	301	264	275	245	214	236	209	182	204	182	155
4 batteries		477.0	419	440	391	340	377	335	290	329	293	252
4 batteries: 6 batteries:	538	479	419	440	001							
	538 741	479 660	577	607	541	470	523	465	402	458	407	351

*Above calculations based on an AC load with a .90 cable plant power factor.


The Alpha Gre

The Alpha Group >	North America	Europe, Middle East 8	& Africa		Asia Pacific	Latin & South America
	Canada Tel: +1 604 430 1476 Fax: +1 604 430 8908 Toll Free: +1 800 667 8743	Cyprus Tel: +357 25 375 675 Fax: +357 52 359 595	Germany Tel: +49 9122 79889 0 Fax: +49 9122 79889 21	Lithuania Tel: +370 5 210 5291 Fax: +370 5 210 5292	P.R. China Tel: +852 2736 8663 Fax: +852 2199 7988	Centact USA office
	USA Tel: +1 360 647 2360 Fax: +1 360 671 4936	Russia Tel: +7 495 925 9844 Fax: +7 495 916 1349	United Kingdom Tel: +44 1279 501110 Fax: +44 1279 659870			

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049-297-10-B002 (06/09)



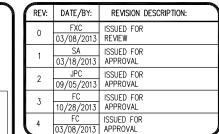

ENGINEER / CONSULTANT:

Civil Engineer CONNELL DESIGN GROUP, LLC

> CONSULTING CIVIL ENGINEERS 26455 RANCHO PARKWAY SOUTH, LAKE FOREST, CA 92630

(949) 753-8807 OFFICE - (949) 753-8833 FAX CLIENT:



STAMP:

SITE INFO:

SITE NAME: MON11m1 VERIZON MONTECITO-MON11m1

SITE ADDRESS: THOMAS BROS PAGE 997 GRID D1 R.O.W. WEST OF LILAC DR (ADJACENT TO 755 ROMERO CANYON RD) LAT: 34.44333° LONG: -119.60114°

SHEET TITLE:


DETAILS

DRAWING INFO:

FC

SHEET NUMBER:

2 N.T.S. ION-M7P/7P/85P/19P **UN-USED**

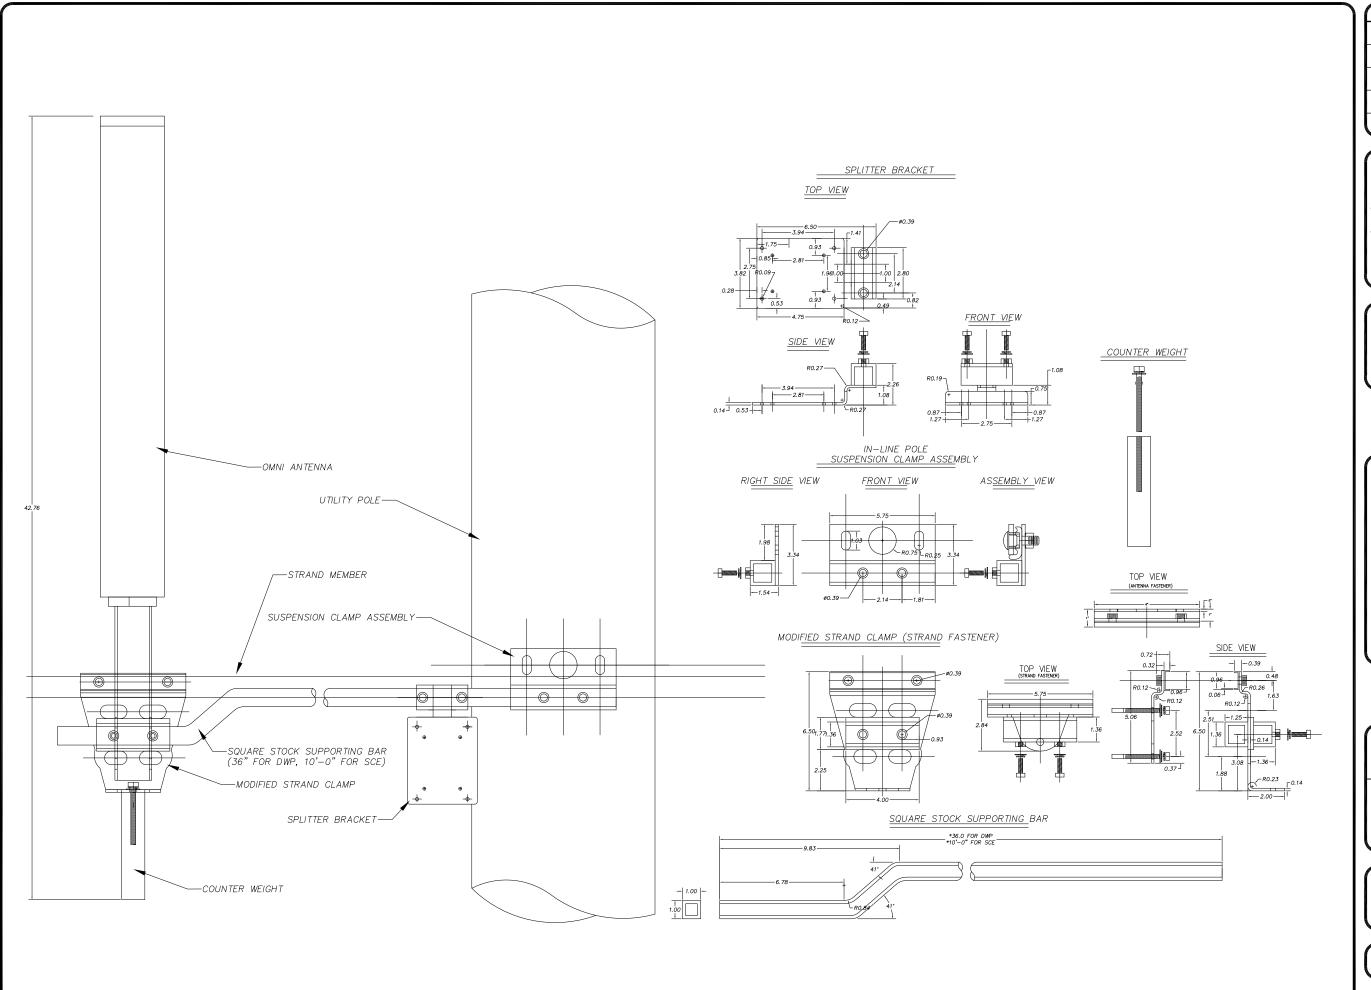

ANTENNA MOUNT

1	REV:	DATE/BY:	REVISION DESCRIPTION:
	0	FXC 03/08/2013	ISSUED FOR REVIEW
	1	SA 03/18/2013	ISSUED FOR APPROVAL
	2	JPC 09/05/2013	ISSUED FOR APPROVAL
	3	FC 10/28/2013	ISSUED FOR APPROVAL
ı	4	FC	ISSUED FOR

ENGINEER/CONSULTANT:

Civil Engineer



26455 RANCHO PARKWAY SOUTH, LAKE FOREST, CA 92630 (949) 753-8807 OFFICE - (949) 753-8833 FAX

CLIENT:



STAMP:

SITE INFO:

SITE NAME:

MON11m1 VERIZON MONTECITO-MON11m1

SITE ADDRESS: THOMAS BROS PAGE 997 GRID D1

R.O.W. WEST OF LILAC DR

(ADJACENT TO 755 ROMERO CANYON RD)

LAT: 34.44333*

LONG: -119.60114*

SHEET TITLE:


DETAILS


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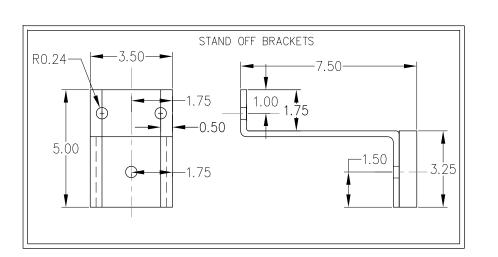
DRAWN BY: FC

SHEET NUMBER:

D-2



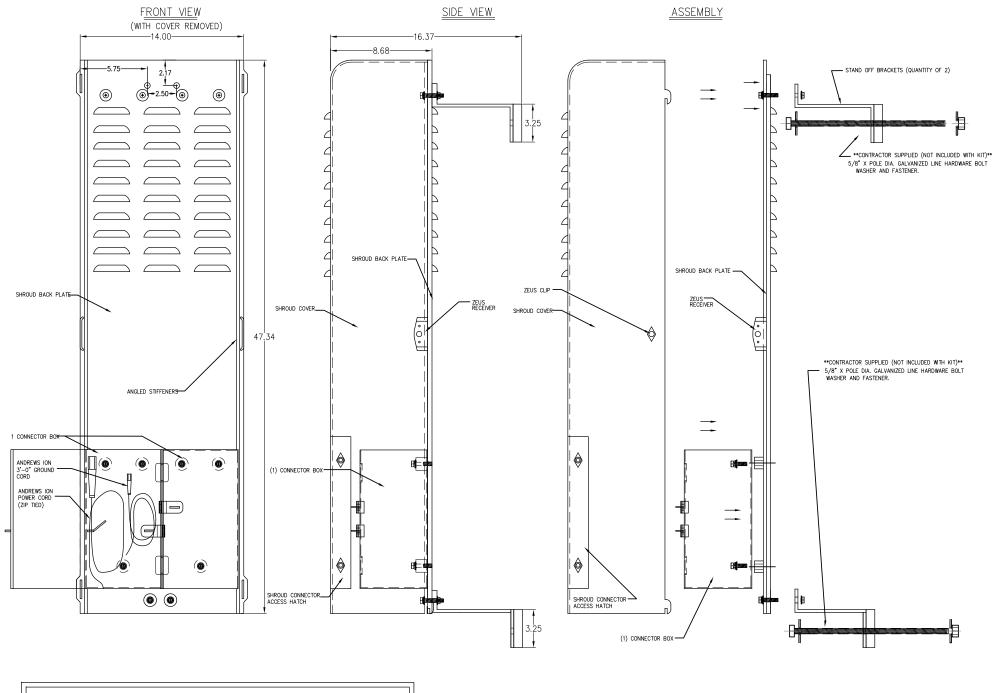

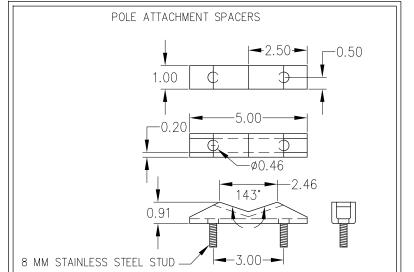

1	1	REV:	DATE/BY:	REVISION DESCRIPTION:
		0	FXC 03/08/2013	ISSUED FOR REVIEW
		1	SA 03/18/2013	ISSUED FOR APPROVAL
		2	JPC 09/05/2013	ISSUED FOR APPROVAL
		3	FC 10/28/2013	ISSUED FOR APPROVAL
		4	FC	ISSUED FOR

Civil Engineer



26455 RANCHO PARKWAY SOUTH, LAKE FOREST, CA 92630 (949) 753-8807 OFFICE - (949) 753-8833 FAX



STAMP:

SITE INFO:

SITE NAME:

MON11m1 VERIZON MONTECITO-MON11m1

SITE ADDRESS: THOMAS BROS PAGE 997 GRID D1
R.O.W. WEST OF LILAC DR
(ADJACENT TO 755 ROMERO CANYON RD)
LAT: 34.44333*
LONG: -119.60114*

SHEET TITLE:

DETAILS

DRAWING INFO:

DRAWN B

SHEET NUMBER:

D - 3

SHROUD DETAIL

- . APPROVAL OF THESE PLANS BY THE CITY ENGINEER DOES NOT AUTHORIZE ANY WORK TO BE PERFORMED UNTIL A PERMIT HAS
- 2. UPON ISSUANCE OF A PERMIT, NO WORK WILL BE PERMITTED ON WEEKENDS OR HOLIDAYS WITHOUT PERMISSION FROM THE
- 3, THE APPROVAL OF THIS PLAN OR ISSUANCE OF A PERMIT BY THE LOCAL JURISDICTION DOES NOT AUTHORIZE THE SUBDIVIDER AND OWNER TO VIOLATE ANY FEDERAL. STATE OR CITY LAWS, ORDINANCES, REGULATIONS, OR POLICIES, INCLUDING, BUT NOT LIMITED TO, THE FEDERAL ENDANGERED SPECIES ACT OF 1973 AND AMENDMENTS THERETO (16 USC SECTION 1531 ET.SEQ.)
- 4. THE CONTRACTOR SHALL BE RESPONSIBLE FOR SURVEY MONUMENTS AND/OR VERTICAL CONTROL BENCHMARKS WHICH ARE DISTURBED OR DESTROYED BY CONSTRUCTION. A LAND SURVEYOR MUST FIELD LOCATE, REFERENCE, AND/OR PRESERVE ALL HISTORICAL OR CONTROLLING MONUMENTS PRIOR TO ANY EARTHWORK. IF DESTROYED, SUCH MONUMENTS SHALL BE REPLACED WITH APPROPRIATE MONUMENTS BY A LAND SURVEYOR, A CORNER RECORD OR RECORD OF SURVEY, AS APPROPRIES, SHALL BE FIELD AS REQUIRED BY THE PROFESSIONAL LAND SURVEYORS ACT. IF ANY VERTICAL CONTROL IS TO BE DISTURBED OR DESTROYED. THE LOCAL JURISDICTION FIELD SURVEY SECTION MUST BE NOTIFIED. IN WRITING, AT LEAST 3 DAYS PRIOR TO THE CONSTRUCTION. THE CONTRACTOR WILL BE RESPONSIBLE FOR THE COST OF REPLACING ANY VERTICAL CONTROL BENCHMARKS
- 5. IMPORTANT NOTICE: SECTION 4216 OF THE GOVERNMENT CODE REQUIRES A DIG ALERT IDENTIFICATION NUMBER BE ISSUED BEFORE A "PERMIT TO EXCAVATE" WILL BE VALID. FOR YOUR DIG ALERT I.D. NUMBER, CALL UNDERGROUND SERVICE ALERT, TWO
- 6. CONTRACTOR SHALL BE RESPONSIBLE FOR THE POTHOLE AND LOCATING OF ALL EXISTING UTILITIES THAT CROSS THE PROPOSED TRENCH LINE AND MUST MAINTAIN 1' MINIMUM VERTICAL CLEARANCE.
- 7. CONTRACTOR SHALL SUBMIT TO THE LOCAL JURISDICTION, A CONSTRUCTION PLAN TO PROTECT WATER MAINS PRIOR TO COMMENCING CONSTRUCTION.
- 8. CONTRACTOR SHALL REPLACE OR REPAIR ALL TRAFFIC SIGNAL LOOPS, CONDUIT, AND LANE STRIPING DAMAGED DURING
- 9. CONTRACTOR SHALL NOTIFY THE LOCAL JURISDICTION. A MINIMUM OF 48 HOURS PRIOR TO COMMENCING WORK WITHIN 10' OF
- 10. THIS PROJECT WILL BE INSPECTED BY ENGINEERING AND CAPITAL PROJECTS DEPARTMENT, FIELD ENGINEERING DIVISION.
- 11. AS-BUILT DRAWINGS MUST BE SUBMITTED TO THE CITY RESIDENT ENGINEER PRIOR TO THE ACCEPTANCE OF THIS PROJECT.
- 12. PUBLIC IMPROVEMENT SUBJECT TO DESUETUDE OR DAMAGE." IF REPAIR OR REPLACEMENT OF SUCH PUBLIC IMPROVEMENTS IS REQUIRED, THE OWNER SHALL OBTAIN THE REQUIRED PERMITS FOR WORK IN THE PUBLIC RIGHT-OFWAY, SATISFACTORY TO TH
- 13. PRIOR TO ANY DISTURBANCE TO THE SITE, EXCLUDING UTILITY MARKS-OUTS AND SURVEYING, THE CONTRACTOR SHALL MAKE ARRANGEMENTS FOR A PRE-CONSTRUCTION MEETING WITH THE LOCAL JURISDICTION FIELD ENGINEERING DIVISION.
- 14. PRIOR TO THE COMMENCEMENT OF ANY CONSTRUCTION SHOWN ON THESE PLANS. IT IS THE SOLE RESPONSIBILITY OF THE CONTRACTOR TO COORDINATE. THE CONTRACTOR IS RESPONSIBLE TO ATTEND THE LOCAL JURISDICTIONS MONTHLY UTILITY COORDINATION COMMITTEE THE CONSTRUCTION ACTIVITIES WITH THE CITY AND ALL OTHER CONTRACTORS SO THAT NO TRENCH IS CUT WITHIN ANY OF THE CITY STREETS THAT HAVE BEEN CONSTRUCTED, REPAIRED, OR SLURRY SEALED WITHIN THREE YEARS OF THE STREET CONSTRCTUION/RESURFACING DATE.
- 15. MANHOLES OR COVERS SHALL BE LABELED "CROWN CASTLE" OR "CROWN CASTLE NG WEST".
- 16. CONTRACTOR SHALL IMPLEMENT AN EROSION AND SEDIMENT CONTROL PROCRAM DURING THE PROJECT CONSTRUCTION ACTIVITIES PROGRAM SHALL MEET THE APPLICABLE REQUIREMENTS OF THE STATE WATER RESOURCE CONTROL BOARD
- 17. THE CONTRACTOR SHALL HAVE EMERGENCY MATERIALS AND EQUIPMENT ON HAND FOR UNFORESEEN SITUATIONS, SUCH AS DAMAGE TO UNDERGROUND WATER, SEWER, AND STORM DRAIN FACILITIES WHEREBY FLOWS MAY GENERATE EROSION AND SEDIMENT

SPECIAL NOTES

THE FOLLOWING NOTES ARE PROVIDED TO GIVE DIRECTIONS TO THE CONTRACTOR BY THE ENGINEER OF WORK. THE CITY ENGINEER'S SIGNATURE ON THESE PLANS DOES NOT CONSTITUTE APPROVAL OF THESE NOTES AND THE CITY WILL NOT BE RESPONSIBLE FOR THEIR ENFORCEMENT.

- THE CONTRACTOR SHALL VERIFY THE LOCATION EXISTING UNDERGROUND UTILITIES INCLUDING SEWER LATERALS AND WATER
 SERVICES TO INDIVIDUAL LOTS BOTH VERTICAL AND HORIZONTAL PRIOR TO COMMENCING IMPROVEMENT OPERATIONS.
- 2. CONTRACTOR SHALL MAKE EXPLORATION EXCAVATIONS AND LOCATE EXISTING FACILITIES SUFFICIENTLY AHEAD OF CONSTRUCTION TO PERMIT REVISIONS OF PLANS IF REVISION IS NECESSARY BECAUSE OF LOCATION OF EXISTING UTILITIES.
- 3. LOCATION AND ELEVATIONS OF IMPROVEMENTS. TO BE MET BY WORK, SHALL BE CONFIRMED BY FIELD MEASUREMENT PRIOR TO
- 4. GRADES SHOWN ARE FINISH GRADES, CONTRACTOR SHALL DETERMINE NECESSARY SUB GRADE ELEVATIONS AND SHALL CONSTRUCT
- 5. Contractor agrees that he shall assume sole responsibility for job site condition during the course of construction of this project, including safety of all persons and property: that this provision shall apply CONTINUOUSLY AND NOT BE LIMITED TO NORMAL WORKING HOURS; AND THAT THE CONTRACTOR SHALL DEFEND, INDEMNIFY AND HOLD THE OWNER AND THE ENGINEER HARMLESS FROM ANY AND ALL LIABILITY. REAL OR ALLEGED IN CONNECTION WITH THI PERFORMANCE OF WORK ON THIS PROJECT, EXPECTING FOR LIABILITY ARISING FROM SOLE NEGLIGENCE OF THE OWNER OR THE
- 6. THE CONTRACTOR SHALL BE TOTALLY RESPONSIBLE FOR COMPLIANCE WITH THE PROVISIONS OF THE STATE OF CALIFORNIA SAFETY
- 7. THE LOCATIONS OF ALL EXISTING UTILITIES SHOWN ON THESE PLANS ARE FROM EXISTING RECORDS AND CORROBORATED, WHERE POSSIBLE WITH FIELD TIES. THE CONTRACTOR IS RESPONSIBLE FOR CONFIRMING THE LOCATIONS SHOWN, BOTH HORIZONTALLY AND VERTICALLY, PRIOR TO CONSTRUCTION. IF EXISTING LOCATIONS VARY SUBSTANTIALLY FROM THE PLANS, THE ENGINEER SHOULD BE NOTIFIED TO MAKE ANY CONSTRUCTION CHANGES REQUIRED.
- 8. THE CONTRACTOR SHALL PROVIDE TEMPORARY SUPPORT FOR ALL SEWER AND WATER MAIN UNDER CROSSING IN ACCORDANCE WITH PART 1 SECTION 5-2 OF THE STANDARD SPECIFICATION.
- 9. THE CONTRACTOR SHALL REPLACE OR REPAIR ALL TRAFFIC SIGNAL LOOPS, CONDUITS, AND LANE STRIPING DAMAGED DURING
- 10. THE CONTRACTOR SHALL SUBMIT WORK PLANS FOR ALL BORE OPERATIONS TWO WEEKS PRIOR TO COMMENCING WORK.
- 11. CONTRACTOR SHALL BE RESPONSIBLE FOR THE POTHOLE AND LOCATING OF ALL EXISTING UTILITIES THAT CROSS THE PROPOSED
- 12. AS-BUILT DRAWINGS MUST BE SUBMITTED TO THE CITY ENGINEER PRIOR TO ACCEPTANCE OF THIS PROJECT




CONSTRUCTION CHANGE TABLE CHANGE DATE EFFECTED OR ADDED SHEET NUMBERS

CROWN CASTLE NG WEST, INC

VERIZON MONTECITO-MON13 ROW NORTH SIDE OF ORTEGA HILLS RD (ADJACENT TO 2101 SUMMERLAND HEIGHTS RD) SUMMERLAND, CA 93067



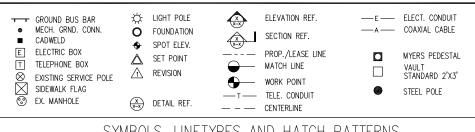

SYMBOLS, LINETYPES AND HATCH PATTERNS

APPLICABLE CODES

ALL WORK SHALL COMPLY WITH THE FOLLOWING APPLICABLE CODES:

- IN THE EVENT OF CONFLICT, THE MOST RESTRICTIVE CODE SHALL PREVAIL

PROJECT DESCRIPTION

PROJECT CONSISTS OF INSTALLATION OF:

2. ÉXISTING EQUIPMENT SHROUD TO BE REPLACED 3. EQUIPMENT PEDESTAL W/ BBU AND ELECTRICAL METER AT BASE OF

SHEET INDEX: - SHEET 1 OF 10 TOPOGRAPHIC SURVEY C-1 - SHFFT 2 OF 10 - SHEET 3 OF 10 - SHEET 4 OF 10 - SHEET 5 OF 10 TOPOGRAPHIC SURVEY **EXISTING FLEVATIONS** PROPOSED ELEVATIONS GRADING PLAN DETAILS D-1 - SHFFT 8 OF 10 DETAILS D-2 - SHEET 9 OF 10

EROSION AND SEDIMENT CONTROL NOTES

TEMPORARY EROSION/SEDIMENT CONTROL, PRIOR TO COMPLETION OF FINAL IMPROVEMENTS. SHALL BE PERFORMED BY THE CONTRACTOR OR QUALIFIED PERSON AS INDICATED BELOW:

- 1. ALL REQUIREMENTS OF THE LOCAL JURISDICTION "LAND DEVELOPMENT MANUAL, STORM WATER STANDARDS" MUST BE INCORPORATED INTO THE DESIGN AND CONSTRUCTION OF THE PROPOSED GRADING/IMPROVEMENTS CONSISTENT WITH THE APPROVED STORM WATER AND/OR WATER POLLUTION CONTROL PLAN (WPCP).
- 2. FOR STORM DRAIN INLETS, PROVIDE A GRAVEL BAG SILT BASIN IMMEDIATELY UPSTREAM OF INLET AS INDICATED ON DETAILS.
- 3. FOR INLETS LOCATED AT SUMPS ADJACENT TO TOP OF SLOPES, THE CONTRACTOR SHALL ENSURE THAT WATER DRAINING TO THE SUMP IS DIRECTED INTO THE INLET AND THAT A MINIMUM OF 1.00" FREEBOARD EXISTS AND IS MAINTAINED ABOVE THE TOP OF THE INLET. IF FREEBOARD IS NOT PROVIDED BY GRADING SHOWN ON THESE PLANS, THE CONTRACTOR SHALL PROVIDE IT VIA TEMPORARY MEASURES, I.E. GRAVEL BAGS OR DIKES.
- 4. THE CONTRACTOR OR QUALIFIED PERSON SHALL BE RESPONSIBLE FOR CLEANUP OF SILT AND MUD ON ADJACENT STREET(S) AND STORM DRAIN SYSTEM DUE TO CONSTRUCTION
- 5. THE CONTRACTOR OR QUALIFIED PERSON SHALL CHECK AND MAINTAIN ALL LINED AND UNLINED DITCHES AFTER EACH RAINFALL.
- 6. THE CONTRACTOR SHALL REMOVE SILT AND DEBRIS AFTER EACH MAJOR RAINFALL.
- EQUIPMENT AND WORKERS FOR EMERGENCY WORK SHALL BE MADE AVAILABLE AT ALL TIMES DURING THE RAINY SEASON, ALL NECESSARY MATERIALS SHALL BE STOCKPILED ON SITE AT CONVENIENT LOCATIONS TO FACILITATE RAPID CONSTRUCTION OF TEMPORARY DEVICES WHEN RAIN IS IMMINENT.
- 8. THE CONTRACTOR SHALL RESTORE ALL EROSION/SEDIMENT CONTROL MEASURES TO WORKING ORDER TO THE SATISFACTION OF THE CITY ENGINEER OR RESIDENT ENGINEER AFTER EACH RUN-OFF PRODUCING RAINFALL.
- THE CONTRACTOR SHALL INSTALL ADDITIONAL EROSION CONTROL MEASURES AS MAY BE REQUIRED BY THE RESIDENT ENGINEER DUE TO UNCOMPLETED GRADING OPERATIONS OR UNFORESEEN CIRCUMSTANCES, WHICH MAY ARISE.
- 10. THE CONTRACTOR SHALL BE RESPONSIBLE AND SHALL TAKE NECESSARY PRECAUTIONS TO PREVENT PUBLIC TRESPASS ONTO AREAS WHERE IMPOUNDED WATERS CREATE A HAZARDOUS CONDITION.
- 11. ALL EROSION/SEDIMENT CONTROL MEASURES PROVIDED PER THE APPROVED GRADING PLAN SHALL BE INCORPORATED HEREON. ALL EROSION/SEDIMENT CONTROL FOR INTERIM CONDITIONS SHALL BE DONE TO THE SATISFACTION OF THE RESIDENT ENGINEER. 12 CRADED AREAS AROUND THE PROJECT PERIMETER MUST DRAIN AWAY FROM THE FACE
- OF THE SLOPE AT THE CONCLUSION OF EACH WORKING DAY. 13. ALL REMOVABLE PROTECTIVE DEVICES SHOWN SHALL BE IN PLACE AT THE END OF EACH
- 14. THE CONTRACTOR SHALL ONLY GRADE, INCLUDING CLEARING AND GRUBBING FOR THE AREAS FOR WHICH THE CONTRACTOR OR QUALIFIED PERSON CAN PROVIDE FROSION/SEDIMENT CONTROL MEASURES.
- 15. THE CONTRACTOR SHALL ARRANGE FOR WEEKLY MEETINGS DURING OCTOBER 1ST TO APRIL 30TH FOR PROJECT TEAM (GENERAL CONTRACTOR, QUALIFIED PERSON, EROSION CONTROL SUBCONTRACTOR IF ANY, ENGINEER OF WORK, OWNER AND THE RESIDENT ENGINEER) TO EVALUATE THE ADEQUACY OF THE EROSION/SEDIMENT CONTROL MEASURES AND OTHER RELATED CONSTRUCTION ACTIVITIES.

TRAFFIC CONTROL NOTES

THE CONTRACTOR SHALL SUBMIT A TRAFFIC CONTROL PLAN (11" X 17") FOR APPROVAL PRIOR TO STARTING WORK. THE PLAN SHOULD BE SUBMITTED TO THE TRAFFIC CONTROL PERMIT COUNTER. CONTRACTOR SHALL OBTAIN A TRAFFIC CONTROL PERMIT A MINIMUM OF TWO (2) WORKING DAYS PRIOR TO STARTING WORK, AND A MINIMUM FIVE (5) DAYS IF WORK WILL AFFECT A BUS STOP OR AN EXISTING TRAFFIC SIGNAL, OR IF WORK WILL REQUIRE A

FOOTAGE TOTALS		
ASPHALT CUT	-	
DIRT TRENCH	-	
PUNCH THRU	-	
BORE	-	
TOTAL	=	
R&R SWF TOTAL	_	

PROJECT DICTIONARY

SITE ADDRESS: ROW NORTH SIDE OF ORTEGA HILLS RD (ADJACENT TO 2101 SUMMERLAND HEIGHTS RD) SUMMERLAND, CA 93067

CROWN CASTLE NG WEST, INC 2125 WRIGHT AVE, SUITE #C9 LA VERNE, CA 91750 CONTACT: HEIDI PAYNE PHONE: (949) 300-9493

CIVIL ENGINEER: CONNELL DESIGN GROUP, LLC 26455 RANCHO PARKWAY SOUTH LAKE FOREST, CA 92630 CONTACT: FRANK CARTER (949) 310-8233 PHONE (949) 753-8833 FAX

REVISION DESCRIPTION: DATE/BY: ISSUED FOR 03/25/2013 REVIEW FXC ISSUED FOR 03/27/2013 FINAL FXC ISSUED FOR 08/05/2013 FINAL FXC ISSUED FOR 11/05/2013 FINAL FXC ISSUED FOR 3/08/2014 FINAL


ENGINEER/CONSULTANT:



(949) 753-8807 OFFICE - (949) 753-8833 FAX

CLIENT:



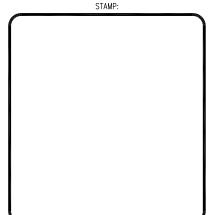

SITE INFO:

MON13

VERIZON MONTECITO-MON13


SITE ADDRESS: THOMAS BROS PAGE 997 GRID C3 R.O.W. NORTH SIDE OF ORTEGA HILL RD (ADJACENT TO 2101 SUMMERLAND HEIGHTS RD) SANTA BARBARA, CA 93108 LAT: 34.423900° LONG: -119.608410°

SHEET TITLE:

TITLE SHEET

DRAWING INFO:



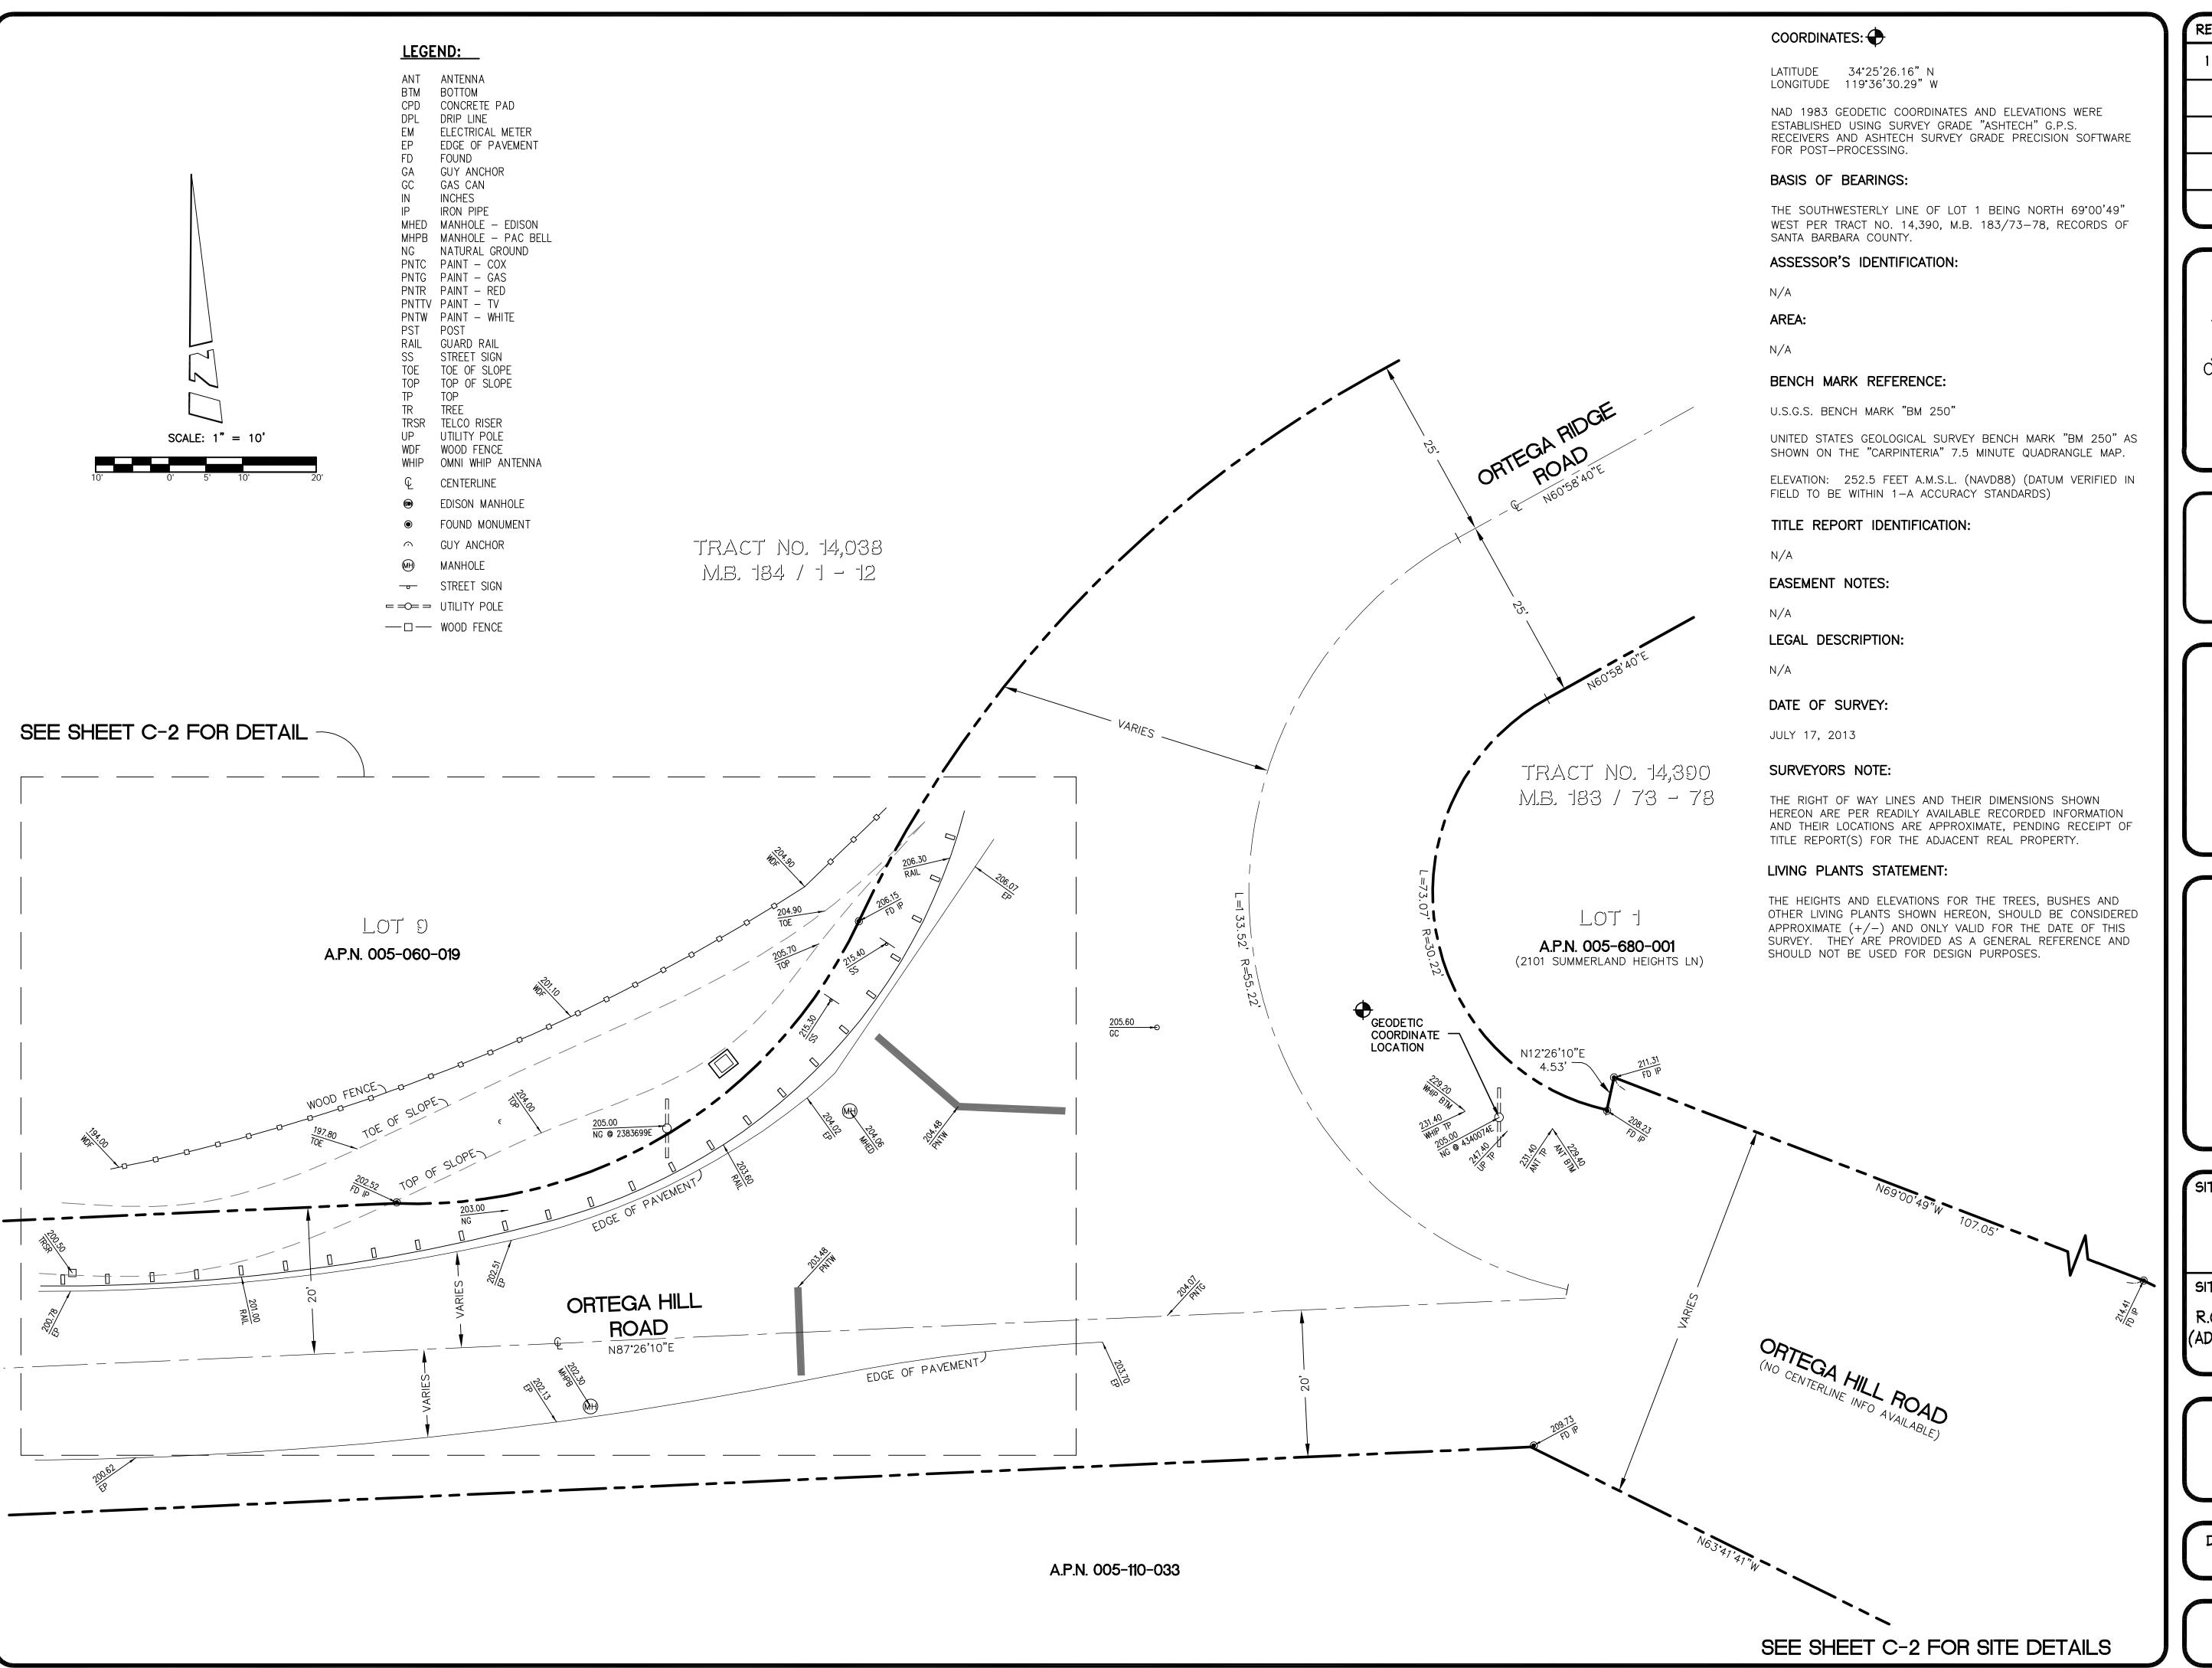

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1	07/24/13	ISSUED FOR REVIEW	
•	MDL		



CONSULTING CIVIL ENGINEERS

26455 RANCHO PKWY. SOUTH

LAKE FOREST, CA 92630-8326

(949) 753-8807 OFFICE - (949) 753-8833 FAX

SITE BUILDER:



SURVEYOR:

BERT HAZE

AND ASSOCIATES, INC.

LAND SURVEYING & MAPPING

3188 AIRWAY AVENUE, SUITE K1


COSTA MESA, CALIFORNIA 92626

714 557-1567 OFFICE

714 557-1568 FAX

JN. 706.226

STAMP:

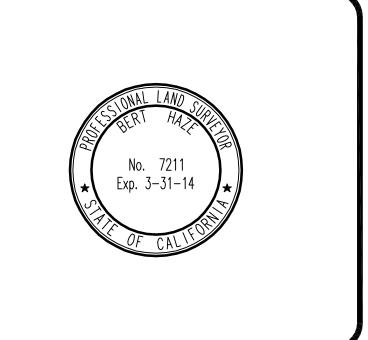

SITE INFO:

SITE NAME:

MON13 VERIZON MONTECITO-MON13

SITE ADDRESS:

R.O.W. EAST SIDE OF ORTEGA RIDGE RD (ADJACENT TO 2101 SUMMERLAND HEIGHTS LN) SANTA BARBARA, CA 93108

SHEET TITLE:

TOPOGRAPHIC SURVEY


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	MDL	
	REV:	



CONSULTING CIVIL ENGINEERS 26455 RANCHO PKWY. SOUTH

LAKE FOREST, CA 92630-8326 (949) 753-8807 OFFICE - (949) 753-8833 FAX

SITE BUILDER:

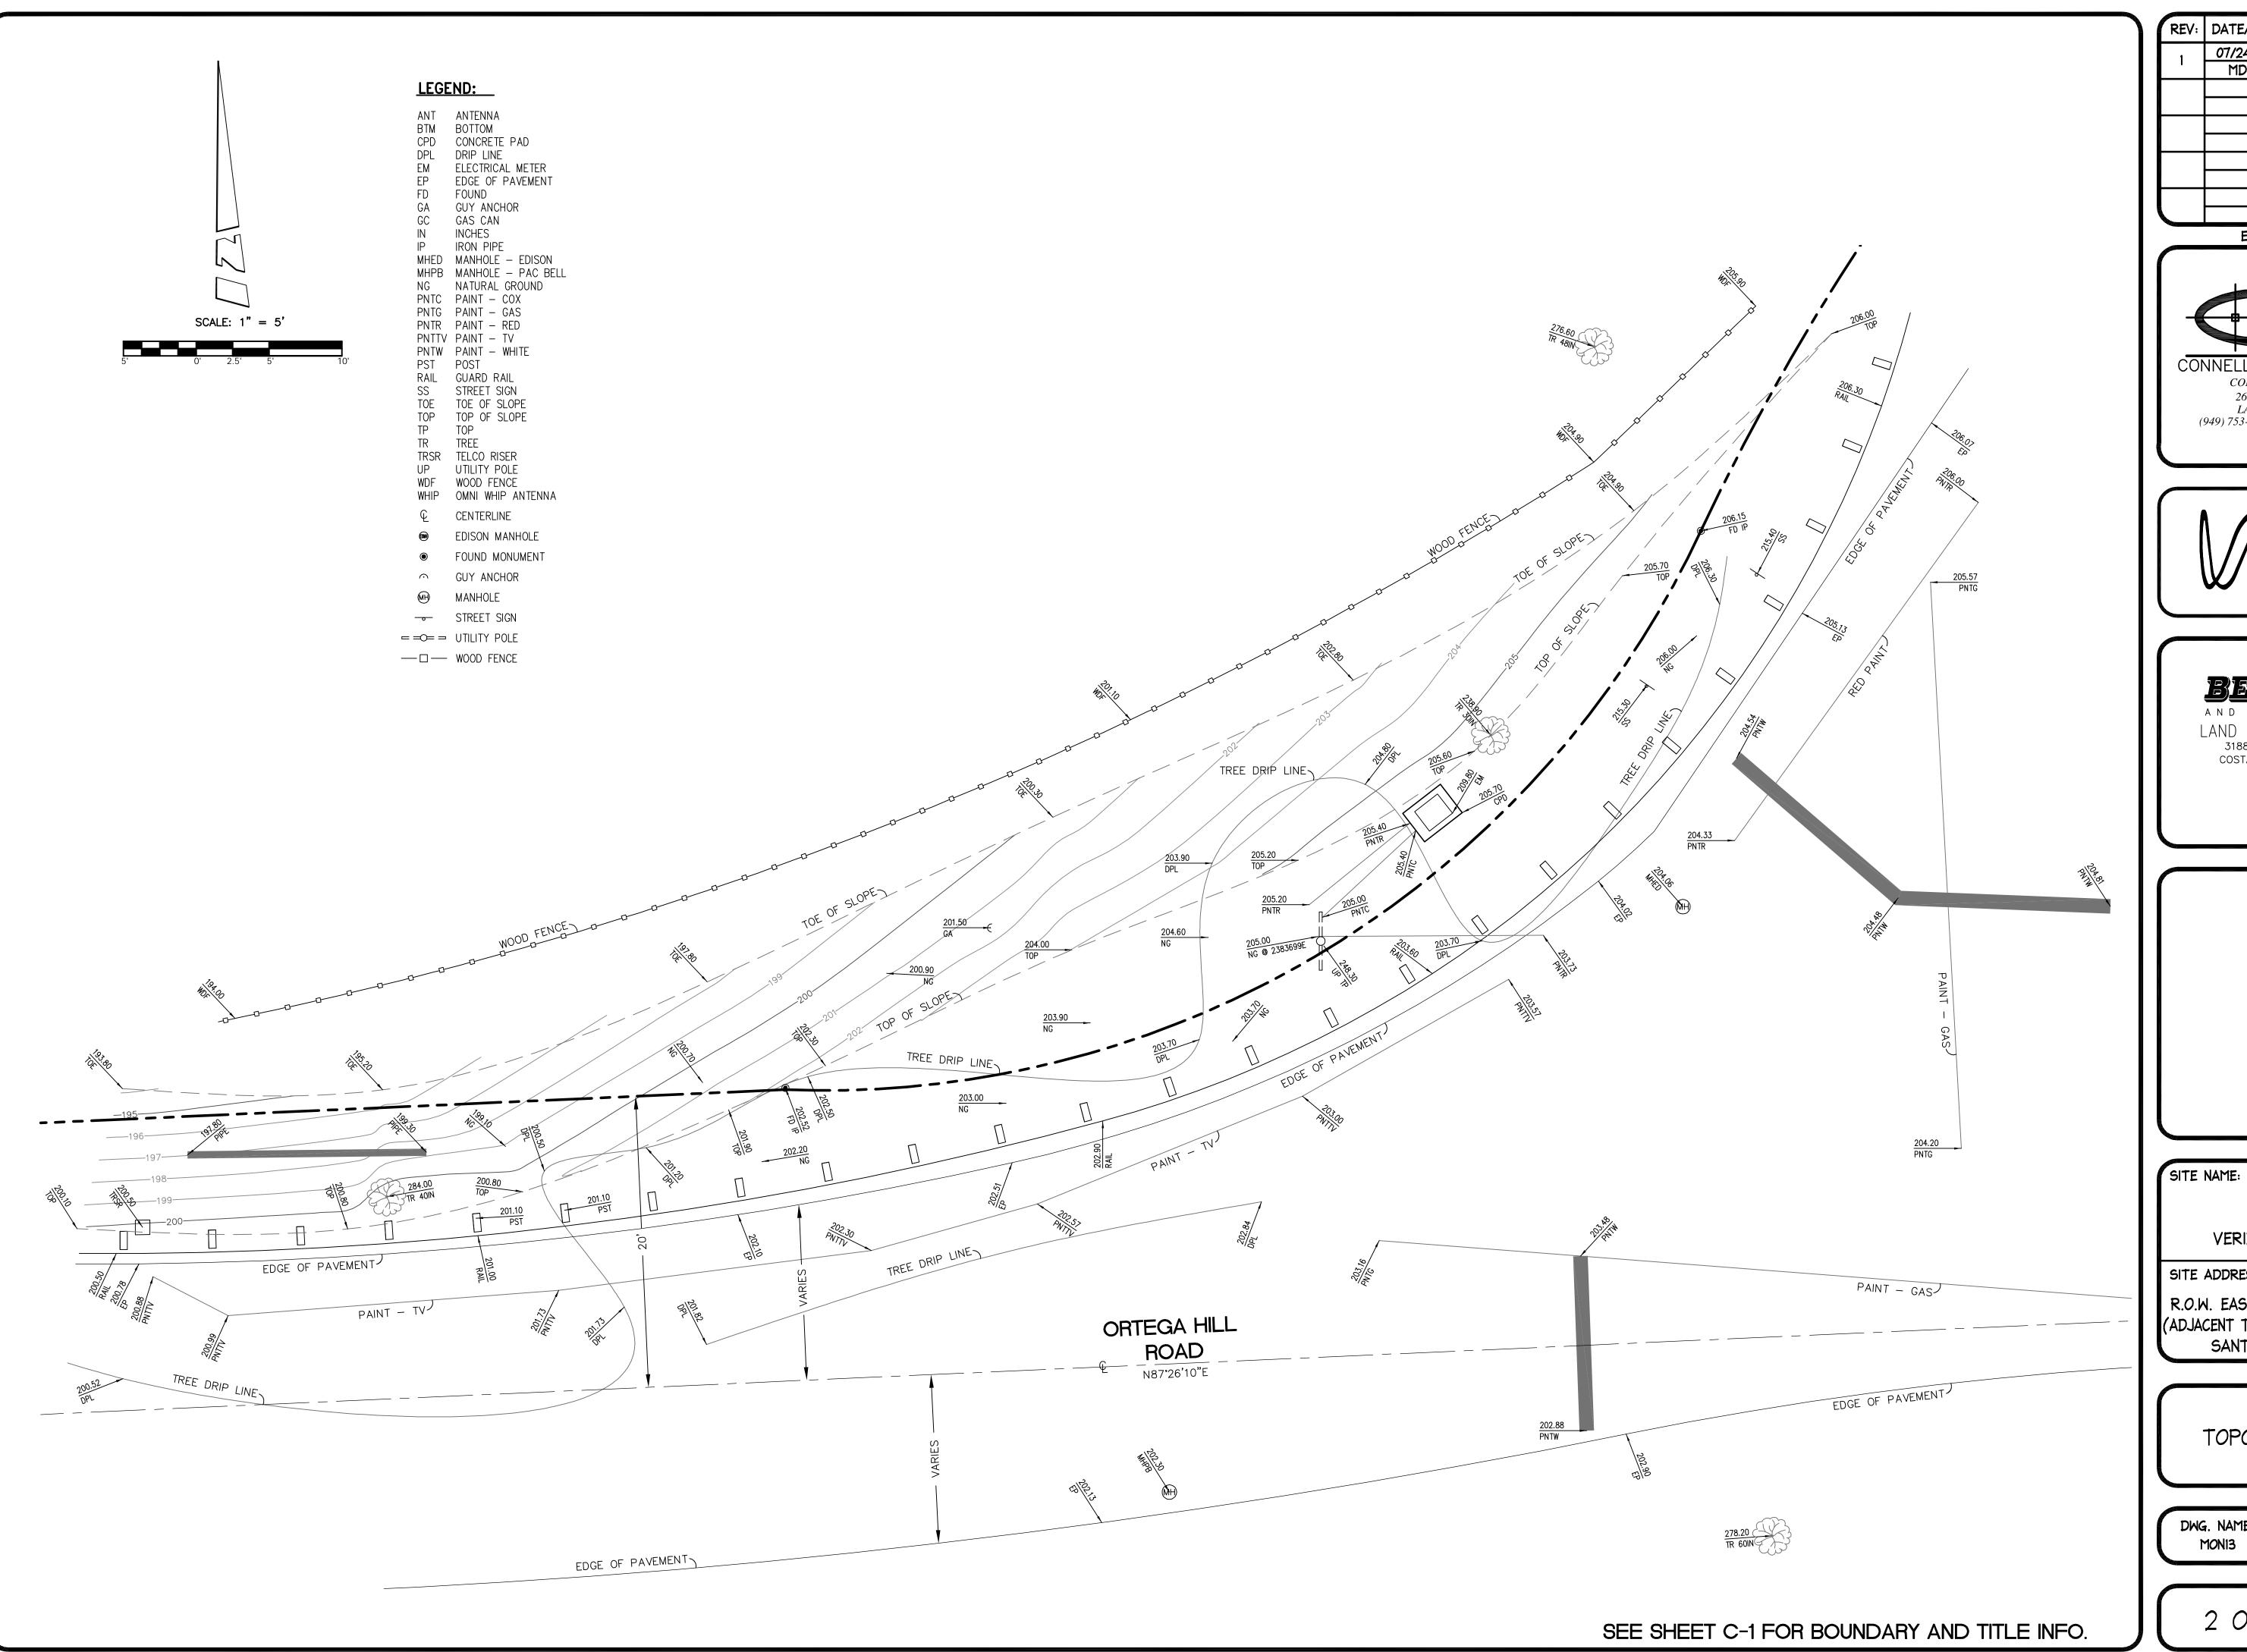


SURVEYOR:

AND ASSOCIATES, INC. LAND SURVEYING & MAPPING 3188 AIRWAY AVENUE, SUITE K1 COSTA MESA, CALIFORNIA 92626 714 557-1567 OFFICE 714 557-1568 FAX

JN. 706.226

STAMP:

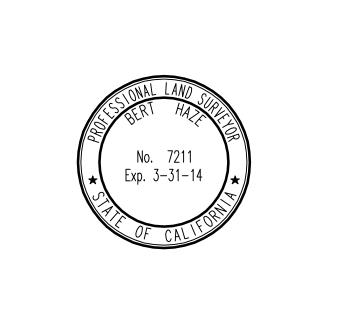

SITE INFO:

MON13 VERIZON MONTECITO-MONI3

SITE ADDRESS:

R.O.W. EAST SIDE OF ORTEGA RIDGE RD (ADJACENT TO 2101 SUMMERLAND HEIGHTS LN) SANTA BARBARA, CA 93108

SHEET TITLE:


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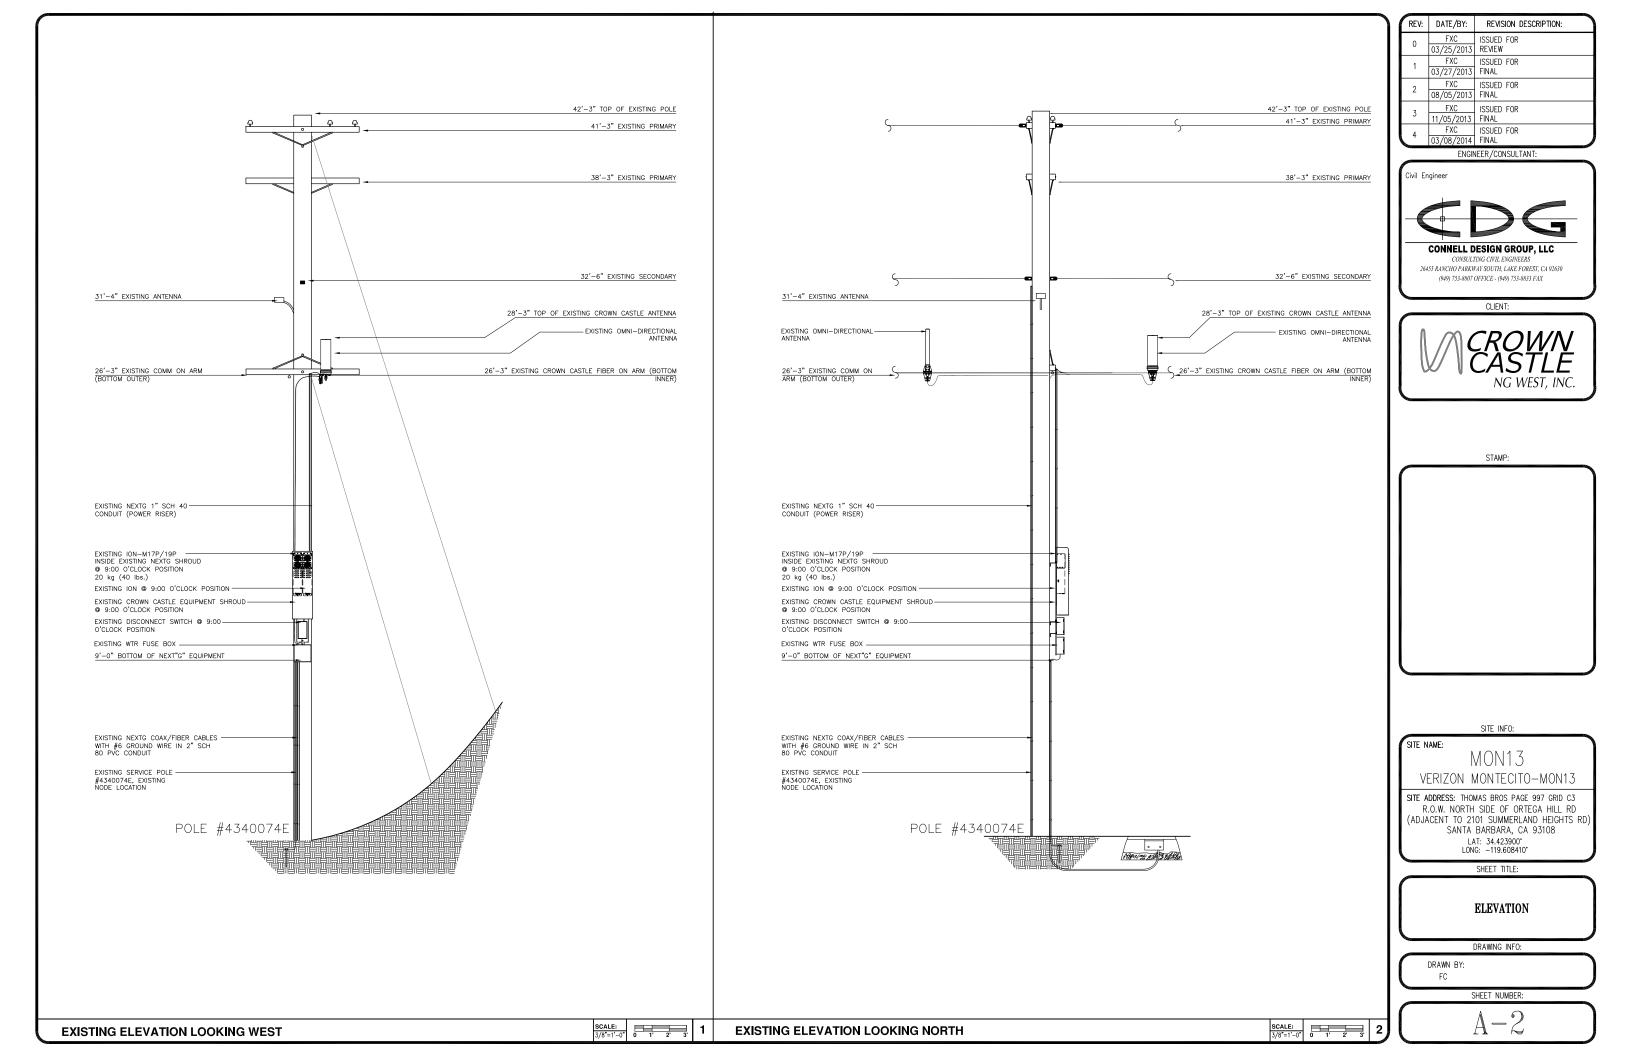
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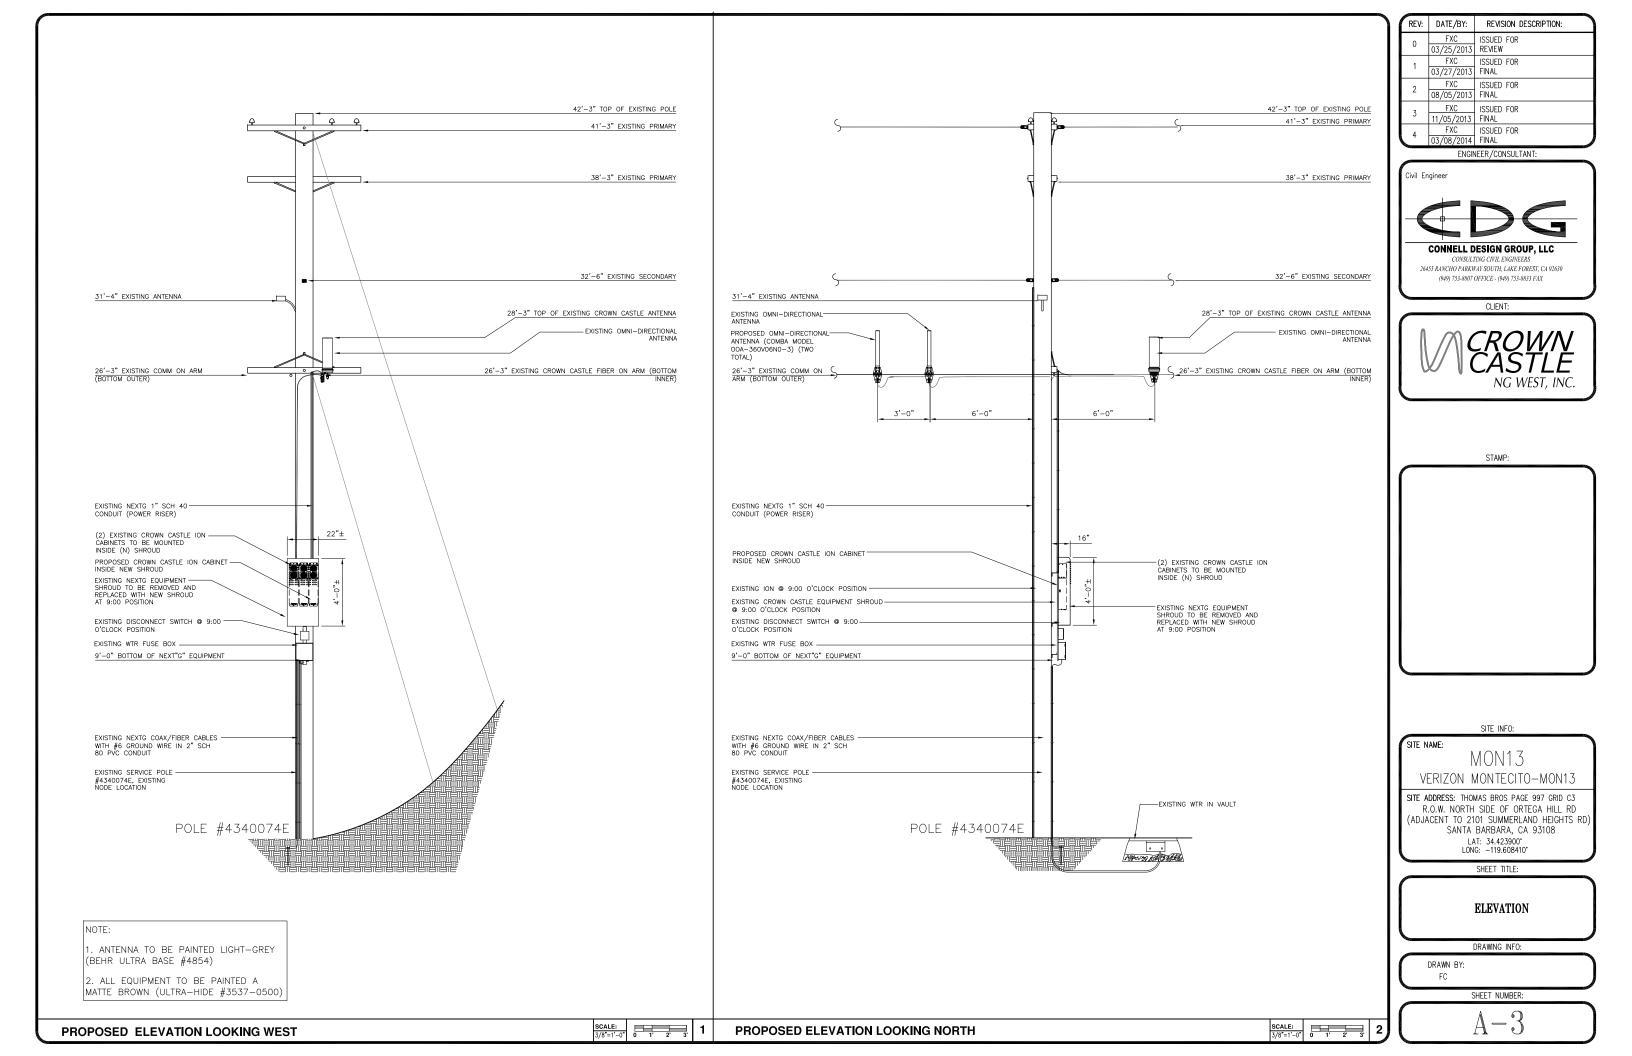
DWG. NAME:	DRAWN BY:	DATE:
MON13	MDL	07/24/13


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ENGINEER/CONSULTANT:



CONSULTING CIVIL ENGINEERS 26455 RANCHO PARKWAY SOUTH, LAKE FOREST, CA 92630

CLIENT:

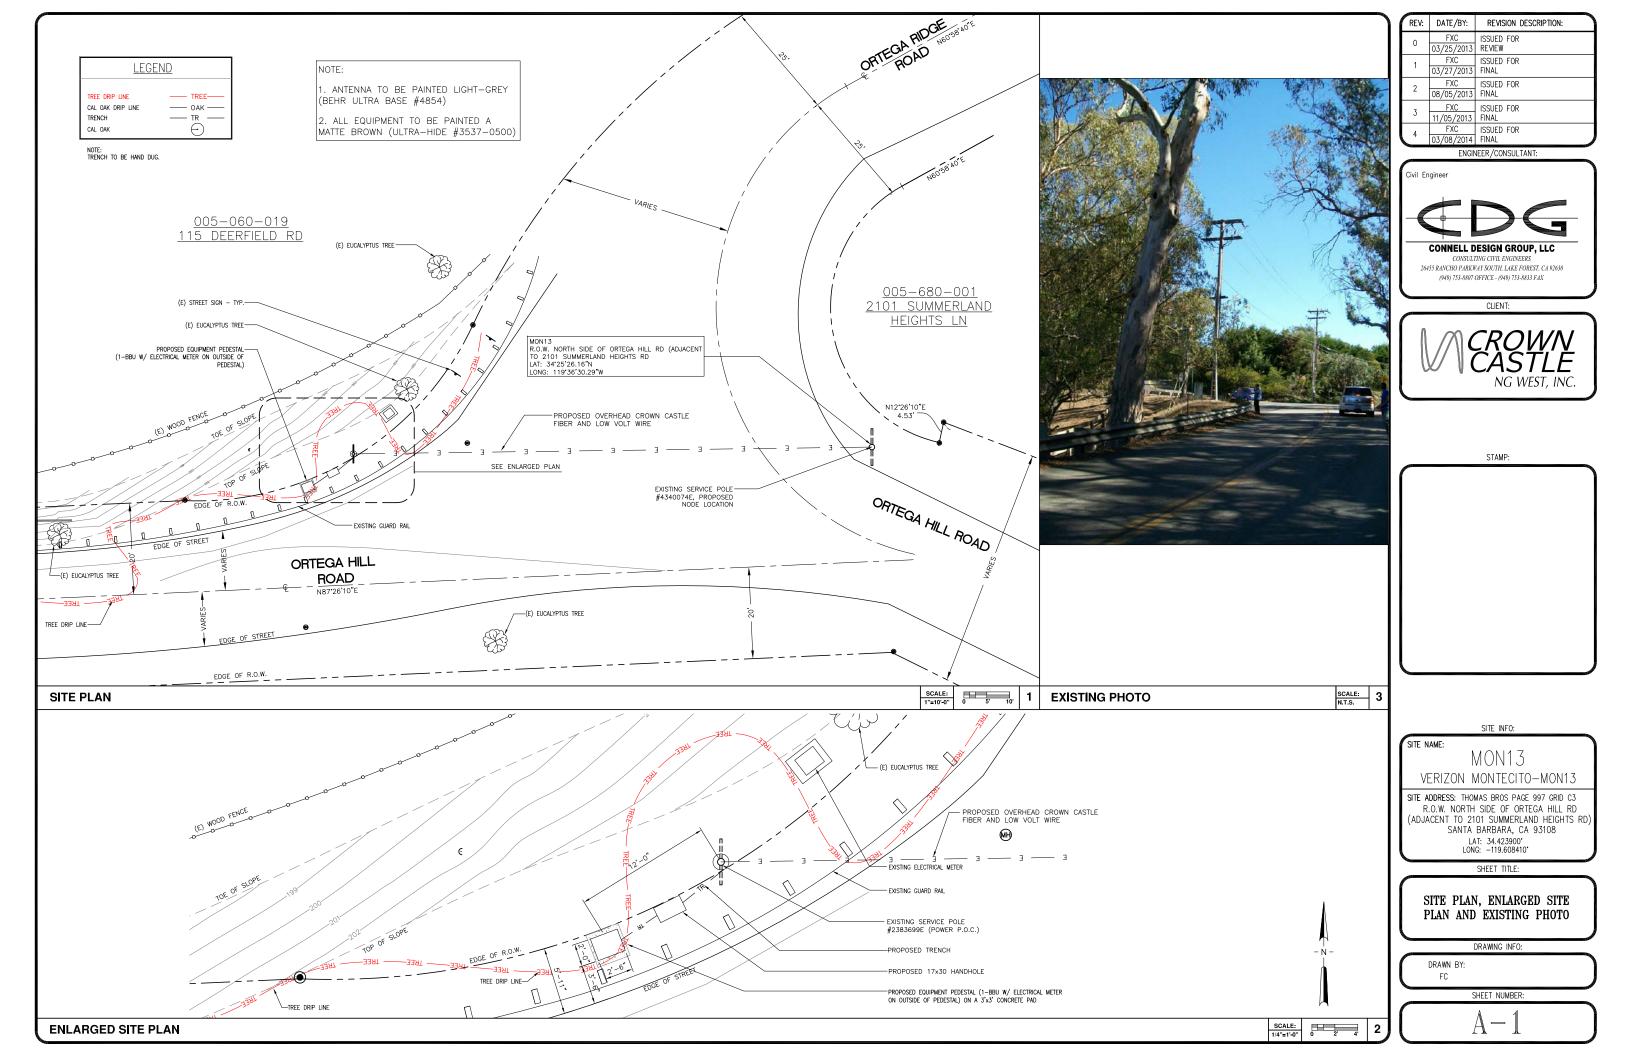

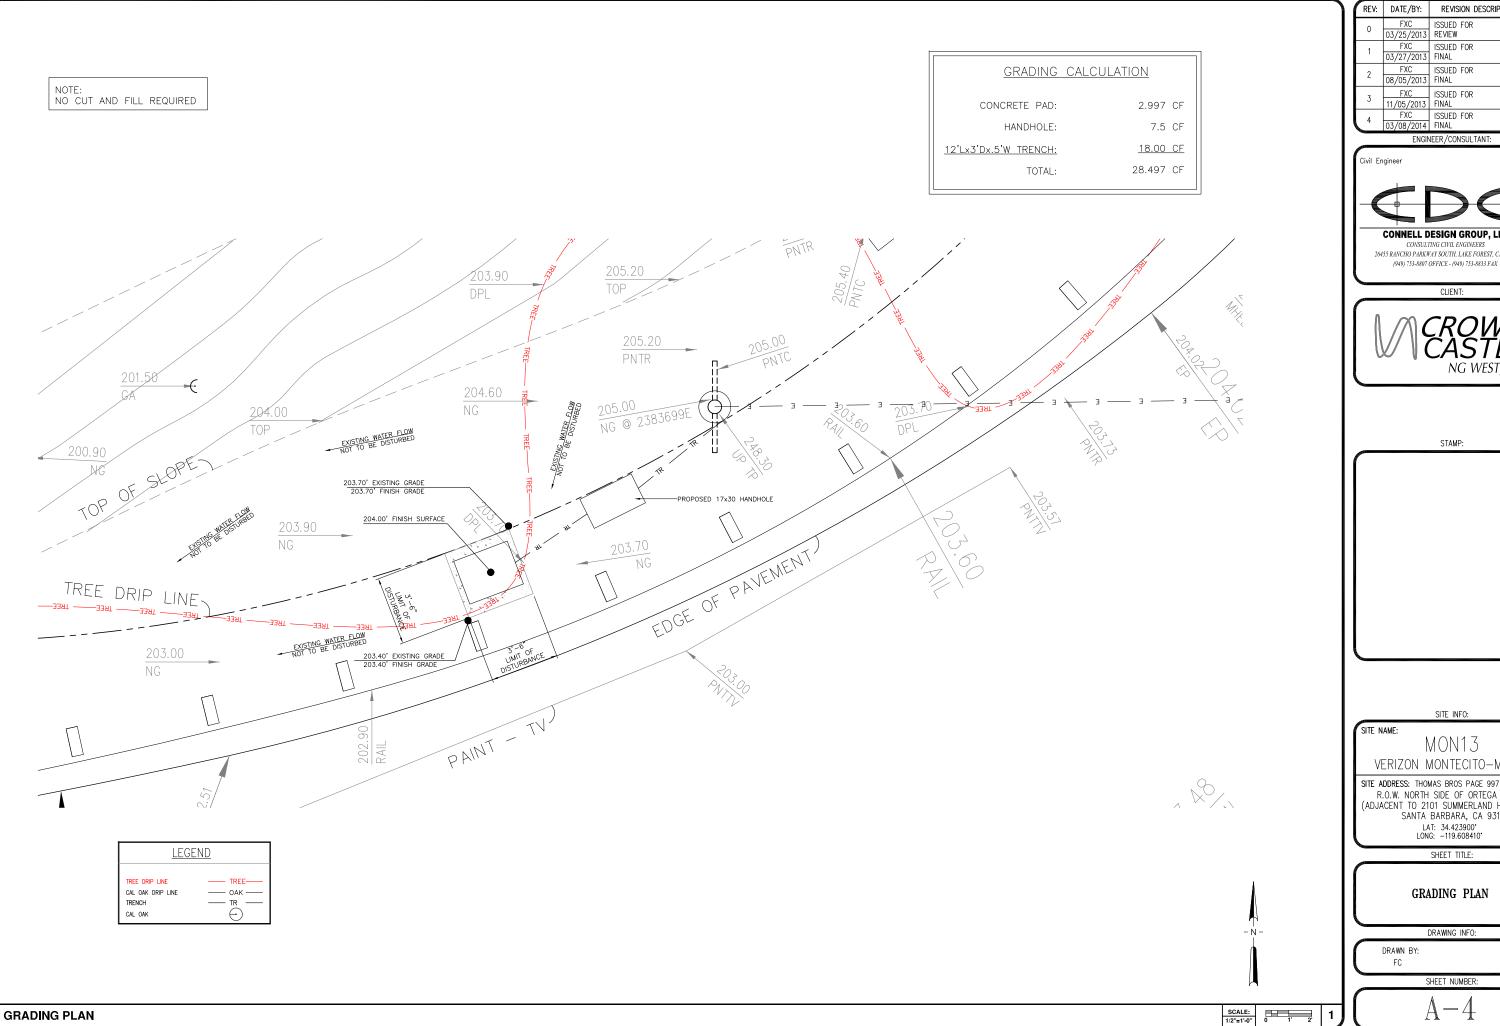STAMP:

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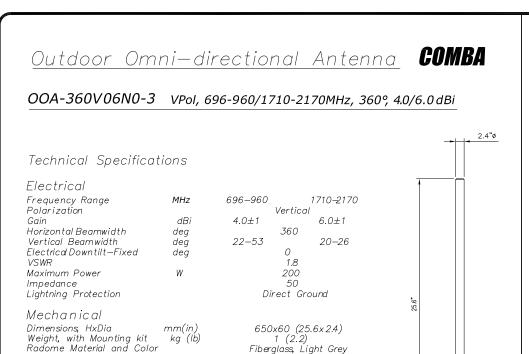
MON13 VERIZON MONTECITO-MON13

SITE ADDRESS: THOMAS BROS PAGE 997 GRID C3 R.O.W. NORTH SIDE OF ORTEGA HILL RD (ADJACENT TO 2101 SUMMERLAND HEIGHTS RD) SANTA BARBARA, CA 93108 LAT: 34.423900° LONG: -119.608410°

SHEET TITLE:

GRADING PLAN


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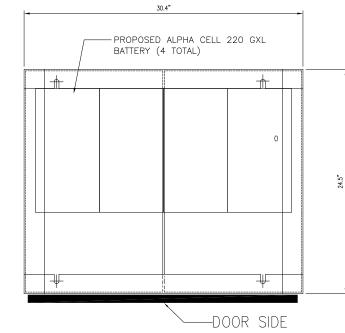



1 (2.2) Fiberglass Light Grey


Copper N-Female, Bottom

-55 to +70 95 200 (124) 670x100x100 (26.4x3.9x3.9) 1. 2 (2.65)



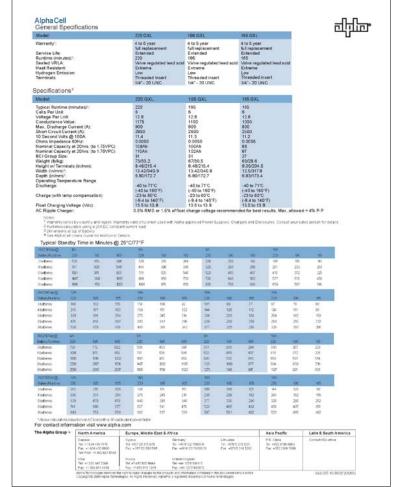

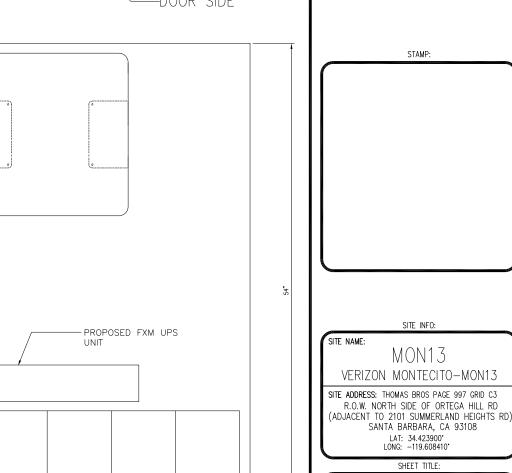

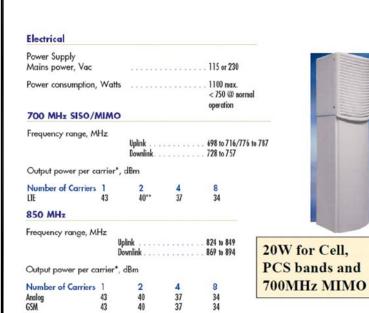

Radiating Element Material

ANTENNA SPECIFICATIONS

43

43

ION-M7P/7P/85P/19P

CDMA

40

37 37

Operational Humidity

Connector Type and Location Operational Temperature

Operational Wind Speed km/h (mph)
Shipping Dimensions, HxWxD mm (in)
Shipping Weight kg (lb)



1900 MHz GSM

Frequency range, MHz

1850 to 1915 1930 to 1995 Output power per carrier*, dBm

N.T.S.

LTE 40 *

CommScope[®]

ION-M7P/7P/85P/19P

Noise figure, dB

+6 max. 4.5 typical

40 (88.2)

1 BATTERY SPECIFICATIONS

Mechanical**** Height, width, depth, mm (in) 817 x 245 x 218 (32.2 x 9.6 x 8.6)

Page 1, February 27, 2013 Company Confidential

Weight, kg (lb)

NATIVE DIRT 3" DUCT

3

N.T.S.

COMPACTED TO 90% OR BETTER & REPLACE LANDSCAPING IN KIND.

* TRENCH TO BE BACK FILL WITH NATIVE MATERIAL &

PROPOSED ALPHA CELL 220 GXL-BATTERY (4 TOTAL)

FC

REV: DATE/BY:

FXC

Civil Engineer

REVISION DESCRIPTION:

ISSUED FOR

ISSUED FOR

ENGINEER / CONSULTANT:

CONNELL DESIGN GROUP, LLC

CONSULTING CIVIL ENGINEERS

26455 RANCHO PARKWAY SOUTH, LAKE FOREST, CA 92630

(949) 753-8807 OFFICE - (949) 753-8833 FAX

CLIENT:

03/25/2013 REVIEW

11/05/2013 FINAL

FXC ISSUED FOR


FXC ISSUED FOR 03/27/2013 FINAL FXC ISSUED FOR 08/05/2013 FINAL

SHEET NUMBER:

DETAILS

DRAWING INFO:

N.T.S. 2 TRENCH **EQUIPMENT PEDESTAL** N.T.S. N.T.S.

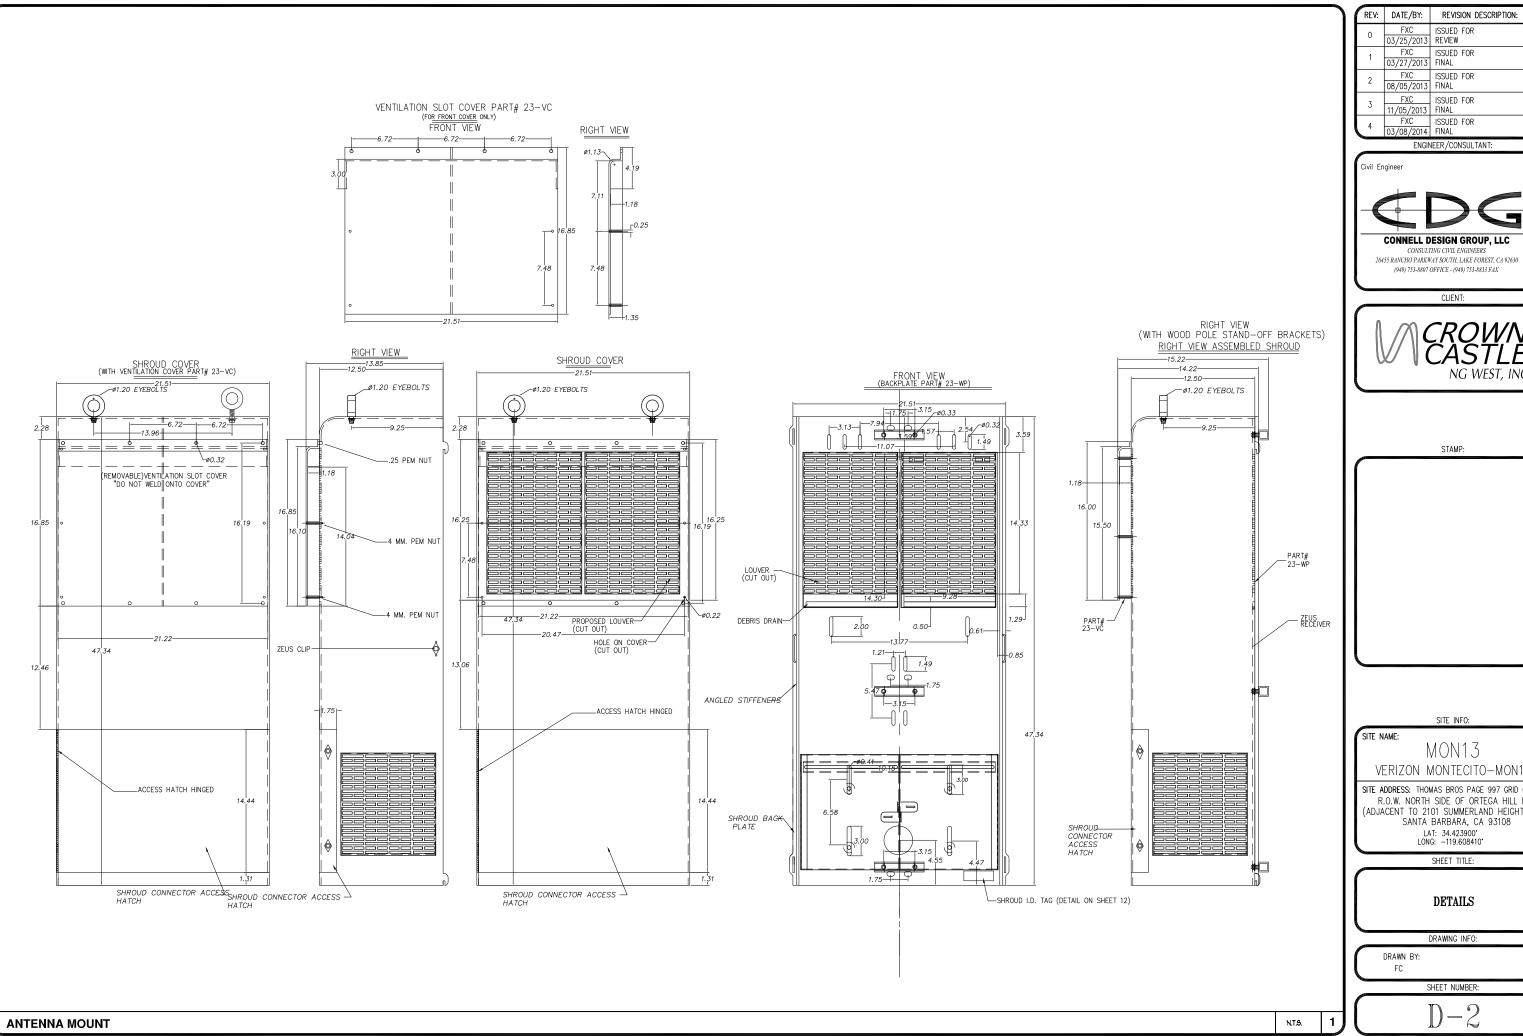

	REV:	DATE/BY:	REVISION DESCRIPTION:
l	0	FXC 03/25/2013	ISSUED FOR REVIEW
l	1	FXC 03/27/2013	ISSUED FOR FINAL
l	2	FXC 08/05/2013	ISSUED FOR FINAL
l	3	FXC 11/05/2013	ISSUED FOR FINAL
L	4	FXC	ISSUED FOR






MON13

VERIZON MONTECITO-MON13

SITE ADDRESS: THOMAS BROS PAGE 997 GRID C3 R.O.W. NORTH SIDE OF ORTEGA HILL RD (ADJACENT TO 2101 SUMMERLAND HEIGHTS RD) SANTA BARBARA, CA 93108

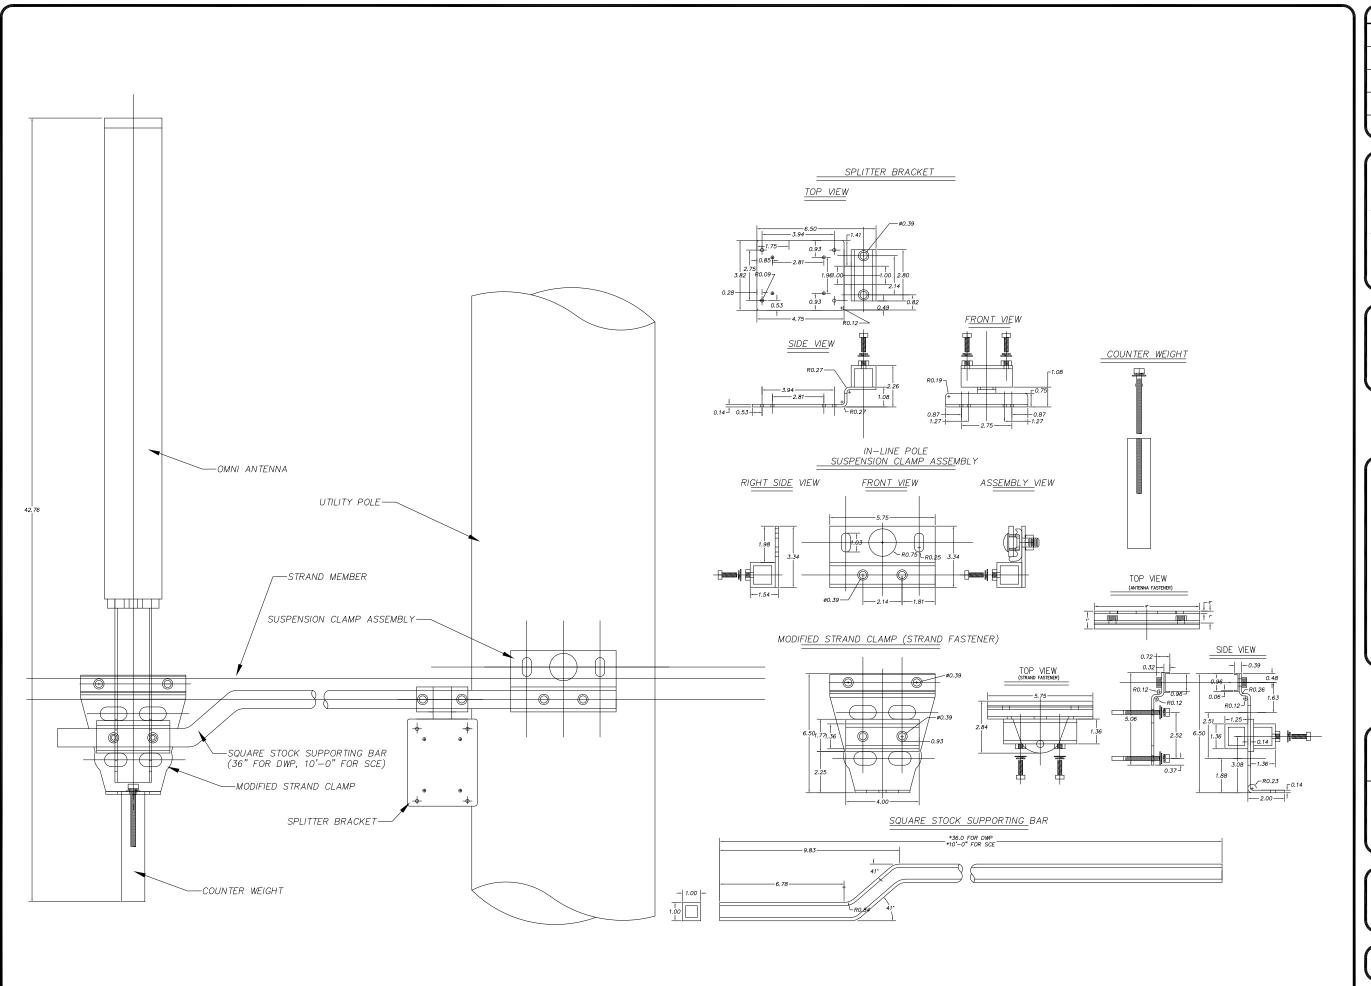

ANTENNA MOUNT

REV:	DATE/BY:	REVISION DESCRIPTION:
0	FXC 03/25/2013	ISSUED FOR REVIEW
1	FXC 03/27/2013	ISSUED FOR FINAL
2	FXC 08/05/2013	ISSUED FOR FINAL
3	FXC 11/05/2013	ISSUED FOR FINAL
4	FXC 03/08/2014	ISSUED FOR FINAL

ENGINEER/CONSULTANT:

Civil Engineer

CONNELL DESIGN GROUP, LLC

CONSULTING CIVIL ENGINEERS 26455 RANCHO PARKWAY SOUTH, LAKE FOREST, CA 92630 (949) 753-8807 OFFICE - (949) 753-8833 FAX

CLIENT:



STAMP:

SITE INFO:

SITE NAME: MON13

VERIZON MONTECITO-MON13

SITE ADDRESS: THOMAS BROS PAGE 997 GRID C3 R.O.W. NORTH SIDE OF ORTEGA HILL RD (ADJACENT TO 2101 SUMMERLAND HEIGHTS RD) SANTA BARBARA, CA 93108 LAT: 34,423900° LONG: -119.608410°

SHEET TITLE:

DETAILS

DRAWING INFO:

RAWN BY: FC

SHEET NUMBER:

D-3

- . APPROVAL OF THESE PLANS BY THE CITY ENGINEER DOES NOT AUTHORIZE ANY WORK TO BE PERFORMED UNTIL A PERMIT HAS
- 2. UPON ISSUANCE OF A PERMIT, NO WORK WILL BE PERMITTED ON WEEKENDS OR HOLIDAYS WITHOUT PERMISSION FROM THE
- 3. THE APPROVAL OF THIS PLAN OR ISSUANCE OF A PERMIT BY THE LOCAL JURISDICTION DOES NOT AUTHORIZE THE SUBDIVIDER AND OWNER TO VIOLATE ANY FEDERAL, STATE OR CITY LAWS, ORDINANCES, REGULATIONS, OR POLICIES, INCLUDING, BUT NOT LIMITED TO, THE FEDERAL ENDANGERED SPECIES ACT OF 1973 AND AMENDMENTS THERETO (16 USC SECTION 1531 ET.SEQ.)
- 4. THE CONTRACTOR SHALL BE RESPONSIBLE FOR SURVEY MONUMENTS AND/OR VERTICAL CONTROL BENCHMARKS WHICH ARE DISTURBED OR DESTROYED BY CONSTRUCTION. A LAND SURVEYOR MUST FIELD LOCATE, REFERENCE, AND/OR PRESERVE ALL HISTORICAL OR CONTROLLING MONUMENTS PRIOR TO ANY FARTHWORK. IF DESTROYED, SUCH MONUMENTS SHALL BE REPLACED WITH APPROPRIATE MONUMENTS BY A LAND SURVEYOR, A CORNER RECORD OR RECORD OF SURVEY, AS APPROPRIES, SHALL BE FIELD AS REQUIRED BY THE PROFESSIONAL LAND SURVEYORS ACT. IF ANY VERTICAL CONTROL IS TO BE DISTURBED OR DESTROYED, THE LOCAL JURISDICTION FIELD SURVEY SECTION MUST BE NOTIFIED, IN WRITING, AT LEAST 3 DAYS PRIOR TO THE CONSTRUCTION. THE CONTRACTOR WILL BE RESPONSIBLE FOR THE COST OF REPLACING ANY VERTICAL CONTROL BENCHMARKS
- 5. IMPORTANT NOTICE: SECTION 4216 OF THE GOVERNMENT CODE REQUIRES A DIG ALERT IDENTIFICATION NUMBER BE ISSUED BEFORE A "PERMIT TO EXCAVATE" WILL BE VALID. FOR YOUR DIG ALERT I.D. NUMBER, CALL UNDERGROUND SERVICE ALERT, TWO
- 6. CONTRACTOR SHALL BE RESPONSIBLE FOR THE POTHOLE AND LOCATING OF ALL EXISTING UTILITIES THAT CROSS THE PROPOSED TRENCH LINE AND MUST MAINTAIN 1' MINIMUM VERTICAL CLEARANCE.
- 7. CONTRACTOR SHALL SUBMIT TO THE LOCAL JURISDICTION, A CONSTRUCTION PLAN TO PROTECT WATER MAINS PRIOR TO COMMENCING CONSTRUCTION.
- 8. CONTRACTOR SHALL REPLACE OR REPAIR ALL TRAFFIC SIGNAL LOOPS, CONDUIT, AND LANE STRIPING DAMAGED DURING
- 9. CONTRACTOR SHALL NOTIFY THE LOCAL JURISDICTION. A MINIMUM OF 48 HOURS PRIOR TO COMMENCING WORK WITHIN 10' OF
- 10. THIS PROJECT WILL BE INSPECTED BY ENGINEERING AND CAPITAL PROJECTS DEPARTMENT, FIELD ENGINEERING DIVISION.
- 11. AS-BUILT DRAWINGS MUST BE SUBMITTED TO THE CITY RESIDENT ENGINEER PRIOR TO THE ACCEPTANCE OF THIS PROJECT. 12. PUBLIC IMPROVEMENT SUBJECT TO DESUETUDE OR DAMAGE." IF REPAIR OR REPLACEMENT OF SUCH PUBLIC IMPROVEMENTS IS REQUIRED, THE OWNER SHALL OBTAIN THE REQUIRED PERMITS FOR WORK IN THE PUBLIC RIGHT-OFWAY, SATISFACTORY TO THE PERMIT - ISSUING AUTHORITY.
- 13. PRIOR TO ANY DISTURBANCE TO THE SITE, EXCLUDING UTILITY MARKS-OUTS AND SURVEYING, THE CONTRACTOR SHALL MAKE ARRANGEMENTS FOR A PRE-CONSTRUCTION MEETING WITH THE LOCAL JURISDICTION FIELD ENGINEERING DIVISION.
- 14. PRIOR TO THE COMMENCEMENT OF ANY CONSTRUCTION SHOWN ON THESE PLANS. IT IS THE SOLE RESPONSIBILITY OF THE CONTRACTOR TO COORDINATE. THE CONTRACTOR IS RESPONSIBLE TO ATTEND THE LOCAL JURISDICTIONS MONTHLY UTILITY COORDINATION COMMITTEE THE CONSTRUCTION ACTIVITIES WITH THE CITY AND ALL OTHER CONTRACTORS SO THAT NO TRENCH IS CUT WITHIN ANY OF THE CITY STREETS THAT HAVE BEEN CONSTRUCTED, REPAIRED, OR SLURRY SEALED WITHIN THREE YEARS OF THE STREET CONSTRCTUION/RESURFACING DATE.
- 15. MANHOLES OR COVERS SHALL BE LABELED "CROWN CASTLE" OR "CROWN CASTLE NG WEST".
- 16 CONTRACTOR SHALL IMPLEMENT AN EROSION AND SEDIMENT CONTROL PROCRAM DURING THE PROJECT CONSTRUCTION ACTIVITIES PROGRAM SHALL MEET THE APPLICABLE REQUIREMENTS OF THE STATE WATER RESOURCE CONTROL BOAR
- 17. THE CONTRACTOR SHALL HAVE EMERGENCY MATERIALS AND EQUIPMENT ON HAND FOR UNFORESEEN SITUATIONS, SUCH AS DAMAGE TO UNDERGROUND WATER, SEWER, AND STORM DRAIN FACILITIES WHEREBY FLOWS MAY GENERATE EROSION AND SEDIMENT

SPECIAL NOTES

THE FOLLOWING NOTES ARE PROVIDED TO GIVE DIRECTIONS TO THE CONTRACTOR BY THE ENGINEER OF WORK. THE CITY ENGINEER'S SIGNATURE ON THESE PLANS DOES NOT CONSTITUTE APPROVAL OF THESE NOTES AND THE CITY WILL NOT BE RESPONSIBLE FOR THEIR ENFORCEMENT.


- THE CONTRACTOR SHALL VERIFY THE LOCATION EXISTING UNDERGROUND UTILITIES INCLUDING SEWER LATERALS AND WATER SERVICES TO INDIVIDUAL LOTS BOTH VERTICAL AND HORIZONTAL PRIOR TO COMMENCING IMPROVEMENT OPERATIONS.
- 2. CONTRACTOR SHALL MAKE EXPLORATION EXCAVATIONS AND LOCATE EXISTING FACILITIES SUFFICIENTLY AHEAD OF CONSTRUCTION TO PERMIT REVISIONS OF PLANS IF REVISION IS NECESSARY BECAUSE OF LOCATION OF EXISTING UTILITIES.
- 3. LOCATION AND ELEVATIONS OF IMPROVEMENTS, TO BE MET BY WORK, SHALL BE CONFIRMED BY FIELD MEASUREMENT PRIOR TO
- 4. GRADES SHOWN ARE FINISH GRADES, CONTRACTOR SHALL DETERMINE NECESSARY SUB GRADE ELEVATIONS AND SHALL CONSTRUCT SMOOTH TRANSITION BETWEEN FINISH GRADES SHOWN.
- CONTRACTOR AGREES THAT HE SHALL ASSUME SOLE RESPONSIBILITY FOR JOB SITE CONDITION DURING THE COURSE OF CONSTRUCTION OF THIS PROJECT, INCLUDING SAFETY OF ALL PERSONS AND PROPERTY: THAT THIS PROVISION SHALL APPLY CONTINUOUSLY AND NOT BE LIMITED TO NORMAL WORKING HOURS; AND THAT THE CONTRACTOR SHALL DEFEND, INDEMNIFY AND HOLD THE OWNER AND THE ENGINEER HARMLESS FROM ANY AND ALL LIABILITY, REAL OR ALLEGED IN CONNECTION WITH THE PERFORMANCE OF WORK ON THIS PROJECT, EXPECTING FOR LIABILITY ARISING FROM SOLE NEGLIGENCE OF THE OWNER OR THE
- 6. THE CONTRACTOR SHALL BE TOTALLY RESPONSIBLE FOR COMPLIANCE WITH THE PROVISIONS OF THE STATE OF CALIFORNIA SAFETY
- 7. THE LOCATIONS OF ALL EXISTING UTILITIES SHOWN ON THESE PLANS ARE FROM EXISTING RECORDS AND CORROBORATED, WHERE POSSIBLE WITH FIELD TIES. THE CONTRACTOR IS RESPONSIBLE FOR CONFIRMING THE LOCATIONS SHOWN, BOTH HORIZONTALLY AND VERTICALLY, PRIOR TO CONSTRUCTION. IF EXISTING LOCATIONS VARY SUBSTANTIALLY FROM THE PLANS, THE ENGINEER SHOULD BE NOTIFIED TO MAKE ANY CONSTRUCTION CHANGES REQUIRED.
- 8. THE CONTRACTOR SHALL PROVIDE TEMPORARY SUPPORT FOR ALL SEWER AND WATER MAIN UNDER CROSSING IN ACCORDANCE WITH PART 1 SECTION 5-2 OF THE STANDARD SPECIFICATION.
- 9. THE CONTRACTOR SHALL REPLACE OR REPAIR ALL TRAFFIC SIGNAL LOOPS, CONDUITS, AND LANE STRIPING DAMAGED DURING
- 10. THE CONTRACTOR SHALL SUBMIT WORK PLANS FOR ALL BORE OPERATIONS TWO WEEKS PRIOR TO COMMENCING WORK.
- 11. CONTRACTOR SHALL BE RESPONSIBLE FOR THE POTHOLE AND LOCATING OF ALL EXISTING UTILITIES THAT CROSS THE PROPOSED
- 12. AS-BUILT DRAWINGS MUST BE SUBMITTED TO THE CITY ENGINEER PRIOR TO ACCEPTANCE OF THIS PROJECT




CONSTRUCTION CHANGE TABLE CHANGE DATE EFFECTED OR ADDED SHEET NUMBERS

CROWN CASTLE NG WEST, INC

VERIZON MONTECITO-MON14 R.O.W. NORTH SIDE OF JAMESON LN (ADJACENT TO 1930 JAMESON LN) SANTA BARBARA, CA 93108

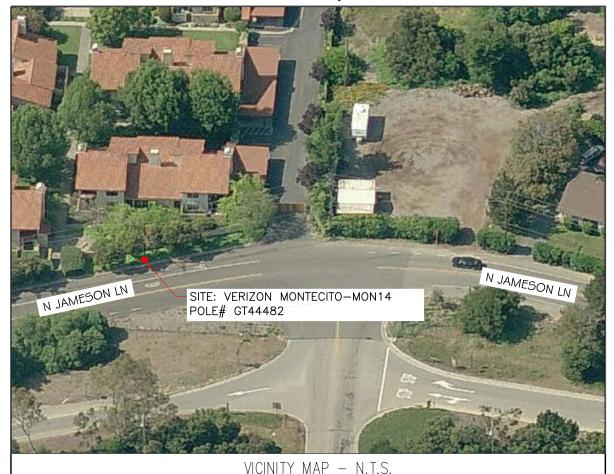

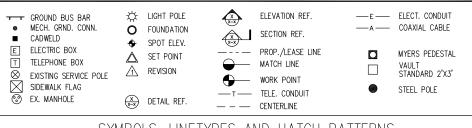

SYMBOLS, LINETYPES AND HATCH PATTERNS

APPLICABLE CODES

ALL WORK SHALL COMPLY WITH THE FOLLOWING APPLICABLE CODES:

- IN THE EVENT OF CONFLICT, THE MOST RESTRICTIVE CODE SHALL PREVAIL

PROJECT DESCRIPTION

- PROJECT CONSISTS OF INSTALLATION OF:
- 1. (2) OMNI DIRECTIONAL ANTENNA ON EXISTING UTILITY POLE 2. EQUIPMENT VAULT AT BASE OF EXISTING POLE
- 3. EQUIPMENT PEDESTAL W/ BBU AND ELECTRICAL METER AT BASE OF

SHEET INDEX: TITLE SHEET - SHEET 1 OF 8 TOPOGRAPHIC SURVEY C-1 - SHFFT 2 OF 8 - SHEET 3 OF 8 - SHEET 4 OF 8 SITE PLAN PROPOSED FLEVATIONS GRADING PLAN - SHEET 5 OF 8 - SHEET 6 OF 8 DETAILS DETAILS DETAILS D-3 - SHEET 8 OF 8

EROSION AND SEDIMENT CONTROL NOTES

TEMPORARY EROSION/SEDIMENT CONTROL, PRIOR TO COMPLETION OF FINAL IMPROVEMENTS. SHALL BE PERFORMED BY THE CONTRACTOR OR QUALIFIED PERSON AS INDICATED BELOW:

- 1. ALL REQUIREMENTS OF THE LOCAL JURISDICTION "LAND DEVELOPMENT MANUAL, STORM WATER STANDARDS" MUST BE INCORPORATED INTO THE DESIGN AND CONSTRUCTION OF THE PROPOSED GRADING/IMPROVEMENTS CONSISTENT WITH THE APPROVED STORM WATER AND/OR WATER POLLUTION CONTROL PLAN (WPCP).
- 2. FOR STORM DRAIN INLETS, PROVIDE A GRAVEL BAG SILT BASIN IMMEDIATELY UPSTREAM OF INLET AS INDICATED ON DETAILS.
- 3. FOR INLETS LOCATED AT SUMPS ADJACENT TO TOP OF SLOPES, THE CONTRACTOR SHALL ENSURE THAT WATER DRAINING TO THE SUMP IS DIRECTED INTO THE INLET AND THAT A MINIMUM OF 1.00" FREEBOARD EXISTS AND IS MAINTAINED ABOVE THE TOP OF THE INLET. IF FREEBOARD IS NOT PROVIDED BY GRADING SHOWN ON THESE PLANS, THE CONTRACTOR SHALL PROVIDE IT VIA TEMPORARY MEASURES, I.E. GRAVEL BAGS OR DIKES.
- 4. THE CONTRACTOR OR QUALIFIED PERSON SHALL BE RESPONSIBLE FOR CLEANUP OF SILT AND MUD ON ADJACENT STREET(S) AND STORM DRAIN SYSTEM DUE TO CONSTRUCTION
- 5. THE CONTRACTOR OR QUALIFIED PERSON SHALL CHECK AND MAINTAIN ALL LINED AND UNLINED DITCHES AFTER EACH RAINFALL.
- 6. THE CONTRACTOR SHALL REMOVE SILT AND DEBRIS AFTER EACH MAJOR RAINFALL.
- EQUIPMENT AND WORKERS FOR EMERGENCY WORK SHALL BE MADE AVAILABLE AT ALL TIMES DURING THE RAINY SEASON, ALL NECESSARY MATERIALS SHALL BE STOCKPILED ON SITE AT CONVENIENT LOCATIONS TO FACILITATE RAPID CONSTRUCTION OF TEMPORARY DEVICES WHEN RAIN IS IMMINENT.
- 8. THE CONTRACTOR SHALL RESTORE ALL EROSION/SEDIMENT CONTROL MEASURES TO WORKING ORDER TO THE SATISFACTION OF THE CITY ENGINEER OR RESIDENT ENGINEER AFTER EACH RUN-OFF PRODUCING RAINFALL.
- THE CONTRACTOR SHALL INSTALL ADDITIONAL EROSION CONTROL MEASURES AS MAY BE REQUIRED BY THE RESIDENT ENGINEER DUE TO UNCOMPLETED GRADING OPERATIONS OR UNFORESEEN CIRCUMSTANCES, WHICH MAY ARISE.
- 10. THE CONTRACTOR SHALL BE RESPONSIBLE AND SHALL TAKE NECESSARY PRECAUTIONS TO PREVENT PUBLIC TRESPASS ONTO AREAS WHERE IMPOUNDED WATERS CREATE A HAZARDOUS CONDITION.
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- APRIL 30TH FOR PROJECT TEAM (GENERAL CONTRACTOR, QUALIFIED PERSON, EROSION CONTROL SUBCONTRACTOR IF ANY, ENGINEER OF WORK, OWNER AND THE RESIDENT ENGINEER) TO EVALUATE THE ADEQUACY OF THE EROSION/SEDIMENT CONTROL MEASURES AND OTHER RELATED CONSTRUCTION ACTIVITIES.

TRAFFIC CONTROL NOTES

THE CONTRACTOR SHALL SUBMIT A TRAFFIC CONTROL PLAN (11" X 17") FOR APPROVAL PRIOR TO STARTING WORK. THE PLAN SHOULD BE SUBMITTED TO THE TRAFFIC CONTROL PERMIT COUNTER. CONTRACTOR SHALL OBTAIN A TRAFFIC CONTROL PERMIT A MINIMUM OF TWO (2) WORKING DAYS PRIOR TO STARTING WORK, AND A MINIMUM FIVE (5) DAYS IF WORK WILL AFFECT A BUS STOP OR AN EXISTING TRAFFIC SIGNAL, OR IF WORK WILL REQUIRE A

FOOTAGE TOTALS		
ASPHALT CUT	-	
DIRT TRENCH	-	
PUNCH THRU	-	
BORE	-	
TOTAL	=	
R&R SWF TOTAL	-	

PROJECT DICTIONARY

R.O.W. NORTH SIDE OF JAMESON LN SITE ADDRESS: (ADJACENT TO 1930 JAMESON LN) SANTA BARBARA, CA 93108

CROWN CASTLE NG WEST, INC 2125 WRIGHT AVE. SUITE #C9 APPLICANT: LA VERNE, CA 91750 CONTACT: HEIDI PAYNE

PHONE: (949) 300-9493 CIVIL ENGINEER:

CONNELL DESIGN GROUP, LLC 26455 RANCHO PARKWAY SOUTH LAKE FOREST, CA 92630 CONTACT: FRANK CARTER (949) 310-8233 PHONE (949) 753-8833 FAX

REVISION DESCRIPTION: DATE/BY: ISSUED FOR 03/15/2013 REVIEW SA ISSUED FOR 03/18/2013 APPROVAL 09/05/2013 APPROVAL ISSUED FOR 11/05/2013 FXC ISSUED FOR 03/08/2014 APPROVAL

ENGINEER / CONSULTANT:

Civil Engineer CONNELL DESIGN GROUP, LLC

26455 RANCHO PARKWAY SOUTH, LAKE FOREST, CA 92630

(949) 753-8807 OFFICE - (949) 753-8833 FAX

CLIENT:



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SITE INFO:


MON14 VERIZON MONTECITO-MON14

SITE ADDRESS: THOMAS BROS PAGE 997 GRID B3 R.O.W. NORTH SIDE OF JAMESON LN (ADJACENT TO 1930 JAMESON LN) SANTA BARBARA, CA 93108 LAT: 34.42241 LONG: -119.61458

SHEET TITLE:

TITLE SHEET

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	1	08/07/13	ISSUED FOR REVIEW
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SITE BUILDER:

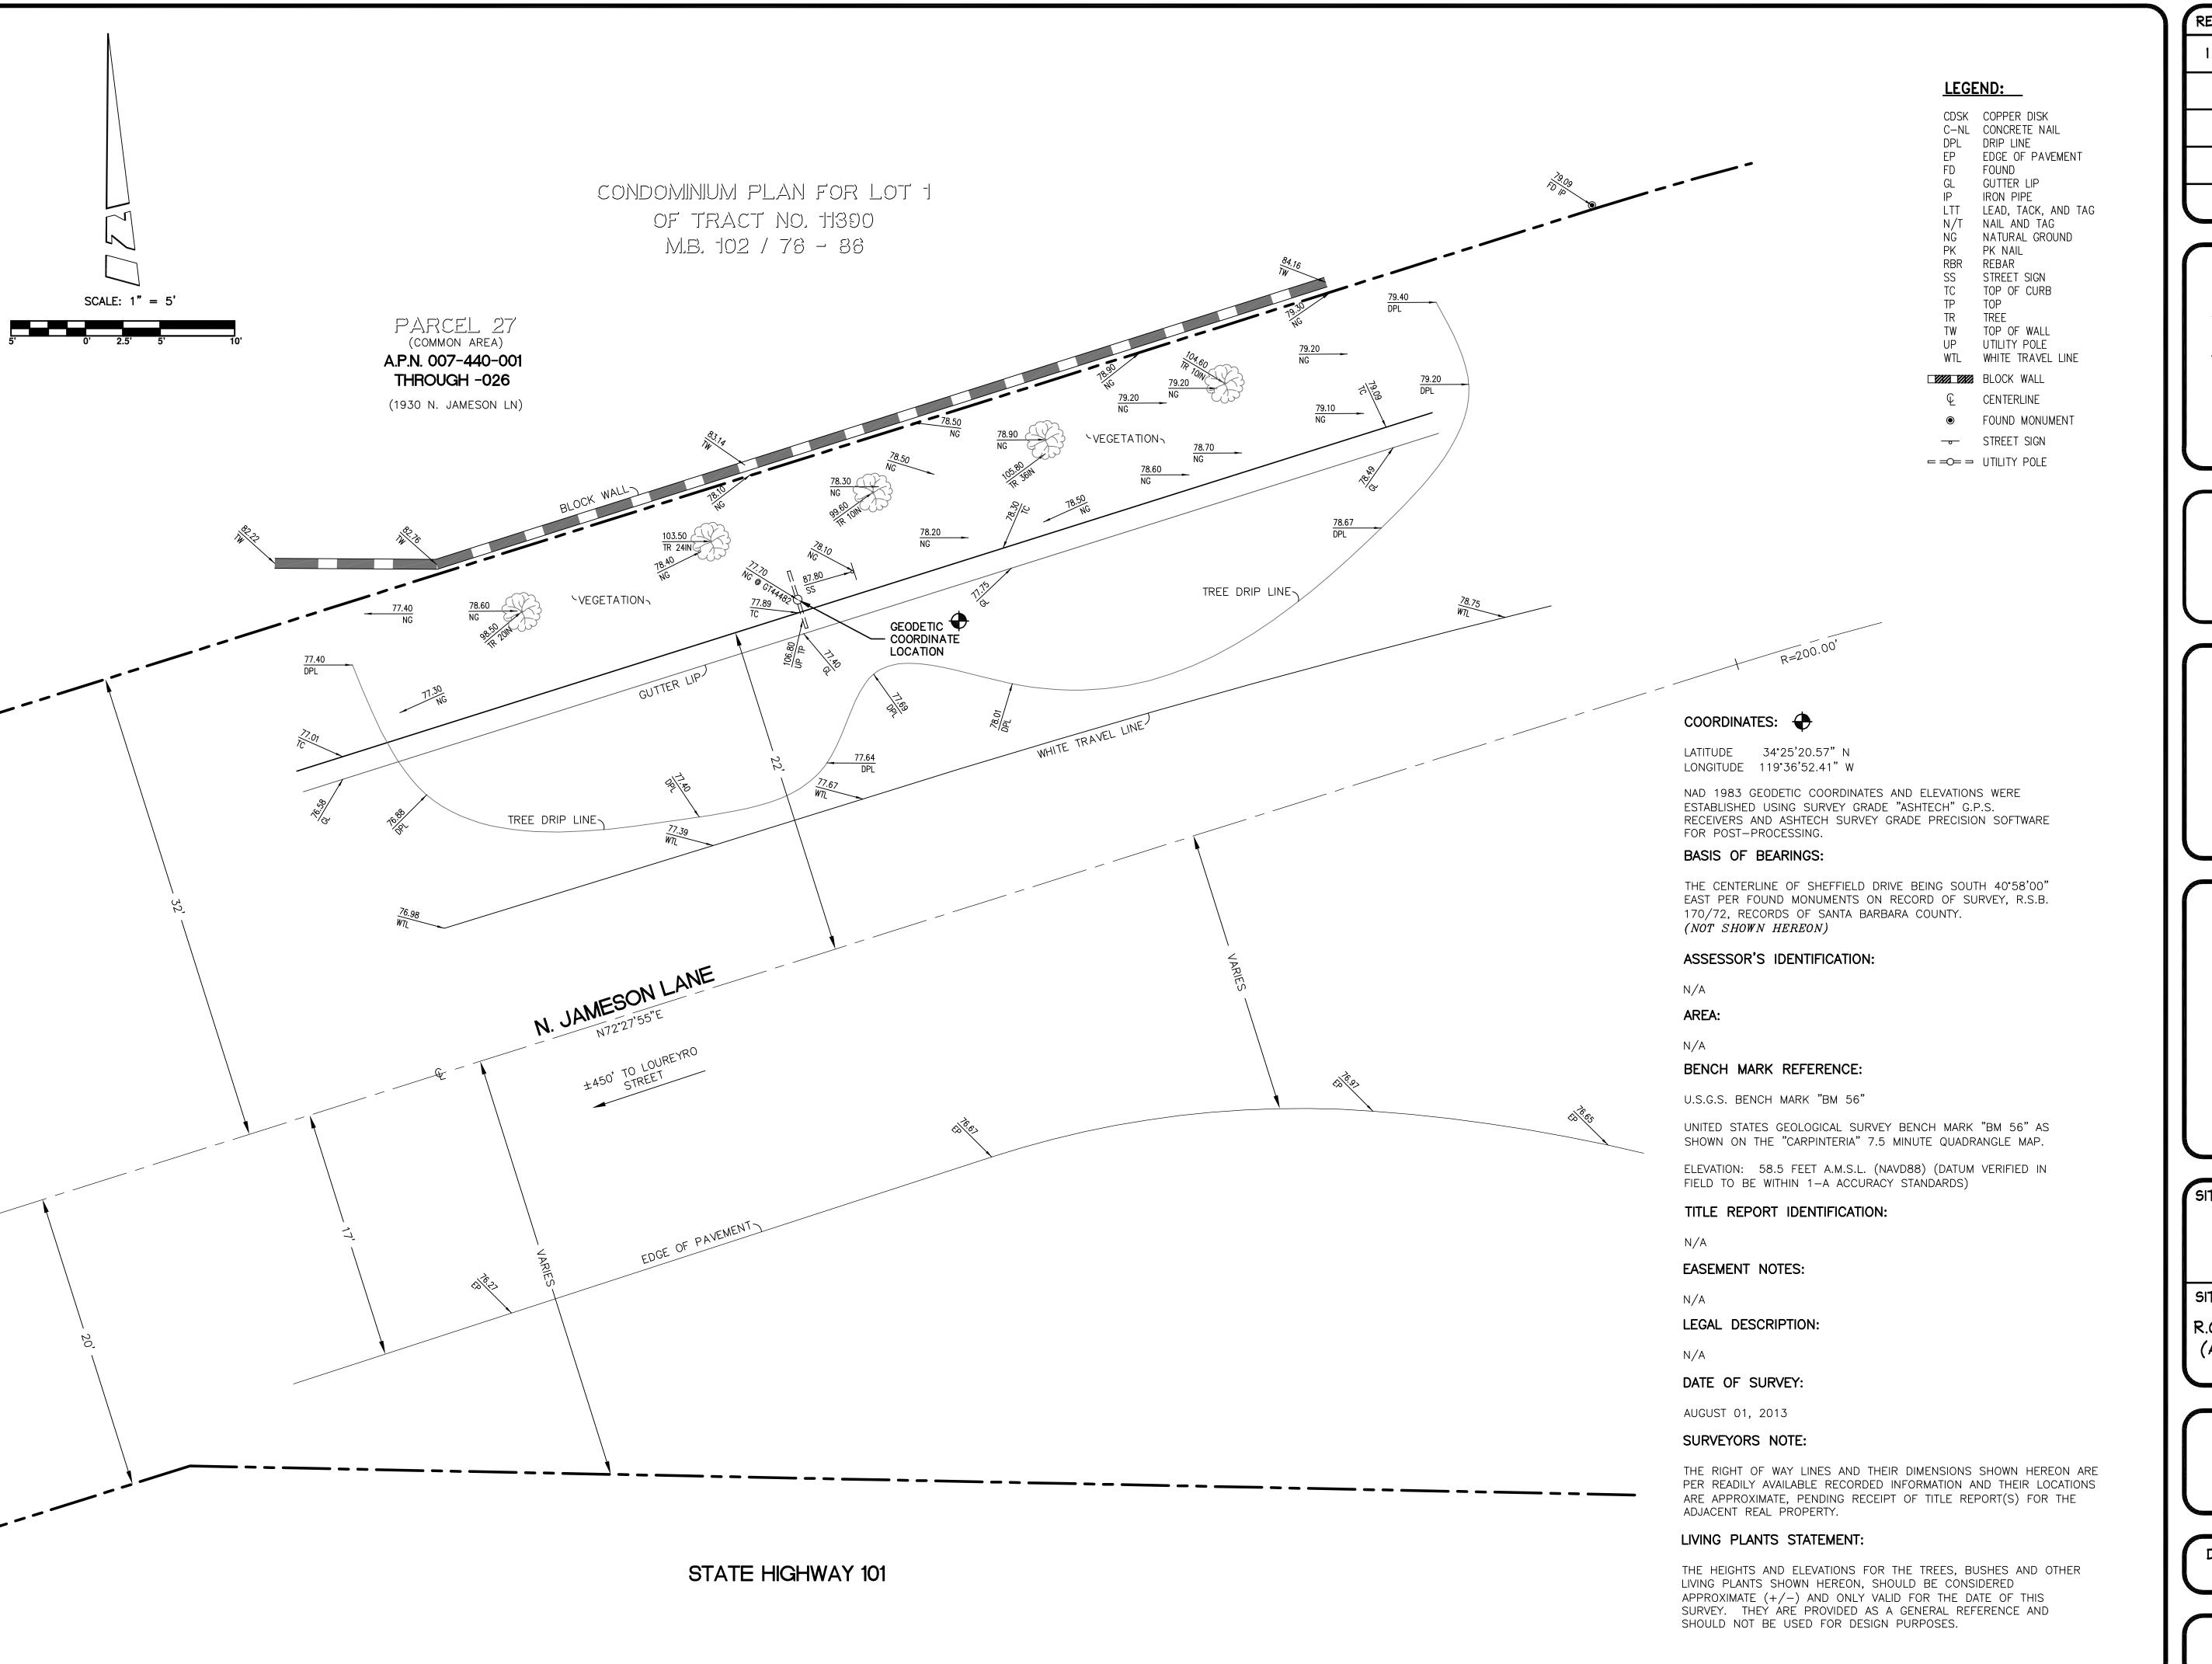LAKE FOREST, CA 92630-8326

(949) 753-8807 OFFICE - (949) 753-8833 FAX



SURVEYOR:

BERU HAZE

AND ASSOCIATES, INC.

LAND SURVEYING & MAPPING

3188 AIRWAY AVENUE, SUITE K1


COSTA MESA, CALIFORNIA 92626

714 557-1567 OFFICE

714 557-1568 FAX

JN. 706.227

STAMP:

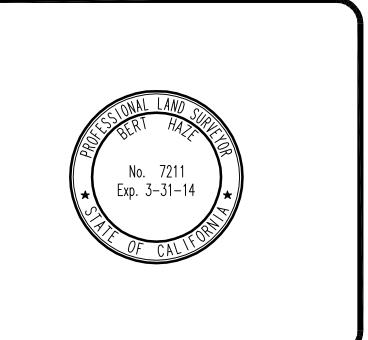

SITE INFO:

SITE NAME:

MON14 VERIZON MONTECITO-MON14

SITE ADDRESS:

R.O.W. NORTH SIDE OF N. JAMESON LN (ADJACENT TO 1930 N. JAMESON LN) SANTA BARBARA, CA 93108

SHEET TITLE:


TOPOGRAPHIC SURVEY


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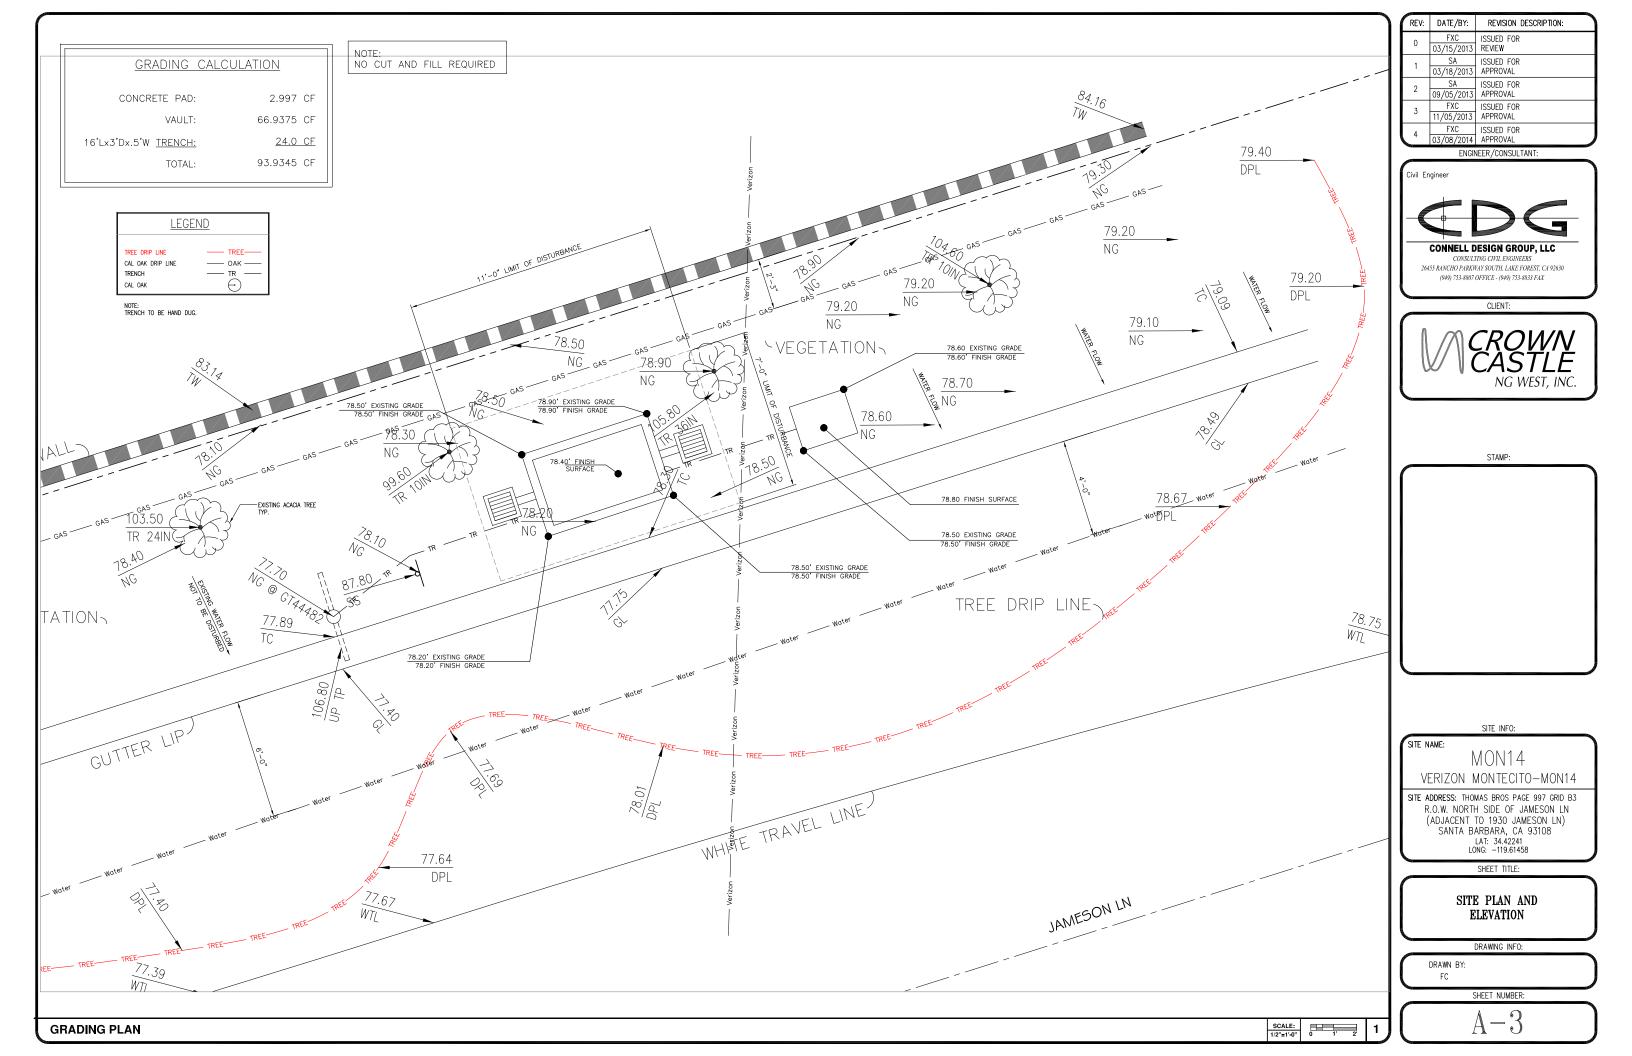
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MON14	MDL	08/07/13				
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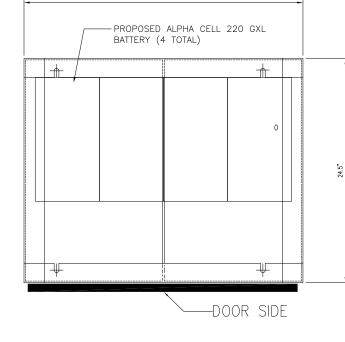







COMBA Outdoor Omni-directional Antenna OOA-360V06N0-3 VPol, 696-960/1710-2170MHz, 360°, 4.0/6.0 dBi 2.4**"**ø Technical Specifications Electrical Frequency Range 696-960 1710–2170 MHz Polarization Vertical dBi 4.0±1 6.0 ± 1 Horizontal Beamwidth deg 22-53 PROPOSED -Vertical Beamwidth 20-26 Electrical Downtilt-Fixed deg VSWR 1.8 200 50 Maximum Power Impedance Lightning Protection Direct Ground Mechanical Dimensions, HxDia 650x60 (25.6x2.4) Weight, with Mounting kit 1 (2.2) Radome Material and Color Fiberglass, Light Grey Radiating Element Material Copper N-Female, Bottom -55 to +70 95 Connector Type and Location Operational Temperature Operational Humidity Operational Wind Speed 200 (124) 670x100x100 (26.4x3.9x3.9) 1. 2 (2.65) Shipping Dimensions, HxWxD mm (in) Shipping Weight 1 CONCRETE PAD **ANTENNA SPECIFICATIONS** N.T.S. 1900 MHz Electrical Power Supply Frequency range, MHz 1850 to 1915 1930 to 1995 . 1100 max. Power consumption, Watts < 750 @ normal Output power per carrier*, dBm operation 700 MHz SISO/MIMO GSM Frequency range, MHz
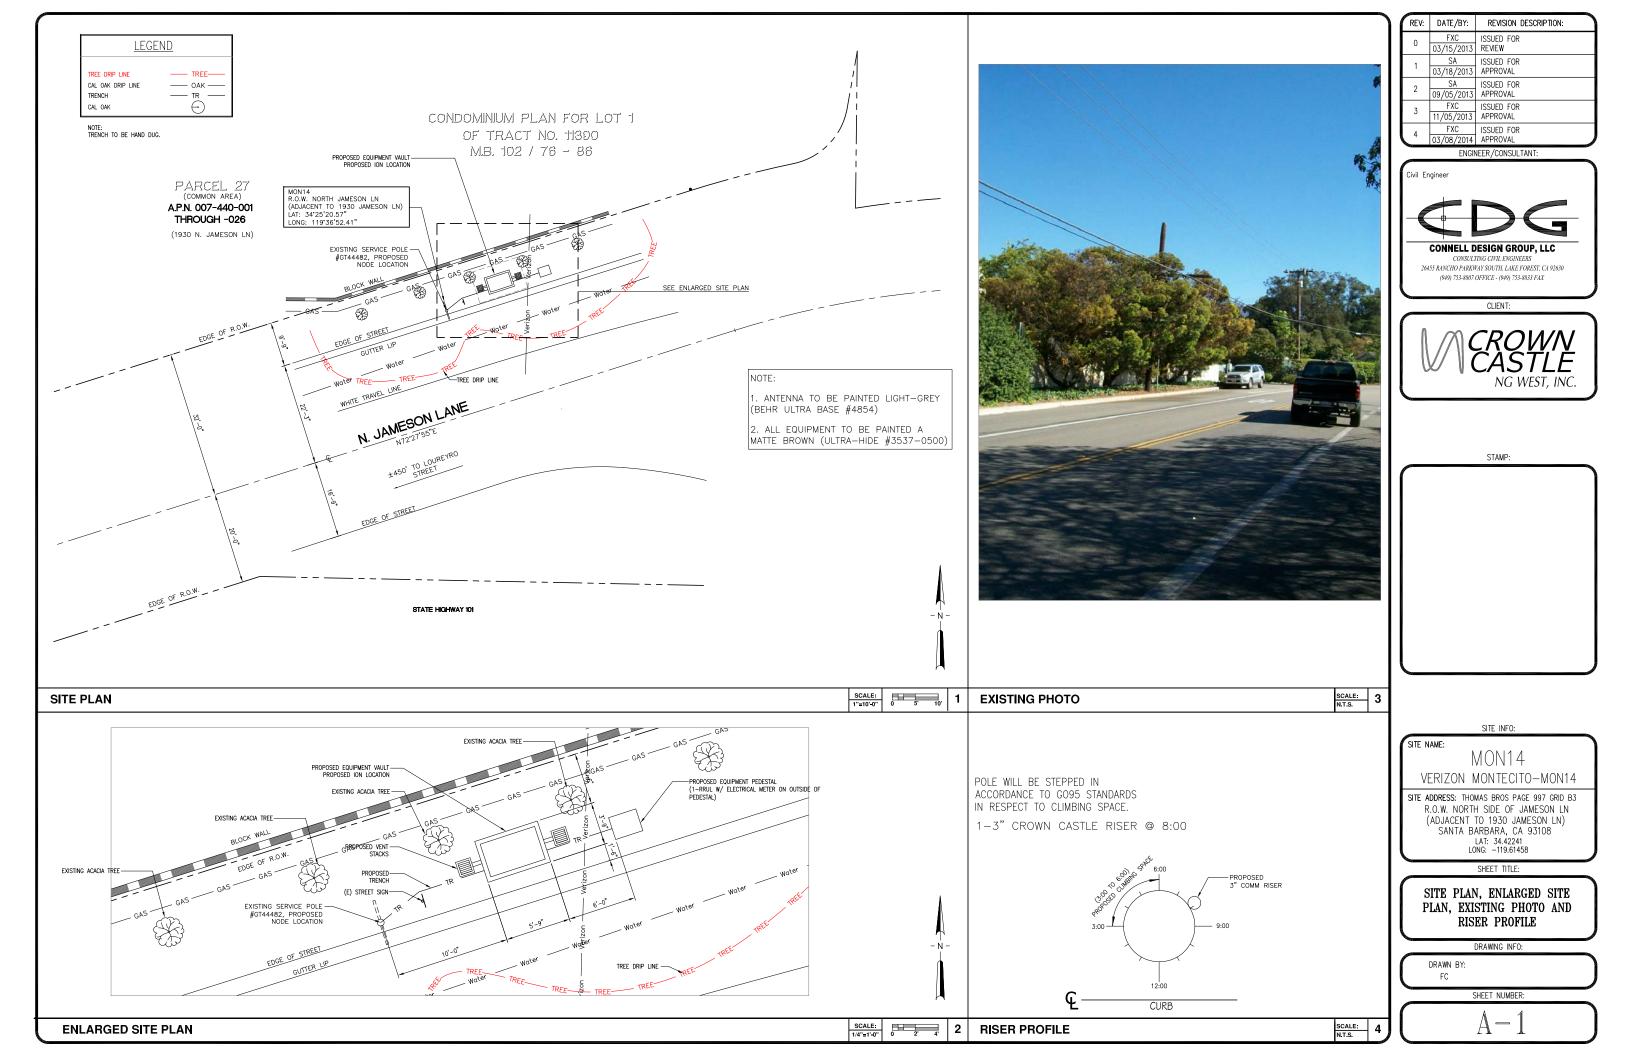
#3 BARS @ 16" O.C. EA WAY FINISH GRADE 3'x3' CONCRETE PAD

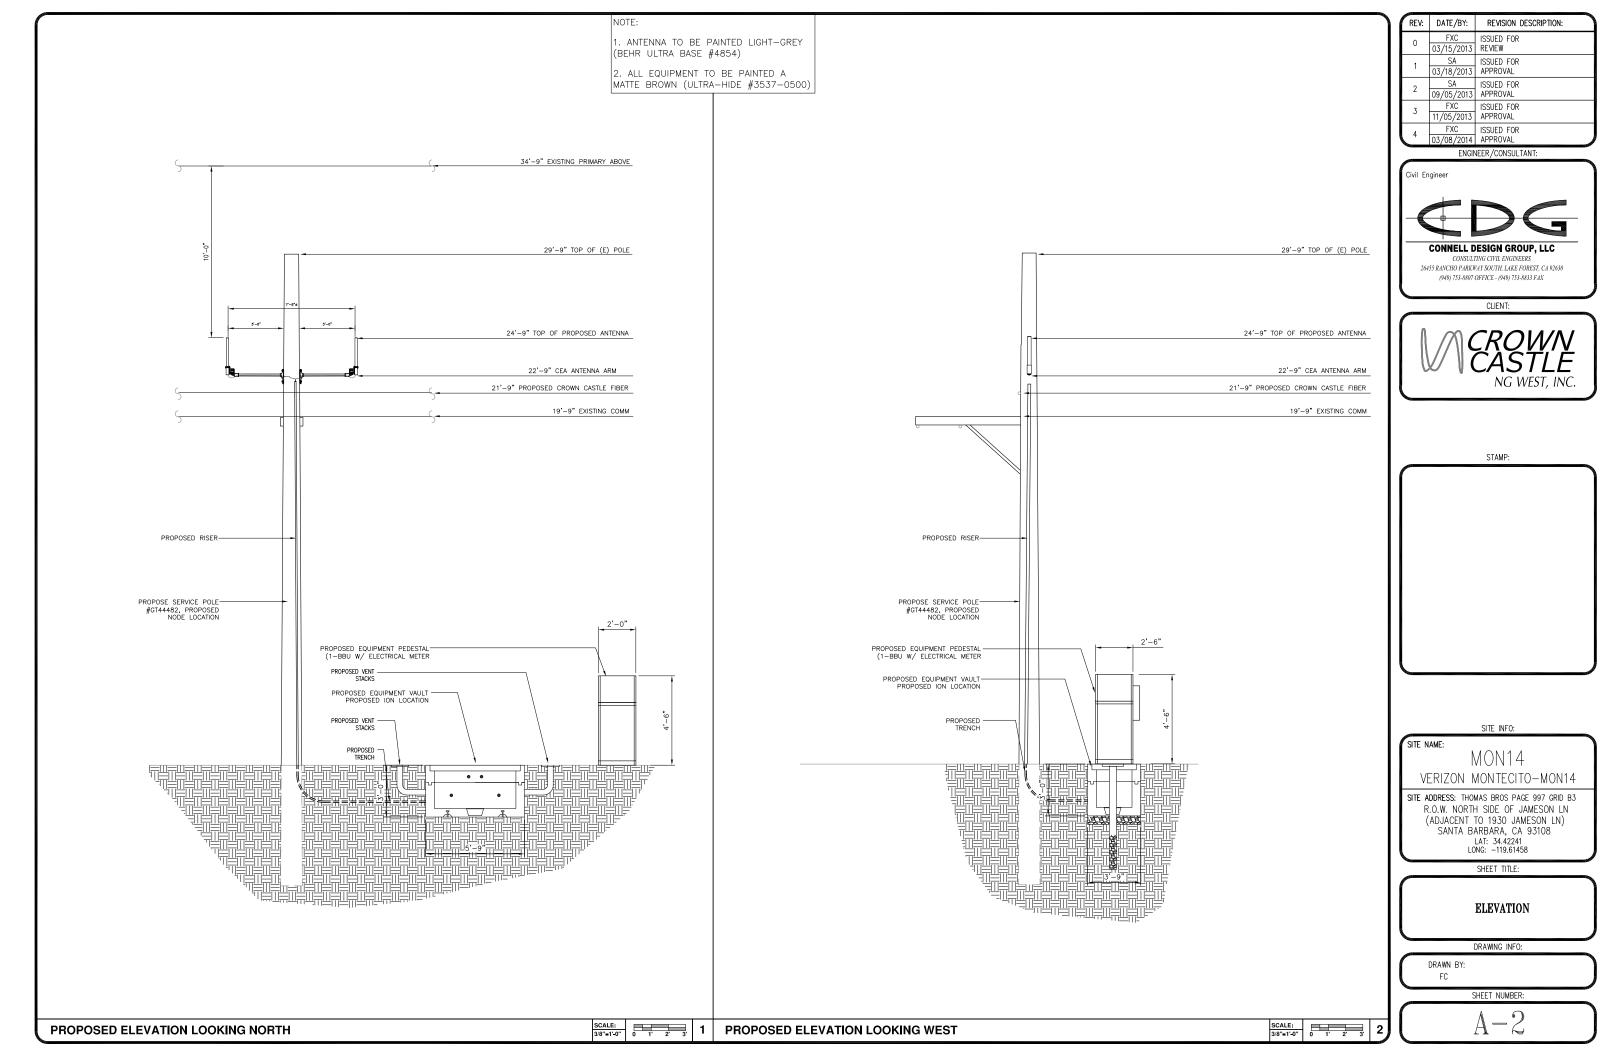

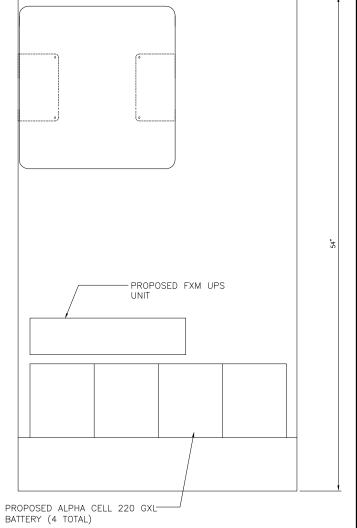

1	REV:	DATE/BY:	REVISION DESCRIPTION:
	0	FXC 03/15/2013	ISSUED FOR REVIEW
	1	SA 03/18/2013	ISSUED FOR APPROVAL
	2	SA 09/05/2013	ISSUED FOR APPROVAL
	3	FXC 11/05/2013	ISSUED FOR APPROVAL
	4	FXC 03/08/2014	ISSUED FOR APPROVAL
- I	ENCINEED (CONCILITANT)		



CLIENT:

(949) 753-8807 OFFICE - (949) 753-8833 FAX



STAMP:

SITE INFO:

MON14 VERIZON MONTECITO-MON14


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SHEET TITLE:

DETAILS

DRAWING INFO:

SHEET NUMBER:

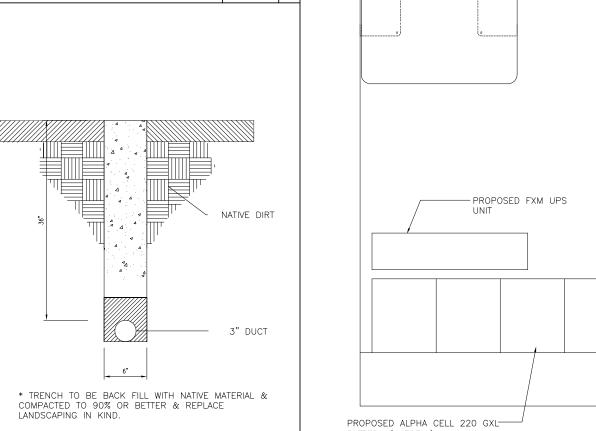

N.T.S.

698 to 716/776 to 787 728 to 757 Output power per carrier*, dBm 850 MHz Frequency range, MHz 824 to 849 20W for Cell, 869 to 894 PCS bands and Output power per carrier*, dBm 700MHz MIMO 37 37 37 37 36 CDMA

ION-M7P/7P/85P/19P

CDWA LTE CommScope[®] ION-M7P/7P/85P/19P

Noise figure, dB

. +6 max. 4.5 typical

Height, width, depth, mm (in) . 817 x 245 x 218 $(32.2 \times 9.6 \times 8.6)$


Weight, kg (lb) 40 (88.2)

Page 1, February 27, 2013 Company Confidential

N.T.S.

TRENCH

EQUIPMENT PEDESTAL

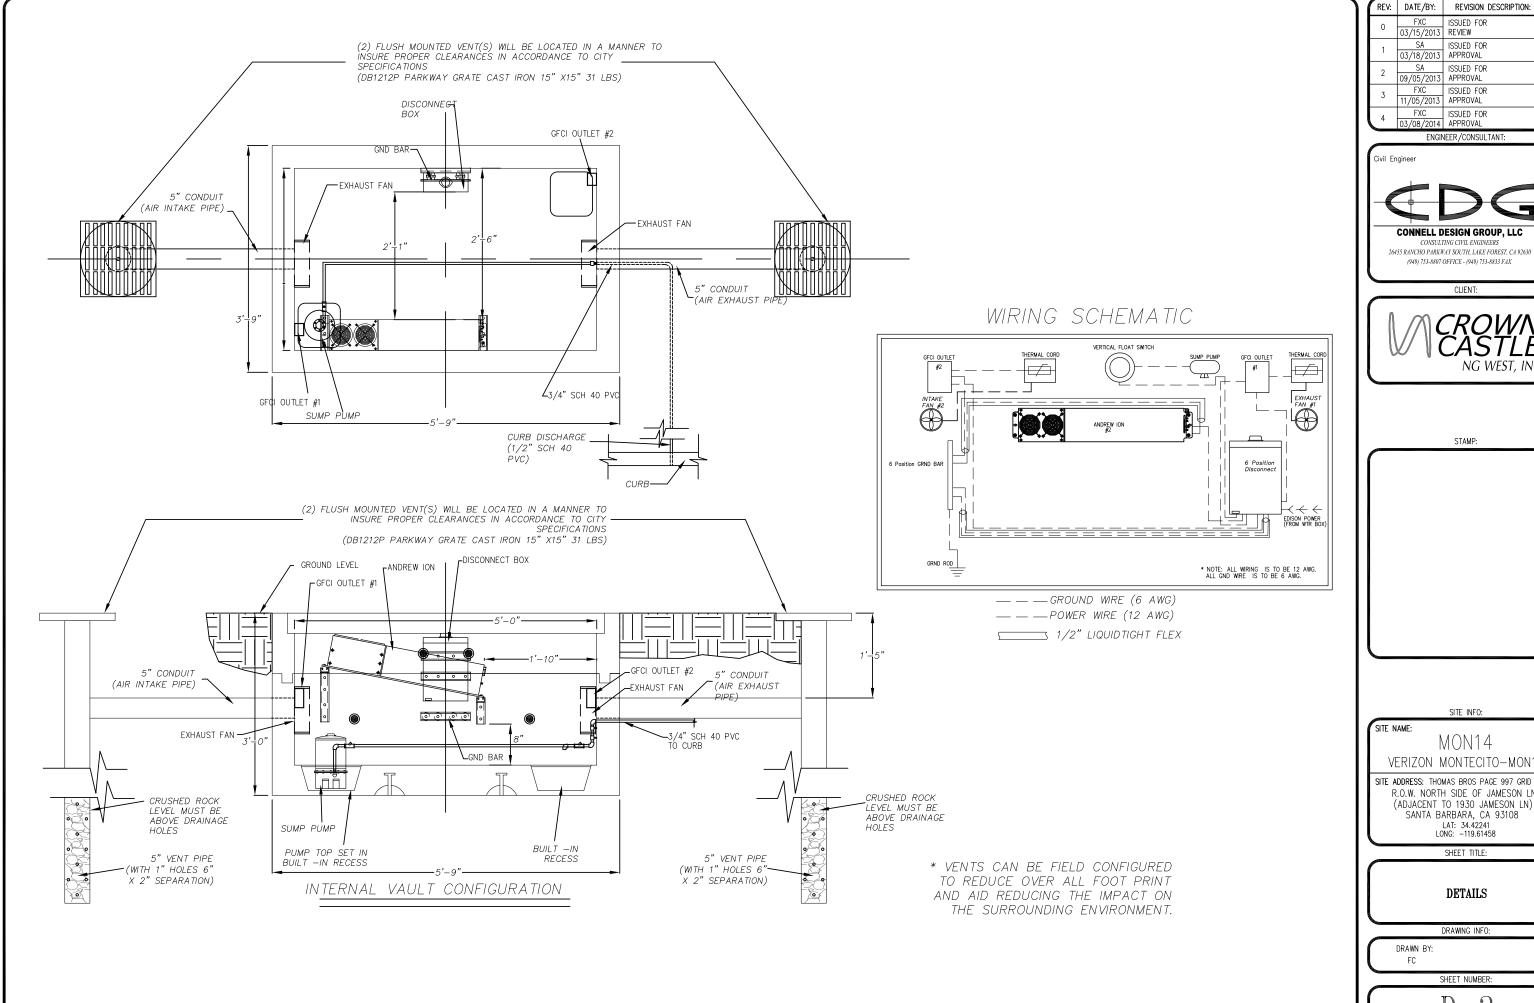

VAULT DETAIL

1	1	REV:	DATE/BY:	REVISION DESCRIPTION:
		0	FXC 03/15/2013	ISSUED FOR REVIEW
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ENGINEER/CONSULTANT:

Civil Engineer CONNELL DESIGN GROUP, LLC CONSULTING CIVIL ENGINEERS

(949) 753-8807 OFFICE - (949) 753-8833 FAX

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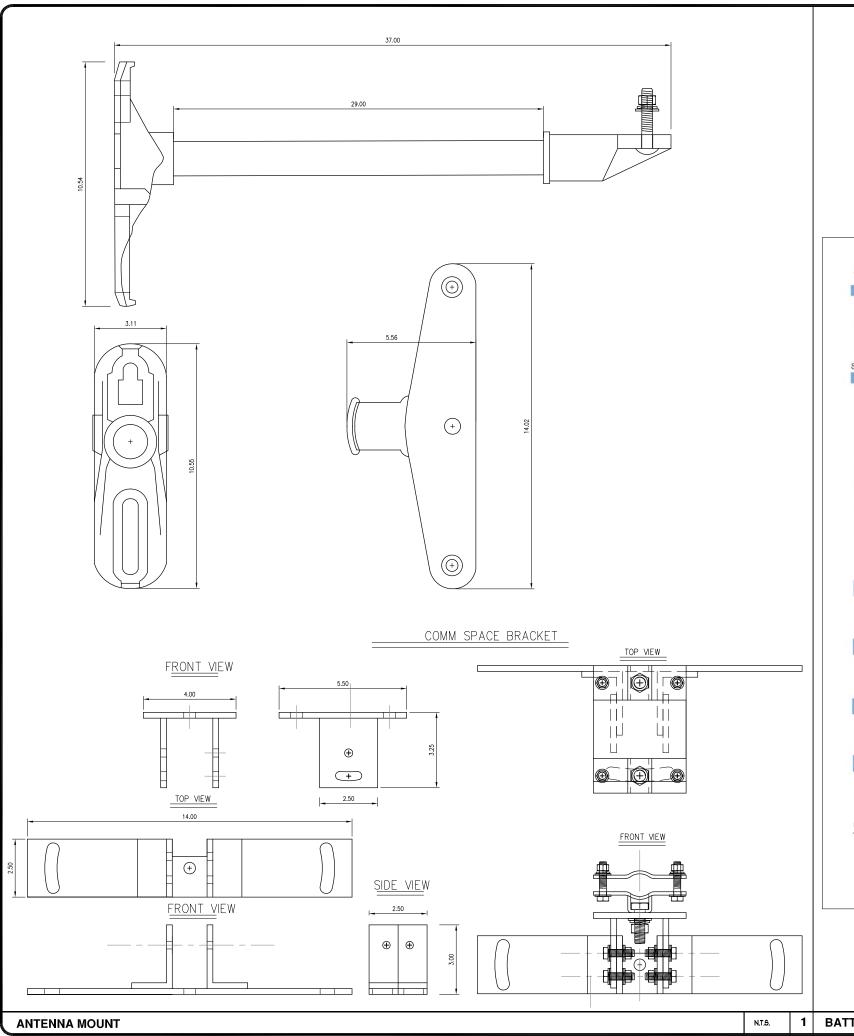
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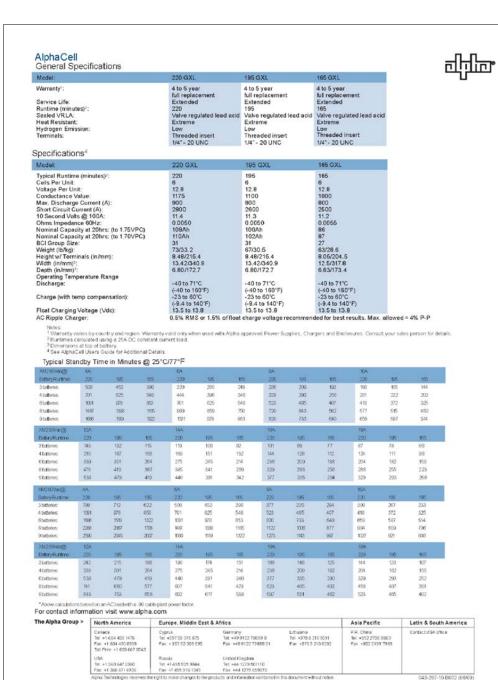
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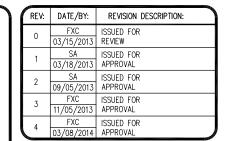
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N.T.S.







Civil Engineer



26455 RANCHO PARKWAY SOUTH, LAKE FOREST, CA 92630 (949) 753-8807 OFFICE - (949) 753-8833 FAX



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SHEET TITLE:

DETAILS

DRAWING INFO:

FC

SHEET NUMBER:

BATTERY SPECIFICATIONS

- 1. APPROVAL OF THESE PLANS BY THE CITY ENGINEER DOES NOT AUTHORIZE ANY WORK TO BE PERFORMED UNTIL A PERMIT HAS
- 2. UPON ISSUANCE OF A PERMIT, NO WORK WILL BE PERMITTED ON WEEKENDS OR HOLIDAYS WITHOUT PERMISSION FROM THE
- 3, THE APPROVAL OF THIS PLAN OR ISSUANCE OF A PERMIT BY THE LOCAL JURISDICTION DOES NOT AUTHORIZE THE SUBDIVIDER AND OWNER TO VIOLATE ANY FEDERAL. STATE OR CITY LAWS, ORDINANCES, REGULATIONS, OR POLICIES, INCLUDING, BUT NOT LIMITED TO, THE FEDERAL ENDANGERED SPECIES ACT OF 1973 AND AMENDMENTS THERETO (16 USC SECTION 1531 ET.SEQ.)
- 4. THE CONTRACTOR SHALL BE RESPONSIBLE FOR SURVEY MONUMENTS AND/OR VERTICAL CONTROL BENCHMARKS WHICH ARE DISTURBED OR DESTROYED BY CONSTRUCTION. A LAND SURVEYOR MUST FIELD LOCATE, REFERENCE, AND/OR PRESERVE ALL HISTORICAL OR CONTROLLING MONUMENTS PRIOR TO ANY EARTHWORK. IF DESTROYED, SUCH MONUMENTS SHALL BE REPLACED WITH APPROPRIATE MONUMENTS BY A LAND SURVEYOR, A CORNER RECORD OR RECORD OF SURVEY, AS APPROPRIATE, SHALL BE FIELD AS REQUIRED BY THE PROFESSIONAL LAND SURVEYORS ACT. IF ANY VERTICAL CONTROL IS TO BE DISTURBED OR DESTROYED. THE LOCAL JURISDICTION FIELD SURVEY SECTION MUST BE NOTIFIED. IN WRITING, AT LEAST 3 DAYS PRIOR TO THE CONSTRUCTION. THE CONTRACTOR WILL BE RESPONSIBLE FOR THE COST OF REPLACING ANY VERTICAL CONTROL BENCHMARKS
- 5. IMPORTANT NOTICE: SECTION 4216 OF THE GOVERNMENT CODE REQUIRES A DIG ALERT IDENTIFICATION NUMBER BE ISSUED BEFORE A "PERMIT TO EXCAVATE" WILL BE VALID. FOR YOUR DIG ALERT I.D. NUMBER, CALL UNDERGROUND SERVICE ALERT, TWO
- 6. CONTRACTOR SHALL BE RESPONSIBLE FOR THE POTHOLE AND LOCATING OF ALL EXISTING UTILITIES THAT CROSS THE PROPOSED TRENCH LINE AND MUST MAINTAIN 1' MINIMUM VERTICAL CLEARANCE.
- 7. CONTRACTOR SHALL SUBMIT TO THE LOCAL JURISDICTION, A CONSTRUCTION PLAN TO PROTECT WATER MAINS PRIOR TO COMMENCING CONSTRUCTION.
- 8. CONTRACTOR SHALL REPLACE OR REPAIR ALL TRAFFIC SIGNAL LOOPS, CONDUIT, AND LANE STRIPING DAMAGED DURING
- 9. CONTRACTOR SHALL NOTIFY THE LOCAL JURISDICTION. A MINIMUM OF 48 HOURS PRIOR TO COMMENCING WORK WITHIN 10' OF
- 10. THIS PROJECT WILL BE INSPECTED BY ENGINEERING AND CAPITAL PROJECTS DEPARTMENT, FIELD ENGINEERING DIVISION.
- 11. AS-BUILT DRAWINGS MUST BE SUBMITTED TO THE CITY RESIDENT ENGINEER PRIOR TO THE ACCEPTANCE OF THIS PROJECT. 12. PUBLIC IMPROVEMENT SUBJECT TO DESUETUDE OR DAMAGE." IF REPAIR OR REPLACEMENT OF SUCH PUBLIC IMPROVEMENTS IS REQUIRED. THE OWNER SHALL OBTAIN THE REQUIRED PERMITS FOR WORK IN THE PUBLIC RIGHT-OFWAY, SATISFACTORY TO TH
- 13. PRIOR TO ANY DISTURBANCE TO THE SITE, EXCLUDING UTILITY MARKS-OUTS AND SURVEYING, THE CONTRACTOR SHALL MAKE ARRANGEMENTS FOR A PRE-CONSTRUCTION MEETING WITH THE LOCAL JURISDICTION FIELD ENGINEERING DIMSION.
- 14. PRIOR TO THE COMMENCEMENT OF ANY CONSTRUCTION SHOWN ON THESE PLANS. IT IS THE SOLE RESPONSIBILITY OF THE CONTRACTOR TO COORDINATE. THE CONTRACTOR IS RESPONSIBLE TO ATTEND THE LOCAL JURISDICTIONS MONTHLY UTILITY COORDINATION COMMITTEE THE CONSTRUCTION ACTIVITIES WITH THE CITY AND ALL OTHER CONTRACTORS SO THAT NO TRENCH IS CUT WITHIN ANY OF THE CITY STREETS THAT HAVE BEEN CONSTRUCTED, REPAIRED, OR SLURRY SEALED WITHIN THREE YEARS OF THE STREET CONSTRCTUION/RESURFACING DATE.
- 15. MANHOLES OR COVERS SHALL BE LABELED "CROWN CASTLE" OR "CROWN CASTLE NG WEST".
- 16. CONTRACTOR SHALL IMPLEMENT AN EROSION AND SEDIMENT CONTROL PROCRAM DURING THE PROJECT CONSTRUCTION ACTIVITIES PROGRAM SHALL MEET THE APPLICABLE REQUIREMENTS OF THE STATE WATER RESOURCE CONTROL BOARD
- 17. THE CONTRACTOR SHALL HAVE EMERGENCY MATERIALS AND EQUIPMENT ON HAND FOR UNFORESEEN SITUATIONS, SUCH AS DAMAGE TO UNDERGROUND WATER, SEWER, AND STORM DRAIN FACILITIES WHEREBY FLOWS MAY GENERATE EROSION AND SEDIMENT

SPECIAL NOTES

THE FOLLOWING NOTES ARE PROVIDED TO GIVE DIRECTIONS TO THE CONTRACTOR BY THE ENGINEER OF WORK. THE CITY ENGINEER'S SIGNATURE ON THESE PLANS DOES NOT CONSTITUTE APPROVAL OF THESE NOTES AND THE CITY WILL NOT BE RESPONSIBLE FOR THEIR ENFORCEMENT.


- THE CONTRACTOR SHALL VERIFY THE LOCATION EXISTING UNDERGROUND UTILITIES INCLUDING SEWER LATERALS AND WATER
 SERVICES TO INDIVIDUAL LOTS BOTH VERTICAL AND HORIZONTAL PRIOR TO COMMENCING IMPROVEMENT OPERATIONS.
- 2. CONTRACTOR SHALL MAKE EXPLORATION EXCAVATIONS AND LOCATE EXISTING FACILITIES SUFFICIENTLY AHEAD OF CONSTRUCTION TO PERMIT REVISIONS OF PLANS IF REVISION IS NECESSARY BECAUSE OF LOCATION OF EXISTING UTILITIES.
- 3. LOCATION AND ELEVATIONS OF IMPROVEMENTS. TO BE MET BY WORK, SHALL BE CONFIRMED BY FIELD MEASUREMENT PRIOR TO
- 4. GRADES SHOWN ARE FINISH GRADES, CONTRACTOR SHALL DETERMINE NECESSARY SUB GRADE ELEVATIONS AND SHALL CONSTRUCT
- 5. Contractor agrees that he shall assume sole responsibility for job site condition during the course of construction of this project, including safety of all persons and property: that this provision shall apply CONTINUOUSLY AND NOT BE LIMITED TO NORMAL WORKING HOURS; AND THAT THE CONTRACTOR SHALL DEFEND, INDEMNIFY AND HOLD THE OWNER AND THE ENGINEER HARMLESS FROM ANY AND ALL LIABILITY. REAL OR ALLEGED IN CONNECTION WITH THI PERFORMANCE OF WORK ON THIS PROJECT, EXPECTING FOR LIABILITY ARISING FROM SOLE NEGLIGENCE OF THE OWNER OR THE
- 6. THE CONTRACTOR SHALL BE TOTALLY RESPONSIBLE FOR COMPLIANCE WITH THE PROVISIONS OF THE STATE OF CALIFORNIA SAFETY
- 7. THE LOCATIONS OF ALL EXISTING UTILITIES SHOWN ON THESE PLANS ARE FROM EXISTING RECORDS AND CORROBORATED, WHERE POSSIBLE WITH FIELD TIES. THE CONTRACTOR IS RESPONSIBLE FOR CONFIRMING THE LOCATIONS SHOWN, BOTH HORIZONTALLY AND VERTICALLY, PRIOR TO CONSTRUCTION. IF EXISTING LOCATIONS VARY SUBSTANTIALLY FROM THE PLANS, THE ENGINEER SHOULD BE NOTIFIED TO MAKE ANY CONSTRUCTION CHANGES REQUIRED.
- 8. THE CONTRACTOR SHALL PROVIDE TEMPORARY SUPPORT FOR ALL SEWER AND WATER MAIN UNDER CROSSING IN ACCORDANCE WITH PART 1 SECTION 5-2 OF THE STANDARD SPECIFICATION.
- 9. THE CONTRACTOR SHALL REPLACE OR REPAIR ALL TRAFFIC SIGNAL LOOPS, CONDUITS, AND LANE STRIPING DAMAGED DURING
- 10. THE CONTRACTOR SHALL SUBMIT WORK PLANS FOR ALL BORE OPERATIONS TWO WEEKS PRIOR TO COMMENCING WORK.
- 11. CONTRACTOR SHALL BE RESPONSIBLE FOR THE POTHOLE AND LOCATING OF ALL EXISTING UTILITIES THAT CROSS THE PROPOSED
- 12. AS-BUILT DRAWINGS MUST BE SUBMITTED TO THE CITY ENGINEER PRIOR TO ACCEPTANCE OF THIS PROJECT




CONSTRUCTION CHANGE TABLE CHANGE DATE EFFECTED OR ADDED SHEET NUMBERS

CROWN CASTLE NG WEST, INC

VERIZON MONTECITO-MON15 R.O.W. NORTH SIDE OF JAMESON LN. (ADJACENT TO 130 TIBURON BAY LN) SANTA BARBARA, CA 93108

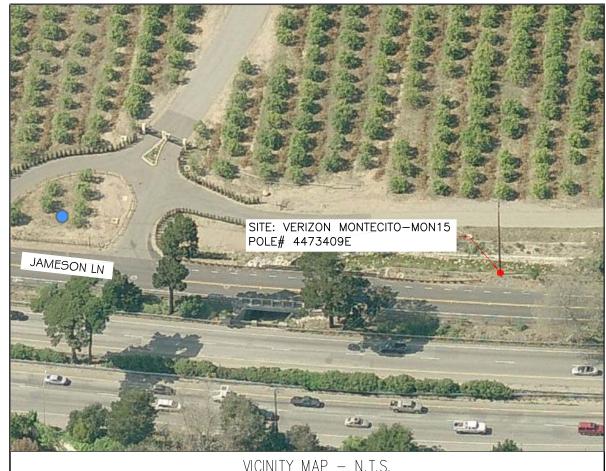

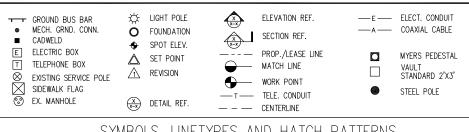

SYMBOLS, LINETYPES AND HATCH PATTERNS

APPLICABLE CODES

ALL WORK SHALL COMPLY WITH THE FOLLOWING APPLICABLE CODES:

- IN THE EVENT OF CONFLICT, THE MOST RESTRICTIVE CODE SHALL PREVAIL

PROJECT DESCRIPTION

PROJECT CONSISTS OF INSTALLATION OF:

- . (2) OMNI DIRECTIONAL ANTENNA ON EXISTING UTILITY POLE
- 2. ION, BBU ON EXISTING UTILITY POLE

SHEET INDEX:

T-1 - SHEET 1 OF 8 LS1 - SHEET 2 OF 8 SITE PLAN A-1 - SHEET 3 OF 8 PROPOSED ELEVATIONS A-2 - SHFFT 4 OF 8 ESH AREA PLAN DETAILS D-1 - SHEET 6 OF 8 DETAILS D-2 - SHEET 7 OF 8

D-3 - SHEET 8 OF 8

EROSION AND SEDIMENT CONTROL NOTES

TEMPORARY EROSION/SEDIMENT CONTROL, PRIOR TO COMPLETION OF FINAL IMPROVEMENTS. SHALL BE PERFORMED BY THE CONTRACTOR OR QUALIFIED PERSON AS INDICATED BELOW:

- 1. ALL REQUIREMENTS OF THE LOCAL JURISDICTION "LAND DEVELOPMENT MANUAL, STORM WATER STANDARDS" MUST BE INCORPORATED INTO THE DESIGN AND CONSTRUCTION OF THE PROPOSED GRADING/IMPROVEMENTS CONSISTENT WITH THE APPROVED STORM WATER AND/OR WATER POLLUTION CONTROL PLAN (WPCP).
- 2. FOR STORM DRAIN INLETS, PROVIDE A GRAVEL BAG SILT BASIN IMMEDIATELY UPSTREAM OF INLET AS INDICATED ON DETAILS.
- 3. FOR INLETS LOCATED AT SUMPS ADJACENT TO TOP OF SLOPES, THE CONTRACTOR SHALL ENSURE THAT WATER DRAINING TO THE SUMP IS DIRECTED INTO THE INLET AND THAT A MINIMUM OF 1.00" FREEBOARD EXISTS AND IS MAINTAINED ABOVE THE TOP OF THE INLET. IF FREEBOARD IS NOT PROVIDED BY GRADING SHOWN ON THESE PLANS, THE CONTRACTOR SHALL PROVIDE IT VIA TEMPORARY MEASURES, I.E. GRAVEL BAGS OR DIKES.
- 4. THE CONTRACTOR OR QUALIFIED PERSON SHALL BE RESPONSIBLE FOR CLEANUP OF SILT AND MUD ON ADJACENT STREET(S) AND STORM DRAIN SYSTEM DUE TO CONSTRUCTION
- 5. THE CONTRACTOR OR QUALIFIED PERSON SHALL CHECK AND MAINTAIN ALL LINED AND
- 6. THE CONTRACTOR SHALL REMOVE SILT AND DEBRIS AFTER EACH MAJOR RAINFALL.

UNLINED DITCHES AFTER EACH RAINFALL.

- 7. EQUIPMENT AND WORKERS FOR EMERGENCY WORK SHALL BE MADE AVAILABLE AT ALL TIMES DURING THE RAINY SEASON, ALL NECESSARY MATERIALS SHALL BE STOCKPILED ON SITE AT CONVENIENT LOCATIONS TO FACILITATE RAPID CONSTRUCTION OF TEMPORARY DEVICES WHEN RAIN IS IMMINENT.
- 8. THE CONTRACTOR SHALL RESTORE ALL EROSION/SEDIMENT CONTROL MEASURES TO WORKING ORDER TO THE SATISFACTION OF THE CITY ENGINEER OR RESIDENT ENGINEER AFTER EACH RUN-OFF PRODUCING RAINFALL.
- THE CONTRACTOR SHALL INSTALL ADDITIONAL EROSION CONTROL MEASURES AS MAY BE REQUIRED BY THE RESIDENT ENGINEER DUE TO UNCOMPLETED GRADING OPERATIONS OR UNFORESEEN CIRCUMSTANCES, WHICH MAY ARISE.
- 10. THE CONTRACTOR SHALL BE RESPONSIBLE AND SHALL TAKE NECESSARY PRECAUTIONS TO PREVENT PUBLIC TRESPASS ONTO AREAS WHERE IMPOUNDED WATERS CREATE A HAZARDOUS CONDITION.
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- OF THE SLOPE AT THE CONCLUSION OF EACH WORKING DAY. 13. ALL REMOVABLE PROTECTIVE DEVICES SHOWN SHALL BE IN PLACE AT THE END OF EACH
- 14. THE CONTRACTOR SHALL ONLY GRADE, INCLUDING CLEARING AND GRUBBING FOR THE AREAS FOR WHICH THE CONTRACTOR OR QUALIFIED PERSON CAN PROVIDE
- 15. THE CONTRACTOR SHALL ARRANGE FOR WEEKLY MEETINGS DURING OCTORER 1ST TO APRIL 30TH FOR PROJECT TEAM (GENERAL CONTRACTOR, QUALIFIED PERSON, EROSION CONTROL SUBCONTRACTOR IF ANY, ENGINEER OF WORK, OWNER AND THE RESIDENT ENGINEER) TO EVALUATE THE ADEQUACY OF THE EROSION/SEDIMENT CONTROL MEASURES AND OTHER RELATED CONSTRUCTION ACTIVITIES.

TRAFFIC CONTROL NOTES

FROSION/SEDIMENT CONTROL MEASURES.

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FOOTAGE TOTALS		
ASPHALT CUT	-	
DIRT TRENCH	-	
PUNCH THRU	-	
BORE	-	
TOTAL	=	
R&R SWF TOTAL	-	

PROJECT DICTIONARY

R.O.W. NORTH SIDE OF JAMESON LN. SITE ADDRESS: (ADJACENT TO 130 TIBURON BAY LN) SANTA BARBARA, CA 93108

APPLICANT: CROWN CASTLE NG WEST, INC 2125 WRIGHT AVE, SUITE #C9 LA VERNE, CA 91750 CONTACT: HEIDI PAYNE

PHONE: (949) 300-9493

CONNELL DESIGN GROUP, LLC CIVIL ENGINEER: 26455 RANCHO PARKWAY SOUTH LAKE FOREST, CA 92630 CONTACT: FRANK CARTER (949) 310-8233 PHONE

(949) 753-8833 FAX

REVISION DESCRIPTION: DATE/BY: ISSUED FOR 03/18/2013 APPROVAL ISSUED FOR 1/05/2013 APPROVAL ISSUED FOR 01/08/2014 APPROVAL ISSUED FOR 01/24/2014 APPROVAL FXC ISSUED FOR 05/13/2014 APPROVAL

ENGINEER / CONSULTANT:



CLIENT:

26455 RANCHO PARKWAY SOUTH, LAKE FOREST, CA 92630

(949) 753-8807 OFFICE - (949) 753-8833 FAX



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SITE INFO:

MON15

VERIZON MONTECITO-MON15


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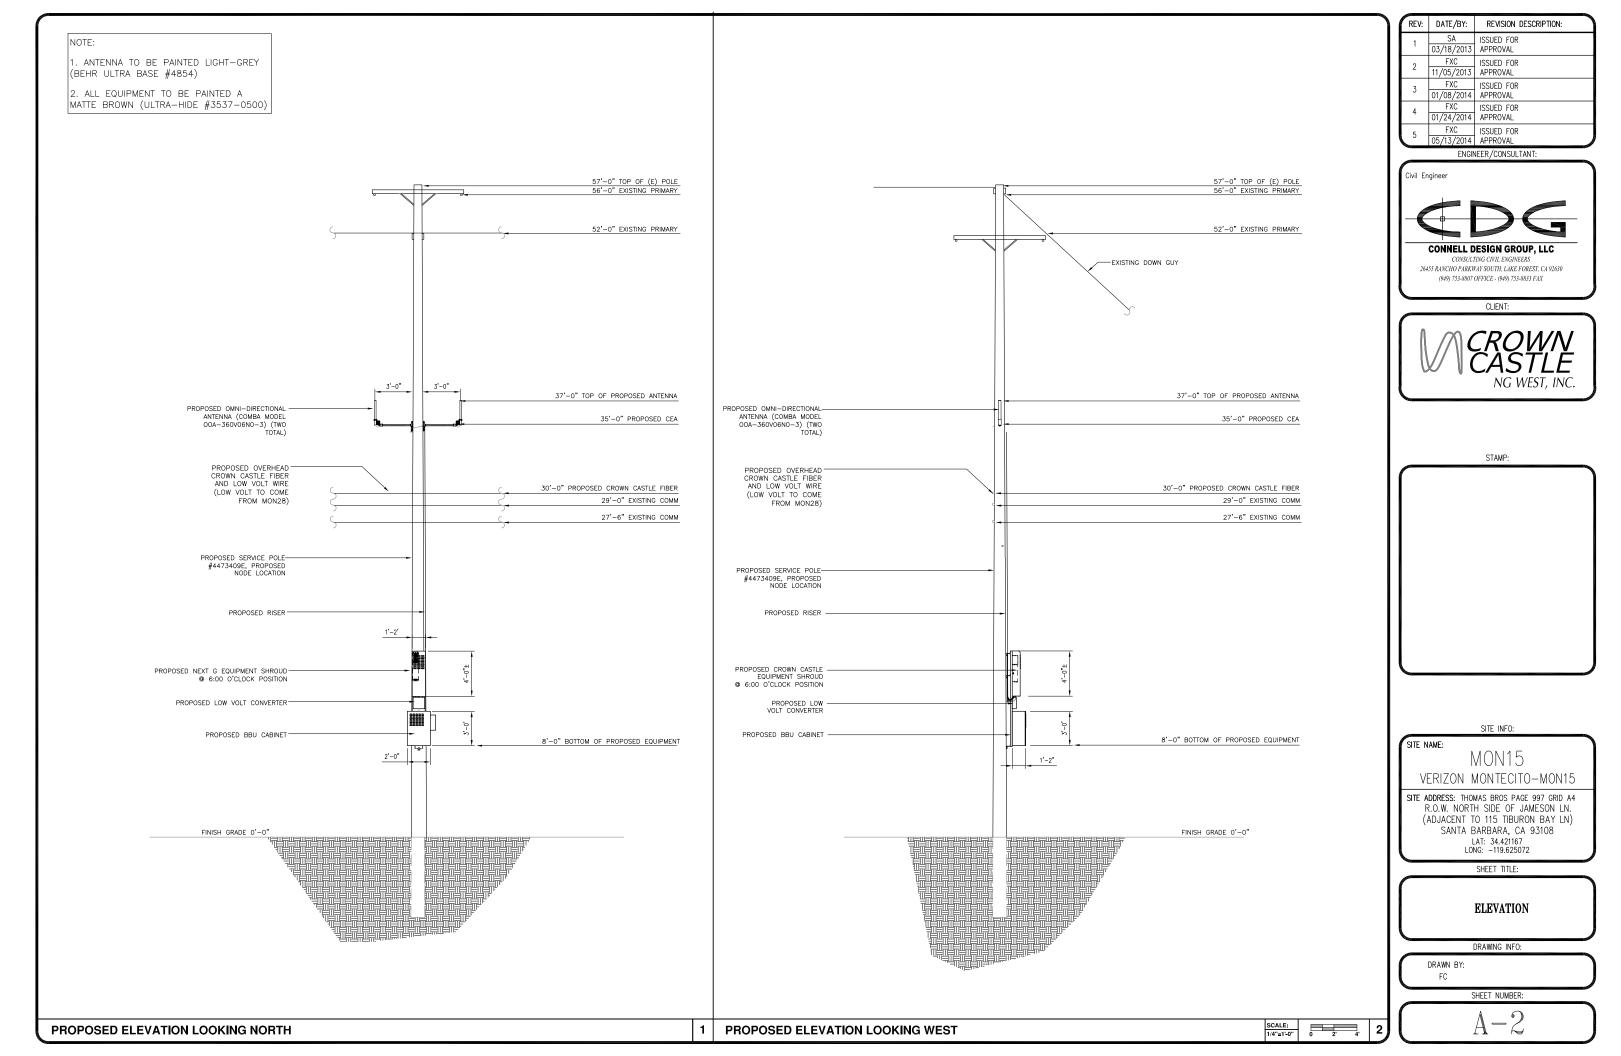
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MON15 R.O.W. NORTH OF JAMESON LN (ADJACENT TO 115 TIBURON BAY LN) LAT: 34.421167 LONG: —119.625072

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2	FXC 11/05/2013	ISSUED FOR APPROVAL
3	FXC 01/08/2014	ISSUED FOR APPROVAL
4	FXC 01/24/2014	ISSUED FOR APPROVAL
5	FXC	ISSUED FOR

ENGINEER/CONSULTANT:

Civil Engineer

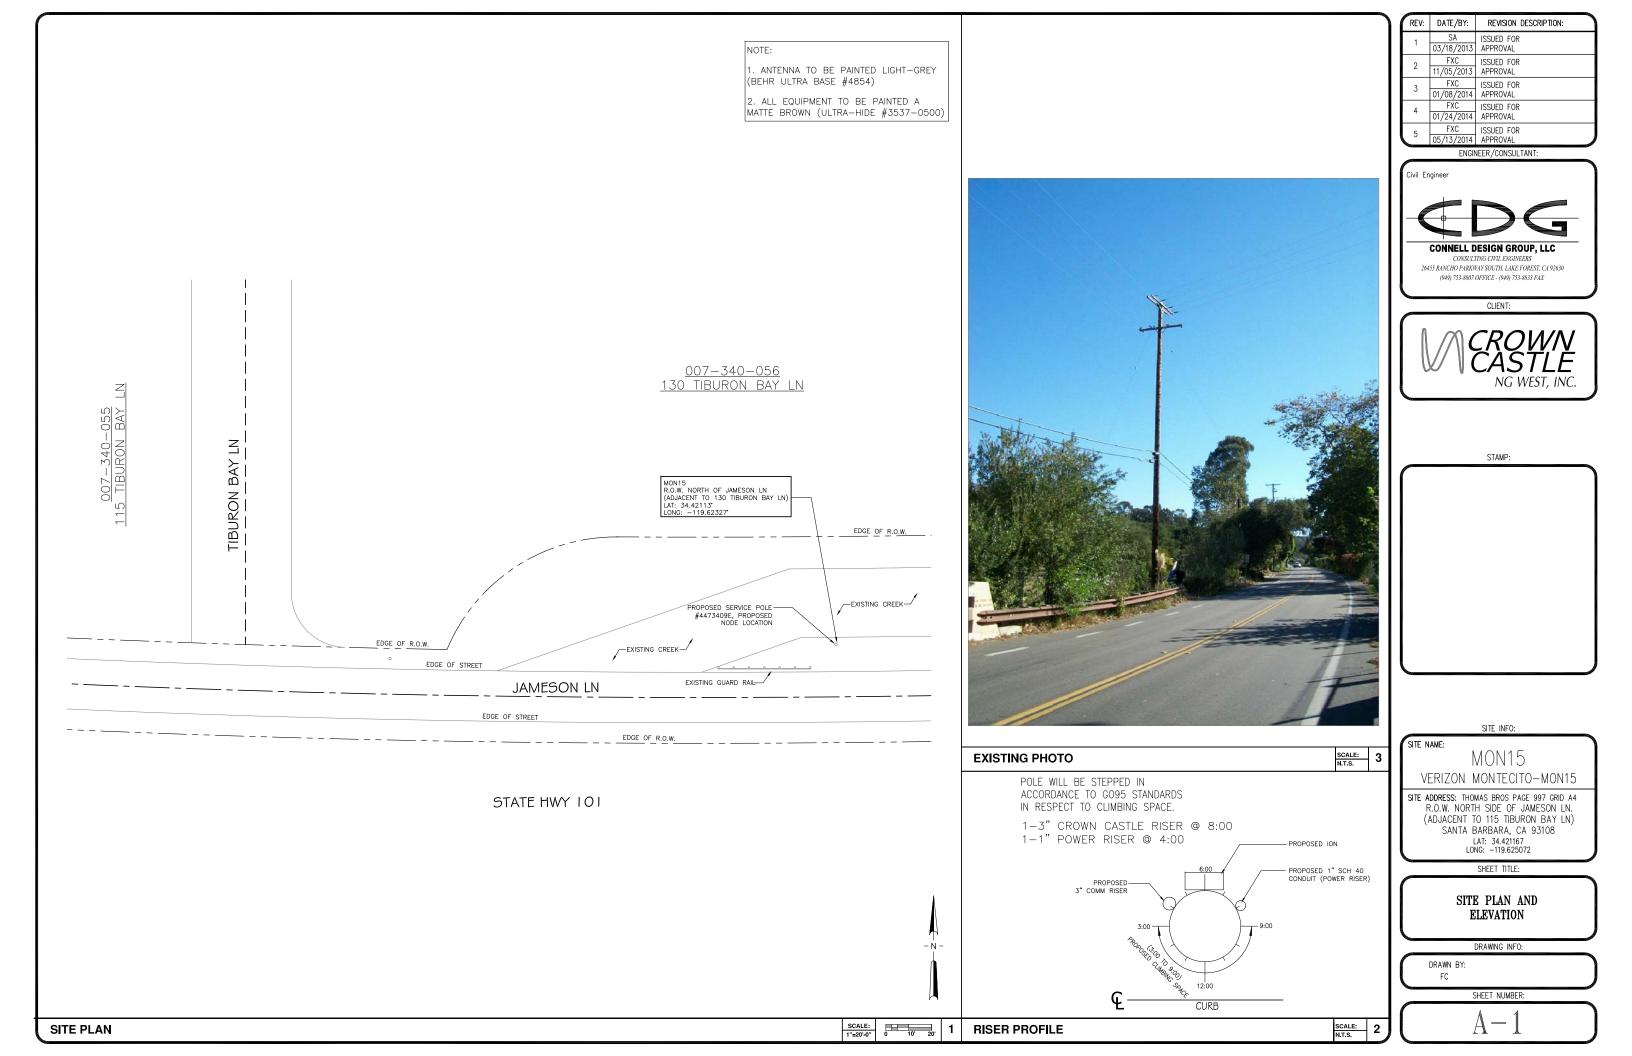

CONNELL DESIGN GROUP, LLC

CONSULTING CIVIL ENGINEERS

26455 RANCHO PARKWAY SOUTH, LAKE FOREST, CA 92630 (949) 753-8807 OFFICE - (949) 753-8833 FAX

CLIENT:



STAMP:

SITE INFO:

SITE NAME:

MON15 VERIZON MONTECITO-MON15

SITE ADDRESS: THOMAS BROS PAGE 997 GRID A4 R.O.W. NORTH SIDE OF JAMESON LN. (ADJACENT TO 115 TIBURON BAY LN) SANTA BARBARA, CA 93108 LAT: 34.421167 LONG: -119.625072

SHEET TITLE:

ESH AREA PLAN

DRAWING INFO:

DRAWN BY: FC

SHEET NUMBER:

 $\Delta - 3$

ESH AREA PLAN

Outdoor Omni-directional Antenna

COMBA

OOA-360V06N0-3 VPol, 696-960/1710-2170MHz, 360°, 4.0/6.0 dBi

Technical Specifications


Electrical

Frequency Range	MHz	696-960	1710–217
Polarization		Vert	ical
Gain	dBi	4.0±1	6.0±1
Horizon tal Beamwidth	deg	36	0
Vertical Beamwidth	deg	22-53	20–26
Electrical Downtilt-Fixed	deg	0	
VSWR	_	1.	8
Maximum Power	W	20	0
lmpedance		5	0
Lightning Protection		Direct	Ground

Mechanical

Dimensions, HxDia mm(in) Weight, with Mounting kit kg (lb)
Radome Material and Color
Radiating Element Material
Connector Type and Location
Operational Temperature
Operational Humidity %
Operational Wind Speed km/h (mph)
Shipping Dimensions, HxWxD mm (in)
Shipping Weight kg (lb)

650x60 (25.6x2.4) 1 (2.2) Fiberglass, Light Grey Copper N-Female, Bottom -55 to +70 95 200 (124) 670x100x100 (26.4x3.9x3.9)

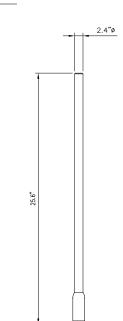

ANTENNA SPECIFICATIONS N.T.S.

Electrical

Power Supply Mains power, Vac	
Power consumption, Watts	
700 MU- CICO/MIMO	ореалы

Frequency range, MHz

698 to 716/776 to 787 . 728 to 757

Output power per carrier*, dBm

Number of Carriers	1	2	4	8
LTE	43	40**	37	34

43 43

850 MHz

CDMA

Frequency range, MHz

	Up Do			824 to 849 869 to 894	
Output power per co	rrier*, c	Bm			
Number of Carriers	1	2	4	8	
naloa	43	40	37	34	

37 37 36

1900 MHz

Frequency range, MHz

1850 to 1915 1930 to 1995

Output power per carrier*, dBm

Number of Co	rriers 1	2	4	8
GSM	43	40	37	34
CDMA	43	40	37	34
LTE	43	40 ***	37	34
UMTS	42	39	36	33



ION-M7P/7P/85P/19P

20W for Cell, Noise figure, dB PCS bands and


. +6 max. 4.5 typical


Mechanical****

Height, width, depth, mm (in) . 817 x 245 x 218 (32.2 x 9.6 x 8.6) Weight, kg (lb) 40 (88.2)

700MHz MIMO

Page 1, February 27, 2013 Company Confidential

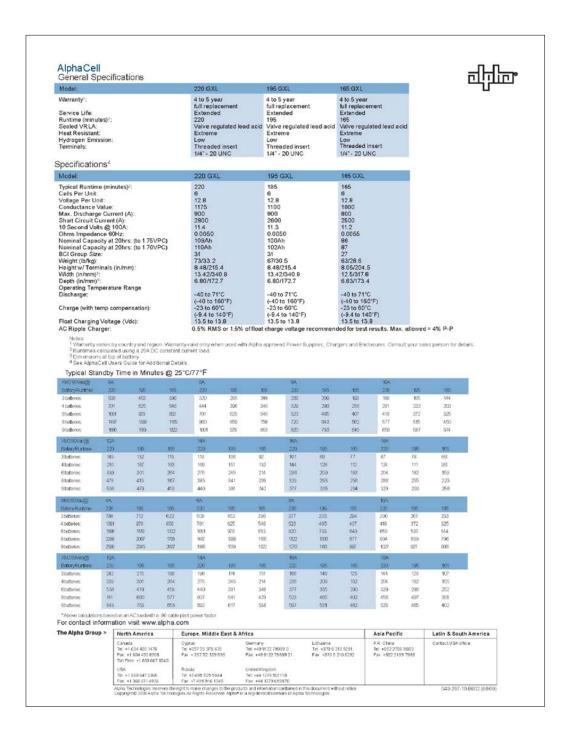

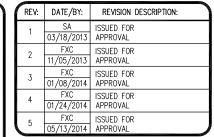

ENGINEER / CONSULTANT:

Civil Engineer CONNELL DESIGN GROUP, LLC

CONSULTING CIVIL ENGINEERS

26455 RANCHO PARKWAY SOUTH, LAKE FOREST, CA 92630

(949) 753-8807 OFFICE - (949) 753-8833 FAX



STAMP:

SITE INFO:

MON15

VERIZON MONTECITO-MON15

SITE ADDRESS: THOMAS BROS PAGE 997 GRID A4 R.O.W. NORTH SIDE OF JAMESON LN. (ADJACENT TO 115 TIBURON BAY LN) SANTA BARBARA, CA 93108 LAT: 34.421167 LONG: -119.625072


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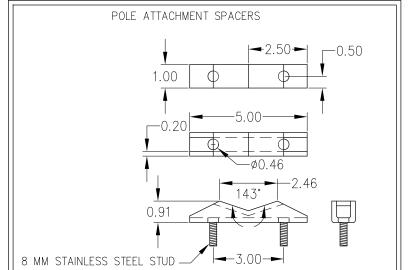
DETAILS


DRAWING INFO:

SHEET NUMBER:

N.T.S. **BATTERY SPECIFICATIONS** N.T.S. ION-M7P/7P/85P/19P



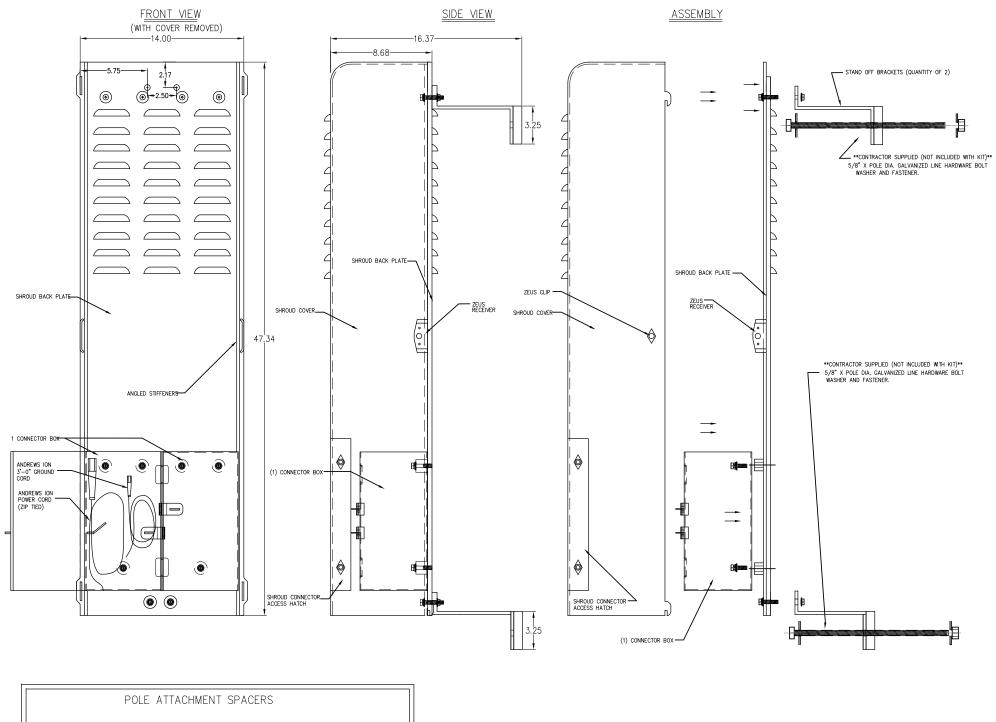

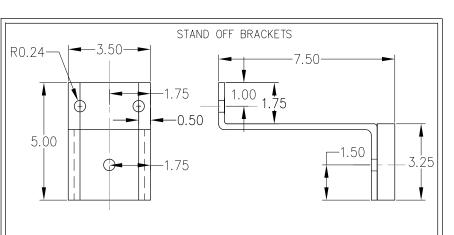

1	1	REV:	DATE/BY:	REVISION DESCRIPTION:
		1	SA 03/18/2013	ISSUED FOR APPROVAL
		2	FXC 11/05/2013	ISSUED FOR APPROVAL
		3	FXC 01/08/2014	ISSUED FOR APPROVAL
		4	FXC 01/24/2014	ISSUED FOR APPROVAL
		5	FXC	ISSUED FOR

Civil Engineer



26455 RANCHO PARKWAY SOUTH, LAKE FOREST, CA 92630 (949) 753-8807 OFFICE - (949) 753-8833 FAX



STAMP:

SITE INFO:

SITE NAME:

MON15 VERIZON MONTECITO-MON15

SITE ADDRESS: THOMAS BROS PAGE 997 GRID A4 R.O.W. NORTH SIDE OF JAMESON LN. (ADJACENT TO 115 TIBURON BAY LN) SANTA BARBARA, CA 93108 LAT: 34.421167 LONG: -119.625072

SHEET TITLE:


DETAILS

DRAWING INFO:

FC

SHEET NUMBER:

SHROUD DETAIL

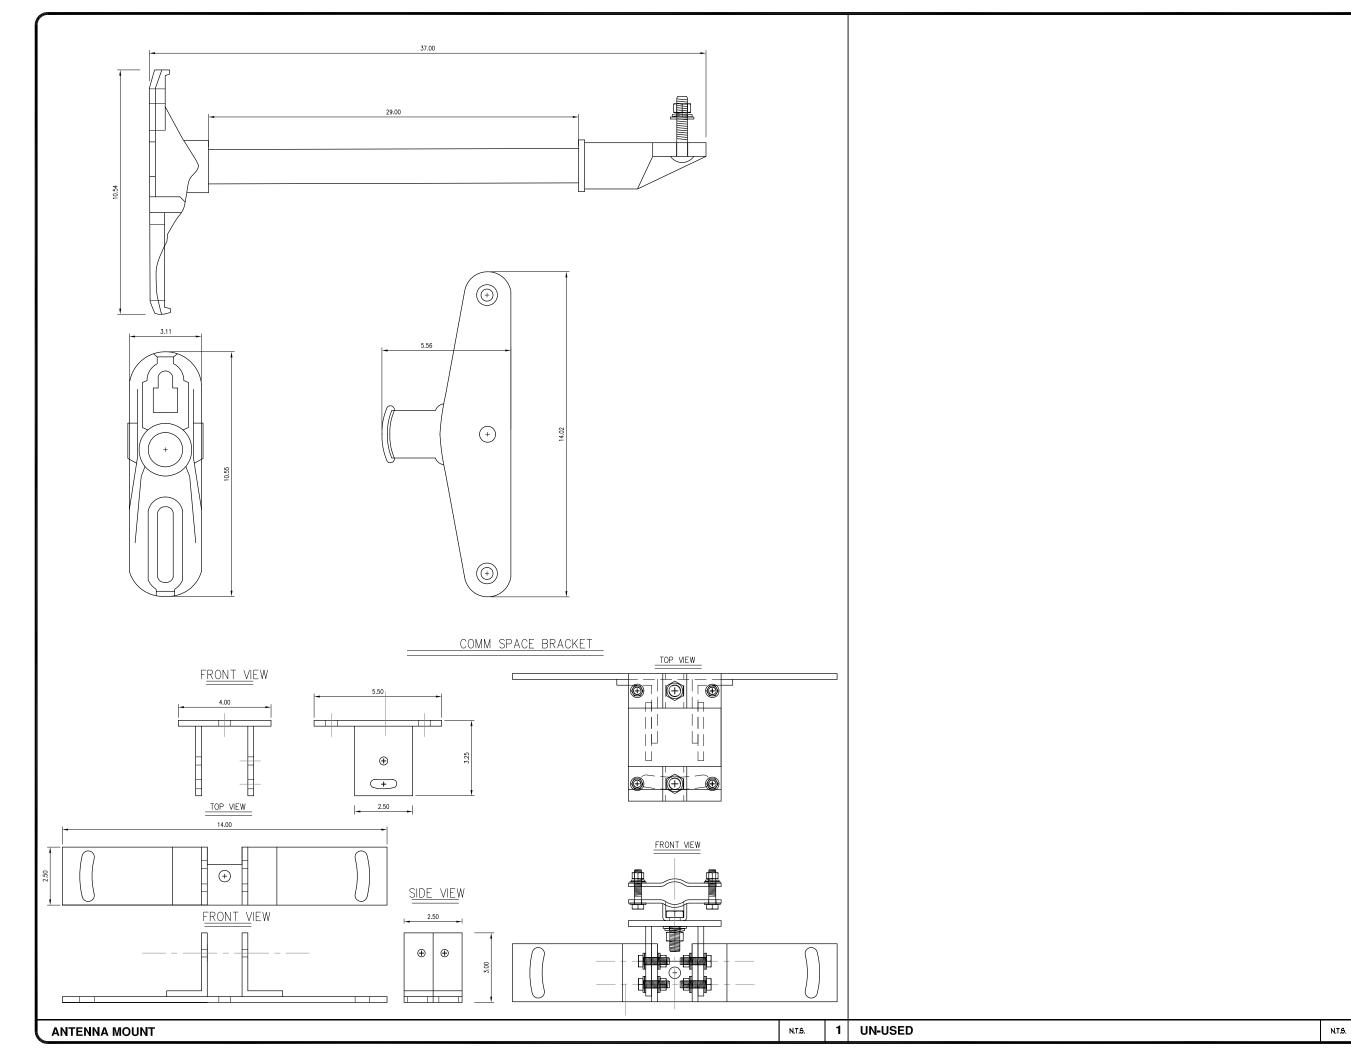

-03		NA.
REV:	DATE/BY:	REVISION DESCRIPTION:
1	SA 03/18/2013	ISSUED FOR APPROVAL
2	FXC 11/05/2013	ISSUED FOR APPROVAL
3	FXC 01/08/2014	ISSUED FOR APPROVAL
4	FXC 01/24/2014	ISSUED FOR APPROVAL
5	FXC 05/13/2014	ISSUED FOR

Civil Engineer



CLIENT:

(949) 753-8807 OFFICE - (949) 753-8833 FAX



STAMP:

SITE INFO:

SITE NAME:

MON15 VERIZON MONTECITO-MON15

SITE ADDRESS: THOMAS BROS PAGE 997 GRID A4 R.O.W. NORTH SIDE OF JAMESON LN. (ADJACENT TO 115 TIBURON BAY LN) SANTA BARBARA, CA 93108 LAT: 34.421167 LONG: -119.625072

SHEET TITLE:

DETAILS

DRAWING INFO:

DRAWN BY FC

SHEET NUMBER:

D-3

- . APPROVAL OF THESE PLANS BY THE CITY ENGINEER DOES NOT AUTHORIZE ANY WORK TO BE PERFORMED UNTIL A PERMIT HAS
- 2. UPON ISSUANCE OF A PERMIT, NO WORK WILL BE PERMITTED ON WEEKENDS OR HOLIDAYS WITHOUT PERMISSION FROM THE
- 3. THE APPROVAL OF THIS PLAN OR ISSUANCE OF A PERMIT BY THE LOCAL JURISDICTION DOES NOT AUTHORIZE THE SUBDIVIDER AND OWNER TO VIOLATE ANY FEDERAL, STATE OR CITY LAWS, ORDINANCES, REGULATIONS, OR POLICIES, INCLUDING, BUT NOT LIMITED TO, THE FEDERAL ENDANGERED SPECIES ACT OF 1973 AND AMENDMENTS THERETO (16 USC SECTION 1531 ET.SEQ.)
- 4. THE CONTRACTOR SHALL BE RESPONSIBLE FOR SURVEY MONUMENTS AND/OR VERTICAL CONTROL BENCHMARKS WHICH ARE DISTURBED OR DESTROYED BY CONSTRUCTION. A LAND SURVEYOR MUST FIELD LOCATE, REFERENCE, AND/OR PRESERVE ALL HISTORICAL OR CONTROLLING MONUMENTS PRIOR TO ANY FARTHWORK. IF DESTROYED, SUCH MONUMENTS SHALL BE REPLACED WITH APPROPRIATE MONUMENTS BY A LAND SURVEYOR, A CORNER RECORD OR RECORD OF SURVEY, AS APPROPRIES, SHALL BE FIELD AS REQUIRED BY THE PROFESSIONAL LAND SURVEYORS ACT. IF ANY VERTICAL CONTROL IS TO BE DISTURBED OR DESTROYED, THE LOCAL JURISDICTION FIELD SURVEY SECTION MUST BE NOTIFIED, IN WRITING, AT LEAST 3 DAYS PRIOR TO THE CONSTRUCTION. THE CONTRACTOR WILL BE RESPONSIBLE FOR THE COST OF REPLACING ANY VERTICAL CONTROL BENCHMARKS
- 5. IMPORTANT NOTICE: SECTION 4216 OF THE GOVERNMENT CODE REQUIRES A DIG ALERT IDENTIFICATION NUMBER BE ISSUED BEFORE A "PERMIT TO EXCAVATE" WILL BE VALID. FOR YOUR DIG ALERT I.D. NUMBER, CALL UNDERGROUND SERVICE ALERT, TWO
- 6. CONTRACTOR SHALL BE RESPONSIBLE FOR THE POTHOLE AND LOCATING OF ALL EXISTING UTILITIES THAT CROSS THE PROPOSED TRENCH LINE AND MUST MAINTAIN 1' MINIMUM VERTICAL CLEARANCE.
- 7. CONTRACTOR SHALL SUBMIT TO THE LOCAL JURISDICTION, A CONSTRUCTION PLAN TO PROTECT WATER MAINS PRIOR TO COMMENCING CONSTRUCTION.
- 8. CONTRACTOR SHALL REPLACE OR REPAIR ALL TRAFFIC SIGNAL LOOPS, CONDUIT, AND LANE STRIPING DAMAGED DURING
- 9. CONTRACTOR SHALL NOTIFY THE LOCAL JURISDICTION. A MINIMUM OF 48 HOURS PRIOR TO COMMENCING WORK WITHIN 10' OF
- 10. THIS PROJECT WILL BE INSPECTED BY ENGINEERING AND CAPITAL PROJECTS DEPARTMENT, FIELD ENGINEERING DIVISION.
- 11. AS-BUILT DRAWINGS MUST BE SUBMITTED TO THE CITY RESIDENT ENGINEER PRIOR TO THE ACCEPTANCE OF THIS PROJECT. 12. PUBLIC IMPROVEMENT SUBJECT TO DESUETUDE OR DAMAGE." IF REPAIR OR REPLACEMENT OF SUCH PUBLIC IMPROVEMENTS IS REQUIRED, THE OWNER SHALL OBTAIN THE REQUIRED PERMITS FOR WORK IN THE PUBLIC RIGHT-OFWAY, SATISFACTORY TO THE PERMIT - ISSUING AUTHORITY.
- 13. PRIOR TO ANY DISTURBANCE TO THE SITE, EXCLUDING UTILITY MARKS-OUTS AND SURVEYING, THE CONTRACTOR SHALL MAKE ARRANGEMENTS FOR A PRE-CONSTRUCTION MEETING WITH THE LOCAL JURISDICTION FIELD ENGINEERING DIVISION.
- 14. PRIOR TO THE COMMENCEMENT OF ANY CONSTRUCTION SHOWN ON THESE PLANS. IT IS THE SOLE RESPONSIBILITY OF THE CONTRACTOR TO COORDINATE. THE CONTRACTOR IS RESPONSIBLE TO ATTEND THE LOCAL JURISDICTIONS MONTHLY UTILITY COORDINATION COMMITTEE THE CONSTRUCTION ACTIVITIES WITH THE CITY AND ALL OTHER CONTRACTORS SO THAT NO TRENCH IS CUT WITHIN ANY OF THE CITY STREETS THAT HAVE BEEN CONSTRUCTED, REPAIRED, OR SLURRY SEALED WITHIN THREE YEARS OF THE STREET CONSTRCTUION/RESURFACING DATE.
- 15. MANHOLES OR COVERS SHALL BE LABELED "CROWN CASTLE" OR "CROWN CASTLE NG WEST".
- 16 CONTRACTOR SHALL IMPLEMENT AN EROSION AND SEDIMENT CONTROL PROCRAM DURING THE PROJECT CONSTRUCTION ACTIVITIES PROGRAM SHALL MEET THE APPLICABLE REQUIREMENTS OF THE STATE WATER RESOURCE CONTROL BOAR
- 17. THE CONTRACTOR SHALL HAVE EMERGENCY MATERIALS AND EQUIPMENT ON HAND FOR UNFORESEEN SITUATIONS, SUCH AS DAMAGE TO UNDERGROUND WATER, SEWER, AND STORM DRAIN FACILITIES WHEREBY FLOWS MAY GENERATE EROSION AND SEDIMENT

SPECIAL NOTES

THE FOLLOWING NOTES ARE PROVIDED TO GIVE DIRECTIONS TO THE CONTRACTOR BY THE ENGINEER OF WORK. THE CITY ENGINEER'S SIGNATURE ON THESE PLANS DOES NOT CONSTITUTE APPROVAL OF THESE NOTES AND THE CITY WILL NOT BE RESPONSIBLE FOR THEIR ENFORCEMENT.

- THE CONTRACTOR SHALL VERIFY THE LOCATION EXISTING UNDERGROUND UTILITIES INCLUDING SEWER LATERALS AND WATER
 SERVICES TO INDIVIDUAL LOTS BOTH VERTICAL AND HORIZONTAL PRIOR TO COMMENCING IMPROVEMENT OPERATIONS.
- 2. CONTRACTOR SHALL MAKE EXPLORATION EXCAVATIONS AND LOCATE EXISTING FACILITIES SUFFICIENTLY AHEAD OF CONSTRUCTION TO PERMIT REVISIONS OF PLANS IF REVISION IS NECESSARY BECAUSE OF LOCATION OF EXISTING UTILITIES.
- 3. LOCATION AND ELEVATIONS OF IMPROVEMENTS, TO BE MET BY WORK, SHALL BE CONFIRMED BY FIELD MEASUREMENT PRIOR TO
- 4. GRADES SHOWN ARE FINISH GRADES, CONTRACTOR SHALL DETERMINE NECESSARY SUB GRADE ELEVATIONS AND SHALL CONSTRUCT SMOOTH TRANSITION BETWEEN FINISH GRADES SHOWN.
- CONTRACTOR AGREES THAT HE SHALL ASSUME SOLE RESPONSIBILITY FOR JOB SITE CONDITION DURING THE COURSE OF CONSTRUCTION OF THIS PROJECT, INCLUDING SAFETY OF ALL PERSONS AND PROPERTY: THAT THIS PROVISION SHALL APPLY CONTINUOUSLY AND NOT BE LIMITED TO NORMAL WORKING HOURS; AND THAT THE CONTRACTOR SHALL DEFEND, INDEMNIFY AND HOLD THE OWNER AND THE ENGINEER HARMLESS FROM ANY AND ALL LIABILITY, REAL OR ALLEGED IN CONNECTION WITH THE PERFORMANCE OF WORK ON THIS PROJECT, EXPECTING FOR LIABILITY ARISING FROM SOLE NEGLIGENCE OF THE OWNER OR THE
- 6. THE CONTRACTOR SHALL BE TOTALLY RESPONSIBLE FOR COMPLIANCE WITH THE PROVISIONS OF THE STATE OF CALIFORNIA SAFETY
- 7. THE LOCATIONS OF ALL EXISTING UTILITIES SHOWN ON THESE PLANS ARE FROM EXISTING RECORDS AND CORROBORATED, WHERE POSSIBLE WITH FIELD TIES. THE CONTRACTOR IS RESPONSIBLE FOR CONFIRMING THE LOCATIONS SHOWN, BOTH HORIZONTALLY AND VERTICALLY, PRIOR TO CONSTRUCTION. IF EXISTING LOCATIONS VARY SUBSTANTIALLY FROM THE PLANS, THE ENGINEER SHOULD BE NOTIFIED TO MAKE ANY CONSTRUCTION CHANGES REQUIRED.
- 8. THE CONTRACTOR SHALL PROVIDE TEMPORARY SUPPORT FOR ALL SEWER AND WATER MAIN UNDER CROSSING IN ACCORDANCE WITH PART 1 SECTION 5-2 OF THE STANDARD SPECIFICATION.
- 9. THE CONTRACTOR SHALL REPLACE OR REPAIR ALL TRAFFIC SIGNAL LOOPS, CONDUITS, AND LANE STRIPING DAMAGED DURING
- 10. THE CONTRACTOR SHALL SUBMIT WORK PLANS FOR ALL BORE OPERATIONS TWO WEEKS PRIOR TO COMMENCING WORK.
- 11. CONTRACTOR SHALL BE RESPONSIBLE FOR THE POTHOLE AND LOCATING OF ALL EXISTING UTILITIES THAT CROSS THE PROPOSED
- 12. AS-BUILT DRAWINGS MUST BE SUBMITTED TO THE CITY ENGINEER PRIOR TO ACCEPTANCE OF THIS PROJECT



CONSTRUCTION CHANGE TABLE CHANGE DATE EFFECTED OR ADDED SHEET NUMBERS

CROWN CASTLE NG WEST, INC

VERIZON MONTECITO-MON16 R.O.W. SOUTH SIDE OF BUENA VISTA DR (ADJACENT TO 900 BUENA VISTA DR) SANTA BARBARA, CA 93108



GROUND BUS BAR MECH. GRND. CONN. CADWELD E ELECTRIC BOX T TELEPHONE BOX EXISTING SERVICE POLE SIDEWALK FLAG EX. MANHOLE	LIGHT POLE FOUNDATION SPOT ELEV. SET POINT REVISION DETAIL REF.	ELEVATION REF. SECTION REF. PROP./LEASE LINE MATCH LINE WORK POINT T TELE. CONDUIT CENTERLINE	ELECT. CONDUIT COAXIAL CABLE MYERS PEDESTAL VAULT STANDARD 2'X3' STEEL POLE
CV	MDOLC LINET	VDEC AND HATCH D.	A TTEDNIC

SYMBOLS, LINETYPES AND HATCH PATTERNS

APPLICABLE CODES

ALL WORK SHALL COMPLY WITH THE FOLLOWING APPLICABLE CODES:

- IN THE EVENT OF CONFLICT, THE MOST RESTRICTIVE CODE SHALL PREVAIL

PROJECT DESCRIPTION

PROJECT CONSISTS OF INSTALLATION OF:

- 1. (2) OMNI DIRECTIONAL ANTENNA ON EXISTING UTILITY POLE
- 2. EQUIPMENT SHROUD AND BBU ON EXISTING POLE

SHEET INDEX:

TITLE SHEET A-1 - SHEET 2 OF 6 SITE PLAN PROPOSED ELEVATIONS A-2 - SHFFT 3 OF 6 D-1 - SHFFT 4 OF 6 DETAILS DETAILS D-2 - SHEET 5 OF 6 DETAILS D-3 - SHEET 6 OF €

EROSION AND SEDIMENT CONTROL NOTES

TEMPORARY EROSION/SEDIMENT CONTROL, PRIOR TO COMPLETION OF FINAL IMPROVEMENTS. SHALL BE PERFORMED BY THE CONTRACTOR OR QUALIFIED PERSON AS INDICATED BELOW:

- 1. ALL REQUIREMENTS OF THE LOCAL JURISDICTION "LAND DEVELOPMENT MANUAL, STORM WATER STANDARDS" MUST BE INCORPORATED INTO THE DESIGN AND CONSTRUCTION OF THE PROPOSED GRADING/IMPROVEMENTS CONSISTENT WITH THE APPROVED STORM WATER AND/OR WATER POLLUTION CONTROL PLAN (WPCP).
- 2. FOR STORM DRAIN INLETS, PROVIDE A GRAVEL BAG SILT BASIN IMMEDIATELY UPSTREAM OF INLET AS INDICATED ON DETAILS.
- 3. FOR INLETS LOCATED AT SUMPS ADJACENT TO TOP OF SLOPES, THE CONTRACTOR SHALL ENSURE THAT WATER DRAINING TO THE SUMP IS DIRECTED INTO THE INLET AND THAT A MINIMUM OF 1.00" FREEBOARD EXISTS AND IS MAINTAINED ABOVE THE TOP OF THE INLET. IF FREEBOARD IS NOT PROVIDED BY GRADING SHOWN ON THESE PLANS, THE CONTRACTOR SHALL PROVIDE IT VIA TEMPORARY MEASURES, I.E. GRAVEL BAGS OR DIKES.
- 4. THE CONTRACTOR OR QUALIFIED PERSON SHALL BE RESPONSIBLE FOR CLEANUP OF SILT AND MUD ON ADJACENT STREET(S) AND STORM DRAIN SYSTEM DUE TO CONSTRUCTION
- 5. THE CONTRACTOR OR QUALIFIED PERSON SHALL CHECK AND MAINTAIN ALL LINED AND UNLINED DITCHES AFTER EACH RAINFALL.
- 6. THE CONTRACTOR SHALL REMOVE SILT AND DEBRIS AFTER EACH MAJOR RAINFALL.
- 7. EQUIPMENT AND WORKERS FOR EMERGENCY WORK SHALL BE MADE AVAILABLE AT ALL TIMES DURING THE RAINY SEASON, ALL NECESSARY MATERIALS SHALL BE STOCKPILED ON SITE AT CONVENIENT LOCATIONS TO FACILITATE RAPID CONSTRUCTION OF TEMPORARY DEVICES WHEN RAIN IS IMMINENT.
- 8. THE CONTRACTOR SHALL RESTORE ALL EROSION/SEDIMENT CONTROL MEASURES TO WORKING ORDER TO THE SATISFACTION OF THE CITY ENGINEER OR RESIDENT ENGINEER AFTER EACH RUN-OFF PRODUCING RAINFALL.
- THE CONTRACTOR SHALL INSTALL ADDITIONAL EROSION CONTROL MEASURES AS MAY BE REQUIRED BY THE RESIDENT ENGINEER DUE TO UNCOMPLETED GRADING OPERATIONS OR UNFORESEEN CIRCUMSTANCES, WHICH MAY ARISE.
- 10. THE CONTRACTOR SHALL BE RESPONSIBLE AND SHALL TAKE NECESSARY PRECAUTIONS TO PREVENT PUBLIC TRESPASS ONTO AREAS WHERE IMPOUNDED WATERS CREATE A HAZARDOUS CONDITION.
- 11. ALL EROSION/SEDIMENT CONTROL MEASURES PROVIDED PER THE APPROVED GRADING PLAN SHALL BE INCORPORATED HEREON. ALL EROSION/SEDIMENT CONTROL FOR INTERIM CONDITIONS SHALL BE DONE TO THE SATISFACTION OF THE RESIDENT ENGINEER.
- 12 CRADED AREAS AROUND THE PROJECT PERIMETER MUST DRAIN AWAY FROM THE FACE OF THE SLOPE AT THE CONCLUSION OF EACH WORKING DAY. 13. ALL REMOVABLE PROTECTIVE DEVICES SHOWN SHALL BE IN PLACE AT THE END OF EACH
- WORKING DAY WHEN RAIN IS IMMINENT. 14. THE CONTRACTOR SHALL ONLY GRADE, INCLUDING CLEARING AND GRUBBING FOR THE AREAS FOR WHICH THE CONTRACTOR OR QUALIFIED PERSON CAN PROVIDE EROSION/SEDIMENT CONTROL MEASURES.
- 15 THE CONTRACTOR SHALL ARRANGE FOR WEEKLY MEETINGS DURING OCTORER 1ST TO APRIL 30TH FOR PROJECT TEAM (GENERAL CONTRACTOR, QUALIFIED PERSON, EROSION CONTROL SUBCONTRACTOR IF ANY, ENGINEER OF WORK, OWNER AND THE RESIDENT ENGINEER) TO EVALUATE THE ADEQUACY OF THE EROSION/SEDIMENT CONTROL MEASURES AND OTHER RELATED CONSTRUCTION ACTIVITIES.

TRAFFIC CONTROL NOTES

THE CONTRACTOR SHALL SUBMIT A TRAFFIC CONTROL PLAN (11" X 17") FOR APPROVAL PRIOR TO STARTING WORK. THE PLAN SHOULD BE SUBMITTED TO THE TRAFFIC CONTROL PERMIT COUNTER. CONTRACTOR SHALL OBTAIN A TRAFFIC CONTROL PERMIT A MINIMUM OF TWO (2) WORKING DAYS PRIOR TO STARTING WORK, AND A MINIMUM FIVE (5) DAYS IF WORK WILL AFFECT A BUS STOP OR AN EXISTING TRAFFIC SIGNAL, OR IF WORK WILL REQUIRE A

FOOTAGE TOTALS		
ASPHALT CUT	-	
DIRT TRENCH	-	
PUNCH THRU	-	
BORE	-	
TOTAL	=	
R&R SWF TOTAL	-	

PROJECT DICTIONARY

SITE ADDRESS: R.O.W. SOUTH SIDE OF BUENA VISTA DR (ADJACENT TO 900 BUENA VISTA DR) SANTA BARBARA, CA 93108

APPLICANT: CROWN CASTLE NG WEST, LLC 2125 WRIGHT AVE, SUITE #C9 LA VERNE, CA 91750 CONTACT: HEIDI PAYNE

PHONE: (949) 310-9493

CONNELL DESIGN GROUP, LLC CIVIL ENGINEER: 26455 RANCHO PARKWAY SOUTH LAKE FOREST, CA 92630 CONTACT: FRANK CARTER

(949) 310-8233 PHONE (949) 753-8833 FAX

REVISION DESCRIPTION: DATE/BY: ISSUED FOR 03/15/2013 REVIEW FXC ISSUED FOR 03/27/2013 FINAL FXC ___ ISSUED FOR 11/05/2013 FINAL ISSUED FOR 02/18/2013 FINAL

ENGINEER/CONSULTANT:




26455 RANCHO PARKWAY SOUTH, LAKE FOREST, CA 92630

(949) 753-8807 OFFICE - (949) 753-8833 FAX

CLIENT:



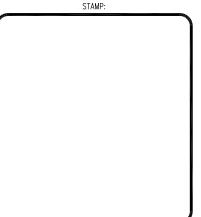

SITE INFO:

MON16m1 VERIZON MONTECITO-MON16m1

SITE ADDRESS: THOMAS BROS PAGE 987 GRID C7 R.O.W. SOUTH SIDE OF BUENA VISTA DR (ADJACENT TO 900 BUENA VISTA DR) SANTA BARBARA, CA 93108 LAT: 34.4469847* LONG: -119.6106914

SHEET TITLE:

TITLE SHEET

DRAWING INFO:



REVISION DESCRIPTION: FXC ISSUED FOR 03/15/2013 REVIEW FXC ISSUED FOR FINAL FXC ISSUED FOR 11/05/2013 FINAL FXC ISSUED FOR 02/18/2013 FINAL

ENGINEER/CONSULTANT:



26455 RANCHO PARKWAY SOUTH, LAKE FOREST, CA 92630

CLIENT:



STAMP:

SITE INFO:


MON16m1 VERIZON MONTECITO-MON16m1

SITE ADDRESS: THOMAS BROS PAGE 987 GRID C7 R.O.W. SOUTH SIDE OF BUENA VISTA DR (ADJACENT TO 900 BUENA VISTA DR) SANTA BARBARA, CA 93108 LAT: 34.4469847* LONG: -119.6106914*

SHEET TITLE:

SITE PLAN, ENLARGED SITE PLAN AND EXISTING PHOTO

DRAWING INFO:

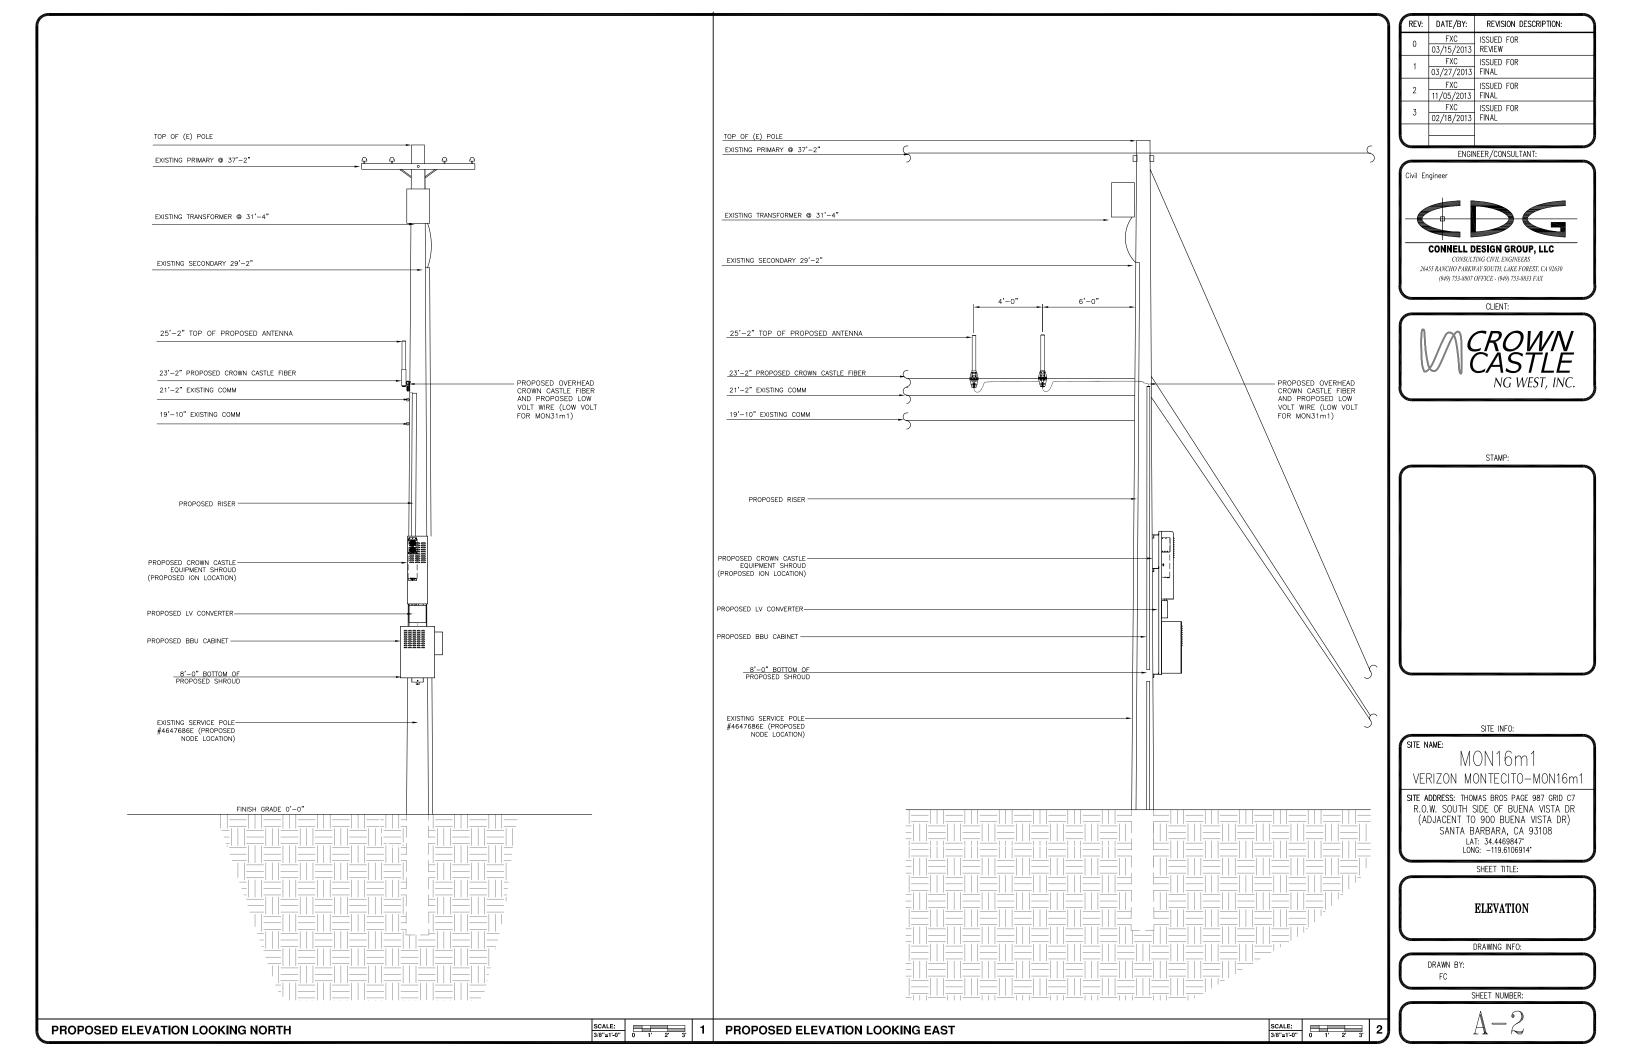

Outdoor Omni-directional Antenna

COMBA

OOA-360V06N0-3 VPol, 696-960/1710-2170MHz, 360°, 4.0/6.0 dBi

Technical Specifications

_				- 1
⊢ /	0	ctr	10	α I

Frequency Range	MHz	696-960	1710-217
Polarization		Vert	ical
Gain	dBi	4.0 ± 1	6.0±1
Horizon tal Beamwidth	deg	36	0
Vertical Beamwidth	deg	22-53	20–26
Electrical Downtilt—Fixed	deg	0	
VSWR		1.	8
Maximum Power	W	20	0
mpedance		5	0
ightning Protection		Direct	Ground

Mechanical

Dimensions HxDia 650x60 (25.6x2.4) Weight, with Mounting kit Radome Material and Color Fiberglass, Light Grey Radiating Element Material Connector Type and Location Operational Temperature Operational Humidity N-Female, Bottom -55 to +70 95 Operational Wind Speed km/h (mph)
Shipping Dimensions, HxWxD mm (in)
Shipping Weight kg (lb) 200 (124) 670x100x100 (26.4x3.9x3.9) 1.2 (2.65)



ANTENNA SPECIFICATIONS N.T.S.

1 (2.2)

Copper

Electrical

Power Supply Mains power, Vac	 115 or 230
Power consumption, Watts	 1100 max. < 750 @ normal operation

700 MHz SISO/MIMO

Frequency range, MHz 698 to 716/776 to 787 728 to 757

Output power per carrier*, dBm

Number of Carriers 1

850 MHz

Frequency range, MHz 824 to 849 869 to 894

Output power per carrier*, dBm

43 37 37 CDMA 37 36



1900 MHz Frequency range, MHz

Output power per carrier*, dBm

LTE 40 **



ION-M7P/7P/85P/19P

20W for Cell, Noise figure, dB

1850 to 1915 1930 to 1995

Mechanical****

Alpha Cell General Specifications



Specifications4

Model:	220 GXL	195 GXL	165 GXL
Typical Runtime (minutes)2:	220	195	165
Cells Per Unit:	6	6	6
Voltage Per Unit:	12.8	12.8	12.8
Conductance Value:	1175	1100	1000
Max. Discharge Current (A):	900	900	800
Short Circuit Current (A):	2800	2600	2500
10 Second Volts @ 100A:	11.4	11.3	11.2
Ohms Impedance 60Hz:	0.0050	0.0050	0.0055
Nominal Capacity at 20hrs: (to 1.75VPC)	109Ah	100Ah	86
Iominal Capacity at 20hrs: (to 1.70VPC)	110Ah	102Ah	87
BCI Group Size:	31	31	27
Veight (lb/kg):	73/33.2	67/30.5	63/28.6
leight w/ Terminals (in/mm):	8.48/215.4	8.48/215.4	8.05/204.5
Vidth (in/mm) ³ :	13.42/340.9	13.42/340.9	12.5/317.8
epth (in/mm) ³ :	6.80/172.7	6.80/172.7	6.83/173.4
Operating Temperature Range			
Discharge:	-40 to 71°C	-40 to 71°C	-40 to 71°C
	(-40 to 160°F)	(-40 to 160°F)	(-40 to 160°F)
Charge (with temp compensation):	-23 to 60°C	-23 to 60°C	-23 to 60°C
	(-9.4 to 140°F)	(-9.4 to 140°F)	(-9.4 to 140°F)
Float Charging Voltage (Vdc):	13.5 to 13.8	13.5 to 13.8	13.5 to 13.8
AC Ripple Charger:	0.5% RMS or 1.5% of	float charge voltage recom	mended for best results. Max.

Twarrarty varies by country and region. Warranty valid only when used with Alpha approved Power Supplies, Chargers and Enclosures. Consult your sales person for details 2 Runtimes calculated using a 25A DC constant current load.

Dimensions at top of battery.

⁴ See AlphaCell Users Guide for Additional Details. Typical Standby Time in Minutes @ 25°C/77°F

04M290Vac(2)	44			64			86			10A		
BatteryRuntme	220	195	165	220	195	165	220	195	165	220	195	165
3 batteries:	508	453	396	320	285	249	296	209	193	186	165	544
4 batteries.	701	625	546	444	396	346	329	293	258	261	232	203
6 batteries.	1091	978	853	701	625	546	523	465	407	418	372	325
8 batteries	1487	1338	1105	960	859	750	720	643	562	577	515	450
9 batteries:	1686	1519	1322	1091	978	853	820	733	640	659	587	514
OM290Vacigo	12A	_		14A	_		16A			18A		_
Battery Runtime	220	195	165	220	195	165	220	195	185	220	195	165
3 betteries	149	132	115	119	106	92	101	89	77	87	78	66
4 batteries	210	187	163	169	151	132	144	128	112	124	111	96
6 batteries:	339	301	264	275	245	214	236	209	183	204	182	159
8 batteries	478	419	367	385	341	299	329	293	256	288	255	223
9 betteries	538	479	419	440	391	342	377	335	294	329	293	256
KM260Vac@	4A			BA			8A			10A		
BatteryRuntime:	220	195	165	220	195	165	220	195	165	220	195	185
3 batteries:	798	712	622	508	453	396	377	335	294	300	267	233
1 bettenes:	1091	978	853	701	625	546	523	465	407	418	372	325
6 batteries:	1686	1519	1322	1091	978	853	820	733	640	659	587	514
8 batteries:	2288	2067	1798	1487	1338	1165	1122	1006	877	904	809	706
9 betteries:	2500	2345	2087	1686	1519	1322	1273	1143	997	1027	921	803
XM260Vac@	12A			144			16A			184		
Battery Runtime:	220	195	1165	220	195	165	220	196	165	220	195	165
3 batteries	242	215	188	196	174	151	186	148	125	144	128	107
4 batteries:	339	301	264	275	245	214	236	209	182	204	182	155
Strattenes:	538	479	419	440	391	340	377	335	290	329	293	252
B batteries	741	660	577	607	541	470	523	465	402	458	407	351
9 batteries	843	763	658	692	617	538	597	531	462	523	465	402

"Above calculations based on an ACloadwith a 90 cable plant power factor.
For contact information visit www.alpha.com

The Alpha Group

North America	Europe, Middle East 8	& Africa		Asia Pacific	Latin & South America
Canada Ter +1 604 430 1476 Fax: +1 604 430 8908 Toll Free: +1 800 667 8743	Cyprus Tel: +357 25 375 675 Fax: +357 52 369 596	Germany Tel: +49 9122 79889 0 Fax: +49 9122 79889 21	Lithuania Tet +370 5 210 5291 Fax: +370 5 210 5292	P.R. China Tel: +852 2736 8663 Fax: +852 2199 7988	Contact USA office
USA Tel: +1 360 647 2360 Fax: +1 360 671 4936	Russia Tel: +7495 925 9844 Fax: +7495 916 1349	United Kingdom Tel: +44 1279 501110 Fax: +44 1279 659870			

REVISION DESCRIPTION: REV: DATE/BY: ISSUED FOR 03/15/2013 REVIEW FXC ISSUED FOR 03/27/2013 FINAL FXC ISSUED FOR 11/05/2013 FINAL FXC ISSUED FOR 02/18/2013 FINAL

ENGINEER/CONSULTANT:

Civil Engineer CONNELL DESIGN GROUP, LLC CONSULTING CIVIL ENGINEERS

CLIENT:

26455 RANCHO PARKWAY SOUTH, LAKE FOREST, CA 92630 (949) 753-8807 OFFICE - (949) 753-8833 FAX



STAMP:

SITE INFO:

SITE NAME: MON16m1 VERIZON MONTECITO-MON16m1

SITE ADDRESS: THOMAS BROS PAGE 987 GRID C7 R.O.W. SOUTH SIDE OF BUENA VISTA DR (ADJACENT TO 900 BUENA VISTA DR) SANTA BARBARA, CA 93108 LAT: 34.4469847* LONG: -119.6106914*

SHEET TITLE:

DETAILS

DRAWING INFO:

N.T.S.


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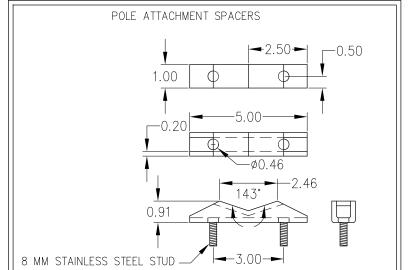
Height, width, depth, mm (in) . 817 x 245 x 218 (32.2 x 9.6 x 8.6) Weight, kg (lb) 40 (88.2) Page 1, February 27, 2013 Company Confidential ION-M7P/7P/85P/19P N.T.S.


PCS bands and

700MHz MIMO

2 BATTERY SPECIFICATIONS



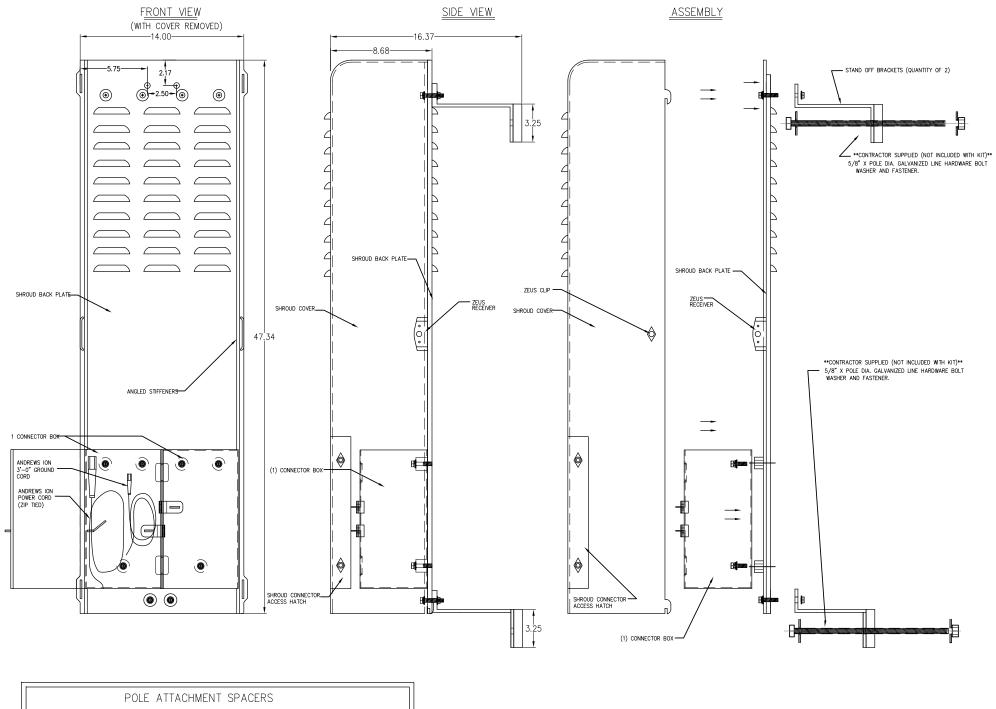

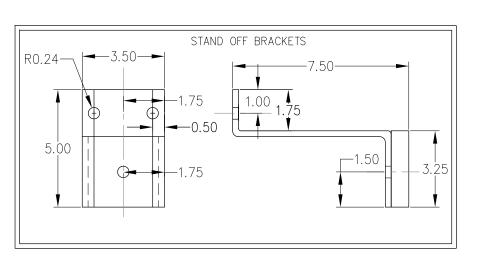

1	1	REV:	DATE/BY:	REVISION DESCRIPTION:
		0	FXC 03/15/2013	ISSUED FOR REVIEW
		1	FXC 03/27/2013	ISSUED FOR FINAL
		2	FXC 11/05/2013	ISSUED FOR FINAL
		3	FXC 02/18/2013	ISSUED FOR FINAL
	IJ			

Civil Engineer



26455 RANCHO PARKWAY SOUTH, LAKE FOREST, CA 92630 (949) 753-8807 OFFICE - (949) 753-8833 FAX



STAMP:

SITE INFO:

SITE NAME:

MON16m1 VERIZON MONTECITO-MON16m1

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SHEET TITLE:

DETAILS


DRAWING INFO:

FC FC

SHEET NUMBER:

D-2

SHROUD DETAIL

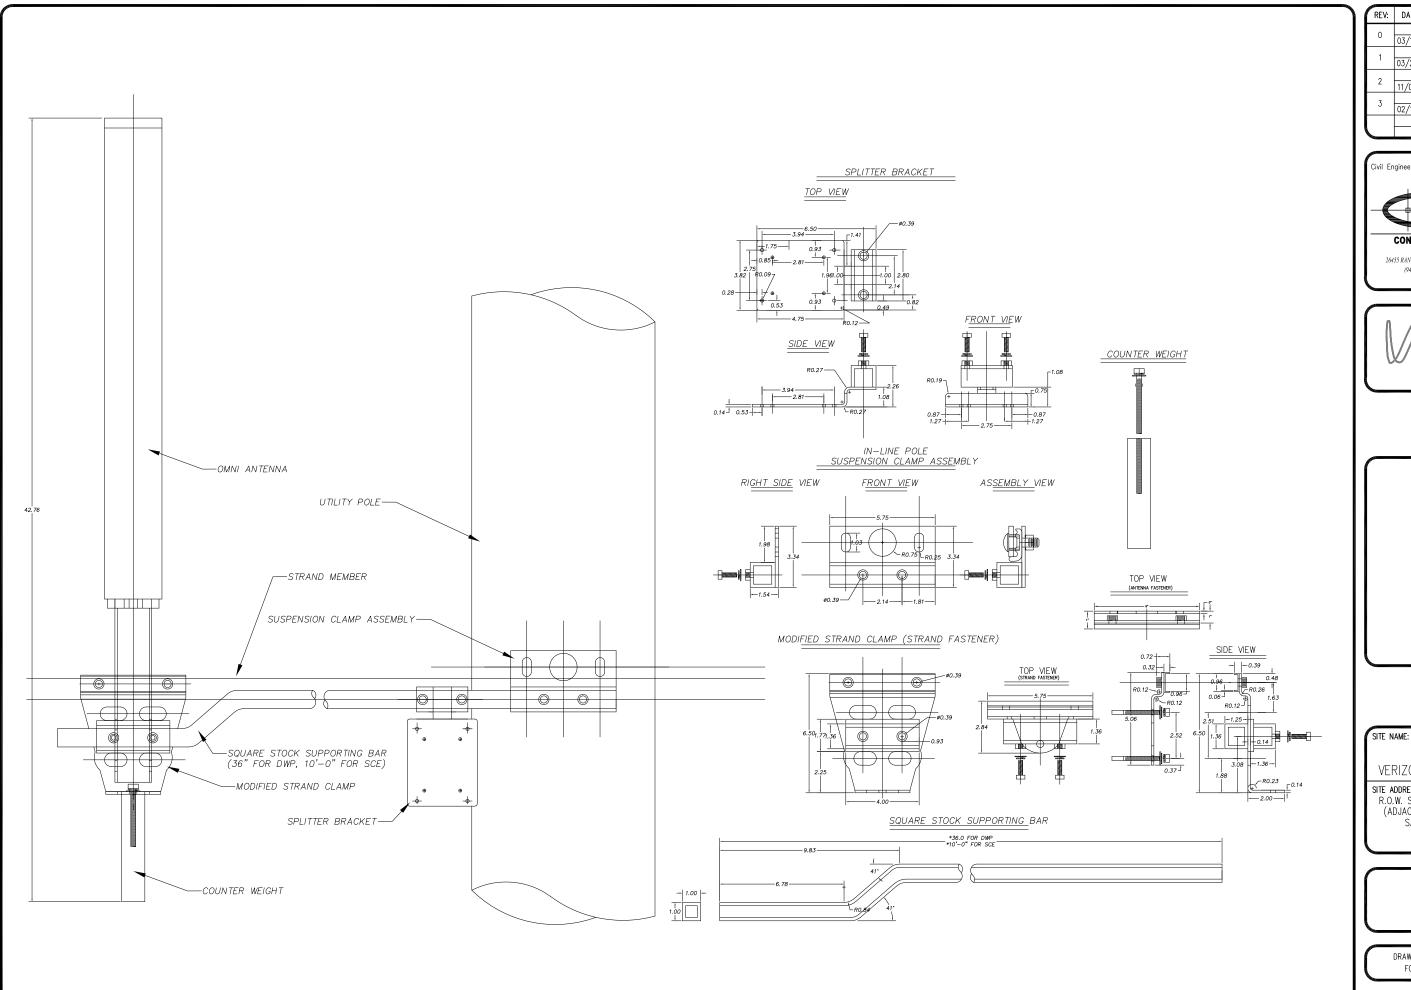

ANTENNA MOUNT

	REV:	DATE/BY:	REVISION DESCRIPTION:
l	0	FXC 03/15/2013	ISSUED FOR REVIEW
l	1	FXC 03/27/2013	ISSUED FOR FINAL
l	2	FXC 11/05/2013	ISSUED FOR FINAL
l	3	FXC 02/18/2013	ISSUED FOR FINAL
L			

ENGINEER/CONSULTANT:

Civil Engineer

CONNELL DESIGN GROUP, LLC CONSULTING CIVIL ENGINEERS

26455 RANCHO PARKWAY SOUTH, LAKE FOREST, CA 92630 (949) 753-8807 OFFICE - (949) 753-8833 FAX

CLIENT:



STAMP:

SITE INFO:

MON16m1 VERIZON MONTECITO-MON16m1

SITE ADDRESS: THOMAS BROS PAGE 987 GRID C7 R.O.W. SOUTH SIDE OF BUENA VISTA DR (ADJACENT TO 900 BUENA VISTA DR) SANTA BARBARA, CA 93108 LAT: 34.4469847* LONG: -119.6106914*

SHEET TITLE:

DETAILS

DRAWING INFO:

FC


SHEET NUMBER:

GENERAL NOTES

- APPROVAL OF THESE PLANS BY THE CITY ENGINEER DOES NOT AUTHORIZE ANY WORK TO BE PERFORMED UNTIL A PERMIT HAS BEEN ISSUED.
- UPON ISSUANCE OF A PERMIT, NO WORK WILL BE PERMITTED ON WEEKENDS OR HOLIDAYS WITHOUT PERMISSION FROM THE ENGINEERING DEPARTMENT.
- I. THE CONTRACTOR SHALL BE RESPONSIBLE FOR SURVEY MONUMENTS AND/OR VERTICAL CONTROL BENCHMARKS WHICH ARE DISTURBED OR DESTROYED BY CONSTRUCTION, A LAWN SURVEYOR MUST FIELD LOCATE, RETERBUCE, AND/OR PRESERVE ALL HISTORICAL OR CONTROLLEN MONUMENTS PROPE TO ANY EARTHWORK. IF DESTROYED, SUCH MONUMENTS SHALL BE REPLACED WITH APPROPRIATE MONUMENTS BY A LAWN SURVEYOR A CORNER RECORD OR RECORD OF SURVEY, AS A PROPER SOUND, INC. OF ANY VERTICAL CONTROLL IS TO BE DISTURBED OR DESTROYED, THE LOCAL JURESDICTION FIELD SURVEY SECTION MUST BE NOTIFED, IN WRITING, AT LESST 3 DAYS PROOK TO THE CONSTRUCTION. THE CONTROLL ON THE PROPERTY SECTION MUST BE NOTIFED, IN WRITING, AT LESST 3 DAYS PROOK TO THE CONSTRUCTION. THE CONTROLL ON THE CONSTRUCTION. THE APPROVAL OF THIS PAW OR ISSUANCE OF A PERMIT BY THE LOCAL JURISDICTION. DOES NOT JURIFICATE THE RISDIONDER AND OWNER TO VIACATE ANY FEDERAL STATE OR OTITY WAS ORDINAVEZES, REGULATIONS, OR POLICES, NICLUDING, BUT NOT LUMITED TO, THE FEDERAL ENDIANCERED SPECIES ACT OF 1973 AND ANADOMENTS THERETO (16 USES SECTION 1531 ETSED.).
- MEORIAM NOTCE: SCOTON 4216 OF THE CONERNMENT CODE REQUIRES A DIG ALERT DENTRICATION NUMBER BE ISSLED BETORE A "PENALT TO ECKAMET" WILL BE VALID. FOR YOUR DIG ALERT 1.D. NUMBER, CALL UNDERGROUND SERVICE ALERT, TWO DAYS BEFORE YOU DIG.
- CONTRACTOR SHALL BE RESPONSIBLE FOR THE POTHOLE AND LOCATING OF ALL EXISTING UTILITIES THAT CROSS THE PROPOSED TRENCH LINE AND MUST MAINTAIN 1' MINIMUM VERTICAL CLEARANCE. CONTRACTOR SHALL SUBMIT TO THE LOCAL JURISDICTION, A CONSTRUCTION PLAN TO PROTECT WATER MAINS PRIOR TO COMMENCING CONSTRUCTION.
- CONTRACTOR SHALL REPLACE OR REPAIR ALL TRAFFIC SIGNAL LOOPS, CONDUIT, AND LANE STRIPING DAMAGED DURING CONSTRUCTION.
- CONTRACTOR SHALL NOTIFY THE LOCAL JURISDICTION. A MINIMUM OF 48 HOURS PRIOR TO COMMENCING WORK WITHIN 10° OF ALL SEWER, WATER, AND STORNORAIN MAIN INCLUDING ALL CROSSINGS. THIS PROJECT WILL BE INSPECTED BY ENGINEERING AND CAPITAL PROJECTS DEPARTMENT, FIELD ENGINEERING DIVISION.
- . PIRELO, MERONZEMENT SUBJECT TO DESIETUDE OR DAMAGE" IF REPAIR OR REPLACEMENT OF SUCH PUBLIC AMPROPLEMENTS IS REQUIRED, THE OWNER SHALL OBTAIN THE REQUIRED PERMITS FOR WORK IN THE PUBLIC RIGHT-OPMAY, SATISFACTORY TO THE PERMIT ISSUING AUTHORITY. AS-BUILT DRAWINGS MUST BE SUBMITTED TO THE CITY RESIDENT ENGINEER PRIOR TO THE ACCEPTANCE OF THIS PROJECT.
- PRIOR TO ANY DISTURBANCE TO THE SITE, EXCLUDING UTILITY MARKS-OUTS AND SURVEYING, THE CONTRACTOR SHALL MAKE RRANGEMENTS FOR A PRE-CONSTRUCTION MEETING WITH THE LOCAL JURISDICTION FIELD ENGINEERING DIVISION.
- 4. PRIOR TO THE COMMENCEMENT OF ANY CONSTRUCTION SHOWN ON THESE PLANS. IT IS THE SOLE RESPONSIBILITY OF THE CONTRACTOR TO COORDINATE. THE CONTRACTOR IS RESPONSIBLE TO ATTEND THE LOCAL JURISDICTIONS MONTHLY UTILITY COORDINATION COMMITTEE THE CONSTRUCTION ACTIVITIES WITH THE CITY AND ALL OTHER CONTRACTORS SO THAT NO TREWH IS CUT WITHIN AWY OF THE CITY STREETS THAT HAVE BEEN CONSTRUCTED, REPARED, OR SLURRY SEALED WITHIN THREE YEARS OF THE STREET CONSTRUCTUON/RESURFACION DATE.
- 15. MANHOLES OR COVERS SHALL BE LABELED "CROWN CASTLE" OR "CROWN CASTLE NG WEST"
- CONTRACTOR SHALL IMPLEMENT AN EROSION AND SEDIMENT CONTROL PROGRAM DURING THE PROJECT CONSTRUCTION ACTIVITIES THE PROGRAM SHALL MEET THE APPLICABLE REQUIREMENTS OF THE STATE WATER RESOURCE CONTROL BOARD.
- . THE CONTRACTOR SHALL HAVE EMERGENCY MATERIALS AND EQUIPMENT ON HAVO FOR UNFORESEEN STUATIONS, SUCH AS DAMAGE TO UNDERGROUND WATER, SEMEN, AND STORM DRAIN FACILITIES WHEREBY FLOWS MAY GENERATE EROSION AND SEDMENT POLLUTION.

SPECIAL NOTES


- Fallowing Mots are provided to give directions to the contractor by the engineer of work. The city inverts's somature on these plans does not constitute approval of these motes and the city will not be provided for their engrecadent.
- THE CONTRACTOR SHALL VERIFY THE LOCATION EXISTING UNDERGROUND UTILITIES INCLUDING SEWER LATERALS AND WATER SERVICES TO INDIVIDUAL LOTS BOTH VERTICAL AND HORIZONTAL PRIOR TO COMMENCING IMPROVEMENT OPERATIONS.
- LOCATION AND ELEVATIONS OF IMPROVEMENTS, TO BE MET BY WORK, SHALL BE CONFIRMED BY FIELD MEASUREMENT PRIOR TO CONSTRUCTION OF NEW WORK. Contractor shall make exploration excavations and locate existing facilities sufficiently ahead of construction to Permit revisions of plans if revision is necessary because of location of existing utilities.
- RADES SHOWN ARE FINISH GRADES, CONTRACTOR SHALL DETERMINE NECESSARY SUB GRADE ELEVATIONS AND SHALL CONSTRUCT MOOTH TRANSITION BETWEEN FINISH GRADES SHOWN.
- ANTRACTOR AGESS THAT HE SHALL ASSUME SOLE RESPONSIBILITY FOR JOB SITE CONDITION DIRINK THE COURSE OF DOSSIBLECTION OF THE SPACET, INJURIANCE SERTY OF ALL RESISONS AND PROPERTY. THAT THIS PROVISON SHALL APPLY DOMINIOUSLY AND NOT BE LIMITED TO NORMAL MORROWGH FOURSE, AND THAT THE CONTRACTOR SHALL DETROW, INSURINATY AND HOLD THE CONTRACTOR SHALL DETROW, DISCHAULTED HOUSE THOM MAY AND ALL LIMITED. THE CONTRACTOR OF THE OWNER ON THE CONTRACTOR OF THE OWNER ON THE OWNER OF THE
- THE CONTRACTOR SHALL BE TOTALLY RESPONSIBLE FOR COMPLIANCE WITH THE PROVISIONS OF THE STATE OF CALIFORNIA SMEET ORDERS.
- THE LOCATIONS OF ALL EXISTING UTILITIES SHOWN ON THESE PLANS ARE FROM EXISTING RECORDS AND CORROBORATED, WHERE POSSIBLE WITH FIELD THES. THE CONTRACTOR IS RESPONSIBLE FOR CONFIRMING THE LOCATIONS SHOWN, BOTH HORIZONTALLY AND VERTICALLY, PROFIT OCONSTRUCTION, IF EXISTING LOCATIONS WAYS JUSTIANTIALLY FROM THE PLANS, THE ENGINEER SHOULD BE NOTIFED TO MAKE ANY CONSTRUCTION CHANGES REQUIRED.
- THE CONTRACTOR SHALL PROVIDE TEMPORARY SUPPORT FOR ALL SEWER AND WATER MAIN UNDER CROSSING IN ACCORDANCE WITH PART 1 SECTION 5-2 OF THE STANDARD SPECIFICATION.
- THE CONTRACTOR SHALL REPLACE OR REPAIR ALL TRAFFIC SIGNAL LOOPS, CONDUITS, AND LANE STRIPING DAMAGED DURING CONSTRUCTION.
- THE CONTRACTOR SHALL SUBMIT WORK PLANS FOR ALL BORE OPERATIONS TWO WEEKS PRIOR TO COMMENCING WORK.
- CONTRACTOR SHALL BE RESPONSIBLE FOR THE POTHOLE AND LOCATING OF ALL EXISTING UTILITIES THAT CROSS THE PROPOSED TRENCH LINE AND MUST MAINTAIN 1' MINIMUM VERTICAL CLEARANCE.
- AS-BUILT DRAWINGS MUST BE SUBMITTED TO THE CITY ENGINEER PRIOR TO ACCEPTANCE OF THIS PROJECT

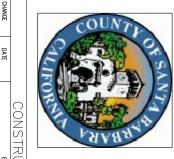

DATE CONSTRUCTION CHANGE EFFECTED OR ADDED SHEET NUMBERS TABLE

CROWN CASTLE NG WEST, LLC

VERIZON MONTECITO-MON17m1 R.O.W. EAST SIDE OF ROMERO CANYON RD (ADJACENT TO 656 ROMERO CANYON RD) SANTA BARBARA, CA 93108

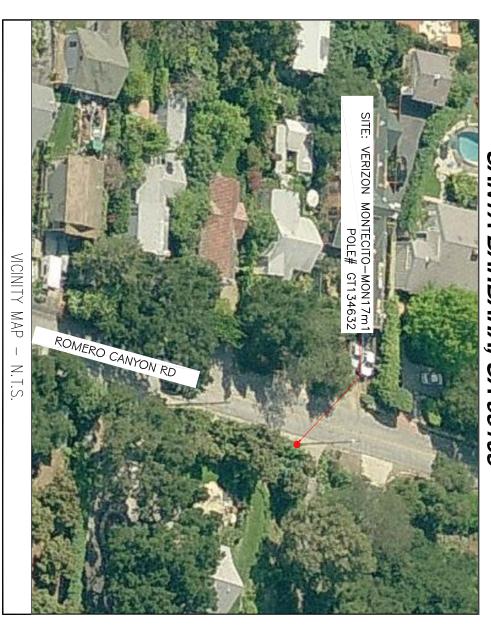

XS	GROUND BUS BAR MECH. GRND. CONN. CADWELD ELECTRIC BOX TELEPHONE BOX EXISTING SERVICE POLE SIDEWALK FLAG EX. MANHOLE
/BOI	\$ >>♦○☆
_S, LINET	UGHT POLE O FOUNDATION SPOT ELEV. A SET POINT REVISION DETAIL REF.
YPES AI	
SYMBOLS, LINETYPES AND HATCH PATTERNS	ELEVATION REF. SECTION REF. PROP./LEASE LINE MATCH LINE WORK POINT TELE. CONDUIT CENTERLINE
PATTERNS	• □ □ · · ·
	- ELECT. CONDUIT - COAXIAL CABLE - MYERS PEDESTAL - VAULT - STANDARD 2'X3' - STEEL POLE

ALL WORK SHALL COMPLY WITH THE FOLLOWING APPLICABLE CODES

PROJECT CONSISTS OF INSTALLATION OF: PROJECT DESCRIPTION

1. (2) OMNI DIRECTIONAL ANTENNA ON EXISTING UTILITY

2. EQUIPMENT SHROUD AND BBU ON EXISTING POLE

IN THE EVENT OF CONFLICT, THE MOST RESTRICTIVE CODE SHALL PREVAIL

TITLE SHEET
SITE PLAN
PROPOSED ELEVATIONS
DETAILS
DETAILS
DETAILS

T-1 - 3 A-1 - 3 A-2 - 1 D-1 - 1 D-2 - 1

SHEET 1 OF 6
SHEET 2 OF 6
SHEET 3 OF 6
SHEET 4 OF 6
SHEET 5 OF 6
SHEET 6 OF 6

NDEX:

CIVIL ENGINEER:

ROSION AND SEDIMENT CONTROL NOTES

TEMPORARY EROSION/SEDIMENT CONTROL, PRIOR TO COMPLETION OF FINAL IMPROVEMENTS, SHALL BE PERFORMED BY THE CONTRACTOR OR QUALIFIED PERSON AS INDICATED BELOW:

- ALL REQUIREMENTS OF THE LOCAL JURISDICTION "LAND DEVELOPMENT MANUAL STORM WATER STANDARDS" MUST BE INCORPORATED INTO THE DESIGN AND CONSTRUCTION OF THE PROPOSED GRADING/IMPROVEMENTS CONSISTENT WITH THE APPROVED STORM WATER
- FOR STORM DRAIN INLETS, PROVIDE A GRAVEL BAG SILT BASIN IMMEDIATELY UPSTREAM OF INLET AS INDICATED ON DETAILS. AND/OR WATER POLLUTION CONTROL PLAN (WPCP).
- ENSINE THAT WATER DRAWING TO THE SUMP IS DRECCED INTO THE INLET AND THAT A MINIMUM OF 1.00° FREEDOARD EXISTS AND IS MAINTAINED ABOVE THE TOP OF THE INLET. IF FREEDOARD IS NOT PROVIDED BY GRADING SHOWN ON HYEST PLANS, THE CONTRACTOR SHALL PROVIDE IT WAS TEMPORARY MEASURES, I.E. GRAVEL BAGS OR DIKES. FOR INLETS LOCATED AT SUMPS ADJACENT TO TOP OF SLOPES, THE CONTRACTOR SHALL
- AND MUD ON ADJACENT STREET(S) AND STORM DRAIN SYSTEM DUE TO CONSTRUCTION THE CONTRACTOR OR QUALIFIED PERSON SHALL BE RESPONSIBLE FOR CLEANUP OF SILT
- UNLINED DITCHES AFTER EACH RAINFA THE CONTRACTOR OR QUALIFIED PERSON SHALL CHECK AND MAINTAIN ALL LINED AND

THE CONTRACTOR SHALL REMOVE

SILT AND DEBRIS AFTER EACH MAJOR RAINFALL.

- DEVICES WHEN RAIN IS IMMINENT. SITE AT CONVENIENT LOCATIONS TO F EQUIPMENT AND WORKERS FOR TIMES DURING THE RAINY SEASON, AI FACILITATE RAPID CONSTRUCTION OF TEMPORARY EMERGENCY WORK SHALL BE MADE AVAILABLE AT ALL NECESSARY MATERIALS SHALL BE STOCKPILED ON
- AFTER EACH RUN-OFF PRODUCING RAINFALL. 8. THE CONTRACTOR SHALL RESTORE ALL EROSION/SEDIMENT CONTROL MEASURES TO WORKING ORDER TO THE SATISFACTION OF THE CITY ENGINEER OR RESIDENT ENGINEER
- OR UNFORESEEN CIRCUMSTANCES, WHICH MAY ARISE. MAY BE REQUIRED BY THE RESIDENT ENGINEER DUE TO UNCOMPLETED GRADING OPERATIONS THE CONTRACTOR SHALL INSTALL
- 10. THE CONTRACTOR SHALL BE RESPONSIBLE AND SHALL TAKE NECESSARY PRECAUTIONS TO PREVENT PUBLIC TRESPASS ONTO AREAS WHERE IMPOUNDED WATERS CREATE A HAZARDOUS CONDITION.
- ALL EROSION/SEDMENT CONTROL MEASURES PROVIDED PER THE APPROVED GRADING PLAN SHALL BE INCORPORATED HEREON. ALL EROSION/SEDMENT CONTROL FOR INTERIM CONDITIONS SHALL BE DONE TO THE SATISFACTION OF THE RESIDENT ENGINEER.
- 12. GRADED AREAS AROUND THE PROJECT PERIMETER MUST DRAIN AWAY FROM THE FACE OF THE SLOPE AT THE CONCLUSION OF EACH WORKING DAY.
- 13. ALL REMOVABLE PROTECTIVE DEVICES SHOWN SHALL BE IN PLACE AT THE END OF EACH WORKING DAY WHEN RAIN IS IMMINENT
- EROSION/SEDIMENT CONTROL MEASURES. 14. THE CONTRACTOR SHALL ONLY GRADE, INCLUDING CLEARING AND GRUBBING FOR THE AREAS FOR WHICH THE CONTRACTOR OR QUALIFED PERSON CAN PROVIDE
- 15. THE CONTRACTOR SHALL ARRANGE FOR WEEKLY MEETINGS DURING OCTOBER IST TO APRIL 30TH FOR PROJECT TEAM (GENERAL CONTRACTOR, QUALIFED PERSON, EROSION CONTROL SUBCONTRACTOR IF ANY, ENGINEER OF WORK, OWNER AND THE RESIDENT ENGINEER) TO EVALUATE THE ADEQUACY OF THE EROSION/SEDIMENT CONTROL MEASURES AND OTHER RELATED CONSTRUCTION ACTIVITIES.

RAFFIC CONTROL NOTES

THE CONTRACTOR SHALL SUBMIT A TRAFFIC CONTROL PLAN (11" x 17") FOR APPROVAL PRIOR TO STARTING WORK. THE PLAN SHOULD BE SUBMITTED TO THE TRAFFIC COMPROL PERMIT COUNTR. CONTRACTOR SHALL GORIAN A TRAFFIC CONTROL PERMIT A MINIMUM OF TWO (2) WORKING DAYS PRIOR TO STARTING WORK, AND A MINIMUM HE (5) DAYS IF WORK WILL AFFECT A SILES STOP OR AM ENSTING TRAFFIC SIGNAL, OR IF WORK WILL REQUIRE A CONTROL WORK WILL REQUIRE A

FOOTAGE TOTALS	
ASPHALT CUT	1
DIRT TRENCH	_
PUNCH THRU	-
BORE	_
TOTAL	ı
R&R SWF TOTAL	1

PROJECT DICT IONARY

SITE ADDRESS: R.O.W. EAST SIDE OF ROMERO CANYON RD (ADJACENT TO 656 ROMERO CANYON RD) SANTA BARBARA, CA 93108

CROWN CASTLE NG WEST, LLC 2125 WRIGHT AVE, SUITE #C9 LA VERNE, CA 91750 CONTACT: HEIDI PAYNE PHONE: (949) 310-9493

LAKE FOREST, CA 92630 CONTACT: FRANK CARTER (949) 310-8233 PHONE (949) 753-8833 FAX CONNELL DESIGN GROUP, LLC 26455 RANCHO PARKWAY SOUTH LAKE FOREST, CA 92630 CONTACT: FRANK CARTER

							and the same of
			-		c	0	REV:
			03/08/2014	FXC	02/18/2014	FXC	DATE/BY:
		•		ISSUED FOR	REVIEW	SSUED FOR	REVISION DESCRIPTION:

Civil Engineer

26455 RANCHO PARKWAY SOUTH, LAKE FOREST, CA 92630 (949) 753-8807 OFFICE - (949) 753-8833 FAX CONNELL DESIGN GROUP, LLC



STAMP:




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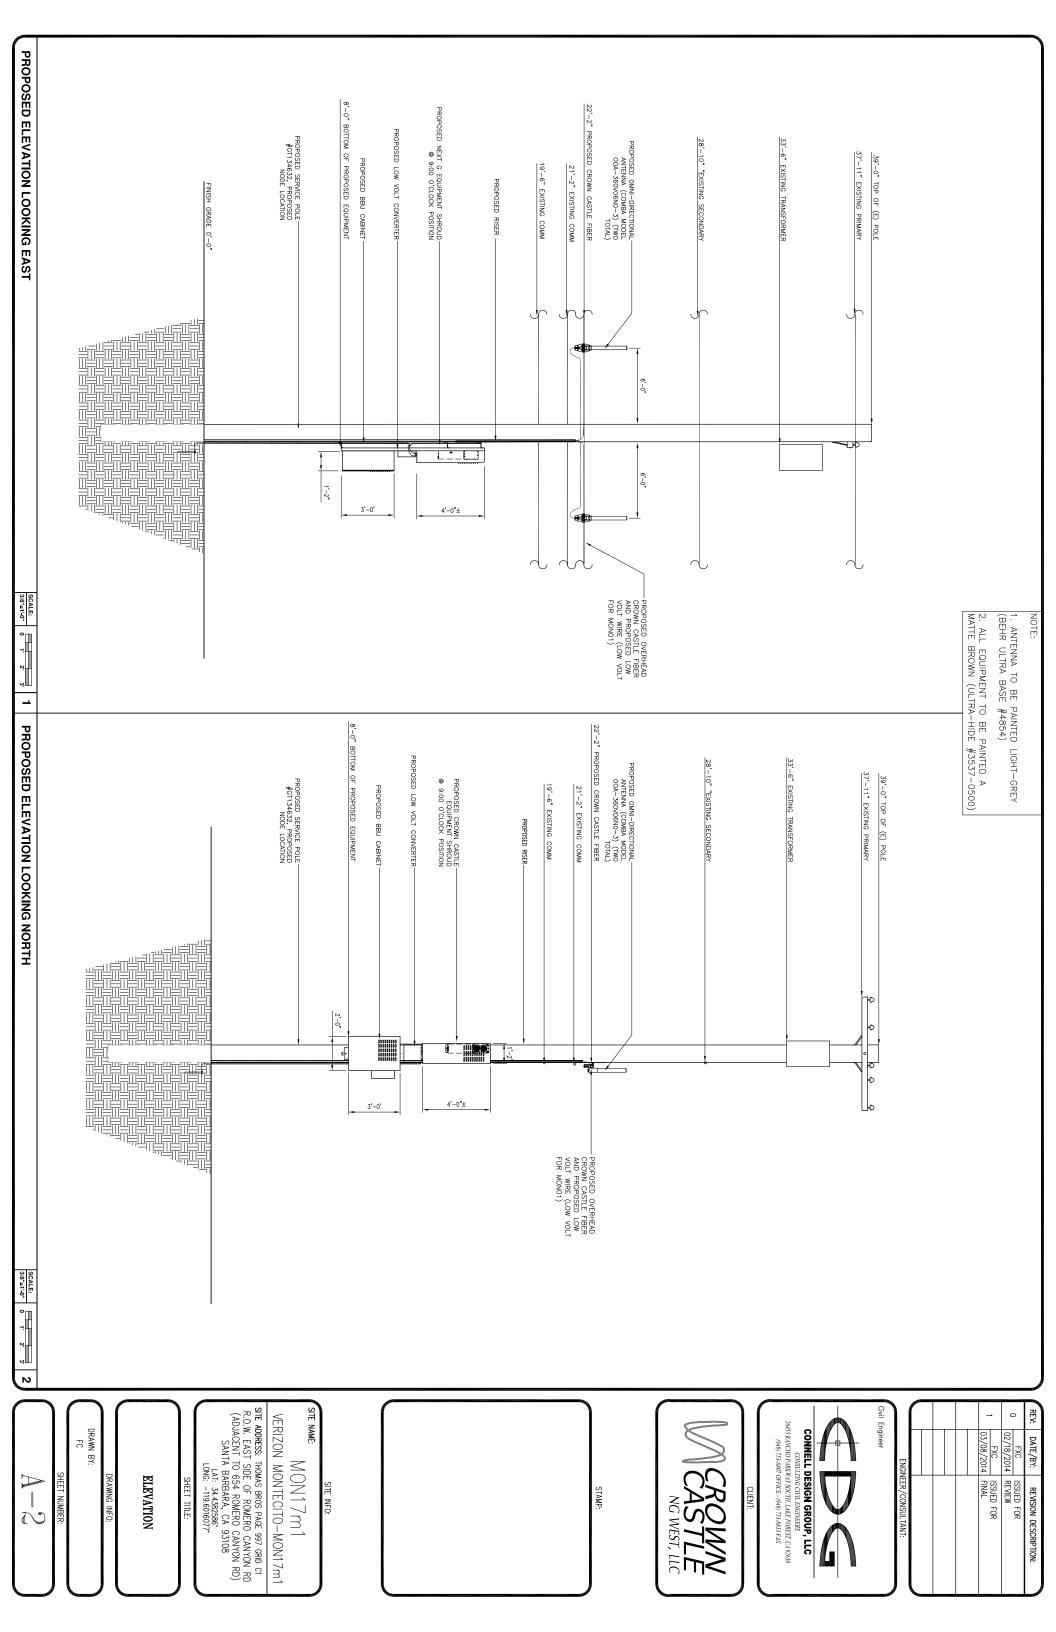
SITE NAME: M0N17m1

SITE ADDRESS: THOMAS BROS PAGE 997 GRID C1 R.O.W. EAST SIDE OF ROMERO CANYON RD (ADJACENT TO 654 ROMERO CANYON RD) SANTA BARBARA, CA 93108 VERIZON MONTECITO-MON17m1 LAT: 34.4382586° _ONG: -119.6016077°

TITLE SHEET

DRAWN BY: FC




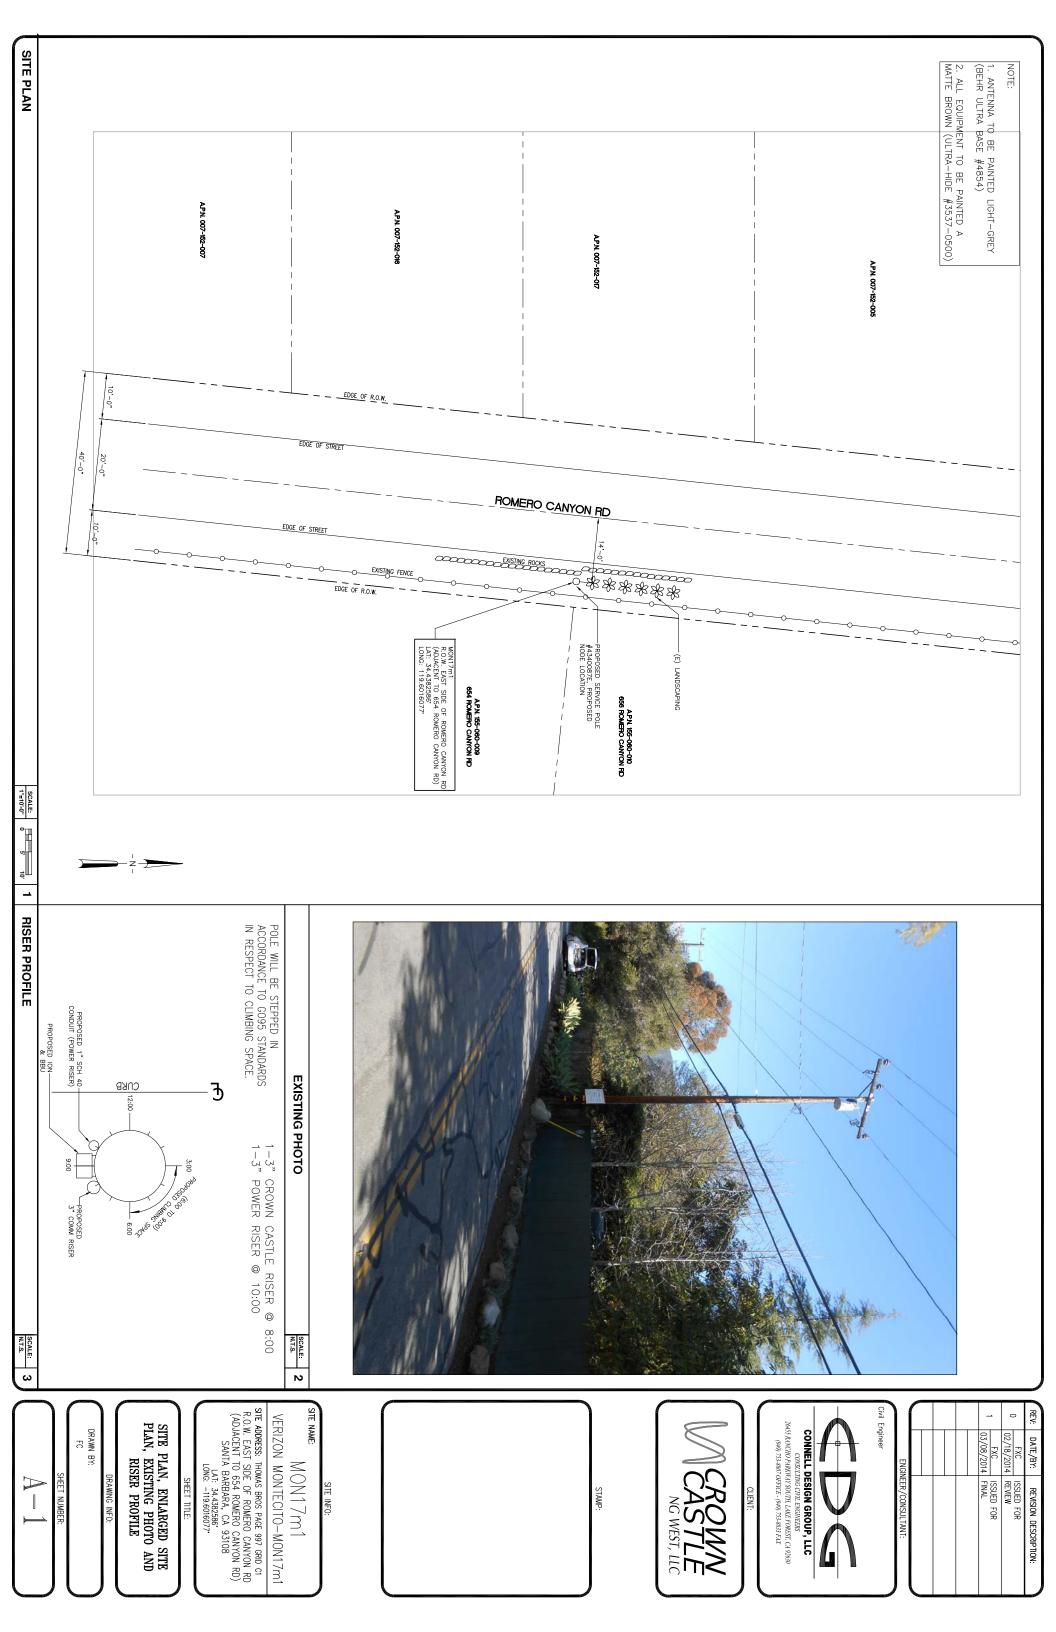


Outdoor Omni-directional Antenna

OOA-360V06N0-3 VPol, 696-960/1710-2170MHz, 360°, 4.0/6.0 dBi

Dimensions HxDia mm
Weight, with Mounting kit kg
Radome Material and Color
Radiating Element Material
Connector Type and Location
Operational Humidity
Operational Wind Speed km/t
Shipping Dimensians,HxWxD mm
Shipping Weight kg Horizontal Beamwidth Vertical Beamwidth Electrical Downtilt—Fixed VSWR Frequency Range Polarization Mechanical Impedance Lightning Protection Electrical Maximum Power Technical Specifications mm(in) kg (lb) dB; deg deg deg 696-960 22-53 4.0 ± 1 1.8 200 50 Direct Ground Vertical 360 1710-2170 6.0 ± 1 20-26

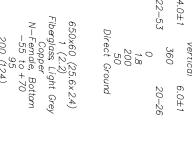

% km/h (mph) D mm (in) kg (lb)

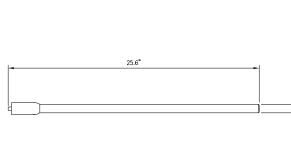

200 (124) 670x100x100 (26.4x3.9x3.9) 1. 2 (2.65)

N.T.S.

ANTENNA SPECIFICATIONS

Electrical


Number of Carriers Output power per carrier 700 MHz SISO/MIMO Power consumption, Watts Power Supply Mains power, Vac 43 -10" 4 12 . 698 to 716/776 to 787 . 728 to 757 . 1100 max. <750 @ normal operation 115 or 230










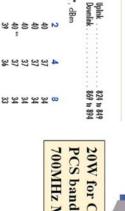

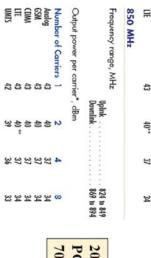

















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Weight, kg (lb)

40 (88.2)

900 MHz

Number of GSM CDMA LITE UMTS Output po Frequency

33	36	39	42
34	37	40 :	43
34	37		43
34	37	40	43
00	4	N	of Carriers 1
		, dB _m	ower per carrier
1850 to 1915 1930 to 1995		Uplink Downink	y range, MHz

ION-M7P/7P/85P/19P Noise figure optimized +10 max. . +6 max. 4.5 typical

Canada Tel +1 604 430 1476 Fax +1 604 430 8908 Toll Free +1 800 667 87

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Latin & South America

North America

 USA
 Unset/ingom

 Tel:+1306.6d72500
 Tel:+1305.0525044
 Tel:+1206.6d72500

 Feb:+1306.6f72500
 Tel:+1305.0525044
 Tel:+41275.50110

 Fax:+1306.6f72500
 Fax:+1305.051649
 Fax:+41275.50110

 Fax:+1306.6f72500
 Fax:+34559161549
 Fax:+41275.50110

 Fax:+34559161500
 Fax:+41275.50110
 Fax:+41275.50110

 Copyright 0-2005.ptg-machines
 Fax:+41559161549
 Fax:+41275.50110

 Copyright 0-2005.ptg-machines
 Fax:+4155916169
 Fax:+41275.50110

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 Fax:+4155916169
 Fax:+4155916169

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 Fax:+4155916169
 Fax:+4127591610

 Copyright 0-2005.ptg-machines
 Fax:+4155916169
 Fax:+4155916169

 Copyright 0-2005.pt

817 x 245 x 218 (32.2 x 9.6 x 8.6)

Page 1, February 27, 2013 Company Confidential

N.T.S.

N

BATTERY SPECIFICATIONS

ION-M7P/7P/85P/19P

Alpha Cell General Spe

2.4"ø

eneral Specifications			
odel:	220 GXL	195 GXL	165 GXL
arranty';	4 to 5 year full replacement	4 to 5 year full replacement	4 to 5 year full replacemen
rvice Life:	Extended	Extended	Extended
ntime (minutes)2:	220	195	165
aled VRLA:	Valve regulated lead acid	Valve regulated lead acid. Valve regulated	Valve regulated
at Resistant:	Extreme	Extreme	Extreme
drogen Emission:	Low	Low	Low
rminals:	Threaded insert	Threaded insert	Threaded inser
	1/4" - 20 UNC	1/4" - 20 UNC	1/4" - 20 UNC



Typical Runtime (minutes)*:
Cells Per Unit:
Voltage Per Unit:
Conductance Value:
Max. Discharge Current (A):
Short Circuit Current (A):
Short Circuit Current (A):
Ohms Impedance 80Hz:
Nominal Capacity at 20hrs: (to 1.76VPC)
Nominal Capacity at 20hrs: (to 1.70VPC)
BCI Group Size:
Visight Prinzer: Weight (Ib/kg):
Height w/ Terminals (in/mm):
Width (in/mm):
Depth (in/mm)?:
Operating Temperature Range
Discharge: Specifications⁴ Float Charging Voltage (Vdc): AC Ripple Charger: Charge (with temp compensation): -40 to 71°C (-40 to 180°F) -23 to 60°C (-9.4 to 140°F) -23 to 60°C (-9.4 to 140°F) 13.5 to 13.8 0.5% RMS or 1.5% offloat charge voltage recom 220 6 6 12.8 1175 900 2800 2800 2800 104 11.4 0.050 109Ah 110Ah 31 7333.2 8.7333.2 8.7333.2 8.7333.2 8.7333.2 8.7333.2 8.7333.2 8.7333.2 8.7333.2 8.7333.2 8.7333.2 1/4" - 20 UNC 195 6 12.8 1100 900 2600 1103 11.3 11.3 100Ah 102Ah 1102Ah 31 6730.5 848/215.4 13.42/340.9 6.80/172.7 -40 to 71°C (-40 to 160°F) -23 to 60°C (-9.4 to 140°F) 13.5 to 13.8 1/4" - 20 UNC

ed for best results. Max. allowed = 4% P-P

4/250Vac@	\$			00			8			NO.		
BaltayRurtine	270	8	OS.	220	8	既	220	18	ž	220	Si.	8
3 batteries	508	453	306	320	285	249	236	200	198	156	Š	Ŧ
4 batteries	70	625	56	44	396	346	329	200	25	261	232	203
6 batteries.	1001	978	25	701	625	546	523	45	407	476	372	325
8 batternes	1487	1338	1	960	959	750	720	643	562	577	55	450
9 batteries	1686	1590	1202	1091	978	853	820	733	640	659	587	Chi 라
NM290Vas(2)	12A			MA			蓝			184		
BatteryRuntme	220	8	- S	220	荔	部	220	35	88	220	8	oği
3 betteries:	E	iğ.	इं	119	106	92	101	889	77	87	78	88
4 batteries	210	187	163	1	<u>15</u>	132	Ė	138	77	12	111	96
6 betteries:	339	301	26.	275	245	2	236	209	88	204	182	159
8 betteries	478	419	367	385	341	299	329	293	256	288	255	223
9 bettenes	538	479	419	440	391	342	3/7	335	294	329	293	256
(M200Vaugh	4			8			66			10A		
BatteyAurtime	220	195	185	220	36	185	220	8	8	220	196	185
3 betteries:	798	712	622	508	453	396	377	335	294	300	267	233
4 totlenes:	1901	978	883	701	625	548	52	85	407	418	372	325
6 batteries.	1000	1519	1522	1001	978	853	820	733	640	659	587	514
8 betteries:	2288	2067	1798	7877	1338	1185	1122	1006	877	904	809	706
9 batteries:	2590	2345	2007	188	83	1202	1273	甚	997	7027	153	803
XMZ60Vac@	12A			NA.			18A			184		
BatteryRuntime	220	8	186	220	88	햜	220	195	88	220	18	88
3 batteries	242	215	188	196	174	151	188	148	125	144	128	107
4 batteries:	339	301	284	275	245	214	236	209	182	204	182	렰
6batteries:	538	479	419	440	383	340	377	335	290	328	283	252
8 batteries	741	660	577	607	쫖	470	523	465	402	458	407	351
	943	8	850	692	617	538	597	531	462	523	40%	402

FXC ISSUED FOR 03/08/2014 FINAL FXC ISSUED FOR 18/2014 REVIEW

DATE/BY: REVISION DESCRIPTION:

Civil Engineer

CONNELL DESIGN GROUP, LLC

CONSULTING CIVIL ENGINEERS

26455 RANCHO PARKWAY SOUTH, LAKE FOREST, CA 92630 (949) 753-8807 OFFICE - (949) 753-8833 FAX

STAMP:

SITE INFO:

SITE NAME: M0N17m1

SITE ADDRESS: THOMAS BROS PAGE 997 GRID C1 R.O.W. EAST SIDE OF ROMERO CANYON RD (ADJACENT TO 654 ROMERO CANYON RD) SANTA BARBARA, CA 93108 LAT: 34.4382586* LONG: -119.6016077* VERIZON MONTECITO-MON17m1


DETAILS


249-297-10-8002 (06/09)

DRAWN BY: FC

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- . APPROVAL OF THESE PLANS BY THE CITY ENGINEER DOES NOT AUTHORIZE ANY WORK TO BE PERFORMED UNTIL A PERMIT HAS
- 2. UPON ISSUANCE OF A PERMIT, NO WORK WILL BE PERMITTED ON WEEKENDS OR HOLIDAYS WITHOUT PERMISSION FROM THE
- 3, THE APPROVAL OF THIS PLAN OR ISSUANCE OF A PERMIT BY THE LOCAL JURISDICTION DOES NOT AUTHORIZE THE SUBDIVIDER AND OWNER TO VIOLATE ANY FEDERAL. STATE OR CITY LAWS, ORDINANCES, REGULATIONS, OR POLICIES, INCLUDING, BUT NOT LIMITED TO, THE FEDERAL ENDANGERED SPECIES ACT OF 1973 AND AMENDMENTS THERETO (16 USC SECTION 1531 ET.SEQ.)
- 4. THE CONTRACTOR SHALL BE RESPONSIBLE FOR SURVEY MONUMENTS AND/OR VERTICAL CONTROL BENCHMARKS WHICH ARE DISTURBED OR DESTROYED BY CONSTRUCTION. A LAND SURVEYOR MUST FIELD LOCATE, REFERENCE, AND/OR PRESERVE ALL HISTORICAL OR CONTROLLING MONUMENTS PRIOR TO ANY EARTHWORK. IF DESTROYED, SUCH MONUMENTS SHALL BE REPLACED WITH APPROPRIATE MONUMENTS BY A LAND SURVEYOR, A CORNER RECORD OR RECORD OF SURVEY, AS APPROPRIATE, SHALL BE FIELD AS REQUIRED BY THE PROFESSIONAL LAND SURVEYORS ACT. IF ANY VERTICAL CONTROL IS TO BE DISTURBED OR DESTROYED. THE LOCAL JURISDICTION FIELD SURVEY SECTION MUST BE NOTIFIED. IN WRITING, AT LEAST 3 DAYS PRIOR TO THE CONSTRUCTION. THE CONTRACTOR WILL BE RESPONSIBLE FOR THE COST OF REPLACING ANY VERTICAL CONTROL BENCHMARKS
- 5. IMPORTANT NOTICE: SECTION 4216 OF THE GOVERNMENT CODE REQUIRES A DIG ALERT IDENTIFICATION NUMBER BE ISSUED BEFORE A "PERMIT TO EXCAVATE" WILL BE VALID. FOR YOUR DIG ALERT I.D. NUMBER, CALL UNDERGROUND SERVICE ALERT, TWO
- 6. CONTRACTOR SHALL BE RESPONSIBLE FOR THE POTHOLE AND LOCATING OF ALL EXISTING UTILITIES THAT CROSS THE PROPOSED TRENCH LINE AND MUST MAINTAIN 1' MINIMUM VERTICAL CLEARANCE.
- 7. CONTRACTOR SHALL SUBMIT TO THE LOCAL JURISDICTION, A CONSTRUCTION PLAN TO PROTECT WATER MAINS PRIOR TO COMMENCING CONSTRUCTION.
- 8. CONTRACTOR SHALL REPLACE OR REPAIR ALL TRAFFIC SIGNAL LOOPS, CONDUIT, AND LANE STRIPING DAMAGED DURING
- 9. CONTRACTOR SHALL NOTIFY THE LOCAL JURISDICTION. A MINIMUM OF 48 HOURS PRIOR TO COMMENCING WORK WITHIN 10' OF
- 10. THIS PROJECT WILL BE INSPECTED BY ENGINEERING AND CAPITAL PROJECTS DEPARTMENT, FIELD ENGINEERING DIVISION.
- 11. AS-BUILT DRAWINGS MUST BE SUBMITTED TO THE CITY RESIDENT ENGINEER PRIOR TO THE ACCEPTANCE OF THIS PROJECT. 12. PUBLIC IMPROVEMENT SUBJECT TO DESUETUDE OR DAMAGE." IF REPAIR OR REPLACEMENT OF SUCH PUBLIC IMPROVEMENTS IS REQUIRED, THE OWNER SHALL OBTAIN THE REQUIRED PERMITS FOR WORK IN THE PUBLIC RIGHT-OFWAY, SATISFACTORY TO TH
- 13. PRIOR TO ANY DISTURBANCE TO THE SITE, EXCLUDING UTILITY MARKS-OUTS AND SURVEYING, THE CONTRACTOR SHALL MAKE ARRANGEMENTS FOR A PRE-CONSTRUCTION MEETING WITH THE LOCAL JURISDICTION FIELD ENGINEERING DIMSION.
- 14. PRIOR TO THE COMMENCEMENT OF ANY CONSTRUCTION SHOWN ON THESE PLANS. IT IS THE SOLE RESPONSIBILITY OF THE CONTRACTOR TO COORDINATE. THE CONTRACTOR IS RESPONSIBLE TO ATTEND THE LOCAL JURISDICTIONS MONTHLY UTILITY COORDINATION COMMITTEE THE CONSTRUCTION ACTIVITIES WITH THE CITY AND ALL OTHER CONTRACTORS SO THAT NO TRENCH IS CUT WITHIN ANY OF THE CITY STREETS THAT HAVE BEEN CONSTRUCTED, REPAIRED, OR SLURRY SEALED WITHIN THREE YEARS OF THE STREET CONSTRCTUION/RESURFACING DATE.
- 15. MANHOLES OR COVERS SHALL BE LABELED "CROWN CASTLE" OR "CROWN CASTLE NG WEST".
- 16. CONTRACTOR SHALL IMPLEMENT AN EROSION AND SEDIMENT CONTROL PROCRAM DURING THE PROJECT CONSTRUCTION ACTIVITIES PROGRAM SHALL MEET THE APPLICABLE REQUIREMENTS OF THE STATE WATER RESOURCE CONTROL BOARD
- 17. THE CONTRACTOR SHALL HAVE EMERGENCY MATERIALS AND EQUIPMENT ON HAND FOR UNFORESEEN SITUATIONS, SUCH AS DAMAGE TO UNDERGROUND WATER, SEWER, AND STORM DRAIN FACILITIES WHEREBY FLOWS MAY GENERATE EROSION AND SEDIMENT

SPECIAL NOTES

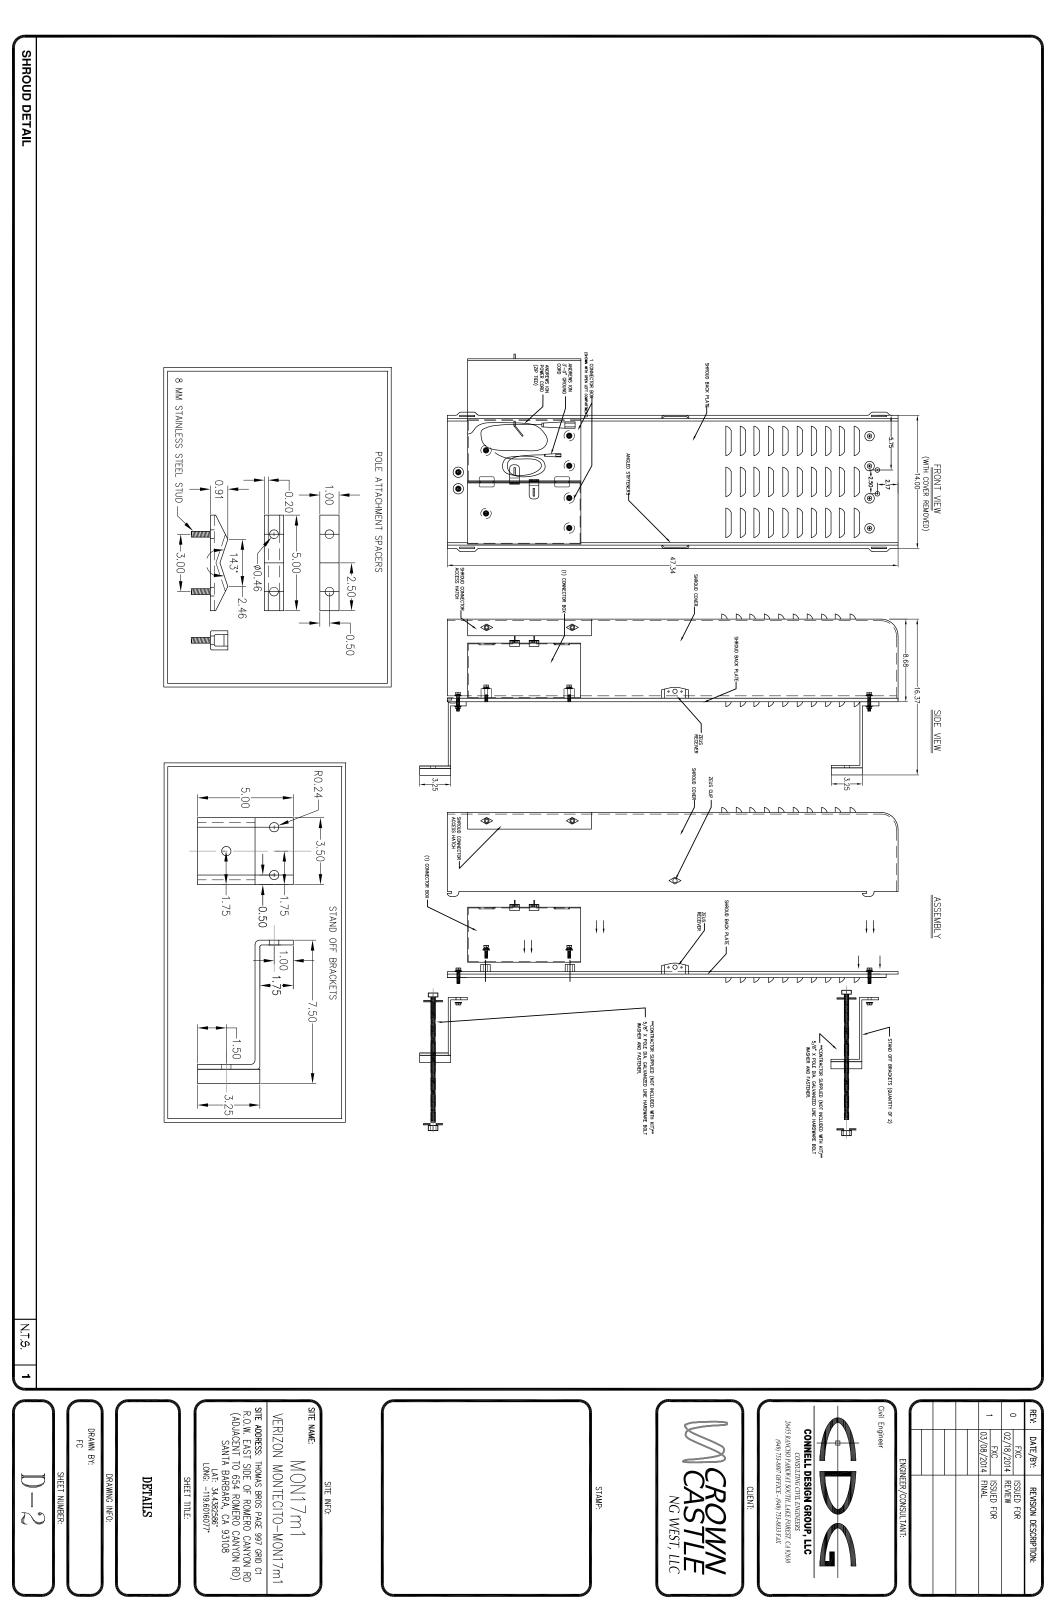THE FOLLOWING NOTES ARE PROVIDED TO GIVE DIRECTIONS TO THE CONTRACTOR BY THE ENGINEER OF WORK. THE CITY ENGINEER'S SIGNATURE ON THESE PLANS DOES NOT CONSTITUTE APPROVAL OF THESE NOTES AND THE CITY WILL NOT BE RESPONSIBLE FOR THEIR ENFORCEMENT.

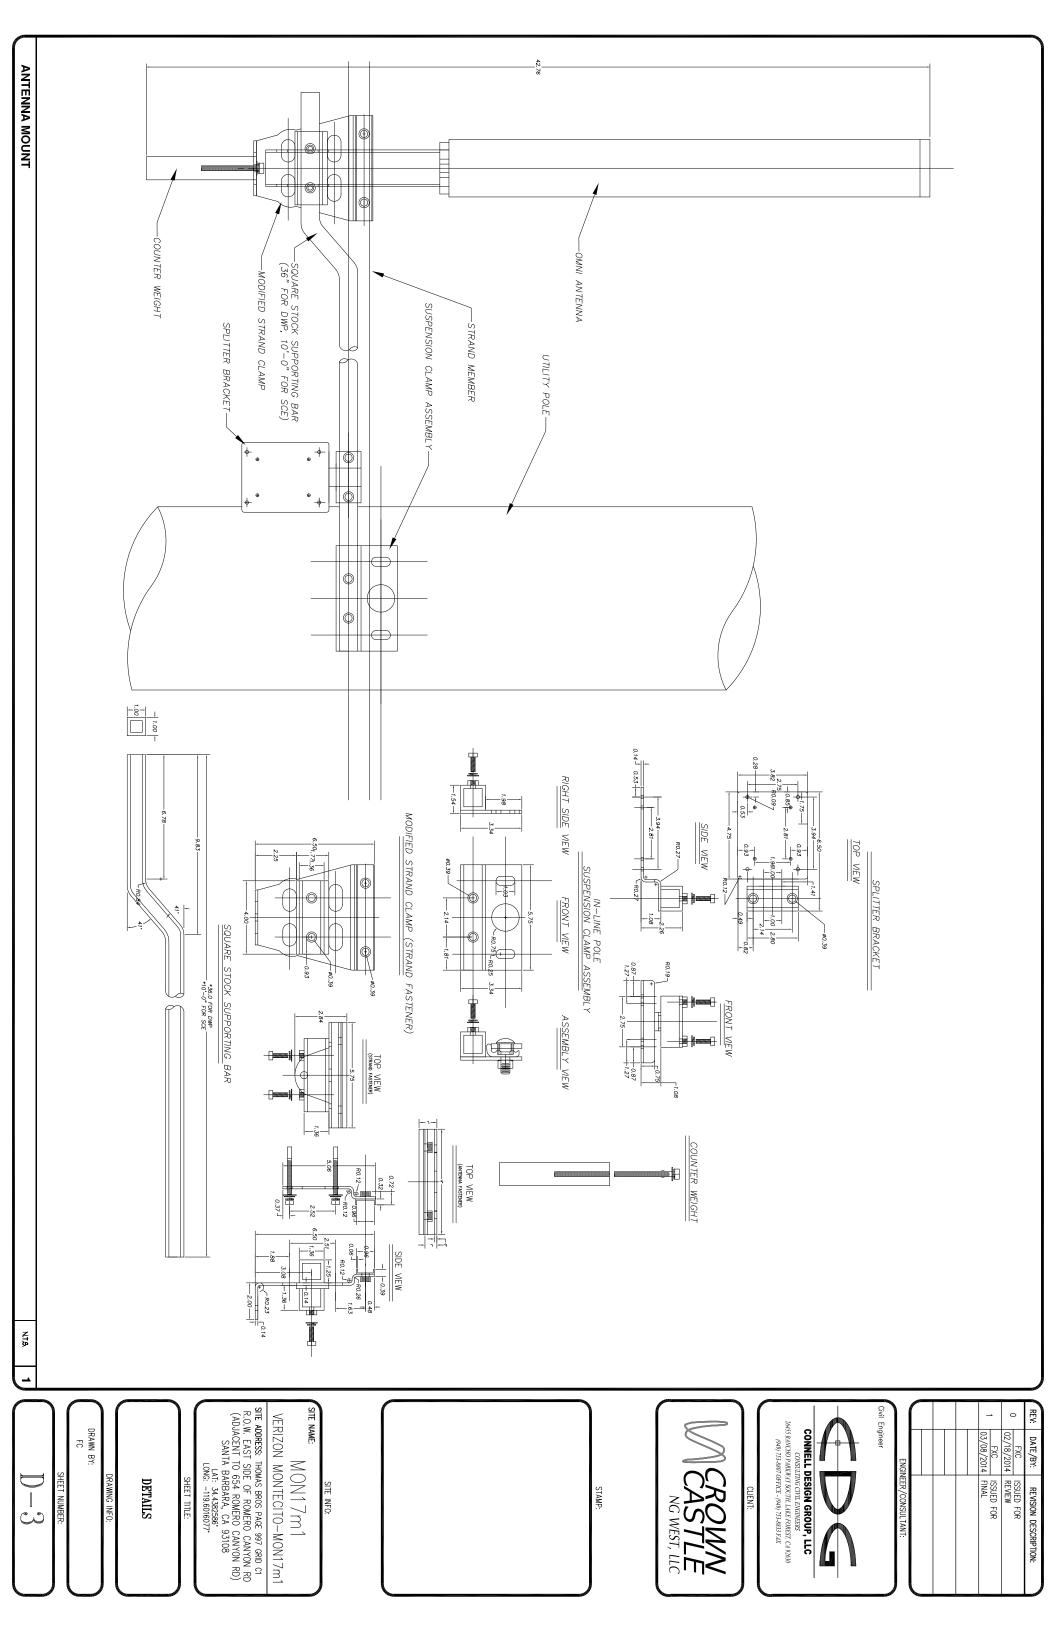- THE CONTRACTOR SHALL VERIFY THE LOCATION EXISTING UNDERGROUND UTILITIES INCLUDING SEWER LATERALS AND WATER
 SERVICES TO INDIVIDUAL LOTS BOTH VERTICAL AND HORIZONTAL PRIOR TO COMMENCING IMPROVEMENT OPERATIONS.
- 2. CONTRACTOR SHALL MAKE EXPLORATION EXCAVATIONS AND LOCATE EXISTING FACILITIES SUFFICIENTLY AHEAD OF CONSTRUCTION TO PERMIT REVISIONS OF PLANS IF REVISION IS NECESSARY BECAUSE OF LOCATION OF EXISTING UTILITIES.
- 3. LOCATION AND ELEVATIONS OF IMPROVEMENTS. TO BE MET BY WORK, SHALL BE CONFIRMED BY FIELD MEASUREMENT PRIOR TO
- 4. GRADES SHOWN ARE FINISH GRADES, CONTRACTOR SHALL DETERMINE NECESSARY SUB GRADE ELEVATIONS AND SHALL CONSTRUCT SMOOTH TRANSITION BETWEEN FINISH GRADES SHOWN.
- 5. Contractor agrees that he shall assume sole responsibility for job site condition during the course of construction of this project, including safety of all persons and property: that this provision shall apply CONTINUOUSLY AND NOT BE LIMITED TO NORMAL WORKING HOURS; AND THAT THE CONTRACTOR SHALL DEFEND, INDEMNIFY AND HOLD THE OWNER AND THE ENGINEER HARMLESS FROM ANY AND ALL LIABILITY. REAL OR ALLEGED IN CONNECTION WITH THI PERFORMANCE OF WORK ON THIS PROJECT, EXPECTING FOR LIABILITY ARISING FROM SOLE NEGLIGENCE OF THE OWNER OR THE
- 6. THE CONTRACTOR SHALL BE TOTALLY RESPONSIBLE FOR COMPLIANCE WITH THE PROVISIONS OF THE STATE OF CALIFORNIA SAFETY
- 7. THE LOCATIONS OF ALL EXISTING UTILITIES SHOWN ON THESE PLANS ARE FROM EXISTING RECORDS AND CORROBORATED, WHERE POSSIBLE WITH FIELD TIES. THE CONTRACTOR IS RESPONSIBLE FOR CONFIRMING THE LOCATIONS SHOWN, BOTH HORIZONTALLY AND VERTICALLY, PRIOR TO CONSTRUCTION. IF EXISTING LOCATIONS VARY SUBSTANTIALLY FROM THE PLANS, THE ENGINEER SHOULD BE NOTIFIED TO MAKE ANY CONSTRUCTION CHANGES REQUIRED.
- 8. THE CONTRACTOR SHALL PROVIDE TEMPORARY SUPPORT FOR ALL SEWER AND WATER MAIN UNDER CROSSING IN ACCORDANCE WITH PART 1 SECTION 5-2 OF THE STANDARD SPECIFICATION.
- 9. THE CONTRACTOR SHALL REPLACE OR REPAIR ALL TRAFFIC SIGNAL LOOPS, CONDUITS, AND LANE STRIPING DAMAGED DURING
- 10. THE CONTRACTOR SHALL SUBMIT WORK PLANS FOR ALL BORE OPERATIONS TWO WEEKS PRIOR TO COMMENCING WORK.
- 11. CONTRACTOR SHALL BE RESPONSIBLE FOR THE POTHOLE AND LOCATING OF ALL EXISTING UTILITIES THAT CROSS THE PROPOSED
- 12. AS-BUILT DRAWINGS MUST BE SUBMITTED TO THE CITY ENGINEER PRIOR TO ACCEPTANCE OF THIS PROJECT




CONSTRUCTION CHANGE TABLE CHANGE DATE EFFECTED OR ADDED SHEET NUMBERS

CROWN CASTLE NG WEST, INC

VERIZON MONTECITO-MON18 R.O.W. SOUTH SIDE OF BELLA VISTA DR (ADJACENT TO 2299 BELLA VISTA DR) SANTA BARBARA, CA 93108



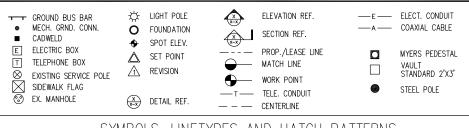

SYMBOLS, LINETYPES AND HATCH PATTERNS

APPLICABLE CODES

ALL WORK SHALL COMPLY WITH THE FOLLOWING APPLICABLE CODES:

- IN THE EVENT OF CONFLICT, THE MOST RESTRICTIVE CODE SHALL PREVAIL

PROJECT DESCRIPTION

PROJECT CONSISTS OF INSTALLATION OF:

- (2) OMNI ANTENNAS ON EXISTING UTILITY POLE
- 2. EQUIPMENT PEDESTAL W/ BBU, ION AND ELECTRICAL METER AT BASE O
- 3. NEW SHROUD ON POLE WITH NEW ION

TITLE SHEET T-1 - SHFFT 1 OF 10 TOPOGRAPHIC SURVEY C-1 - SHEET 2 OF 10 TOPOGRAPHIC SURVEY C-2 - SHEET 3 OF 10 SITE PLAN - SHFFT 4 OF 10 ENLARGED SITE PLAN SHEET 5 OF 10 PROPOSED ELEVATIONS A-3- SHFFT 6 OF 10 GRADING PLAN DETAILS D-1 - SHEET 8 OF 10 - SHEET 9 OF 10 DETAILS

SHEET INDEX:

EROSION AND SEDIMENT CONTROL NOTES

TEMPORARY EROSION/SEDIMENT CONTROL, PRIOR TO COMPLETION OF FINAL IMPROVEMENTS. SHALL BE PERFORMED BY THE CONTRACTOR OR QUALIFIED PERSON AS INDICATED BELOW:

- 1. ALL REQUIREMENTS OF THE LOCAL JURISDICTION "LAND DEVELOPMENT MANUAL, STORM WATER STANDARDS" MUST BE INCORPORATED INTO THE DESIGN AND CONSTRUCTION OF THE PROPOSED GRADING/IMPROVEMENTS CONSISTENT WITH THE APPROVED STORM WATER AND/OR WATER POLLUTION CONTROL PLAN (WPCP).
- 2. FOR STORM DRAIN INLETS, PROVIDE A GRAVEL BAG SILT BASIN IMMEDIATELY UPSTREAM OF INLET AS INDICATED ON DETAILS.
- 3. FOR INLETS LOCATED AT SUMPS ADJACENT TO TOP OF SLOPES, THE CONTRACTOR SHALL ENSURE THAT WATER DRAINING TO THE SUMP IS DIRECTED INTO THE INLET AND THAT A MINIMUM OF 1.00" FREEBOARD EXISTS AND IS MAINTAINED ABOVE THE TOP OF THE INLET. IF FREEBOARD IS NOT PROVIDED BY GRADING SHOWN ON THESE PLANS, THE CONTRACTOR SHALL PROVIDE IT VIA TEMPORARY MEASURES, I.E. GRAVEL BAGS OR DIKES.
- 4. THE CONTRACTOR OR QUALIFIED PERSON SHALL BE RESPONSIBLE FOR CLEANUP OF SILT AND MUD ON ADJACENT STREET(S) AND STORM DRAIN SYSTEM DUE TO CONSTRUCTION
- 5. THE CONTRACTOR OR QUALIFIED PERSON SHALL CHECK AND MAINTAIN ALL LINED AND UNLINED DITCHES AFTER EACH RAINFALL.
- 6. THE CONTRACTOR SHALL REMOVE SILT AND DEBRIS AFTER EACH MAJOR RAINFALL.
- EQUIPMENT AND WORKERS FOR EMERGENCY WORK SHALL BE MADE AVAILABLE AT ALL TIMES DURING THE RAINY SEASON, ALL NECESSARY MATERIALS SHALL BE STOCKPILED ON SITE AT CONVENIENT LOCATIONS TO FACILITATE RAPID CONSTRUCTION OF TEMPORARY DEVICES WHEN RAIN IS IMMINENT.
- 8. THE CONTRACTOR SHALL RESTORE ALL EROSION/SEDIMENT CONTROL MEASURES TO WORKING ORDER TO THE SATISFACTION OF THE CITY ENGINEER OR RESIDENT ENGINEER AFTER EACH RUN-OFF PRODUCING RAINFALL.
- THE CONTRACTOR SHALL INSTALL ADDITIONAL EROSION CONTROL MEASURES AS MAY BE REQUIRED BY THE RESIDENT ENGINEER DUE TO UNCOMPLETED GRADING OPERATIONS OR UNFORESEEN CIRCUMSTANCES, WHICH MAY ARISE.
- 10. THE CONTRACTOR SHALL BE RESPONSIBLE AND SHALL TAKE NECESSARY PRECAUTIONS TO PREVENT PUBLIC TRESPASS ONTO AREAS WHERE IMPOUNDED WATERS CREATE A HAZARDOUS CONDITION.
- 11. ALL EROSION/SEDIMENT CONTROL MEASURES PROVIDED PER THE APPROVED GRADING PLAN SHALL BE INCORPORATED HEREON. ALL EROSION/SEDIMENT CONTROL FOR INTERIM CONDITIONS SHALL BE DONE TO THE SATISFACTION OF THE RESIDENT ENGINEER.
- 12 CRADED AREAS AROUND THE PROJECT PERIMETER MUST DRAIN AWAY FROM THE FACE OF THE SLOPE AT THE CONCLUSION OF EACH WORKING DAY. 13. ALL REMOVABLE PROTECTIVE DEVICES SHOWN SHALL BE IN PLACE AT THE END OF EACH
- 14. THE CONTRACTOR SHALL ONLY GRADE, INCLUDING CLEARING AND GRUBBING FOR THE AREAS FOR WHICH THE CONTRACTOR OR QUALIFIED PERSON CAN PROVIDE FROSION/SEDIMENT CONTROL MEASURES.
- 15. THE CONTRACTOR SHALL ARRANGE FOR WEEKLY MEETINGS DURING OCTOBER 1ST TO APRIL 30TH FOR PROJECT TEAM (GENERAL CONTRACTOR, QUALIFIED PERSON, EROSION CONTROL SUBCONTRACTOR IF ANY, ENGINEER OF WORK, OWNER AND THE RESIDENT ENGINEER) TO EVALUATE THE ADEQUACY OF THE EROSION/SEDIMENT CONTROL MEASURES AND OTHER RELATED CONSTRUCTION ACTIVITIES.

TRAFFIC CONTROL NOTES

THE CONTRACTOR SHALL SUBMIT A TRAFFIC CONTROL PLAN (11" X 17") FOR APPROVAL PRIOR TO STARTING WORK. THE PLAN SHOULD BE SUBMITTED TO THE TRAFFIC CONTROL PERMIT COUNTER. CONTRACTOR SHALL OBTAIN A TRAFFIC CONTROL PERMIT A MINIMUM OF TWO (2) WORKING DAYS PRIOR TO STARTING WORK, AND A MINIMUM FIVE (5) DAYS IF WORK WILL AFFECT A BUS STOP OR AN EXISTING TRAFFIC SIGNAL, OR IF WORK WILL REQUIRE A

FOOTAGE TOTALS				
ASPHALT CUT	-			
DIRT TRENCH	-			
PUNCH THRU	-			
BORE	-			
TOTAL	-			
R&R SWF TOTAL	_			

PROJECT DICTIONARY

R.O.W. SOUTH SIDE OF BELLA VISTA SITE ADDRESS: (ADJACENT TO 2299 BELLA VISTA) SANTA BARBARA, CA 93108

CROWN CASTLE NG WEST, INC 2125 WRIGHT AVE. SUITE #C9 LA VERNE, CA 91750 CONTACT: HEIDI PAYNE

PHONE: (949) 300-9493 CIVIL ENGINEER:

CONNELL DESIGN GROUP, LLC 26455 RANCHO PARKWAY SOUTH LAKE FOREST, CA 92630 CONTACT: FRANK CARTER (949) 310-8233 PHONE (949) 753-8833 FAX

REVISION DESCRIPTION: DATE/BY: ISSUED FOR 01/15/2013 REVIEW SA ISSUED FOR 03/18/2013 APPROVAL 08/05/2013 APPROVAL ISSUED FOR 03/08/2014 APPROVAL

ENGINEER/CONSULTANT:



26455 RANCHO PARKWAY SOUTH, LAKE FOREST, CA 92630

(949) 753-8807 OFFICE - (949) 753-8833 FAX

CLIENT:



STAMP:

SITE INFO:

MON18


VERIZON MONTECITO-MON18

SITE ADDRESS: THOMAS BROS PAGE XXX GRID XX R.O.W. SOUTH SIDE OF BELLA VISTA DR (ADJACENT TO 2299 BELLA VISTA DR) SANTA BARBARA, CA 93108 LAT: 34.44805 LONG: -119.59984

SHEET TITLE:

TITLE SHEET

DRAWING INFO:

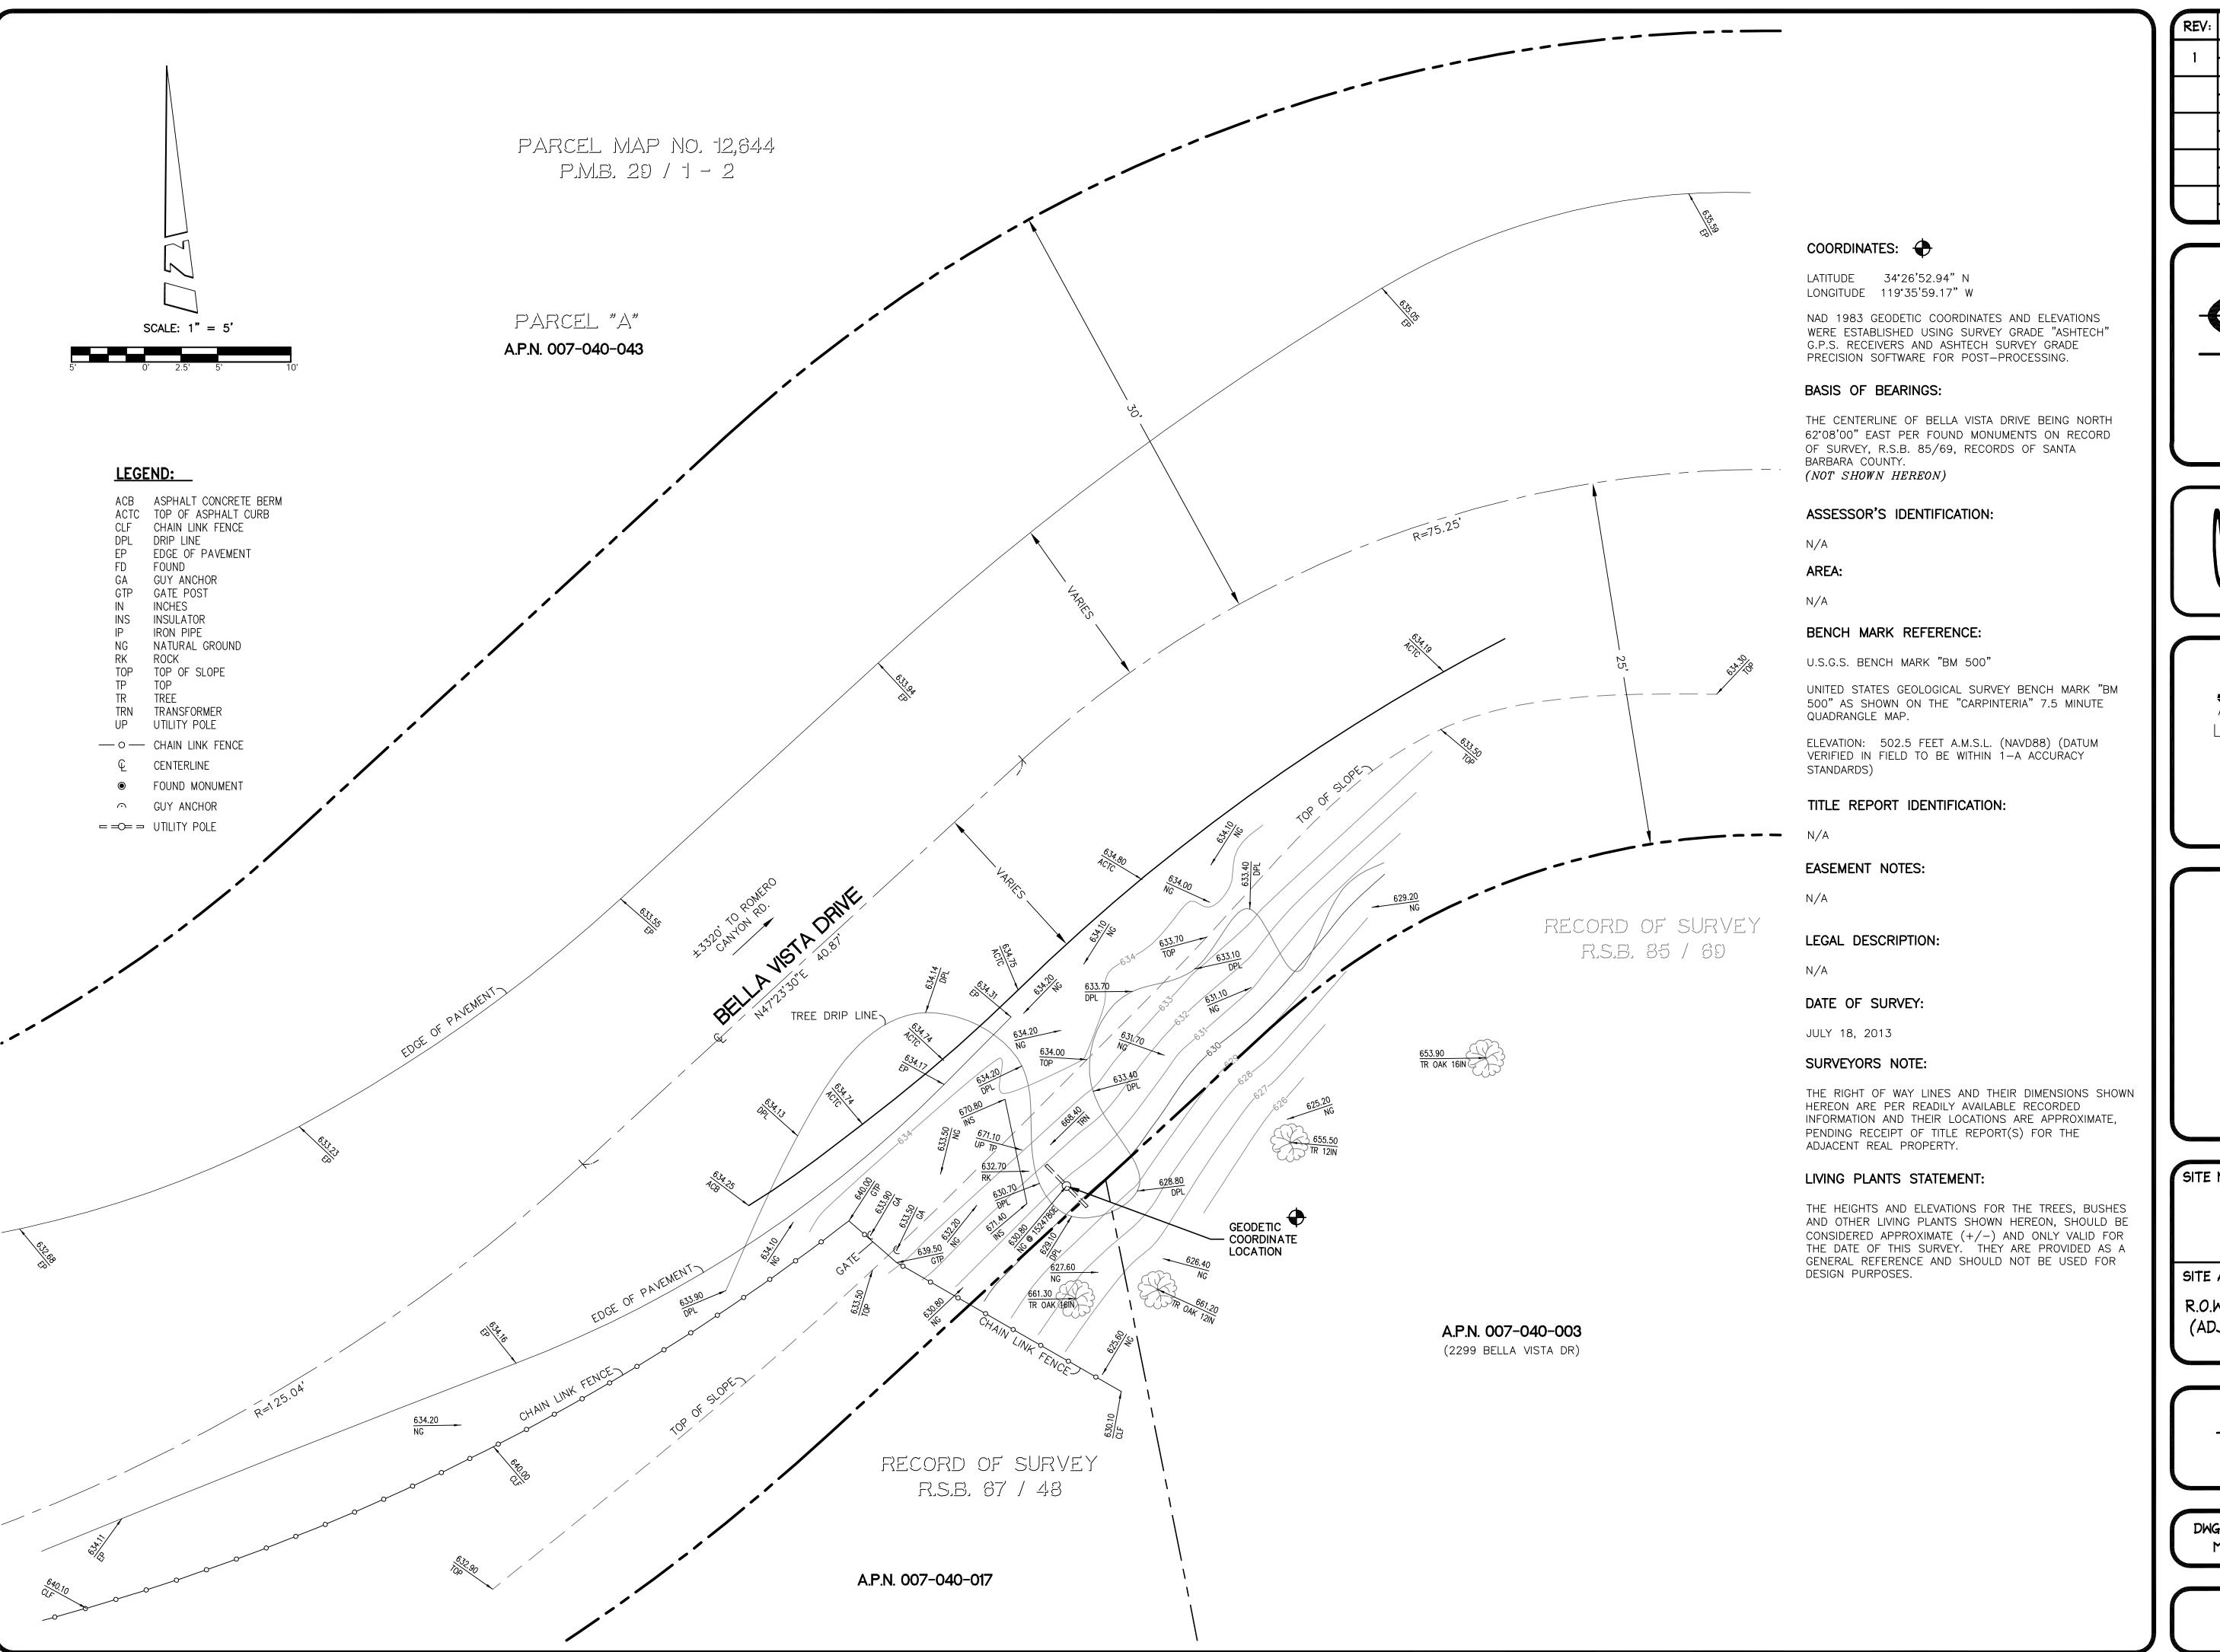

Y		REV:	DATE/BY:	REVISION DESCRIPTION:
		1	07/30/13	ISSUED FOR REVIEW
		•	MDL	
	Н			
	'	&		



26455 RANCHO PKWY. SOUTH LAKE FOREST, CA 92630-8326

(949) 753-8807 OFFICE - (949) 753-8833 FAX

SITE BUILDER:




SURVEYOR:

AND ASSOCIATES, INC.

LAND SURVEYING & MAPPING 3188 AIRWAY AVENUE, SUITE K1 COSTA MESA, CALIFORNIA 92626 714 557-1567 OFFICE 714 557-1568 FAX

JN. 706.231

STAMP:

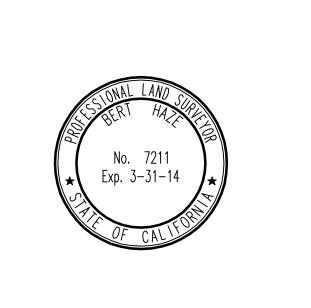

SITE INFO:

SITE NAME:

MON18 VERIZON MONTECITO-MONI8

SITE ADDRESS:


R.O.W. SOUTH SIDE OF BELLA VISTA DR (ADJACENT TO 2299 BELLA VISTA DR) SANTA BARBARA, CA 93108

SHEET TITLE:

TOPOGRAPHIC SURVEY

DRAWING INFO:

DWG. NAME:	DRAWN BY:	DATE:
MON18	MDL	07/30/13
S	HEET NUMBER:	N

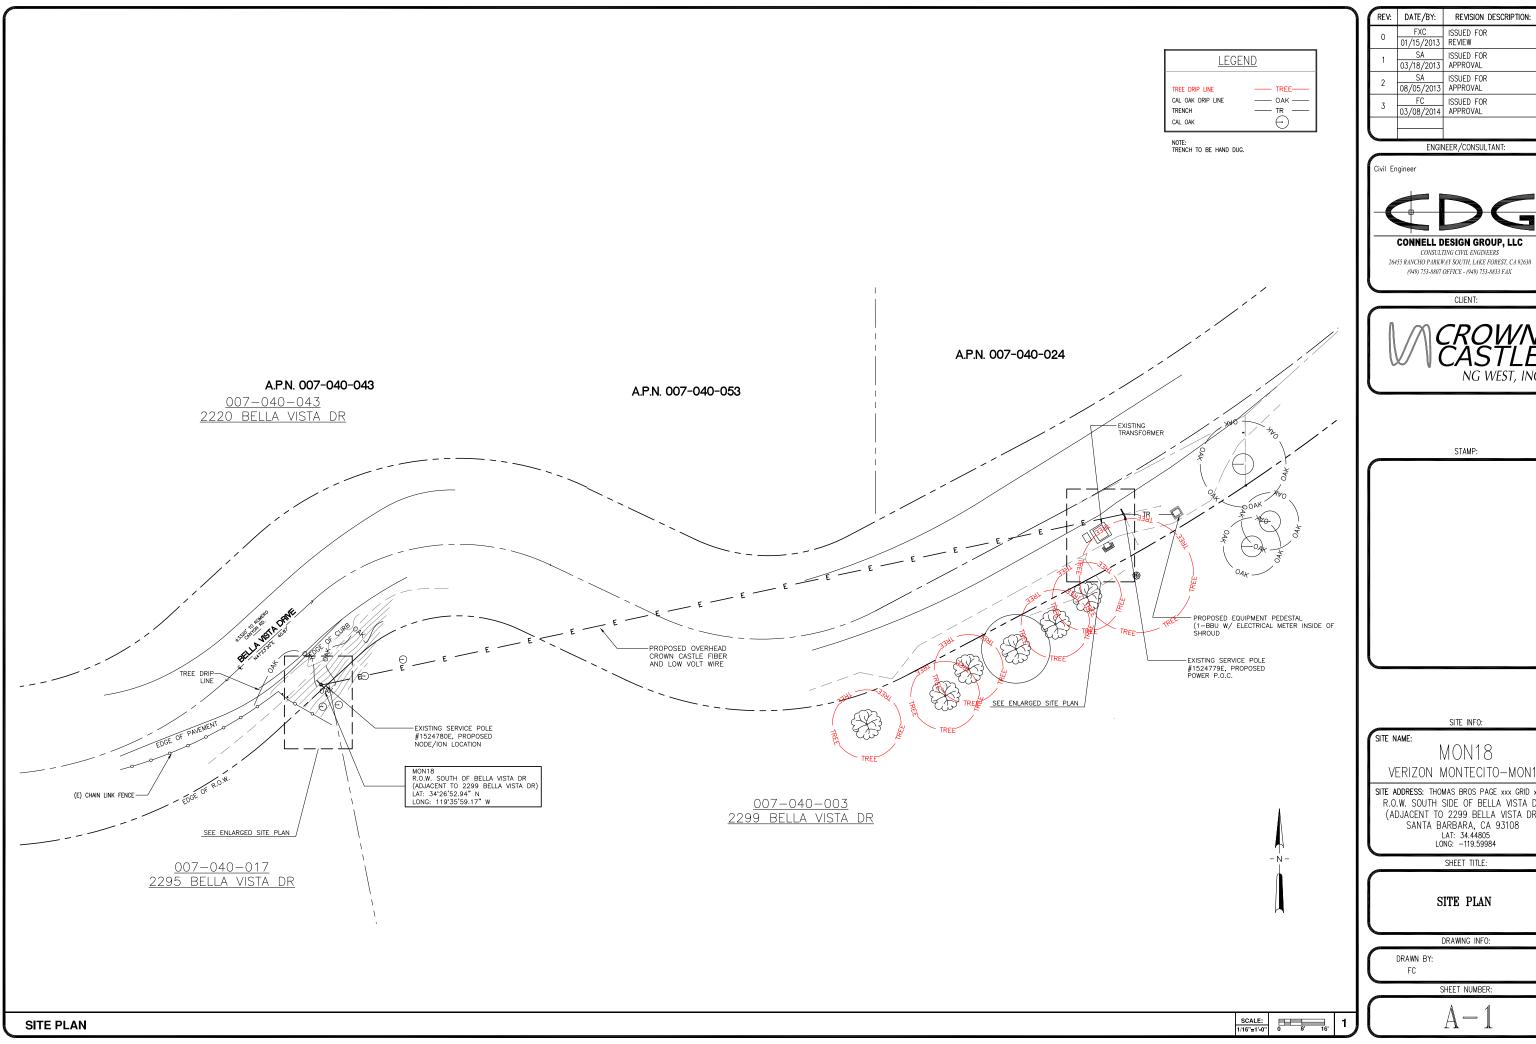

1	REV:	DATE/BY:	REVISION DESCRIPTION:
	0	FXC 01/15/2013	ISSUED FOR REVIEW
	1	SA 03/18/2013	ISSUED FOR APPROVAL
	2	SA 08/05/2013	ISSUED FOR APPROVAL
	3	FC 03/08/2014	ISSUED FOR APPROVAL
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CONNELL DESIGN GROUP, LLC





VERIZON MONTECITO-MON18

SITE ADDRESS: THOMAS BROS PAGE XXX GRID XX R.O.W. SOUTH SIDE OF BELLA VISTA DR (ADJACENT TO 2299 BELLA VISTA DR)
SANTA BARBARA, CA 93108
LAT: 34,44805
LONG: -119.59984

SITE PLAN

DRAWING INFO:

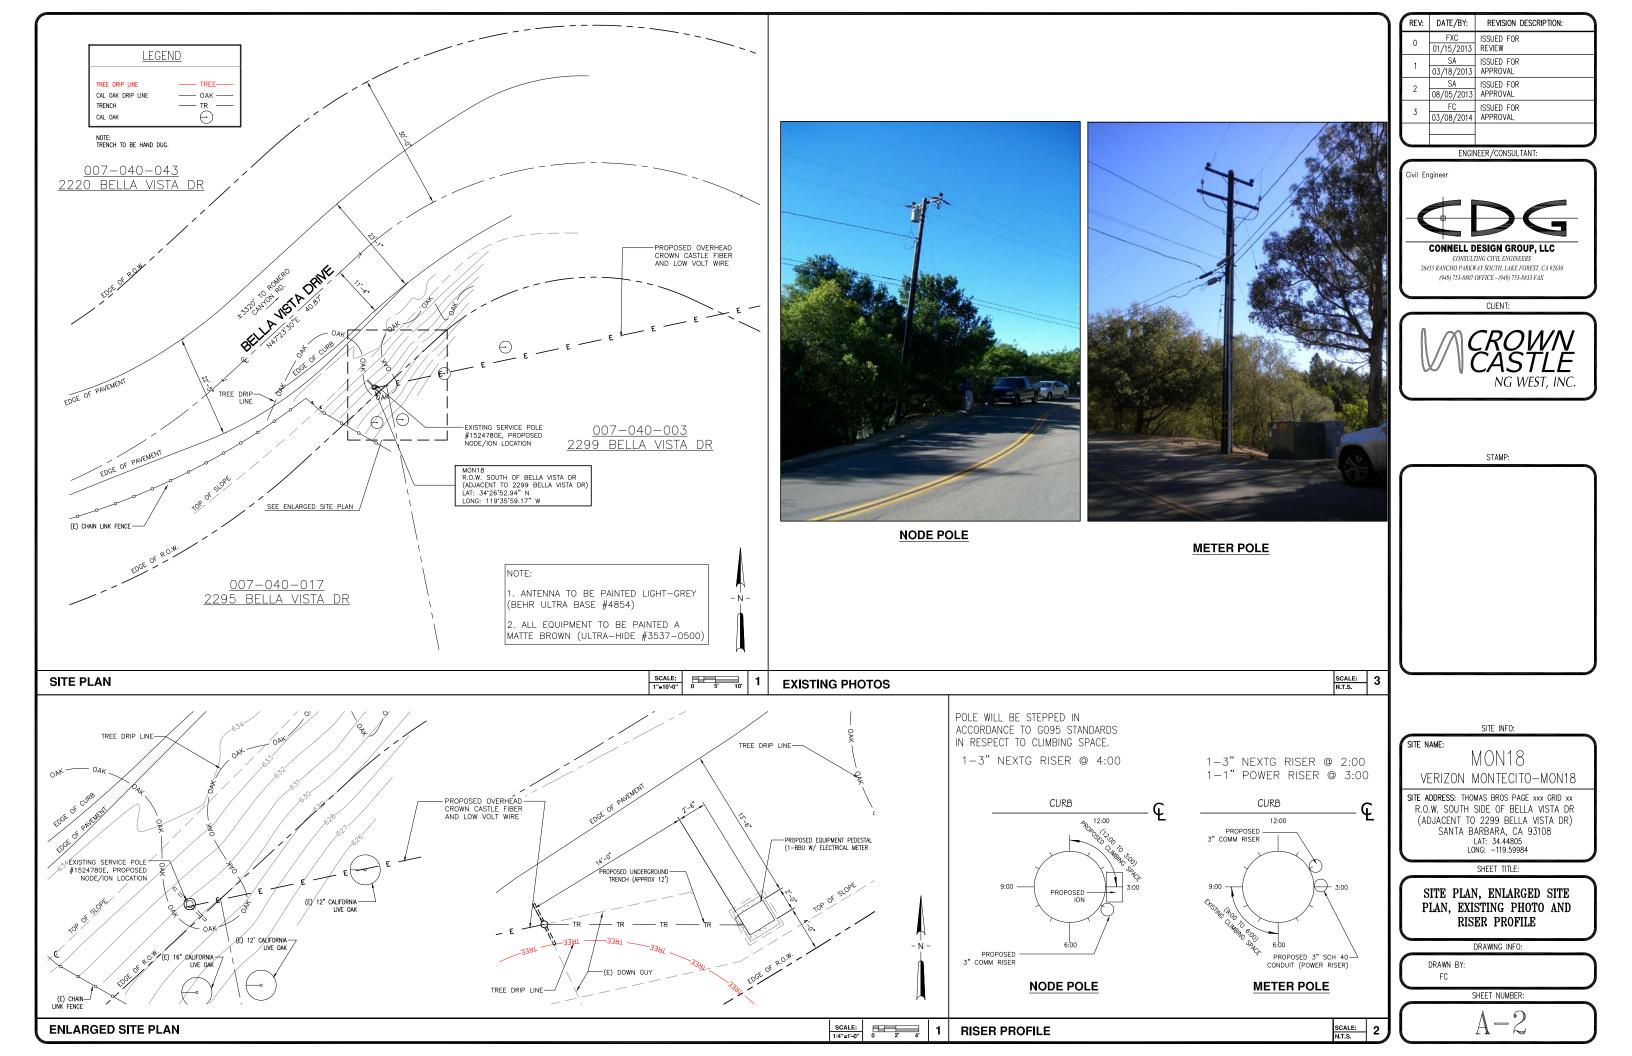

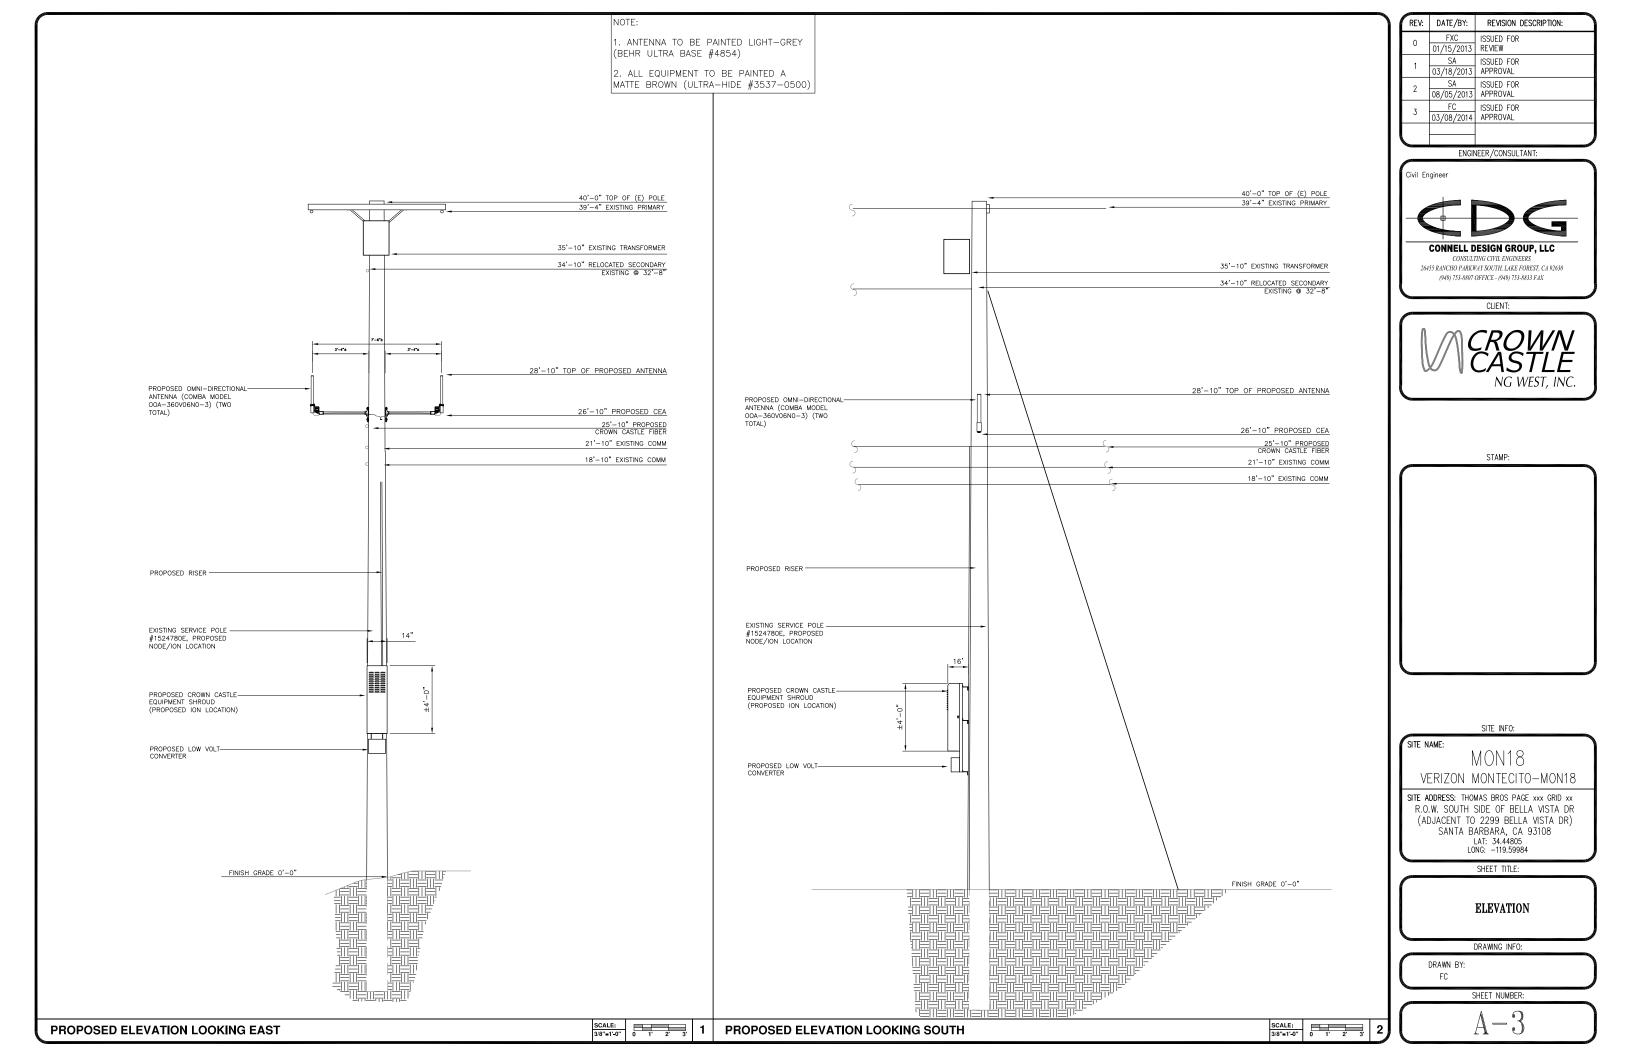

NOTE: NO CUT AND FILL REQUIRED

LEGEND

 \odot

TREE DRIP LINE
CAL OAK DRIP LINE

TRENCH

CAL OAK

GRADING CALCULATION

CONCRETE PAD:

2.997 CF


VAULT:

66.9375 CF

12'Lx3'Dx.5'W TRENCH:

<u>17.25 CF</u>

TOTAL: 87.1845 CF

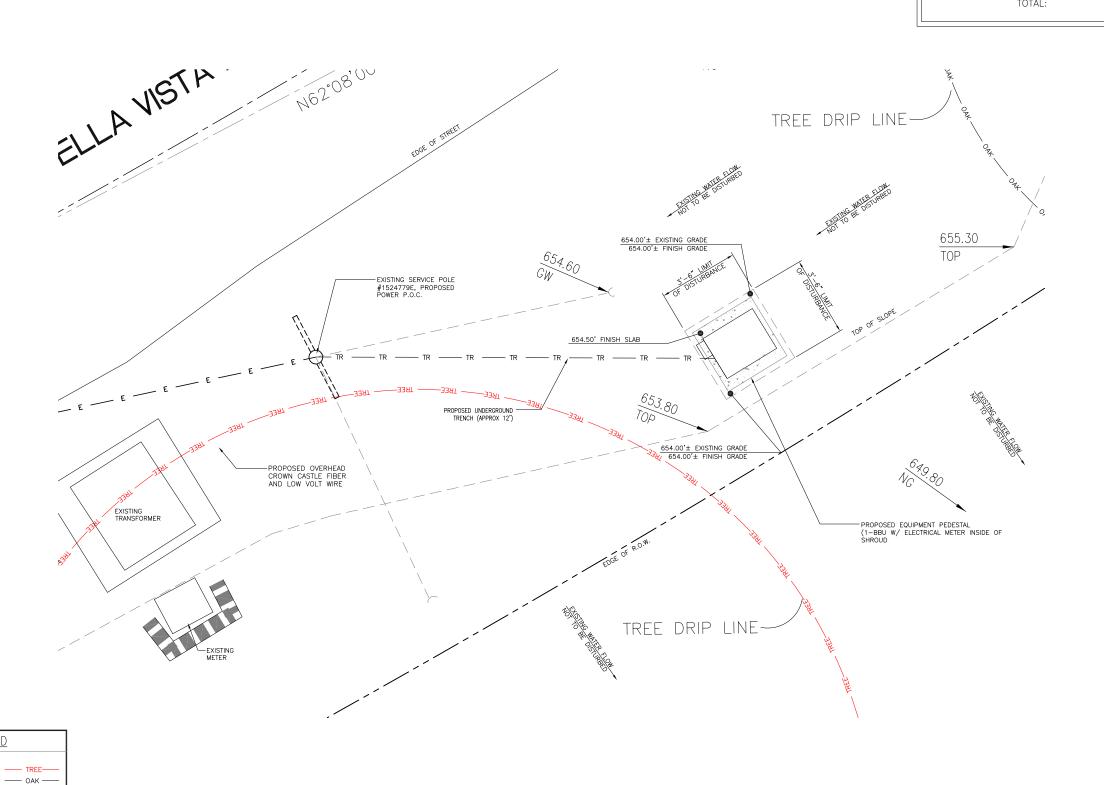

	REV:	DATE/BY:	REVISION DESCRIPTION:
	0	FXC 01/15/2013	ISSUED FOR REVIEW
	1	SA 03/18/2013	ISSUED FOR APPROVAL
	2	SA 08/05/2013	ISSUED FOR APPROVAL
	3	FC 03/08/2014	ISSUED FOR APPROVAL
ı			

ENGINEER/CONSULTANT:



CONSULTING CIVIL ENGINEERS 26455 RANCHO PARKWAY SOUTH, LAKE FOREST, CA 92630 (949) 753-8807 OFFICE - (949) 753-8833 FAX

CLIENT:

STAMP:

SITE INFO:

SITE NAME:

MON18
VERIZON MONTECITO-MON18

SITE ADDRESS: THOMAS BROS PAGE XXX GRID XX R.O.W. SOUTH SIDE OF BELLA VISTA DR (ADJACENT TO 2299 BELLA VISTA DR) SANTA BARBARA, CA 93108 LAT: 34.44805 LONG: -119.59984

SHEET TITLE:

SITE PLAN AND ELEVATION

DRAWING INFO:

DRAWN BY: FC


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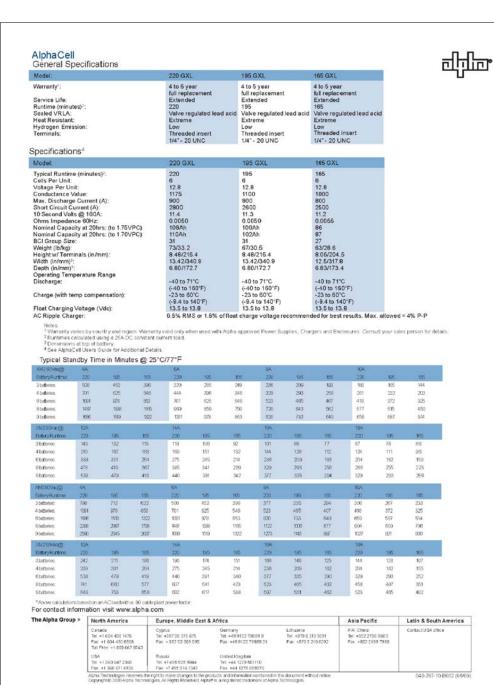
A-4

SITE PLAN

SCALE: 0 1' 2'

REV: DATE/BY: REVISION DESCRIPTION: ISSUED FOR 01/15/2013 REVIEW **COMBA** Outdoor Omni-directional Antenna SA ISSUED FOR 03/18/2013 APPROVAL 08/05/2013 APPROVAL OOA-360V06N0-3 VPol, 696-960/1710-2170MHz, 360°, 4.0/6.0 dBi FC ISSUED FOR 03/08/2014 APPROVAL -PROPOSED ALPHA CELL 220 GXL BATTERY (4 TOTAL) 2.4"ø ENGINEER/CONSULTANT: Technical Specifications Civil Engineer Electrical Frequency Range 696-960 1710-2170 Polarization Vertical dBi 4.0±1 6.0 ± 1 Horizontal Beamwidth PROPOSED 22-53 20-26 Vertical Beamwidth CONNELL DESIGN GROUP, LLC SIDEWALK Electrical Downtilt-Fixed 1.8 200 50 CONSULTING CIVIL ENGINEERS VSWR 26455 RANCHO PARKWAY SOUTH, LAKE FOREST, CA 92630 Maximum Power (949) 753-8807 OFFICE - (949) 753-8833 FAX 8. Impedance Lightning Protection Direct Ground CLIENT: Mechanical 650x60 (25.6x2.4) Dimensions, HxDia Weight, with Mounting kit 1 (2.2) Fiberglass, Light Grey Radome Material and Color Radiating Element Material Copper Connector Type and Location Operational Temperature N-Female, Bottom 3'x3' CONCRETE PAD -55 to +70 95 Operational Humidity Operational Wind Speed km/h (mph) Shipping Dimensions, HxWxD mm (in) 200 (124) 670x100x100 (26.4x3.9x3.9) 1.2 (2.65) -DOOR SIDE Shipping Weight STAMP: 1 | CONCRETE PAD **ANTENNA SPECIFICATIONS** N.T.S. N.T.S. 1900 MHz Electrical Power Supply Frequency range, MHz 1850 to 1915 Mains power, Vac 1930 to 1995 . 1100 max. Power consumption, Watts < 750 @ normal Output power per carrier*, dBm operation 700 MHz SISO/MIMO GSM Frequency range, MHz LTE 698 to 716/776 to 787 40 ** 728 to 757 SITE INFO: PROPOSED FXM UPS Output power per carrier*, dBm UNIT NATIVE DIRT MON18 CommScope[®] VERIZON MONTECITO-MON18 850 MHz ION-M7P/7P/85P/19P SITE ADDRESS: THOMAS BROS PAGE xxx GRID xx Frequency range, MHz R.O.W. SOUTH SIDE OF BELLA VISTA DR 824 to 849 20W for Cell, (ADJACENT TO 2299 BELLA VISTA DR) Noise figure, dB 869 to 894 SANTA BARBARA, CA 93108 PCS bands and Output power per carrier*, dBm LAT: 34.44805 LONG: -119.59984 . +6 max. 4.5 typical 700MHz MIMO 3" DUCT 37 37 SHEET TITLE: Mechanical**** 37 37 36 CDMA Height, width, depth, mm (in) . 817 x 245 x 218 (32.2 x 9.6 x 8.6) DETAILS Weight, kg (lb) 40 (88.2) * TRENCH TO BE BACK FILL WITH NATIVE MATERIAL & COMPACTED TO 90% OR BETTER & REPLACE DRAWING INFO: LANDSCAPING IN KIND. PROPOSED ALPHA CELL 220 GXL-Page 1, February 27, 2013 Company Confidential BATTERY (4 TOTAL) FC SHEET NUMBER: N.T.S. 2 **TRENCH EQUIPMENT PEDESTAL** N.T.S. ION-M7P/7P/85P/19P



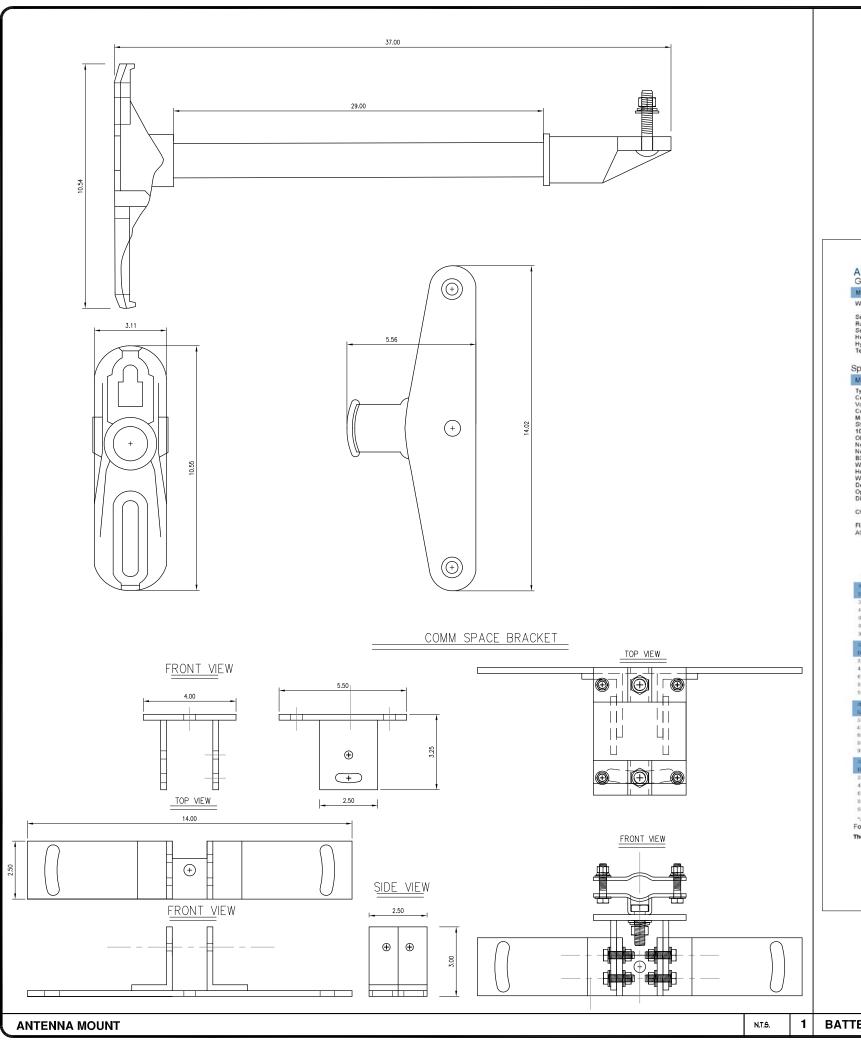

	REV:	DATE/BY:	REVISION DESCRIPTION:
	0	FXC 01/15/2013	ISSUED FOR REVIEW
	1	SA 03/18/2013	ISSUED FOR APPROVAL
	2	SA 08/05/2013	ISSUED FOR APPROVAL
	3	FC 03/08/2014	ISSUED FOR APPROVAL
480			

Civil Engineer



(949) 753-8807 OFFICE - (949) 753-8833 FAX

CLIENT:

26455 RANCHO PARKWAY SOUTH, LAKE FOREST, CA 92630



STAMP:

SITE INFO:

MON18

VERIZON MONTECITO-MON18

SITE ADDRESS: THOMAS BROS PAGE xxx GRID xx R.O.W. SOUTH SIDE OF BELLA VISTA DR (ADJACENT TO 2299 BELLA VISTA DR) SANTA BARBARA, CA 93108 LAT: 34.44805 LONG: -119.59984

SHEET TITLE:

DETAILS

DRAWING INFO:

DRAWN BY FC

SITE NAME:


SHEET NUMBER:


D-2


BATTERY SPECIFICATIONS

N.T.S.

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۱ (REV:	DATE/BY:	REVISION DESCRIPTION:
	0	FXC 01/15/2013	ISSUED FOR REVIEW
	1	SA 03/18/2013	ISSUED FOR APPROVAL
	2	SA 08/05/2013	ISSUED FOR APPROVAL
	3	FC 03/08/2014	ISSUED FOR APPROVAL

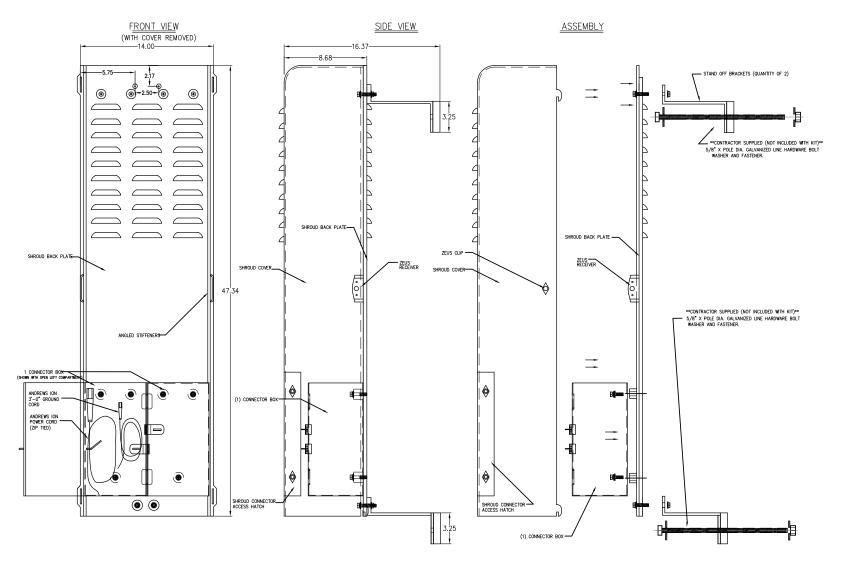Civil Engineer

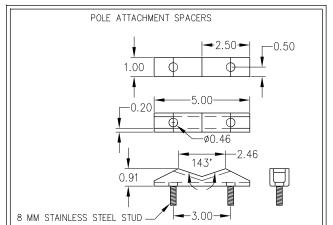

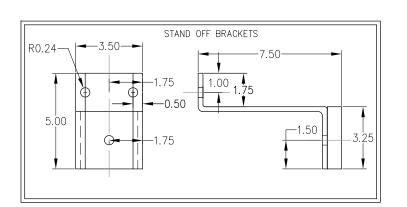26455 RANCHO PARKWAY SOUTH, LAKE FOREST, CA 92630 (949) 753-8807 OFFICE - (949) 753-8833 FAX CLIENT:



STAMP:

SITE INFO:

SITE NAME:

MON18 VERIZON MONTECITO-MON18

SITE ADDRESS: THOMAS BROS PAGE XXX GRID XX R.O.W. SOUTH SIDE OF BELLA VISTA DR (ADJACENT TO 2299 BELLA VISTA DR) SANTA BARBARA, CA 93108 LAT: 34.44805 LONG: -119.59984

SHEET TITLE:

DETAILS

DRAWING INFO:

DRAWN B

SHEET NUMBER:

D-3

SHROUD DETAIL

- . APPROVAL OF THESE PLANS BY THE CITY ENGINEER DOES NOT AUTHORIZE ANY WORK TO BE PERFORMED UNTIL A PERMIT HAS
- 2. UPON ISSUANCE OF A PERMIT, NO WORK WILL BE PERMITTED ON WEEKENDS OR HOLIDAYS WITHOUT PERMISSION FROM THE
- 3. THE APPROVAL OF THIS PLAN OR ISSUANCE OF A PERMIT BY THE LOCAL JURISDICTION DOES NOT AUTHORIZE THE SUBDIVIDER AND OWNER TO VIOLATE ANY FEDERAL, STATE OR CITY LAWS, ORDINANCES, REGULATIONS, OR POLICIES, INCLUDING, BUT NOT LIMITED TO, THE FEDERAL ENDANGERED SPECIES ACT OF 1973 AND AMENDMENTS THERETO (16 USC SECTION 1531 ET.SEQ.).
- 4. THE CONTRACTOR SHALL BE RESPONSIBLE FOR SURVEY MONUMENTS AND/OR VERTICAL CONTROL BENCHMARKS WHICH ARE DISTURBED OR DESTROYED BY CONSTRUCTION. A LAND SURVEYOR MUST FIELD LOCATE, REFERENCE, AND/OR PRESERVE ALL HISTORICAL OR CONTROLLING MONUMENTS PRIOR TO ANY FARTHWORK. IF DESTROYED, SUCH MONUMENTS SHALL BE REPLACED WITH APPROPRIATE MONUMENTS BY A LAND SURVEYOR, A CORNER RECORD OR RECORD OF SURVEY, AS APPROPRIES, SHALL BE FIELD AS REQUIRED BY THE PROFESSIONAL LAND SURVEYORS ACT. IF ANY VERTICAL CONTROL IS TO BE DISTURBED OR DESTROYED, THE LOCAL JURISDICTION FIELD SURVEY SECTION MUST BE NOTIFIED, IN WRITING, AT LEAST 3 DAYS PRIOR TO THE CONSTRUCTION. THE CONTRACTOR WILL BE RESPONSIBLE FOR THE COST OF REPLACING ANY VERTICAL CONTROL BENCHMARKS
- 5. IMPORTANT NOTICE: SECTION 4216 OF THE GOVERNMENT CODE REQUIRES A DIG ALERT IDENTIFICATION NUMBER BE ISSUED BEFORE A "PERMIT TO EXCAVATE" WILL BE VALID. FOR YOUR DIG ALERT I.D. NUMBER, CALL UNDERGROUND SERVICE ALERT, TWO
- 6. CONTRACTOR SHALL BE RESPONSIBLE FOR THE POTHOLE AND LOCATING OF ALL EXISTING UTILITIES THAT CROSS THE PROPOSED TRENCH LINE AND MUST MAINTAIN 1' MINIMUM VERTICAL CLEARANCE.
- 7. CONTRACTOR SHALL SUBMIT TO THE LOCAL JURISDICTION, A CONSTRUCTION PLAN TO PROTECT WATER MAINS PRIOR TO COMMENCING CONSTRUCTION.
- 8. CONTRACTOR SHALL REPLACE OR REPAIR ALL TRAFFIC SIGNAL LOOPS, CONDUIT, AND LANE STRIPING DAMAGED DURING
- 9. CONTRACTOR SHALL NOTIFY THE LOCAL JURISDICTION. A MINIMUM OF 48 HOURS PRIOR TO COMMENCING WORK WITHIN 10' OF
- 10. THIS PROJECT WILL BE INSPECTED BY ENGINEERING AND CAPITAL PROJECTS DEPARTMENT, FIELD ENGINEERING DIVISION.
- 11. AS-BUILT DRAWINGS MUST BE SUBMITTED TO THE CITY RESIDENT ENGINEER PRIOR TO THE ACCEPTANCE OF THIS PROJECT.
- 12. PUBLIC IMPROVEMENT SUBJECT TO DESUETUDE OR DAMAGE." IF REPAIR OR REPLACEMENT OF SUCH PUBLIC IMPROVEMENTS IS REQUIRED, THE OWNER SHALL OBTAIN THE REQUIRED PERMITS FOR WORK IN THE PUBLIC RIGHT-OFWAY, SATISFACTORY TO THE PERMIT - ISSUING AUTHORITY.
- 13. PRIOR TO ANY DISTURBANCE TO THE SITE, EXCLUDING UTILITY MARKS-OUTS AND SURVEYING, THE CONTRACTOR SHALL MAKE ARRANGEMENTS FOR A PRE-CONSTRUCTION MEETING WITH THE LOCAL JURISDICTION FIELD ENGINEERING DIVISION.
- 14. PRIOR TO THE COMMENCEMENT OF ANY CONSTRUCTION SHOWN ON THESE PLANS. IT IS THE SOLE RESPONSIBILITY OF THE CONTRACTOR TO COORDINATE. THE CONTRACTOR IS RESPONSIBLE TO ATTEND THE LOCAL JURISDICTIONS MONTHLY UTILITY COORDINATION COMMITTEE THE CONSTRUCTION ACTIVITIES WITH THE CITY AND ALL OTHER CONTRACTORS SO THAT NO TRENCH IS CUT WITHIN ANY OF THE CITY STREETS THAT HAVE BEEN CONSTRUCTED, REPAIRED, OR SLURRY SEALED WITHIN THREE YEARS OF THE STREET CONSTRCTUION/RESURFACING DATE.
- 15. MANHOLES OR COVERS SHALL BE LABELED "CROWN CASTLE" OR "CROWN CASTLE NG WEST".
- 16 CONTRACTOR SHALL IMPLEMENT AN EROSION AND SEDIMENT CONTROL PROCRAM DURING THE PROJECT CONSTRUCTION ACTIVITIES PROGRAM SHALL MEET THE APPLICABLE REQUIREMENTS OF THE STATE WATER RESOURCE CONTROL BOAR
- 17. THE CONTRACTOR SHALL HAVE EMERGENCY MATERIALS AND EQUIPMENT ON HAND FOR UNFORESEEN SITUATIONS, SUCH AS DAMAGE TO UNDERGROUND WATER, SEWER, AND STORM DRAIN FACILITIES WHEREBY FLOWS MAY GENERATE EROSION AND SEDIMENT

THE FOLLOWING NOTES ARE PROVIDED TO GIVE DIRECTIONS TO THE CONTRACTOR BY THE ENGINEER OF WORK. THE CITY ENGINEER'S SIGNATURE ON THESE PLANS DOES NOT CONSTITUTE APPROVAL OF THESE NOTES AND THE CITY WILL NOT BE RESPONSIBLE FOR THEIR ENFORCEMENT.

- THE CONTRACTOR SHALL VERIFY THE LOCATION EXISTING UNDERGROUND UTILITIES INCLUDING SEWER LATERALS AND WATER SERVICES TO INDIVIDUAL LOTS BOTH VERTICAL AND HORIZONTAL PRIOR TO COMMENCING IMPROVEMENT OPERATIONS.
- 2. CONTRACTOR SHALL MAKE EXPLORATION EXCAVATIONS AND LOCATE EXISTING FACILITIES SUFFICIENTLY AHEAD OF CONSTRUCTION TO PERMIT REVISIONS OF PLANS IF REVISION IS NECESSARY BECAUSE OF LOCATION OF EXISTING UTILITIES.
- 3. LOCATION AND ELEVATIONS OF IMPROVEMENTS, TO BE MET BY WORK, SHALL BE CONFIRMED BY FIELD MEASUREMENT PRIOR TO
- 4. GRADES SHOWN ARE FINISH GRADES, CONTRACTOR SHALL DETERMINE NECESSARY SUB GRADE ELEVATIONS AND SHALL CONSTRUCT SMOOTH TRANSITION BETWEEN FINISH GRADES SHOWN.
- CONTRACTOR AGREES THAT HE SHALL ASSUME SOLE RESPONSIBILITY FOR JOB SITE CONDITION DURING THE COURSE OF CONSTRUCTION OF THIS PROJECT, INCLUDING SAFETY OF ALL PERSONS AND PROPERTY: THAT THIS PROVISION SHALL APPLY CONTINUOUSLY AND NOT BE LIMITED TO NORMAL WORKING HOURS; AND THAT THE CONTRACTOR SHALL DEFEND, INDEMNIFY AND HOLD THE OWNER AND THE ENGINEER HARMLESS FROM ANY AND ALL LIABILITY, REAL OR ALLEGED IN CONNECTION WITH THE PERFORMANCE OF WORK ON THIS PROJECT, EXPECTING FOR LIABILITY ARISING FROM SOLE NEGLIGENCE OF THE OWNER OR THE
- 6. THE CONTRACTOR SHALL BE TOTALLY RESPONSIBLE FOR COMPLIANCE WITH THE PROVISIONS OF THE STATE OF CALIFORNIA SAFETY
- 7. THE LOCATIONS OF ALL EXISTING UTILITIES SHOWN ON THESE PLANS ARE FROM EXISTING RECORDS AND CORROBORATED, WHERE POSSIBLE WITH FIELD TIES. THE CONTRACTOR IS RESPONSIBLE FOR CONFIRMING THE LOCATIONS SHOWN, BOTH HORIZONTALLY AND VERTICALLY, PRIOR TO CONSTRUCTION. IF EXISTING LOCATIONS VARY SUBSTANTIALLY FROM THE PLANS, THE ENGINEER SHOULD BE NOTIFIED TO MAKE ANY CONSTRUCTION CHANGES REQUIRED.
- 8. THE CONTRACTOR SHALL PROVIDE TEMPORARY SUPPORT FOR ALL SEWER AND WATER MAIN UNDER CROSSING IN ACCORDANCE WITH PART 1 SECTION 5-2 OF THE STANDARD SPECIFICATION.
- 9. THE CONTRACTOR SHALL REPLACE OR REPAIR ALL TRAFFIC SIGNAL LOOPS, CONDUITS, AND LANE STRIPING DAMAGED DURING
- 10. THE CONTRACTOR SHALL SUBMIT WORK PLANS FOR ALL BORE OPERATIONS TWO WEEKS PRIOR TO COMMENCING WORK.
- 11. CONTRACTOR SHALL BE RESPONSIBLE FOR THE POTHOLE AND LOCATING OF ALL EXISTING UTILITIES THAT CROSS THE PROPOSED

CONSTRUCTION CHANGE TABLE

EFFECTED OR ADDED SHEET NUMBERS

12. AS-BUILT DRAWINGS MUST BE SUBMITTED TO THE CITY ENGINEER PRIOR TO ACCEPTANCE OF THIS PROJECT



CHANGE

DATE

APPLICABLE CODES

ALL WORK SHALL COMPLY WITH THE FOLLOWING APPLICABLE CODES:

GROUND BUS BAR MECH. GRND. CONN

CADWELD

EXISTING SERVE SIDEWALK FLA

ELECTRIC BOX

TELEPHONE BOX

SIDEWALK FLAG

EXISTING SERVICE POLE

IN THE EVENT OF CONFLICT, THE MOST RESTRICTIVE CODE SHALL PREVAIL

PROJECT DESCRIPTION

VICINITY MAP - N.T.S.

ELEVATION REF.

-- — PROP./LEASE LINE

MATCH LINE

— WORK POINT

— T — TELE, CONDUIT

— — CENTERLINE

SYMBOLS, LINETYPES AND HATCH PATTERNS

X SECTION REF.

(2) OMNI ANTENNAS ON EXISTING UTILITY POLE

∴ LIGHT POLE

O FOUNDATION

▲ SET POINT

(x) DETAIL REF.

A REVISION

SPOT ELEV.

2. EQUIPMENT PEDESTAL W/ BBU, AND ELECTRICAL METER AT BASE OF

3. PROPOSED SHROUD W/ ION ON EXISTING UTILITY POLI

CROWN CASTLE NG WEST, LLC

VERIZON MONTECITO-MON19m1

R.O.W. SOUTH SIDE OF ROMERO CANYON RD.

(ACROSS FROM 969 ROMERO CANYON RD)

SANTA BARBARA, CA 93108

SITE: VERIZON

POLE# 443777E

MONTECITO-MON19m1

— E — ELECT. CONDUIT

MYERS PEDESTAL

VAULT STANDARD 2'X3'

STEEL POLE

SHEET INDEX: TITLE SHEET T-1 - SHEET 1 OF 6 SITE PLAN A-1 - SHEET 2 OF 6 PROPOSED ELEVATIONS A-2 - SHFFT 3 OF 6 DETAILS D-1 - SHEET 4 OF 6 D-2 - SHEET 5 OF 6 DETAILS D-3 - SHEET 6 OF 6

EROSION AND SEDIMENT CONTROL NOTES

TEMPORARY EROSION/SEDIMENT CONTROL, PRIOR TO COMPLETION OF FINAL IMPROVEMENTS. SHALL BE PERFORMED BY THE CONTRACTOR OR QUALIFIED PERSON AS INDICATED BELOW:

- 1. ALL REQUIREMENTS OF THE LOCAL JURISDICTION "LAND DEVELOPMENT MANUAL, STORM WATER STANDARDS" MUST BE INCORPORATED INTO THE DESIGN AND CONSTRUCTION OF THE PROPOSED GRADING/IMPROVEMENTS CONSISTENT WITH THE APPROVED STORM WATER AND/OR WATER POLLUTION CONTROL PLAN (WPCP).
- 2. FOR STORM DRAIN INLETS, PROVIDE A GRAVEL BAG SILT BASIN IMMEDIATELY UPSTREAM
- 3. FOR INLETS LOCATED AT SUMPS ADJACENT TO TOP OF SLOPES, THE CONTRACTOR SHALL ENSURE THAT WATER DRAINING TO THE SUMP IS DIRECTED INTO THE INLET AND THAT A MINIMUM OF 1.00" FREEBOARD EXISTS AND IS MAINTAINED ABOVE THE TOP OF THE INLET. IF FREEBOARD IS NOT PROVIDED BY GRADING SHOWN ON THESE PLANS, THE CONTRACTOR SHALL PROVIDE IT VIA TEMPORARY MEASURES, I.E. GRAVEL BAGS OR DIKES.
- 4. THE CONTRACTOR OR QUALIFIED PERSON SHALL BE RESPONSIBLE FOR CLEANUP OF SILT AND MUD ON ADJACENT STREET(S) AND STORM DRAIN SYSTEM DUE TO CONSTRUCTION
- 5. THE CONTRACTOR OR QUALIFIED PERSON SHALL CHECK AND MAINTAIN ALL LINED AND UNLINED DITCHES AFTER EACH RAINFALL.
- 6. THE CONTRACTOR SHALL REMOVE SILT AND DEBRIS AFTER EACH MAJOR RAINFALL.
- EQUIPMENT AND WORKERS FOR EMERGENCY WORK SHALL BE MADE AVAILABLE AT ALL TIMES DURING THE RAINY SEASON, ALL NECESSARY MATERIALS SHALL BE STOCKPILED ON SITE AT CONVENIENT LOCATIONS TO FACILITATE RAPID CONSTRUCTION OF TEMPORARY DEVICES WHEN RAIN IS IMMINENT.
- 8. THE CONTRACTOR SHALL RESTORE ALL EROSION/SEDIMENT CONTROL MEASURES TO WORKING ORDER TO THE SATISFACTION OF THE CITY ENGINEER OR RESIDENT ENGINEER AFTER EACH RUN-OFF PRODUCING RAINFALL.
- THE CONTRACTOR SHALL INSTALL ADDITIONAL EROSION CONTROL MEASURES AS MAY BE REQUIRED BY THE RESIDENT ENGINEER DUE TO UNCOMPLETED GRADING OPERATIONS OR UNFORESEEN CIRCUMSTANCES, WHICH MAY ARISE.
- 10. THE CONTRACTOR SHALL BE RESPONSIBLE AND SHALL TAKE NECESSARY PRECAUTIONS TO PREVENT PUBLIC TRESPASS ONTO AREAS WHERE IMPOUNDED WATERS CREATE A HAZARDOUS CONDITION.
- 11. ALL EROSION/SEDIMENT CONTROL MEASURES PROVIDED PER THE APPROVED GRADING PLAN SHALL BE INCORPORATED HEREON. ALL EROSION/SEDIMENT CONTROL FOR INTERIM CONDITIONS SHALL BE DONE TO THE SATISFACTION OF THE RESIDENT ENGINEER. 12 CRADED AREAS AROUND THE PROJECT PERIMETER MUST DRAIN AWAY FROM THE FACE
- OF THE SLOPE AT THE CONCLUSION OF EACH WORKING DAY. 13. ALL REMOVABLE PROTECTIVE DEVICES SHOWN SHALL BE IN PLACE AT THE END OF EACH
- WORKING DAY WHEN RAIN IS IMMINENT. 14. THE CONTRACTOR SHALL ONLY GRADE, INCLUDING CLEARING AND GRUBBING FOR THE AREAS FOR WHICH THE CONTRACTOR OR QUALIFIED PERSON CAN PROVIDE
- 15 THE CONTRACTOR SHALL ARRANGE FOR WEEKLY MEETINGS DURING OCTORER 1ST TO APRIL 30TH FOR PROJECT TEAM (GENERAL CONTRACTOR, QUALIFIED PERSON, EROSION CONTROL SUBCONTRACTOR IF ANY, ENGINEER OF WORK, OWNER AND THE RESIDENT ENGINEER) TO EVALUATE THE ADEQUACY OF THE EROSION/SEDIMENT CONTROL MEASURES AND OTHER RELATED CONSTRUCTION ACTIVITIES.

TRAFFIC CONTROL NOTES

EROSION/SEDIMENT CONTROL MEASURES.

THE CONTRACTOR SHALL SUBMIT A TRAFFIC CONTROL PLAN (11" X 17") FOR APPROVAL PRIOR TO STARTING WORK. THE PLAN SHOULD BE SUBMITTED TO THE TRAFFIC CONTROL PERMIT COUNTER. CONTRACTOR SHALL OBTAIN A TRAFFIC CONTROL PERMIT A MINIMUM OF TWO (2) WORKING DAYS PRIOR TO STARTING WORK, AND A MINIMUM FIVE (5) DAYS IF WORK WILL AFFECT A BUS STOP OR AN EXISTING TRAFFIC SIGNAL, OR IF WORK WILL REQUIRE A

FOOTAGE TOTALS				
ASPHALT CUT	-			
DIRT TRENCH	-			
PUNCH THRU	-			
BORE	-			
TOTAL	=			
R&R SWF TOTAL	-			

PROJECT DICTIONARY

R.O.W. SOUTH SIDE OF ROMERO CANYON RD. (ACROSS FROM 969 ROMERO CANYON RD) SANTA BARBARA, CA 93108

CROWN CASTLE NG WEST, LLC 2125 WRIGHT AVE, SUITE #C9 LA VERNE, CA 91750 CONTACT: HEIDI PAYNE

PHONE: (949) 300-9493

CONNELL DESIGN GROUP, LLC 26455 RANCHO PARKWAY SOUTH LAKE FOREST, CA 92630 CONTACT: FRANK CARTER (949) 310-8233 PHONE (949) 753-8833 FAX

REVISION DESCRIPTION: DATE/BY: ISSUED FOR 02/10/2014 REVIEW FXC ISSUED FOR 03/08/2014 FINAL

ENGINEER/CONSULTANT:



CLIENT:

(949) 753-8807 OFFICE - (949) 753-8833 FAX



STAMP

SITE INFO:


MON19m1 VERIZON MONTECITO-MON19m1


SITE ADDRESS: THOMAS BROS PAGE 987 GRID E7 R.O.W. SOUTH SIDE OF ROMERO CANYON RD (ACROSS FROM 969 ROMERO CANYON RD) SANTA BARBARA, CA 93108 LAT: 34.443777 LONG: -119.592570

SHEET TITLE:

TITLE SHEET

DRAWING INFO:

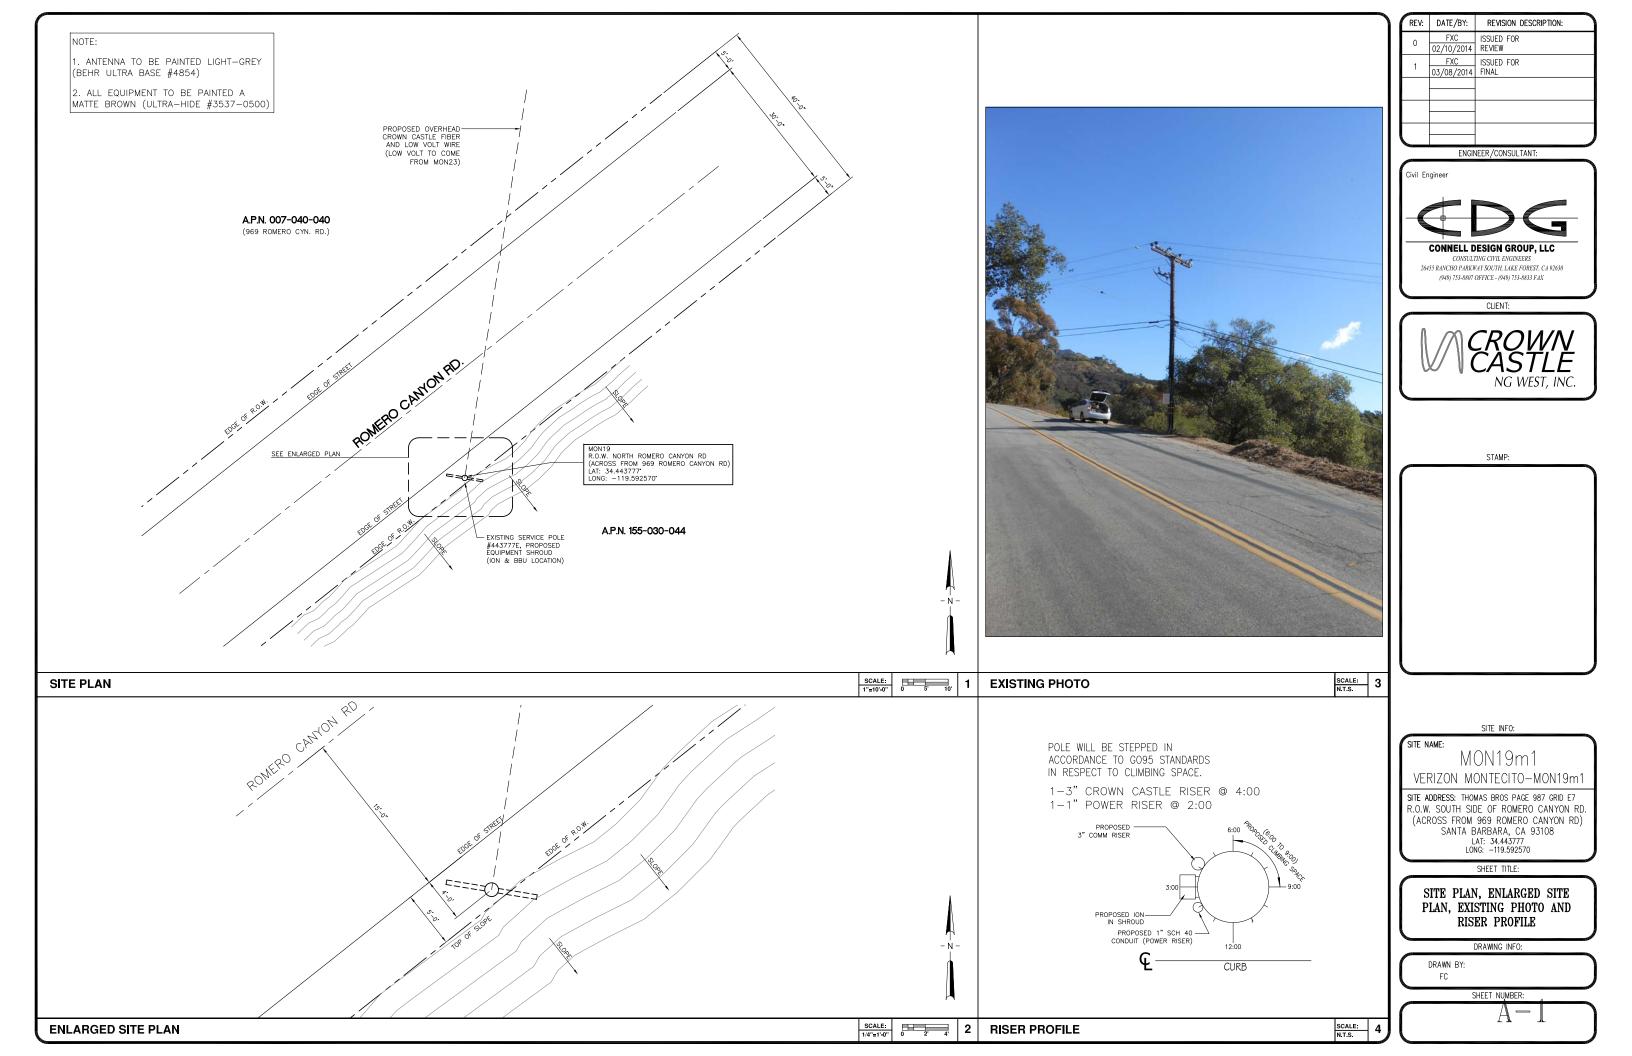

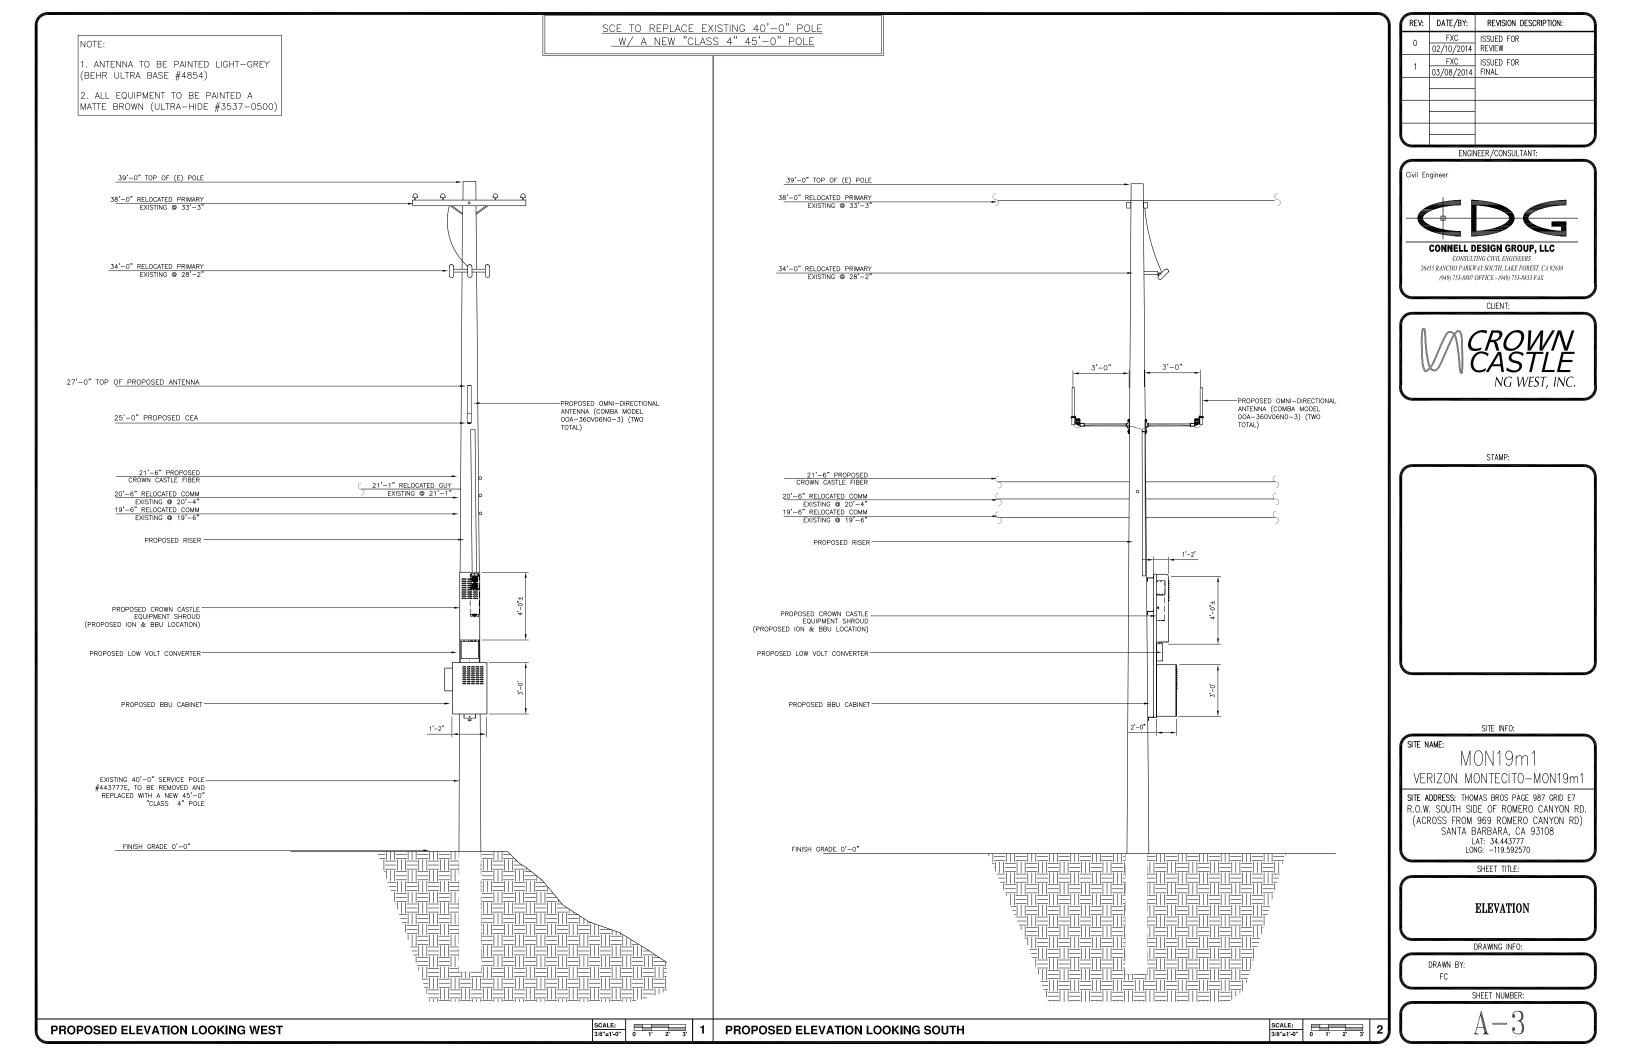

Outdoor Omni-directional Antenna

COMBA

OOA-360V06N0-3 VPol, 696-960/1710-2170MHz, 360°, 4.0/6.0 dBi


Technical Specifications

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Frequency Range	MHz	696-960	1710–2170
Polarization		Veri	ical
Gain	dBi	4.0±1	6.0±1
Horizontal Beamwidth	deg	36	0
Vertical Beamwidth	deg	22-53	20–26
Electrical Downtilt-Fixed	deg	0	
VSWR	9	1.	.8
Maximum Power	W	20	00
Impedance		5	0
Lightning Protection		Direct	Ground

Mechanical

Dimensions, HxDia 650x60 (25.6x2.4) Weight, with Mounting kit Radome Material and Color Fiberglass, Light Grey Radiating Element Material N-Female, Bottom Connector Type and Location Operational Temperature Operational Humidity Operational Wind Speed km/h (mph) Shipping Dimensions, HxWxD mm (in) 200 (124) 670x100x100 (26.4x3.9x3.9) 1.2 (2.65) Shipping Weight

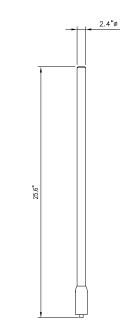

ANTENNA SPECIFICATIONS N.T.S.

Copper

-55 to +70

9.5

Electrical

Power Supply Mains power, Vac . 1100 max. Power consumption, Watts < 750 @ normal operation

700 MHz SISO/MIMO

Frequency range, MHz 698 to 716/776 to 787 728 to 757

Output power per carrier*, dBm

Number of Carriers 1

850 MHz

Frequency range, MHz 824 to 849

Output power per carrier*, dBm

Analog GSM 37 43 40 CDMA 43 37 37

1900 MHz Frequency range, MHz

1850 to 1915 1930 to 1995

Output power per carrier*, dBm

GSM LTE 40 **



ION-M7P/7P/85P/19P

20W for Cell, Noise figure, dB

PCS bands and

700MHz MIMO

+6 max. 4.5 typical

Mechanical****

Height, width, depth, mm (in) 817 x 245 x 218 (32.2 x 9.6 x 8.6) 40 (88.2) Weight, kg (lb)

Page 1, February 27, 2013 Company Confidential

General Specifications

AlphaCell



Specifications4

220 GXL 195 GXL 165 GXL 220 6 165 Typical Runtime (minutes)2: Cells Per Unit: Voltage Per Unit: Conductance Value: 12.8 Max. Discharge Current (A): Short Circuit Current (A): 10 Second Volts @ 100A: 900 2600 11.3 2500 11.2 0.0055 0.0050 109Ah 110Ah Ohms Impedance 60Hz: Nominal Capacity at 20hrs: (to 1.75VPC) 0.0050 100Ah Nominal Capacity at 20hrs: (to 1.70VPC) 102Ah BCI Group Size: 31 73/33.2 31 67/30.5 63/28.6 Weight (lb/kg): 8.48/215.4 13.42/340.9 6.80/172.7 Height w/ Terminals (in/mm): Width (in/mm)³: 8.48/215.4 8.05/204.5 13.42/340.9 12.6/317.8 6.83/173.4 Depth (in/mm) Operating Temperature Range Discharge: -40 to 71°C -40 to 71°C (-40 to 160°F) -23 to 60°C (-9.4 to 140°F) (-40 to 160"F) (-40 to 160°F) -23 to 60°C (-9.4 to 140°F) -23 to 60°C (-9.4 to 140°F) Charge (with temp compensation): 13.5 to 13.8 13.5 Float Charging Voltage (Vdc):

AC Ripple Charger:

volves.

Vaxranty varies by country and region. Warranty valid only when used with Alpha approved Power Supplies, Chargers and Enclosures. Consult your sales person for details.

Runtimes celculated using a 25A DC constant current load.

³ Dimensions at top of battery. ⁴ See AlphaCell Users Guide for Additional Details.

Typical Standby Time in Minutes @ 25°C/77°F

3/M290Vac(2)	46			64			8A			10A		
BatteryRuntme	220	195	185	220	195	165	220	195	165	220	195	10
3 batteries	508	453	396	320	285	249	286	209	193	186	165	14
4 batteries.	701	625	546	444	396	346	329	293	256	261	232	20
6 batteries.	1091	978	853	701	625	546	523	485	407	418	372	32
8 batteries	1487	1338	1165	960	859	750	720	643	562	577	515	45
9 batteries:	1686	1519	1322	1091	978	853	820	733	640	659	587	51
XM290Vas(Z)	12A	_	_	14A		_	16A			18A	_	
Battery Runtime	220	195	165	220	195	165	220	195	185	220	195	165
3 batteries	149	132	115	119	106	92	101	89	77	87	78	66
4 batteries	210	187	163	169	151	132	144	128	112	124	111	96
6 batteries:	339	301	264	275	245	214	236	209	183	204	182	159
8 batteries:	478	419	367	385	341	299	329	293	256	288	255	223
9 betteries:	538	479	419	440	391	342	377	335	294	329	293	256
XM260Vac@	44			ÐΑ			8A			10A		
BatteryRuntime:	220	195	165	220	195	165	220	195	165	220	195	165
3 batteries:	798	712	622	508	453	396	377	335	294	300	267	233
4 bettenes:	1091	978	853	701	625	546	523	465	407	418	372	325
6 betteries:	1686	1519	1322	1091	978	853	820	733	640	659	587	514
8 batteries:	2288	2067	1798	1487	1338	1165	1122	1006	877	904	809	706
9 betteries	2590	2345	2037	1686	1519	1322	1273	1143	997	1027	921	803
XMZ60Vac@	12A			14A			16A			18A		
Battery Runtime:	220	195	165	220	195	165	220	195	165	220	196	165
3 batteries:	242	215	188	196	174	151	186	148	125	144	128	107
4 batteries:	339	301	264	275	245	214	236	209	182	204	182	155
6 batteries	538	479	419	440	391	340	377	335	290	329	293	252
			577	and the	541	470	523	465	402	458	407	351
8 batteries	741	660	D()	607	241	470	250	900	402	400	407	201

*Above calculations based on an AC load with a 90 cable plant power factor.

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REV: DATE/BY: REVISION DESCRIPTION: ISSUED FOR 02/10/2014 REVIEW FXC ISSUED FOR 03/08/2014 FINAL

ENGINEER / CONSULTANT:



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STAMP:

SITE INFO:

SITE NAME:

MON19m1 VERIZON MONTECITO-MON19m1

SITE ADDRESS: THOMAS BROS PAGE 987 GRID E7 R.O.W. SOUTH SIDE OF ROMERO CANYON RD (ACROSS FROM 969 ROMERO CANYON RD) SANTA BARBARA, CA 93108 LAT: 34.443777 LONG: -119.592570

SHEET TITLE:

DETAILS

DRAWING INFO:

FC

SHEET NUMBER:

N.T.S. 2 BATTERY SPECIFICATIONS N.T.S. ION-M7P/7P/85P/19P