SANTA BARBARA COUNTY FLOOD CONTROL AND WATER CONSERVATION DISTRICT COLD SPRINGS DEBRIS BASIN IMPROVEMENT PROJECT

SC8355

FINAL PLANS

IN THE MONTECITO AREA OF SANTA BARBARA COUNTY, CALIFORNIA

TeiMDheil Reservoir Reservoir Reservoir Reservoir Reservoir Reservoir Reservoir New Cuydma Cu

VICINITY MAP

No Scale

CA: 1-800-422-4133

CALL TWO WORKING
DAYS BEFORE YOU DIG

DISTRICT BOARD OF DIRECTORS


FIRST DISTRICT, CHAIR
SECOND DISTRICT
THIRD DISTRICT
FOURTH DISTRICT
FIFTH DISTRICT
Steve Lavagnino

CHAIR BOARD OF DIRECTORS

Steve Lavagnino

INDEX TO SHEETS

DESCRIPTION	SHEET NO.
TITLE SHEET	1
GENERAL INFORMATION	2
SURVEY INFORMATION	3
TYPICAL SECTIONS 1	4
TYPICAL SECTIONS 2	5
KEYLINE GEOMETRY	6
DEMOLITION PLAN	7
LAYOUT PLAN	8
GRADING PLAN	9
COLD SPRINGS CREEK PROFILE	10
ACCESS ROAD PROFILE	11
SECTIONS 1	12
SECTIONS 2	13
SECTIONS 3	14
POOL, RIFFLE, AND ESM DETAIL	15
DETAILS	16
PLANTING PLAN	17
OUTLET STRUCTURE PLAN	18
OUTLET STRUCTURE FOUNDATION PLAN	19
SLAB REINFORCING PLAN	20
OUTLET STRUCTURE ELEVATIONS 1	21
OUTLET STRUCTURE ELEVATIONS 2	22
OUTLET STRUCTURE TYPICAL SECTIONS	23
OUTLET STRUCTURE DETAILS	24
RETAINING WALL DETAILS 1	25
RETAINING WALL DETAILS 2	26

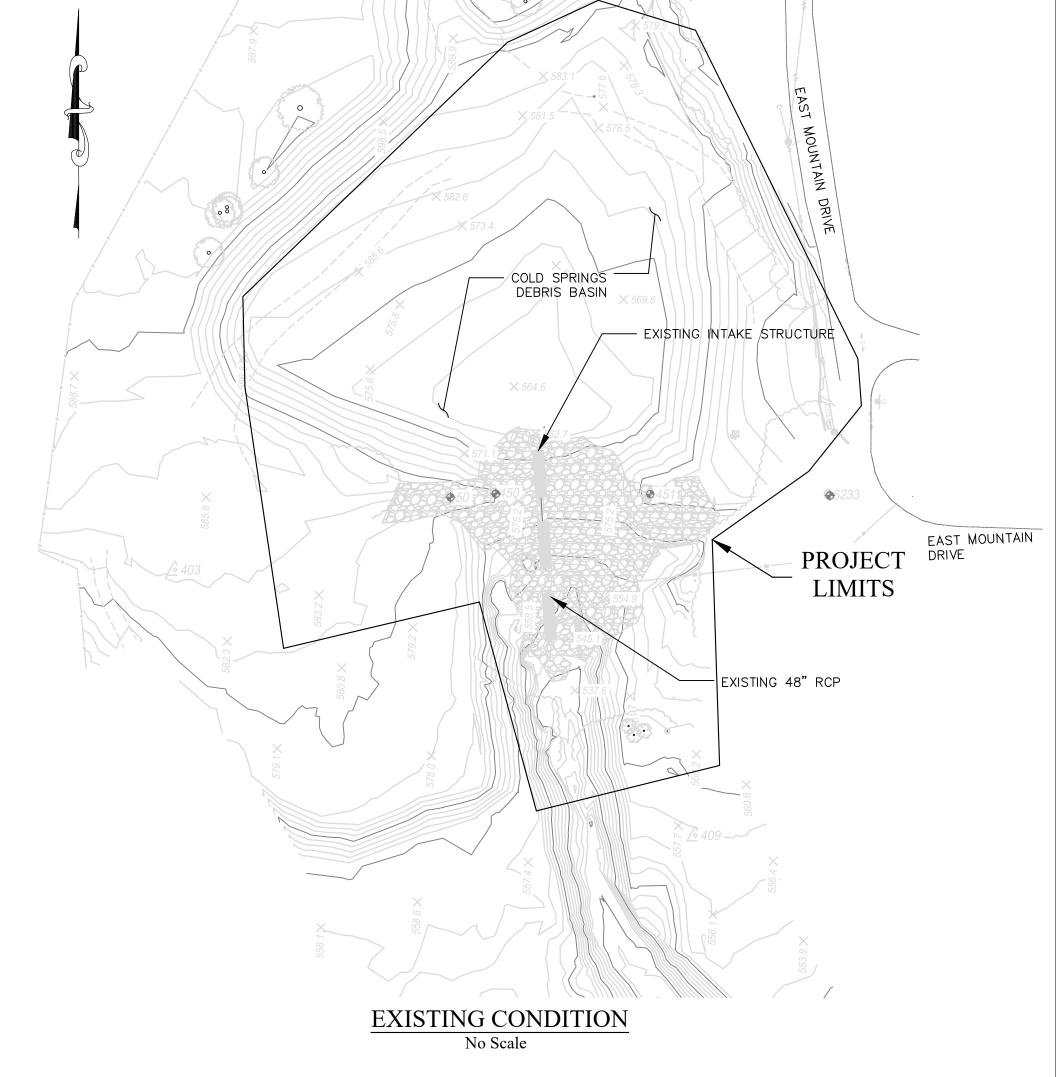

THE (OR	TRACTOR'S LICENSE CONTRACTOR SHALL POSSESS THE CLASS CLASSES) OF LICENSE AS SPECIFIED THE "NOTICE" ADVERTISING FOR BIDS.			
	REVISIONS			PROFESSION.
10.	DESCRIPTION	DATE	APR	LAED EY BROOKING
				No. C88686

THE SANTA BARBARA COUNTY FLOOD CONTROL & WATER CONSERVATION DISTRICT AND ITS EMPLOYEES WILL NOT BE RESPONSIBLE FOR, OR LIABLE FOR, UNAUTHORIZED CHANGES TO OR USES OF THESE PLANS. ALL PROPOSED CHANGES TO THE PLANS MUST BE PRESENTED IN WRITING TO THE DISTRICT AND APPROVED IN WRITING BY THE DISTRICT PRIOR TO IMPLEMENTATION

UNAUTHORIZED CHANGES OR USES:

OF ANY SUCH CHANGE OR USE.

	DESIGNED BY:		
	Lent 11/03/2023		
\	WRECO DATE		
ľ	REVIEWED BY: Cocusigned by:	REVIEWED BY	
$\ $	Matt Griffin 12/20/2023 8:19 AM PST	Floyd Holmes 12/20/2023	11:54 AM P
IJ	FLOOD CONTROL ENGINEERING MANAGER DATE	MAINTENANCE SUPERINTENDENT	DATE
/	REVIEWED BY Docusigned by:	REVIEWED BY Docusigned by:	11.40 AM D
	Walter Kulalcava 12/20/2023 3:42 PM PST 2745EDA75027485	12/20/2023	11:49 AM P
	FLOOD CONTROL DEPUTY DIRECTOR DATE	ENVIRONMENTAL SERVICES MANAGER	DATE

SANTA BARBARA COUNTY
FLOOD CONTROL AND
WATER CONSERVATION DISTRICT
130 E. VICTORIA STREET
SANTA BARBARA, CA 93101
(805) 568-3440



COLD SPRINGS DEBRIS
BASIN IMPROVEMENT PROJECT
AREA OF MONTECITO
SANTA BARBARA COUNTY, CALIFORNIA

DESIGNED BY: LB	\mathbf{O}	_1	15	6
DRAWN BY:		1	1)	<u> </u>
CHECKED BY:	SHEET	1	OF	26
HBL	Filename: Cold	Springs	DB Plans	s.DWG

		SYMBOL LEGENI)		
CONTROL POINT	A	EX. ROCK		EX. TREE	o
EX. CABLE TV BOX	CTV	EX. SEWER CLEANOUT	0	EX. TREE — EUCALYPTUS	
EX. CABLE TV VAULT	CTV VAULT	EX. SEWER MANHOLE	S	EX. TREE — LEMON	
EX. ELECTRIC BOX	EBOX	EX. SIGNAGE		EX. TREE — PALM	0
EX. ELECTRIC GUY WIRE	-() GWE	EX. STORM DRAIN GRATE		EX. TREE – PINE	0
EX. ELECTRIC MANHOLE	E	EX. STORM DRAIN MANHOLE		EX. TREE — STUMP	
EX. ELECTRIC METER	EM	EX. STRUCTURE BENCH		EX. TREE — SYCAMORE	603
EX. FIRE HYDRANT	*	EX. STRUCTURE BOLLARD/POS	S7 °	EX. TREE — WILLOW	
EX. GAS METER	GM	EX. TELEPHONE BOX	TBOX	EX. TREE – YUCCA	
EX. GAS VALVE	G∨ ⋈	EX. TELEPHONE MANHOLE	\bigcirc	EX. WATER METER	WM
EX. IRRIGATION SPRINKLER	0	EX. TELEPHONE POLE	TP	EX. WATER SPIGOT	- 5 -2
EX. LUMINARY *	-o or *	EX. TELEPHONE VAULT	TELE VAULT	EX. WATER VALVE	₩V
EX. MAILBOX	MB	EX. BUSH/HEDGE		EX. WATER WELL	
EX. MONUMENT	•				
EX. POWER & TELEPHONE PC	DLE P+TP				

BOUNDARY EASEMENT LINE -
Deerver, English Live
BOUNDARY RIGHT OF WAY LINE
BOUNDARY PROPERTY LINE

LINETYPE LEGEND

CENTERLINE	
CONTOUR LINE-MAJOR	10
CONTOUR LINE-MINOR	
EDGE OF PAVEMENT	

____ X ____ X ____ X ___

EX.	BARBED	WIRE	$FE\Lambda$
EX.	BRUSH		

EX. CHAINLINK FENCE

EX.	DRAINAC	E
EX.	STORM	DRAIN


GRADING	LIMIT.
STAGING	ARFA

00000000000
0000000000
0000000000
0000000000
00000000000
0000000000

GROUTED ROCK SLOPE PROTECTION




EXISTING GROUTED RIPRAP

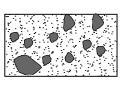

ESM



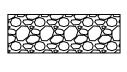

CLASS // AGGREGATE BASE



CLASS V ROCK



GROUTED ROCK STRUCTURE



GROUTED RIPRAP REMOVAL LIMITS

EXISTING UTILITY INFORMATION

ALL UNDERGROUND UTILITIES SHOWN ARE PLOTTED BASED ON INFORMATION PROVIDED BY OTHERS, AND ARE APPROXIMATE. OVERHEAD UTILITIES ARE NOT SHOWN. NOTE THAT INDIVIDUAL SERVICE LATERALS AND CONNECTIONS ARE NOT PLOTTED ON THE PROFILE.

THE SANTA BARBARA COUNTY FLOOD CONTROL DISTRICT IS NOT RESPONSIBLE FOR THE ACCURACY OF THIS INFORMATION. CONTRACTOR SHALL NOTIFY UNDERGROUND SERVICE ALERT A MINIMUM OF TWO WORKING DAYS PRIOR TO COMMENCEMENT OF ANY EXCAVATION @ 1-800-422-4133.

STANDARD DETAILS AND PLANS LIST

STANDARD

NO.

 $//\!\!\!/$

 \wedge

DESCRIPTION

STATE OF CALIFORNIA DEPARTMENT OF TRANSPORTATION STANDARD PLANS (2018) The Standard Plan sheets applicable to this contract include, but are not limited to those indicated below. The Revised Standard Plans (RSP) and New Standard Plans (NSP) which apply are attached to the contract.

A62B LIMITS OF PAYMENT FOR EXCAVATION AND BACKFILL BRIDGE SURCHARGE AND WALL B11-47 CABLE RAILING

ABBREVIATIONS

APNASSESSORS PARCEL NUMBER OGORIGINAL GRADE APWA AMERICAN PUBLIC WORKS ASSOC. R, RT RIGHT BWBOTH WAYS RCPREINFORCED CONCRETE PIPE CFS CUBIC FEET PER SECOND REINFORCEMENT REINF CL or C/L CENTER LINE RW OR RETWALL retaining wall CLRCLEAR SEWER OR SLOPE OR SOUTH CAL TRANS STATE OF CALIFORNIA SDMH STORM DRAIN MANHOLE COUNTYCOUNTY OF SANTA BARBARA STA STA TION CONTROL POINT T.R. THREADED ROD EAST OR EASTING TW or tw TOP OF WALL EG EXISTING GROUND ELEVATION TCE TEMPORARY CONSTRUCTION EL ELE VA TION EASEMENT ESM ENGINEERED STREAMBED MATERIAL T&B TOP AND BOTTOM FG, F.G. FINISHED GRADE TBM TEMPORARY BENCH MARK FT FEET TYPICAL TYP GAS LINE WF WALL FACE GBGRADE BREAK


HDPE HIGH DENSITY POLYETHYLENE *INCH* LEFT L, LT L OL LA YOUT LINE L WD LARGE WOODY DEBRIS MAXMAXIMUM MJ MECHANICAL JOINT M/NMINIMUM MON MONUMENT

NORTH OR NORTHING



UNAUTHORIZED CHANGES OR USES: THE SANTA BARBARA COUNTY FLOOD CONTROL & WATER CONSERVATION DISTRICT AND ITS EMPLOYEES WILL NOT BE RESPONSIBLE FOR, OR LIABLE FOR, UNAUTHORIZED CHANGES TO OR USES OF THESE PLANS. ALL PROPOSED CHANGES TO THE PLANS MUST BE PRESENTED IN WRITING TO THE DISTRICT AND APPROVED IN WRITING BY THE DISTRICT PRIOR TO IMPLEMENTATION OF ANY SUCH CHANGE OR USE.

	REVISIONS			PROFESS/ONA	DESIGNED BY: Suntu 11/03/2023	
NO	DESCRIPTION	DATE	APR	EX SLEY BROOKS	WRECO DATE	
				No. C88686 75 No. C88686		V
				Exp. 03/31/24		
				ST CIVIL ONIA		
				OF CALIFOR		

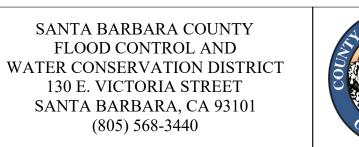

COLD SPRINGS DEBRIS BASIN IMPROVEMENT PROJECT


AREA OF MONTECITO SANTA BARBARA COUNTY, CALIFORNIA


GENERAL **INFORMATION**

DESIGNED BY:	
LB	
DRAWN BY:	
MD	
CHECKED BY:	SHFFT

0-1156 2 OF 26 CHECKED BY:

Filename: Cold Springs DB Plans.DWG

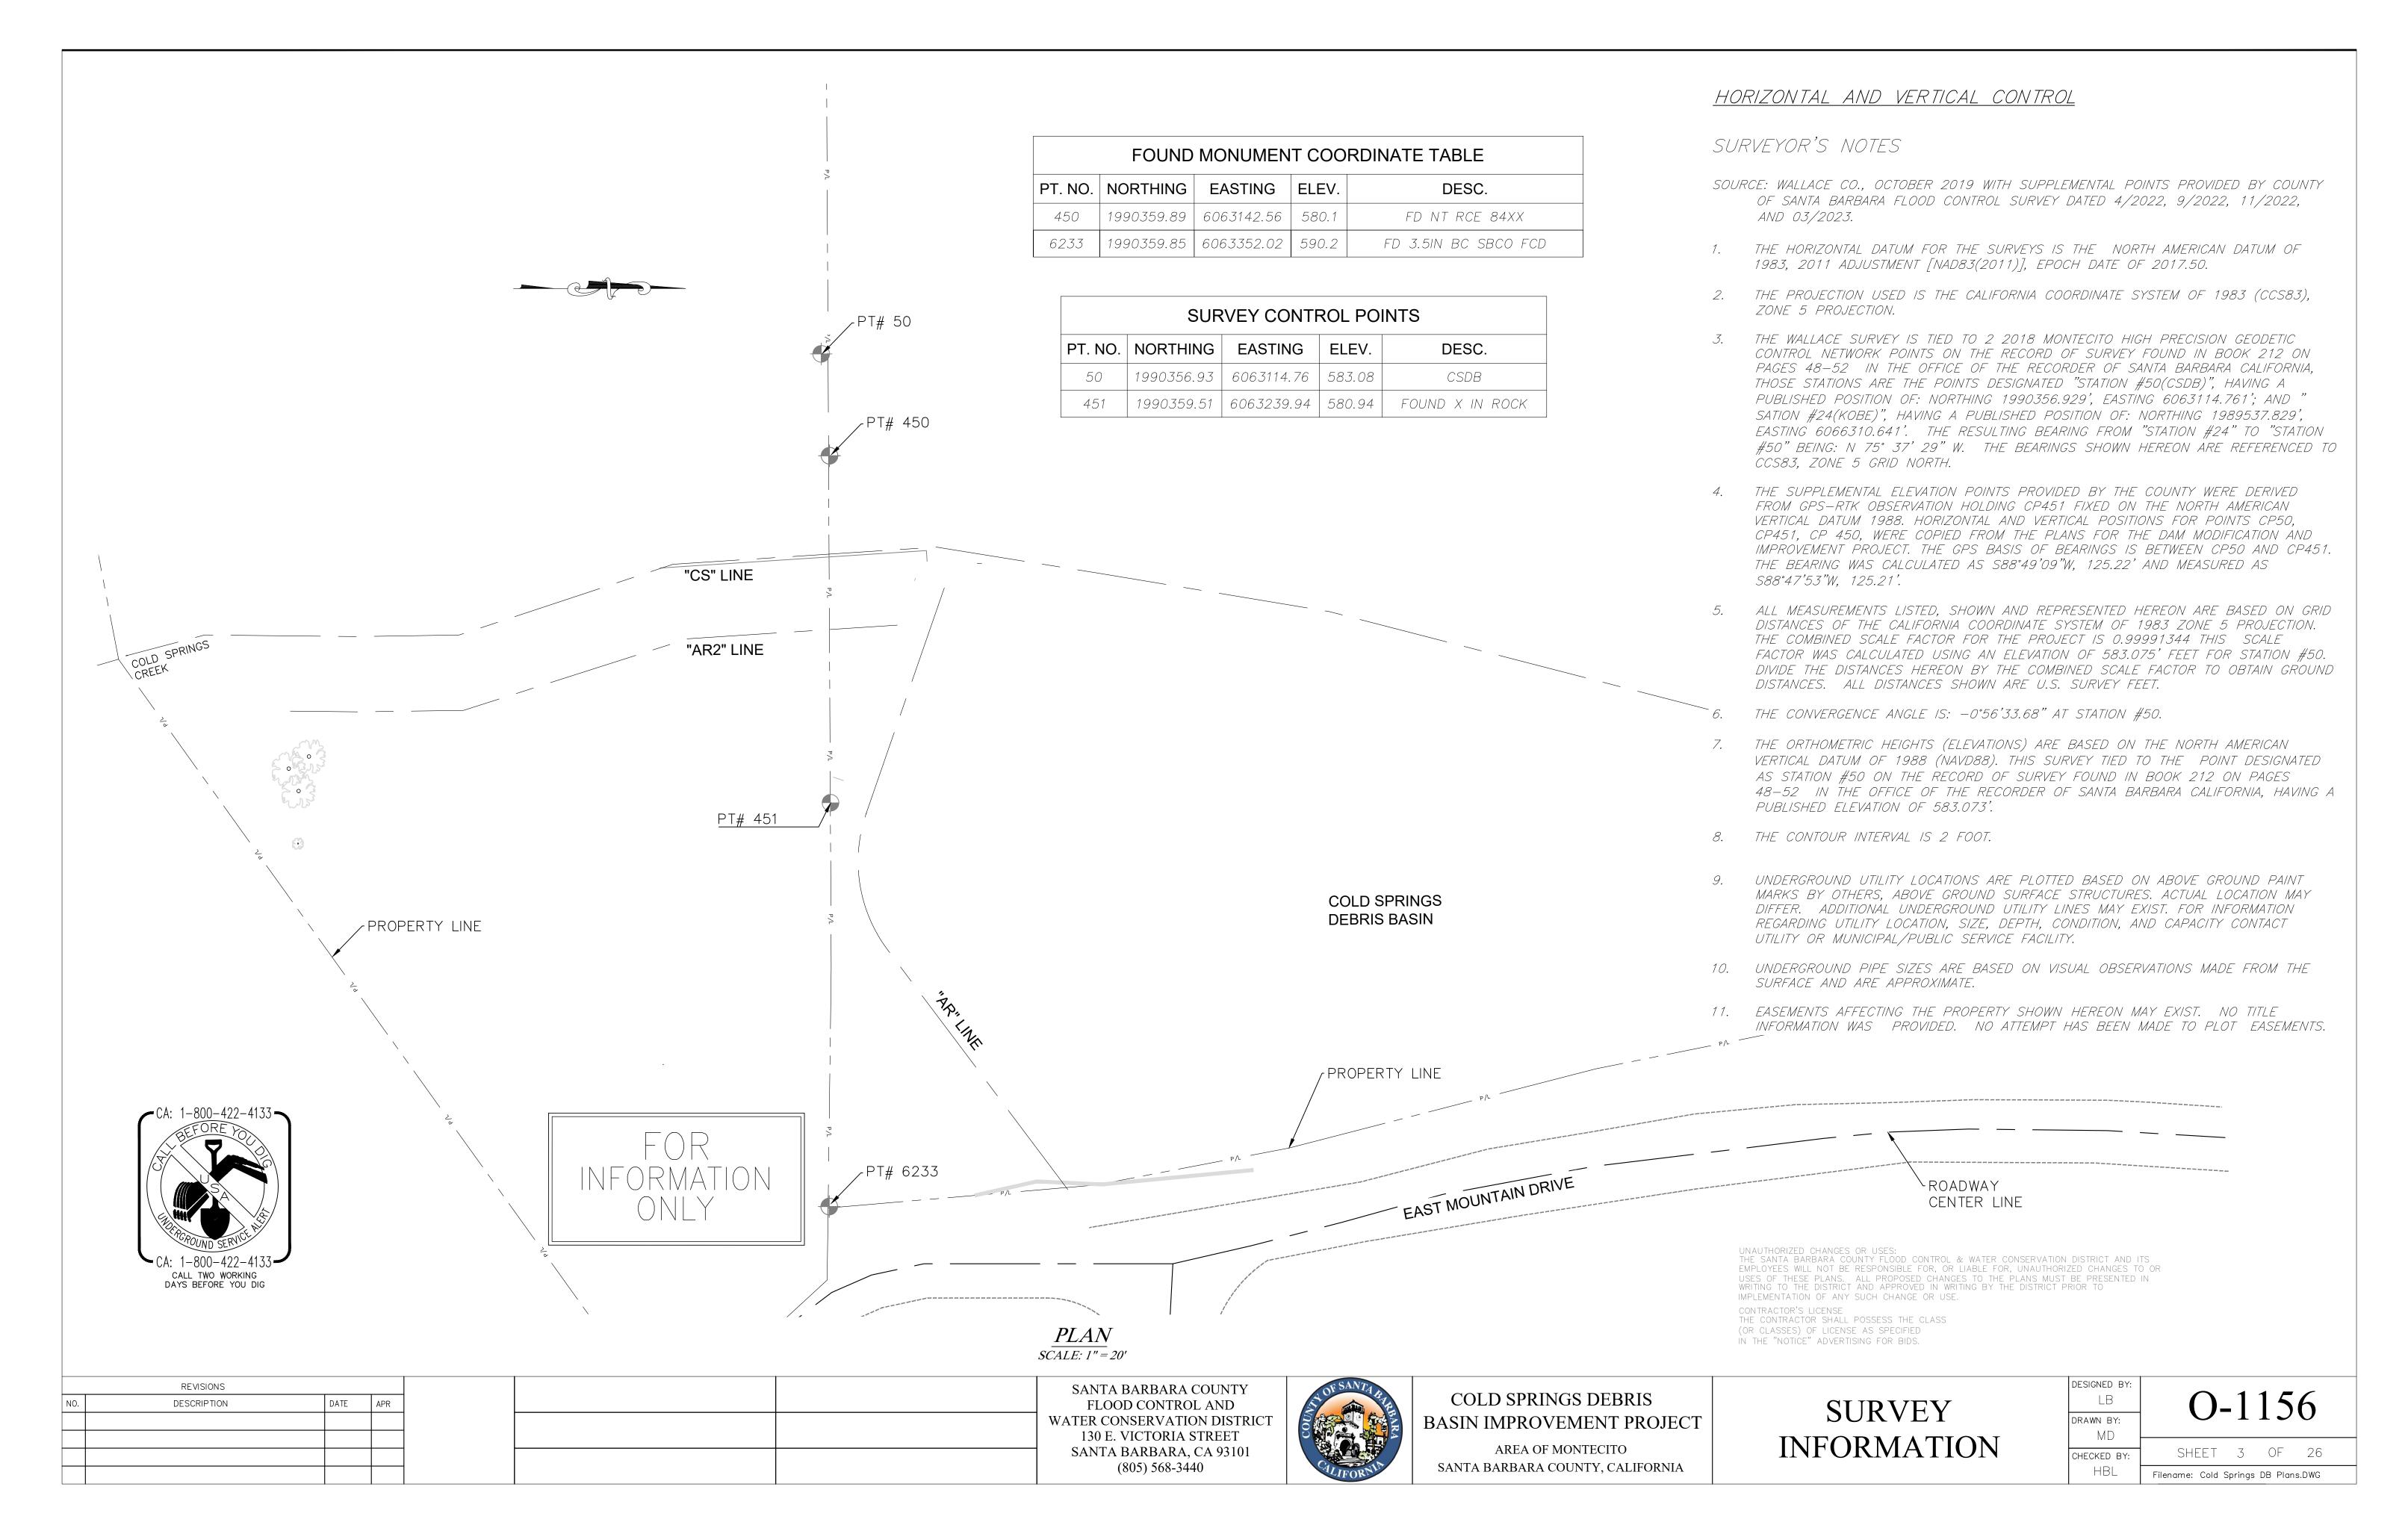

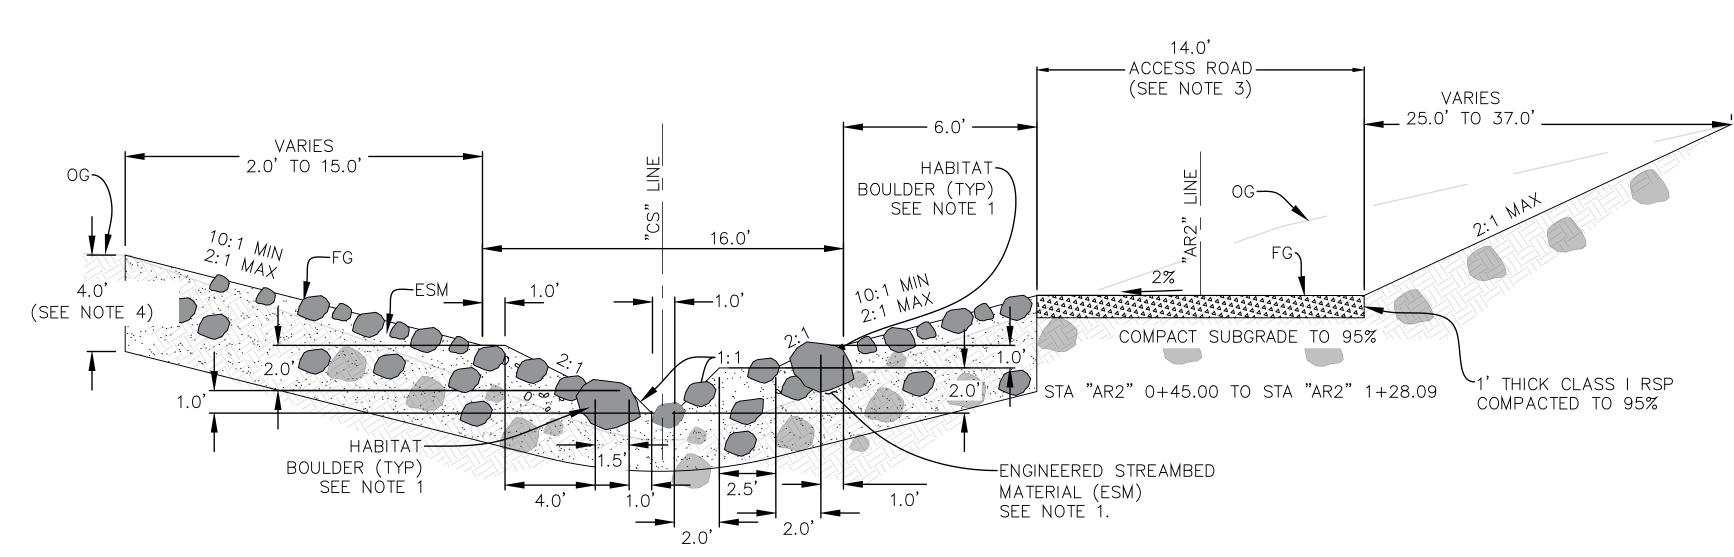

STA "CS" 0+21.78 TO STA "CS" 1+23.00

NOTES


- 1. SEE SHEET 15 FOR ADDITIONAL INFORMATION ON HABITAT BOULDERS AND ESM SIZING AND PLACEMENT. HABITAT BOULDERS INCLUDED IN ESM TOTALS.
- 2. WHERE BEDROCK ELEVATION IS LESS THAN 7' DEEP FROM FG ELEVATION, GROUTED ROCK CUTOFF WALL TO BE TRENCHED 2—FEET DEEP INTO BEDROCK AND GROUTED INTO BEDROCK.
- 3. ACCESS ROAD (AR2 LINE) ALONG CHANNEL TO CONSIST OF 1' THICK CLASS 1 RSP WITH 95% COMPACTION. GROUTED ROCK SECTION THICKNESS TO BE REDUCED TO ALLOW FOR ACCESS ROAD, WHERE APPLICABLE. OTHERWISE, ACCESS ROAD TO FOLLOW TYPICAL SECTION E SHEET 5.
- 4. ESM DEPTH FOR SECTION A ESTIMATED AS 4'. ACTUAL ESM DEPTH WILL BE THE DIFFERENCE BETWEEN THE OG AND FG ELEVATIONS AND WILL VARY. ROUGHEN EXISTING STREAMBED MATERIAL TO A 2 FEET MINIMUM TO BIND ESM TO SURFACE IN AREAS WHERE EXISTING STREAMBED MATERIAL DOES NOT INCLUDE BOULDERS WITH A MINIMUM DIAMETER OF 2.5 FEET.

NOMINAL RSP CLASS BY MEDIAN PARTICLE DIAMETER

<u>CLASS</u>	SIZE (INCHES)
CLASS I	6
CLASS III	12
CLASS V	18

VARIES 6.5' TO 14'

A CHANNEL TYPICAL SECTION (DOWNSTREAM OF THE WALL) NOT TO SCALE

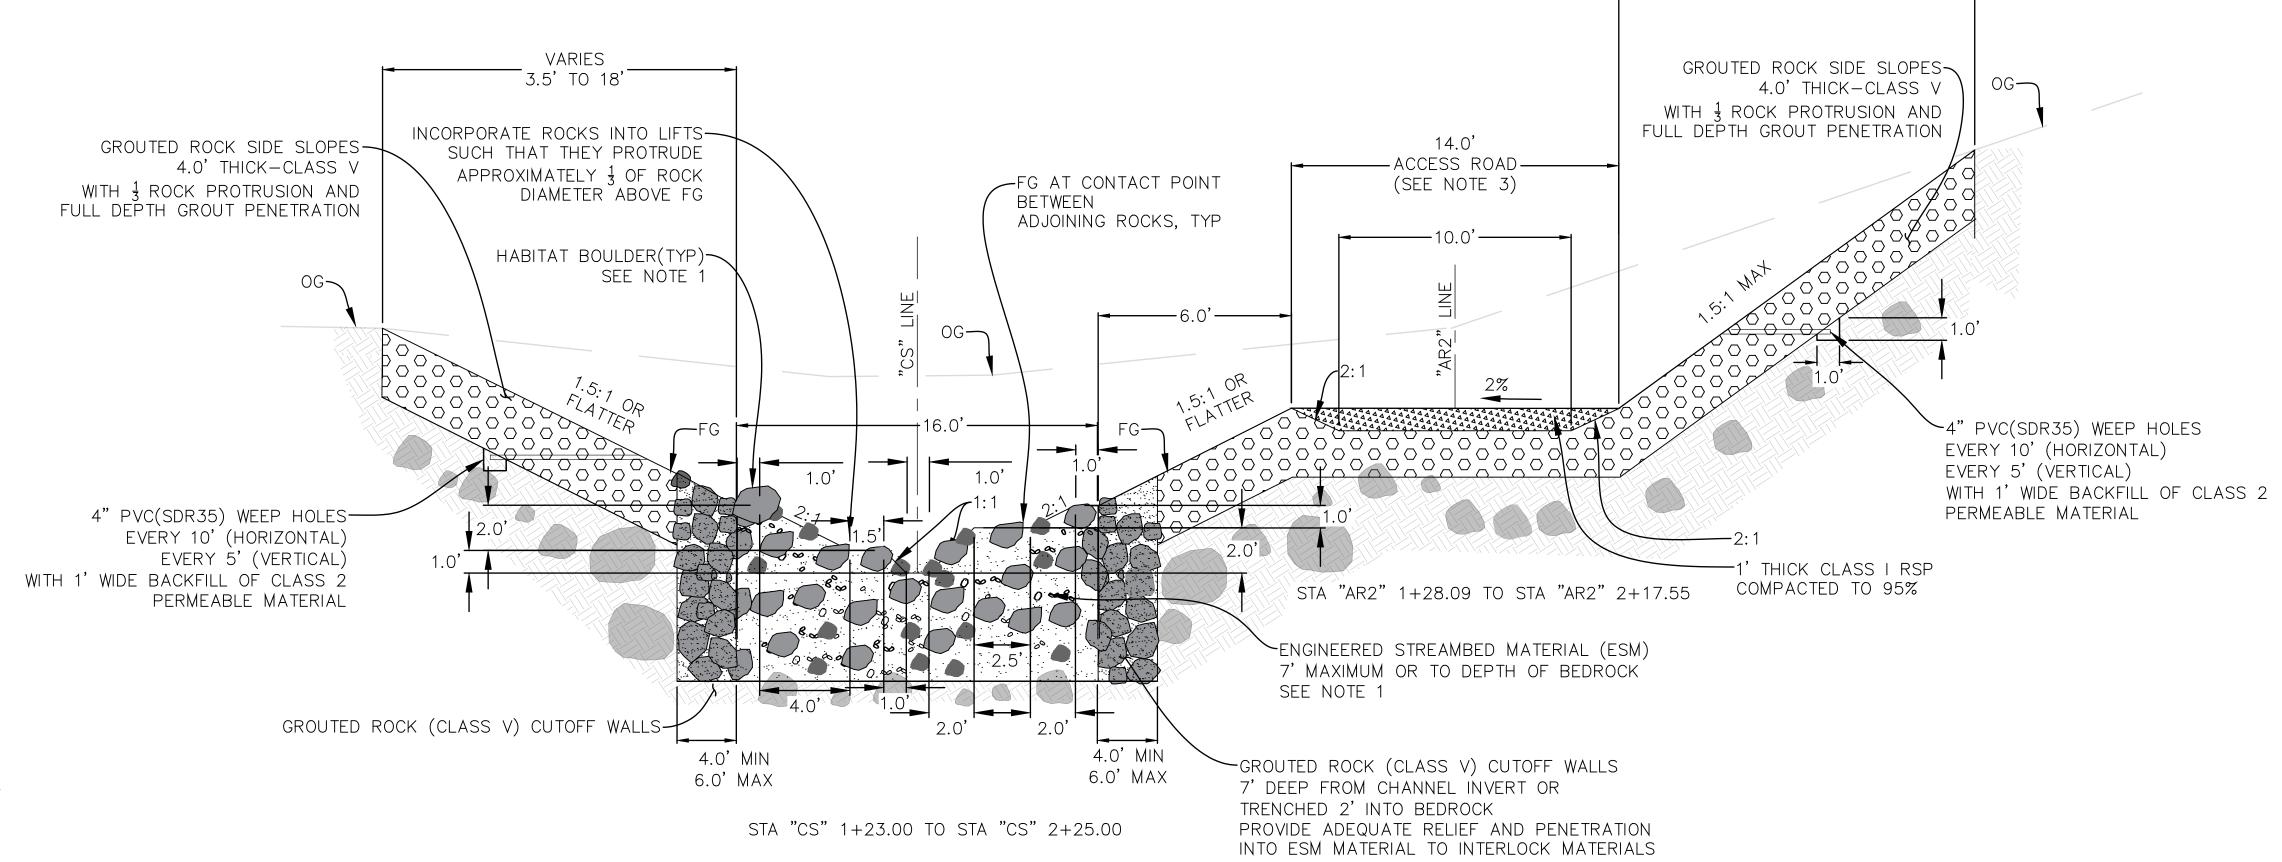

ALL UNDERGROUND UTILITIES SHOWN ARE PLOTTED BASED ON INFORMATION PROVIDED BY OTHERS, AND ARE APPROXIMATE. OVERHEAD UTILITIES ARE NOT SHOWN. THE SANTA BARBARA COUNTY FLOOD CONTROL DISTRICT IS NOT RESPONSIBLE FOR THE ACCURACY OF THIS INFORMATION. CONTRACTOR SHALL NOTIFY UNDERGROUND SERVICE ALERT A MINIMUM OF TWO WORKING DAYS PRIOR TO COMMENCEMENT OF ANY EXCAVATION @ 1-800-422-4133.

UNAUTHORIZED CHANGES OR USES:

THE SANTA BARBARA COUNTY FLOOD CONTROL & WATER CONSERVATION DISTRICT AND ITS EMPLOYEES WILL NOT BE RESPONSIBLE FOR, OR LIABLE FOR, UNAUTHORIZED CHANGES TO OR USES OF THESE PLANS. ALL PROPOSED CHANGES TO THE PLANS MUST BE PRESENTED IN WRITING TO THE DISTRICT AND APPROVED IN WRITING BY THE DISTRICT PRIOR TO IMPLEMENTATION OF ANY SUCH CHANGE OR USE.

B CHANNEL TYPICAL SECTION (DOWNSTREAM OF THE WALL) NOT TO SCALE

	REVISIONS			PROFESSIONAL DES	SIGNED BY: Sunla 11/03/202	7	
NO.	DESCRIPTION	DATE	APR	WRE			
				No. C88686			W
				Exp. 03/31/24			
				SAN CIVIL ONIA			
				OF CALIFOR			

SANTA BARBARA COUNTY
FLOOD CONTROL AND
WATER CONSERVATION DISTRICT
130 E. VICTORIA STREET
SANTA BARBARA, CA 93101
(805) 568-3440



COLD SPRINGS DEBRIS BASIN IMPROVEMENT PROJECT

AREA OF MONTECITO SANTA BARBARA COUNTY, CALIFORNIA


	DESIGNED B
	LB
1	DRAWN BY:
1	MD
	CHECKED B,

CA DAY	ALL TW	ORE Y	RKING OU D	ilG
O-	1	13	56	5


CA: 1-800-422-4133

SHEET 4 OF 26

Filename: Cold Springs DB Plans.DWG

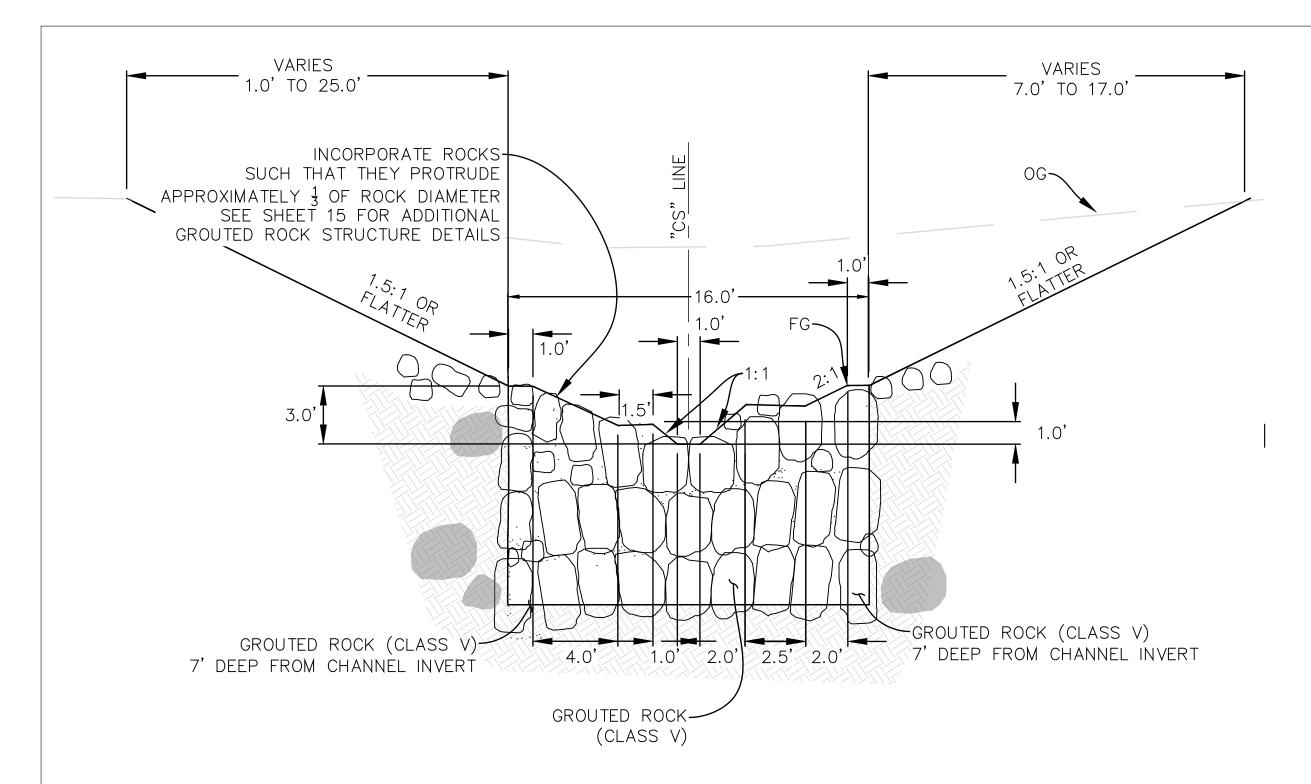

A ROCK STRUCTURE EMBEDMENT TYPICAL SECTION 5 NOT TO SCALE (SCENARIO 1 - NO BED ROCK ENCOUNTERED)

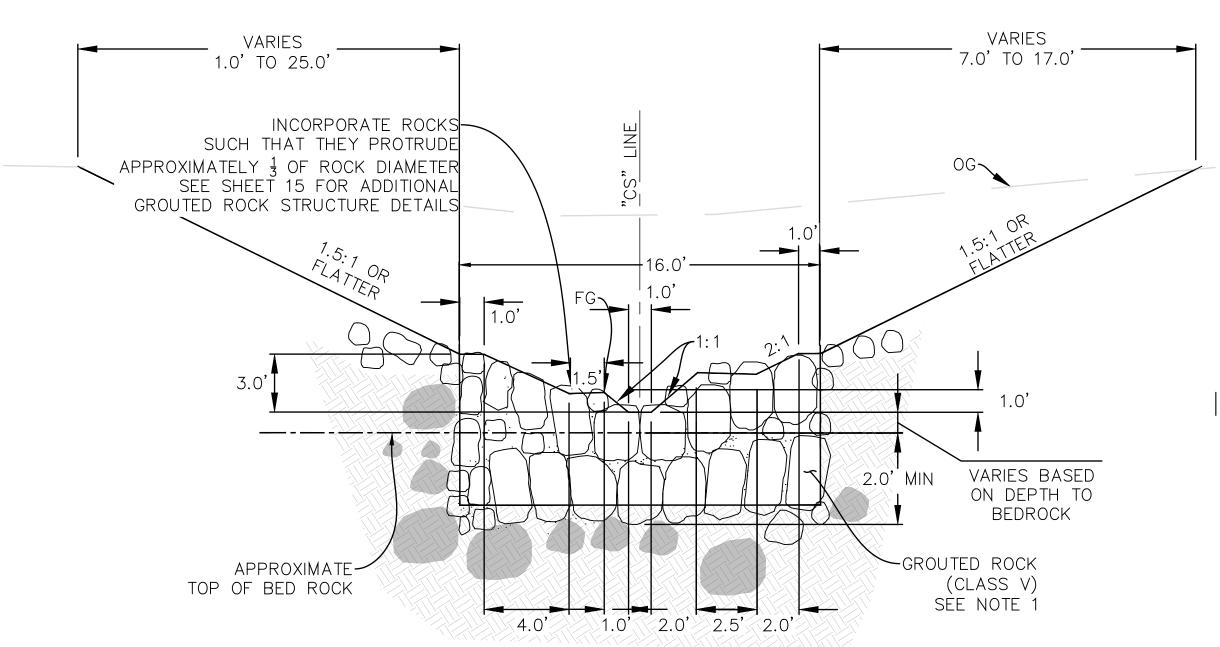

B ROCK STRUCTURE EMBEDMENT TYPICAL SECTION 5 NOT TO SCALE (SCENARIO 2 - BED ROCK ENCOUNTERED)

UNAUTHORIZED CHANGES OR USES:
THE SANTA BARBARA COUNTY FLOOD CONTROL & WATER CONSERVATION DISTRICT
AND ITS EMPLOYEES WILL NOT BE RESPONSIBLE FOR, OR LIABLE FOR, UNAUTHORIZED
CHANGES TO OR USES OF THESE PLANS. ALL PROPOSED CHANGES TO THE PLANS
MUST BE PRESENTED IN WRITING TO THE DISTRICT AND APPROVED IN WRITING BY THE

DATE APR

Exp. 03/31/24

DISTRICT PRIOR TO IMPLEMENTATION OF ANY SUCH CHANGE OR USE.

REVISIONS

DESCRIPTION

ALL UNDERGROUND UTILITIES SHOWN ARE PLOTTED BASED ON INFORMATION PROVIDED BY OTHERS, AND ARE APPROXIMATE. OVERHEAD UTILITIES ARE NOT SHOWN. THE SANTA BARBARA COUNTY FLOOD CONTROL DISTRICT IS NOT RESPONSIBLE FOR THE ACCURACY OF THIS INFORMATION. CONTRACTOR SHALL NOTIFY UNDERGROUND SERVICE ALERT A MINIMUM OF TWO WORKING DAYS PRIOR TO COMMENCEMENT OF ANY EXCAVATION @ 1-800-422-4133.

SANTA BARBARA COUNTY
FLOOD CONTROL AND
WATER CONSERVATION DISTRICT
130 E. VICTORIA STREET

ON SANTARADO ON SA

SANTA BARBARA, CA 93101

(805) 568-3440

COLD SPRINGS DEBRIS BASIN IMPROVEMENT PROJECT

AREA OF MONTECITO
SANTA BARBARA COUNTY, CALIFORNIA

TYPICAL SECTIONS 2

	DESIGNED BY:
	LB
\mathbf{A}	DRAWN BY:
2	MD
	CHECKED BY:

O-1156

SHEET 5 OF 26


Filename: Cold Springs DB Plans.DWG

CALL TWO WORKING DAYS BEFORE YOU DIG


CA: 1-800-422-4133

NOTES


- 1. WHERE ROCK STRUCTURES ENCOUNTER BEDROCK BEFORE A 7' DEPTH IS ACHIEVED, BEDROCK WILL BE TRENCHED TO A DEPTH OF 2 FEET AND THE ROCK STRUCTURE WILL BE GROUTED INTO THE BEDROCK TRENCH.
- 2. EXPOSED GRADED STREAMBED MATERIAL WITHIN THE PILOT CHANNEL TO CONFORM TO ESM GRADATIONS PROVIDED IN SHEET 15. BOULDER SIZES OF D84 AND LARGER TO REMAIN PROTRUDING FROM THE PILOT CHANNEL FG, WHERE ENCOUNTERED. FINAL ROUGHNESS OF EXPOSED PILOT CHANNEL MATERIAL TO BE REVIEWED AND APPROVED BY FIELD ENGINEER.

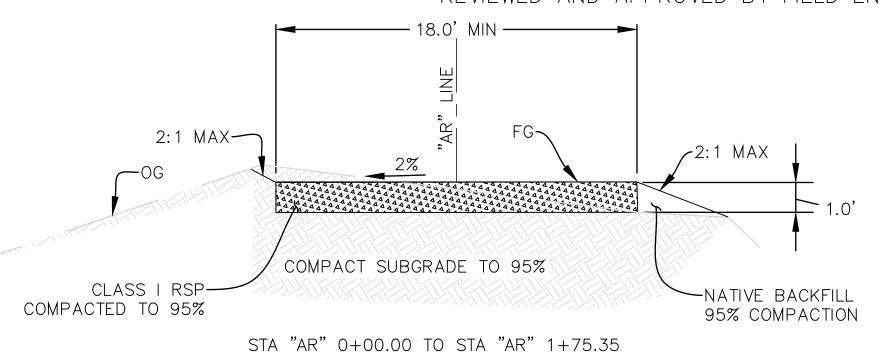




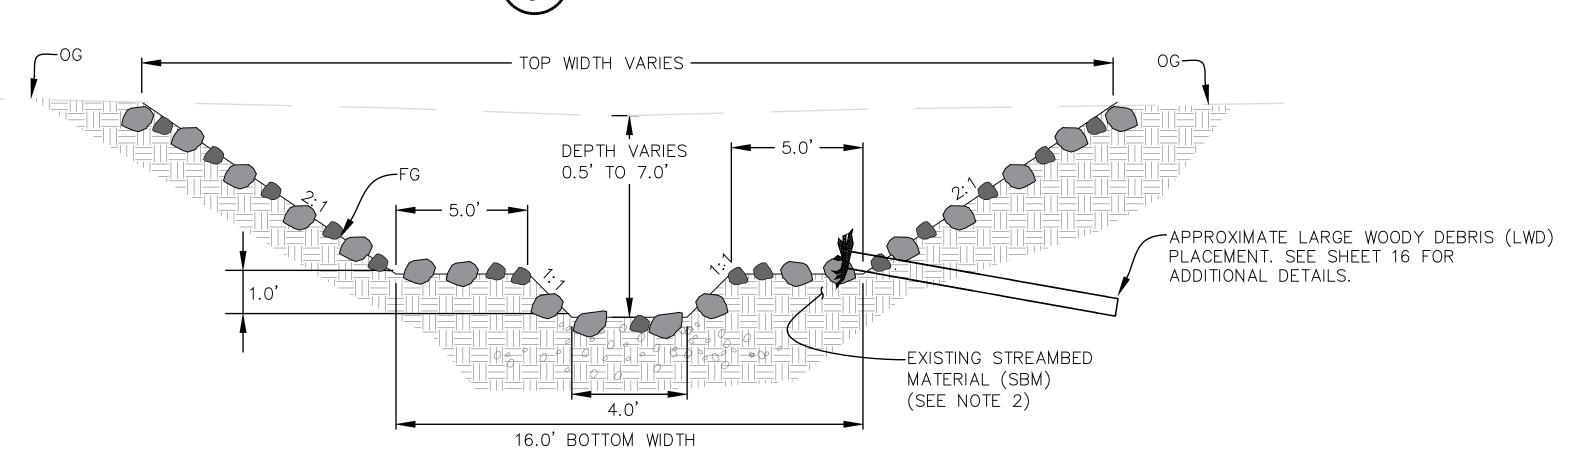

STA "CS" 2+40.00 TO STA "CS" 5+06.51

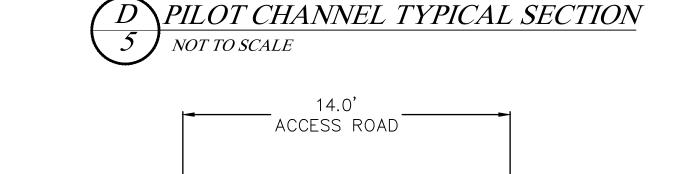


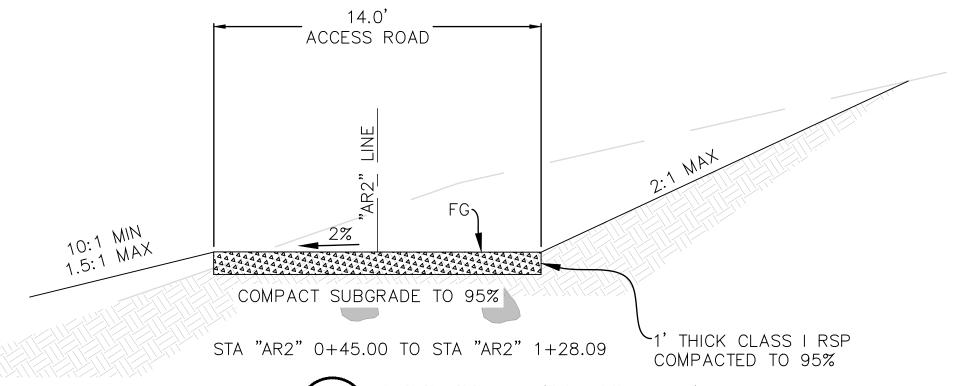



"CS" ALIGNMENT										
SEGMENT ID	START STATION	END STATION	RADIUS	DELTA	DIRECTION					
L1	0+00.00	1990163.02	6063198.96	22.75	0+22.75			N14° 47′ 40″W		
L2	0+22.75	1990185.01	6063193.16	42.22	0+64.96			N0° 36′ 47″E		
L3	0+64.96	1990227.22	6063193.61	28.71	0+93.67			N0° 51′ 31″W		
L4	0+93.67	1990255.93	6063193.18	62.86	1+56.53			N18° 18′ 04″W		
L5	1+56.53	1990315.61	6063173.44	73.66	2+30.18			N3° 43′ 29″W		
L6	2+30.18	1990389.11	6063168.65	44.89	2+75.07			N9° 09' 02"E		
L7	2+75.07	1990433.42	6063175.79	66.06	3+41.13			N9° 26′ 31″E		
L8	3+41.13	1990498.59	6063186.63	183.87	5+25.00			N14° 28' 07"E		

	"AR2" ALIGNMENT											
SEGMENT ID	START STATION	NORTHING	EASTING	LENGTH	END STATION	RADIUS	DELTA	DIRECTION				
L9	0+45.00	1990208.83	6063214.41	18.50	0+63.50			N0° 35′ 40″E				
L10	0+63.50	1990227.33	6063214.60	29.79	0+93.29			N0° 45′ 46″W				
L11	0+93.29	1990257.12	6063214.21	65.75	1+59.04			N17° 42′ 06″W				
L12	1+59.04	1990319.76	6063194.21	58.51	2+17.55			N3° 42' 51"W				

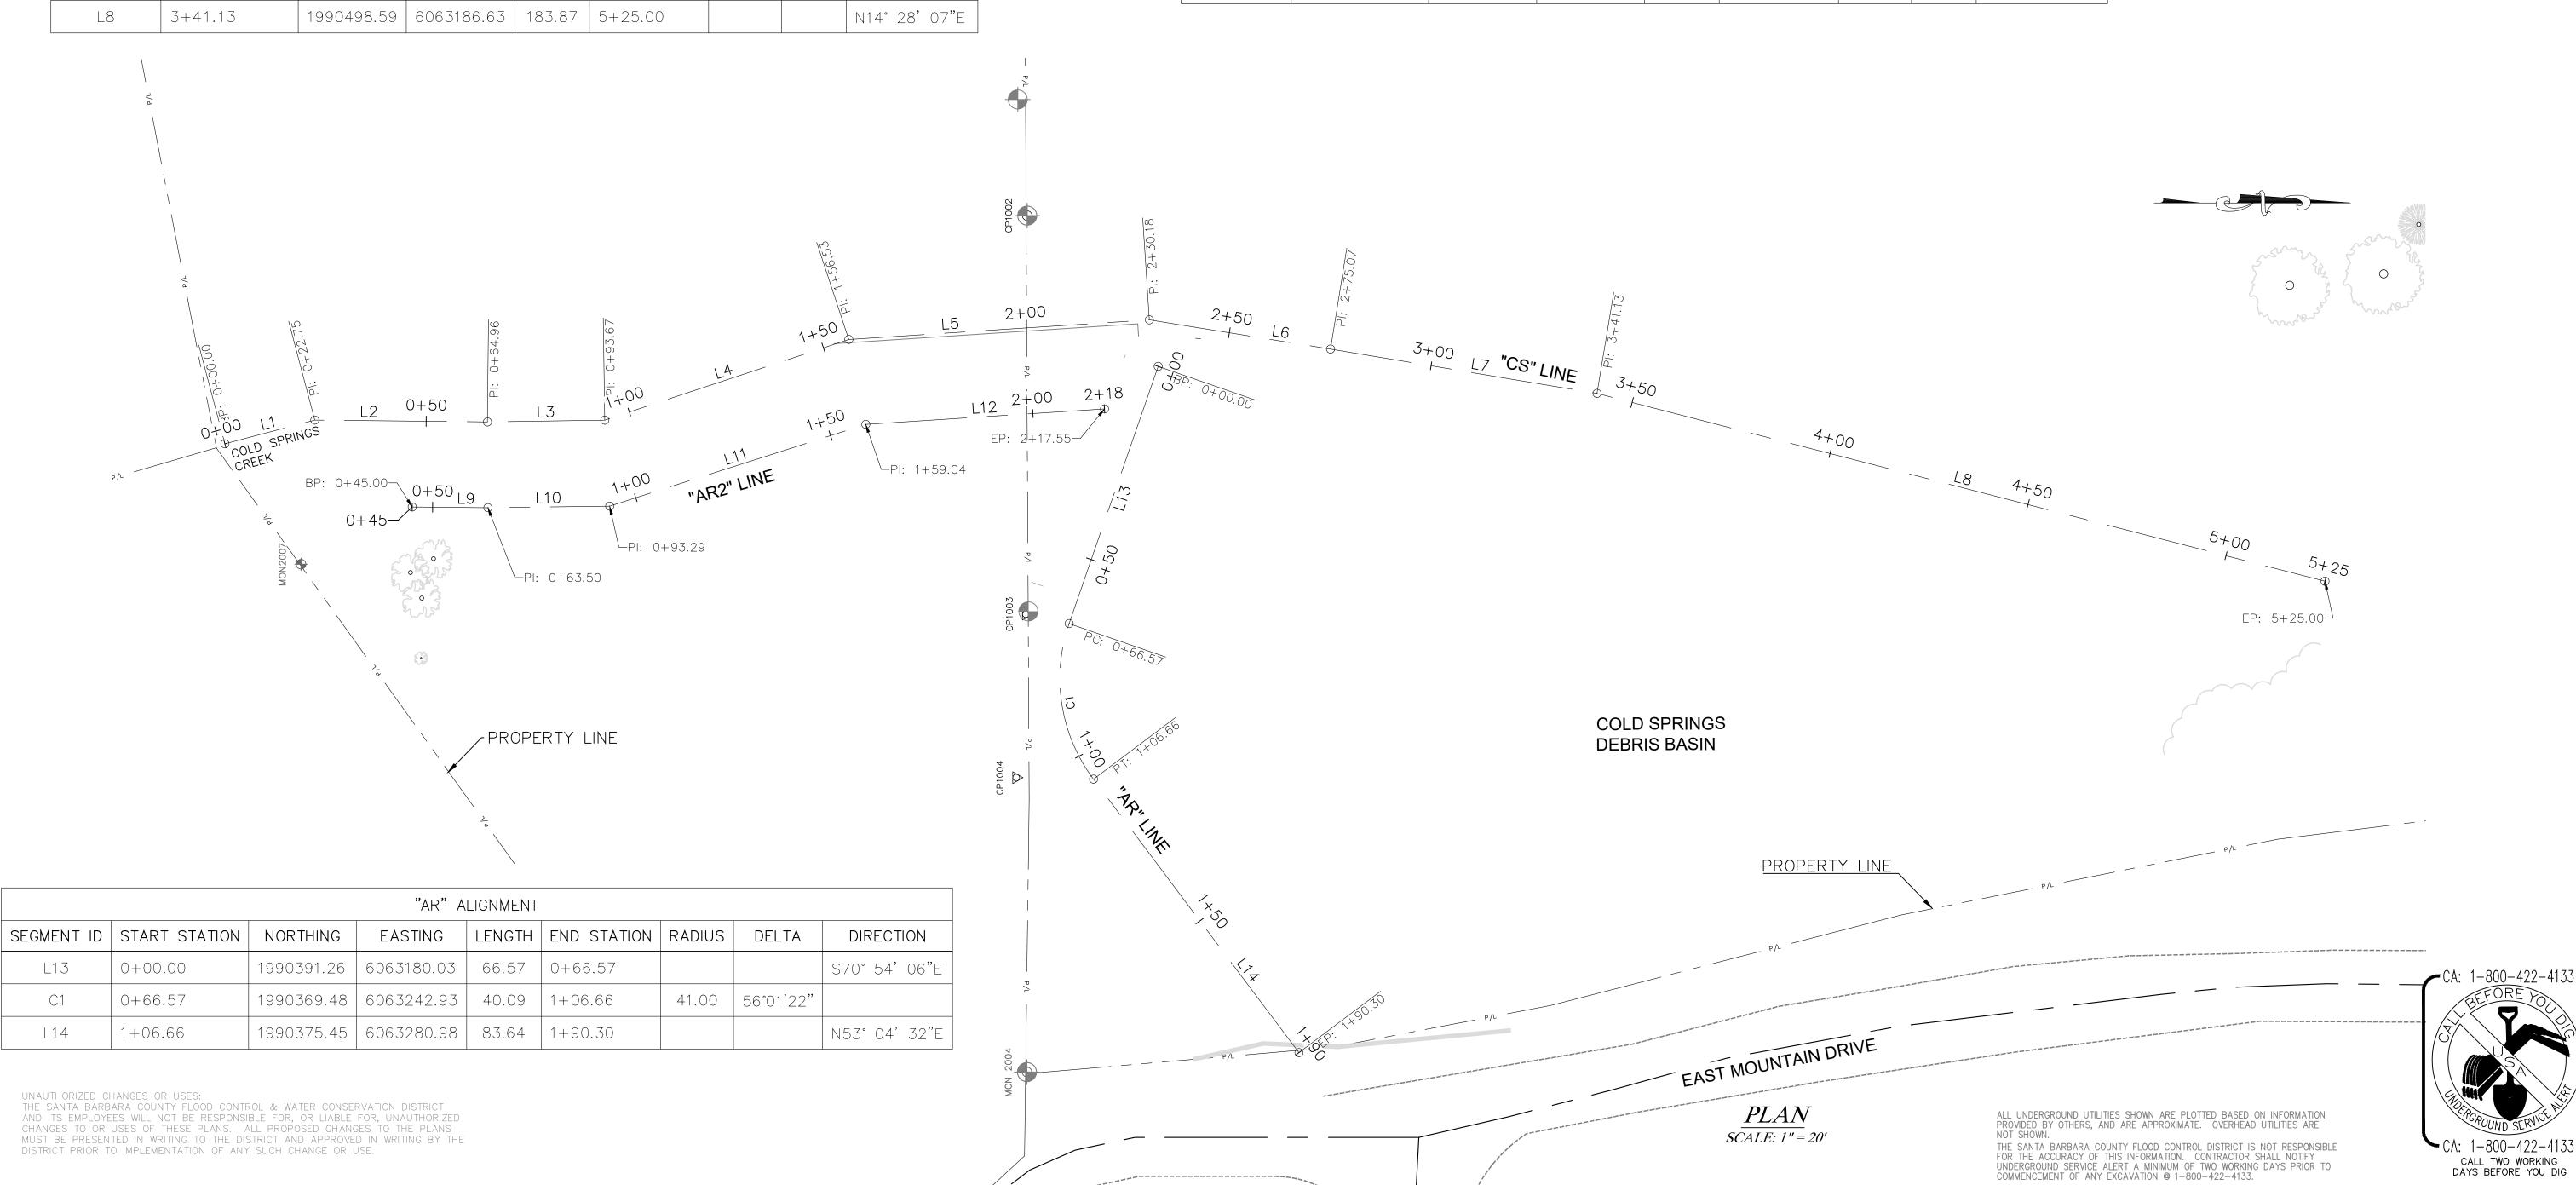

UNAUTHORIZED CHANGES OR USES: THE SANTA BARBARA COUNTY FLOOD CONTROL & WATER CONSERVATION DISTRICT AND ITS EMPLOYEES WILL NOT BE RESPONSIBLE FOR, OR LIABLE FOR, UNAUTHORIZED CHANGES TO OR USES OF THESE PLANS. ALL PROPOSED CHANGES TO THE PLANS MUST BE PRESENTED IN WRITING TO THE DISTRICT AND APPROVED IN WRITING BY THE

REVISIONS DESCRIPTION Exp. 03/31/24

SANTA BARBARA COUNTY FLOOD CONTROL AND WATER CONSERVATION DISTRICT 130 E. VICTORIA STREET SANTA BARBARA, CA 93101 (805) 568-3440




COLD SPRINGS DEBRIS BASIN IMPROVEMENT PROJECT


AREA OF MONTECITO SANTA BARBARA COUNTY, CALIFORNIA KEYLINE GEOMETR


	DESIGNED B'
	LB
Y	DRAWN BY:
	CHECKED BY


O-1156


SHEET 6 OF 26 Filename: Cold Springs DB Plans.DWG

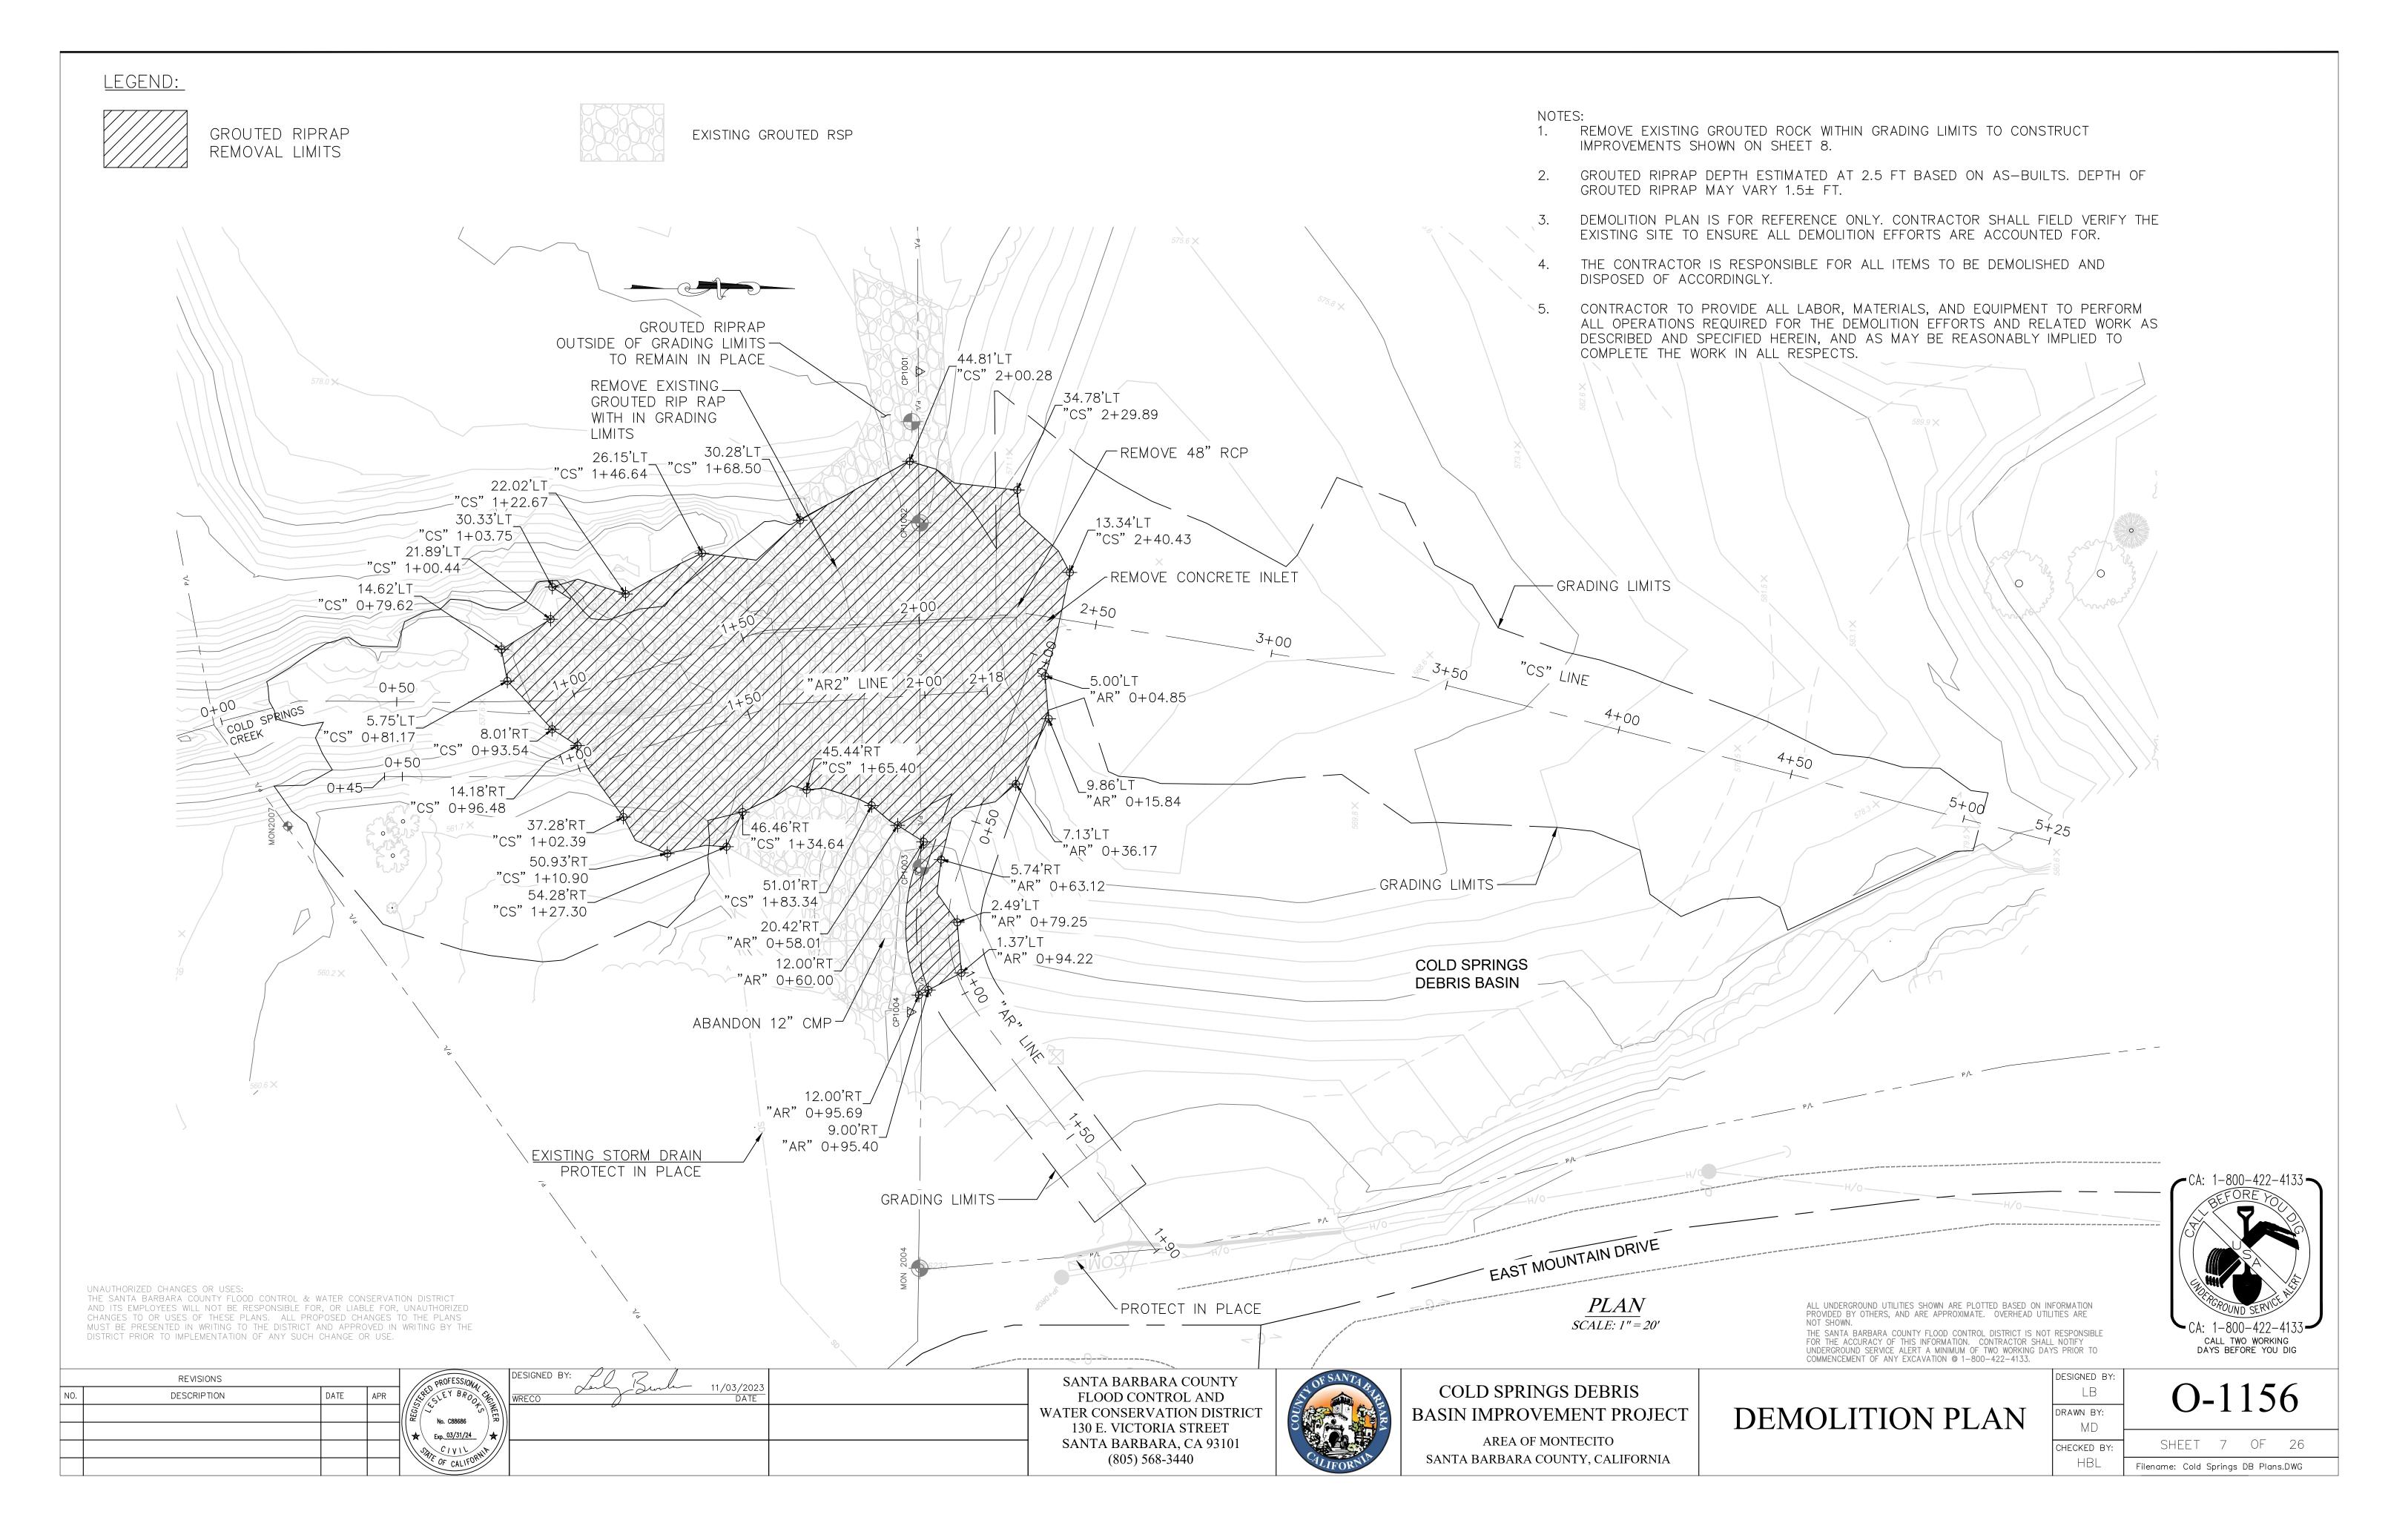

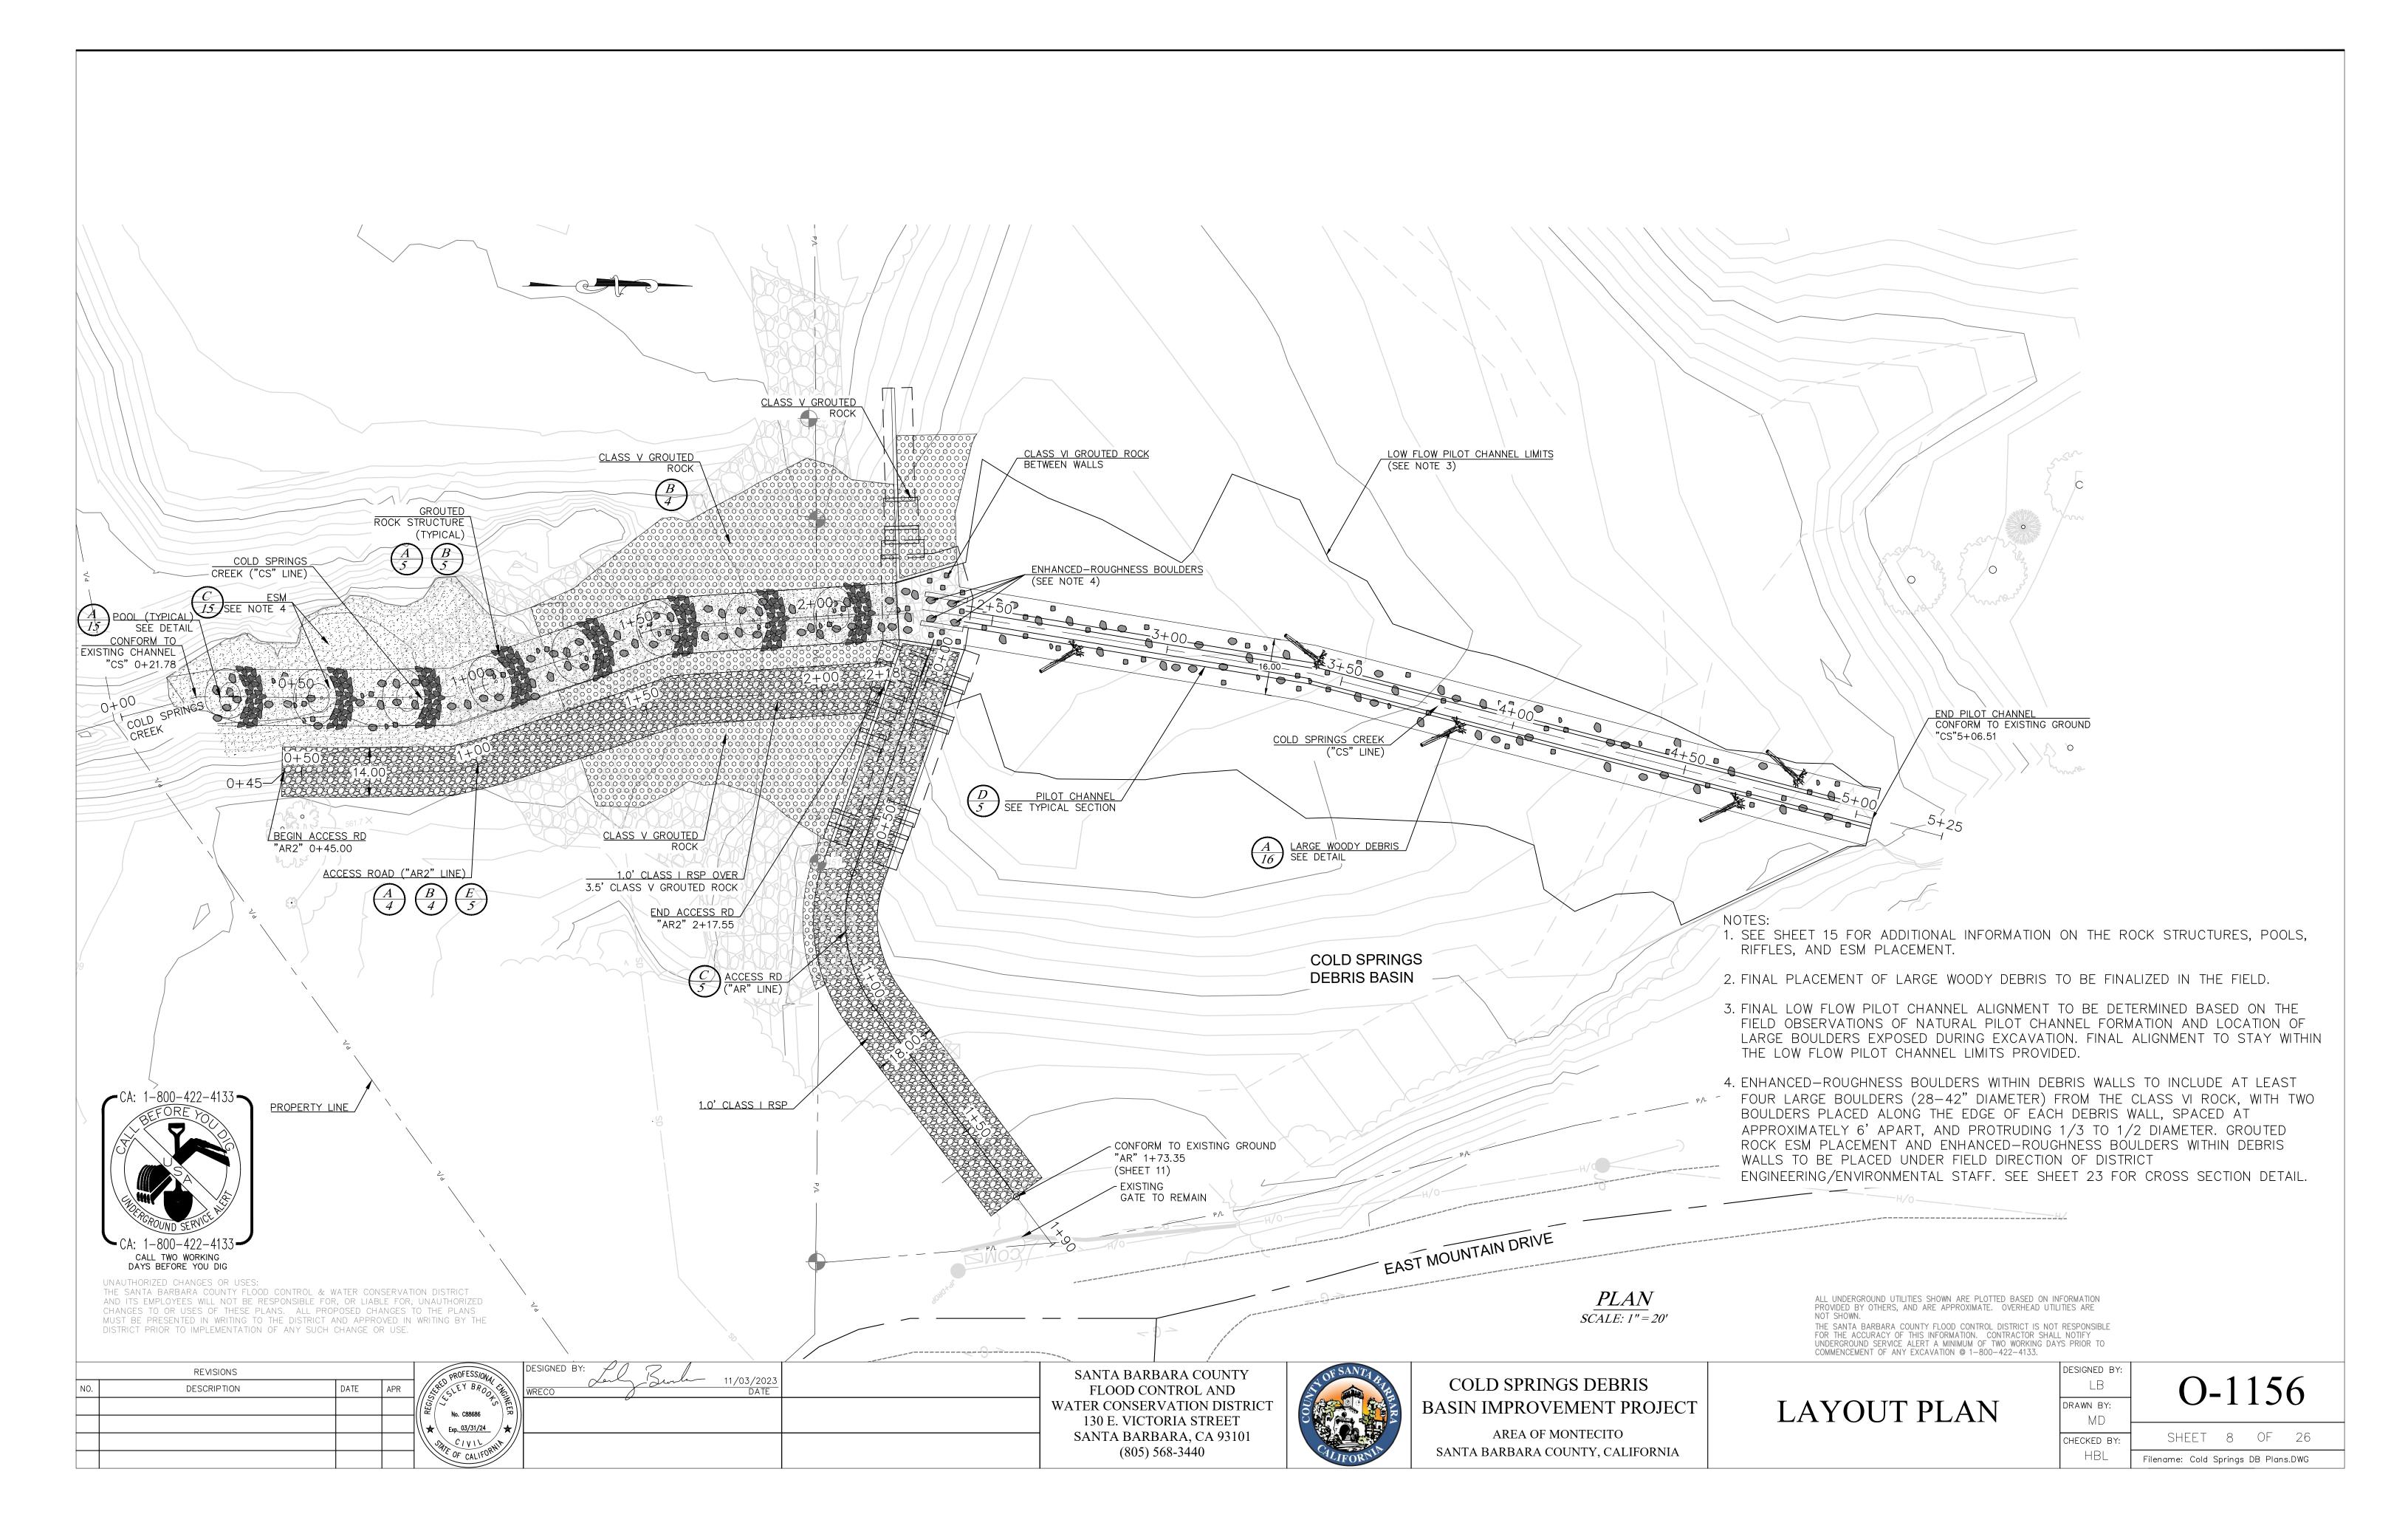

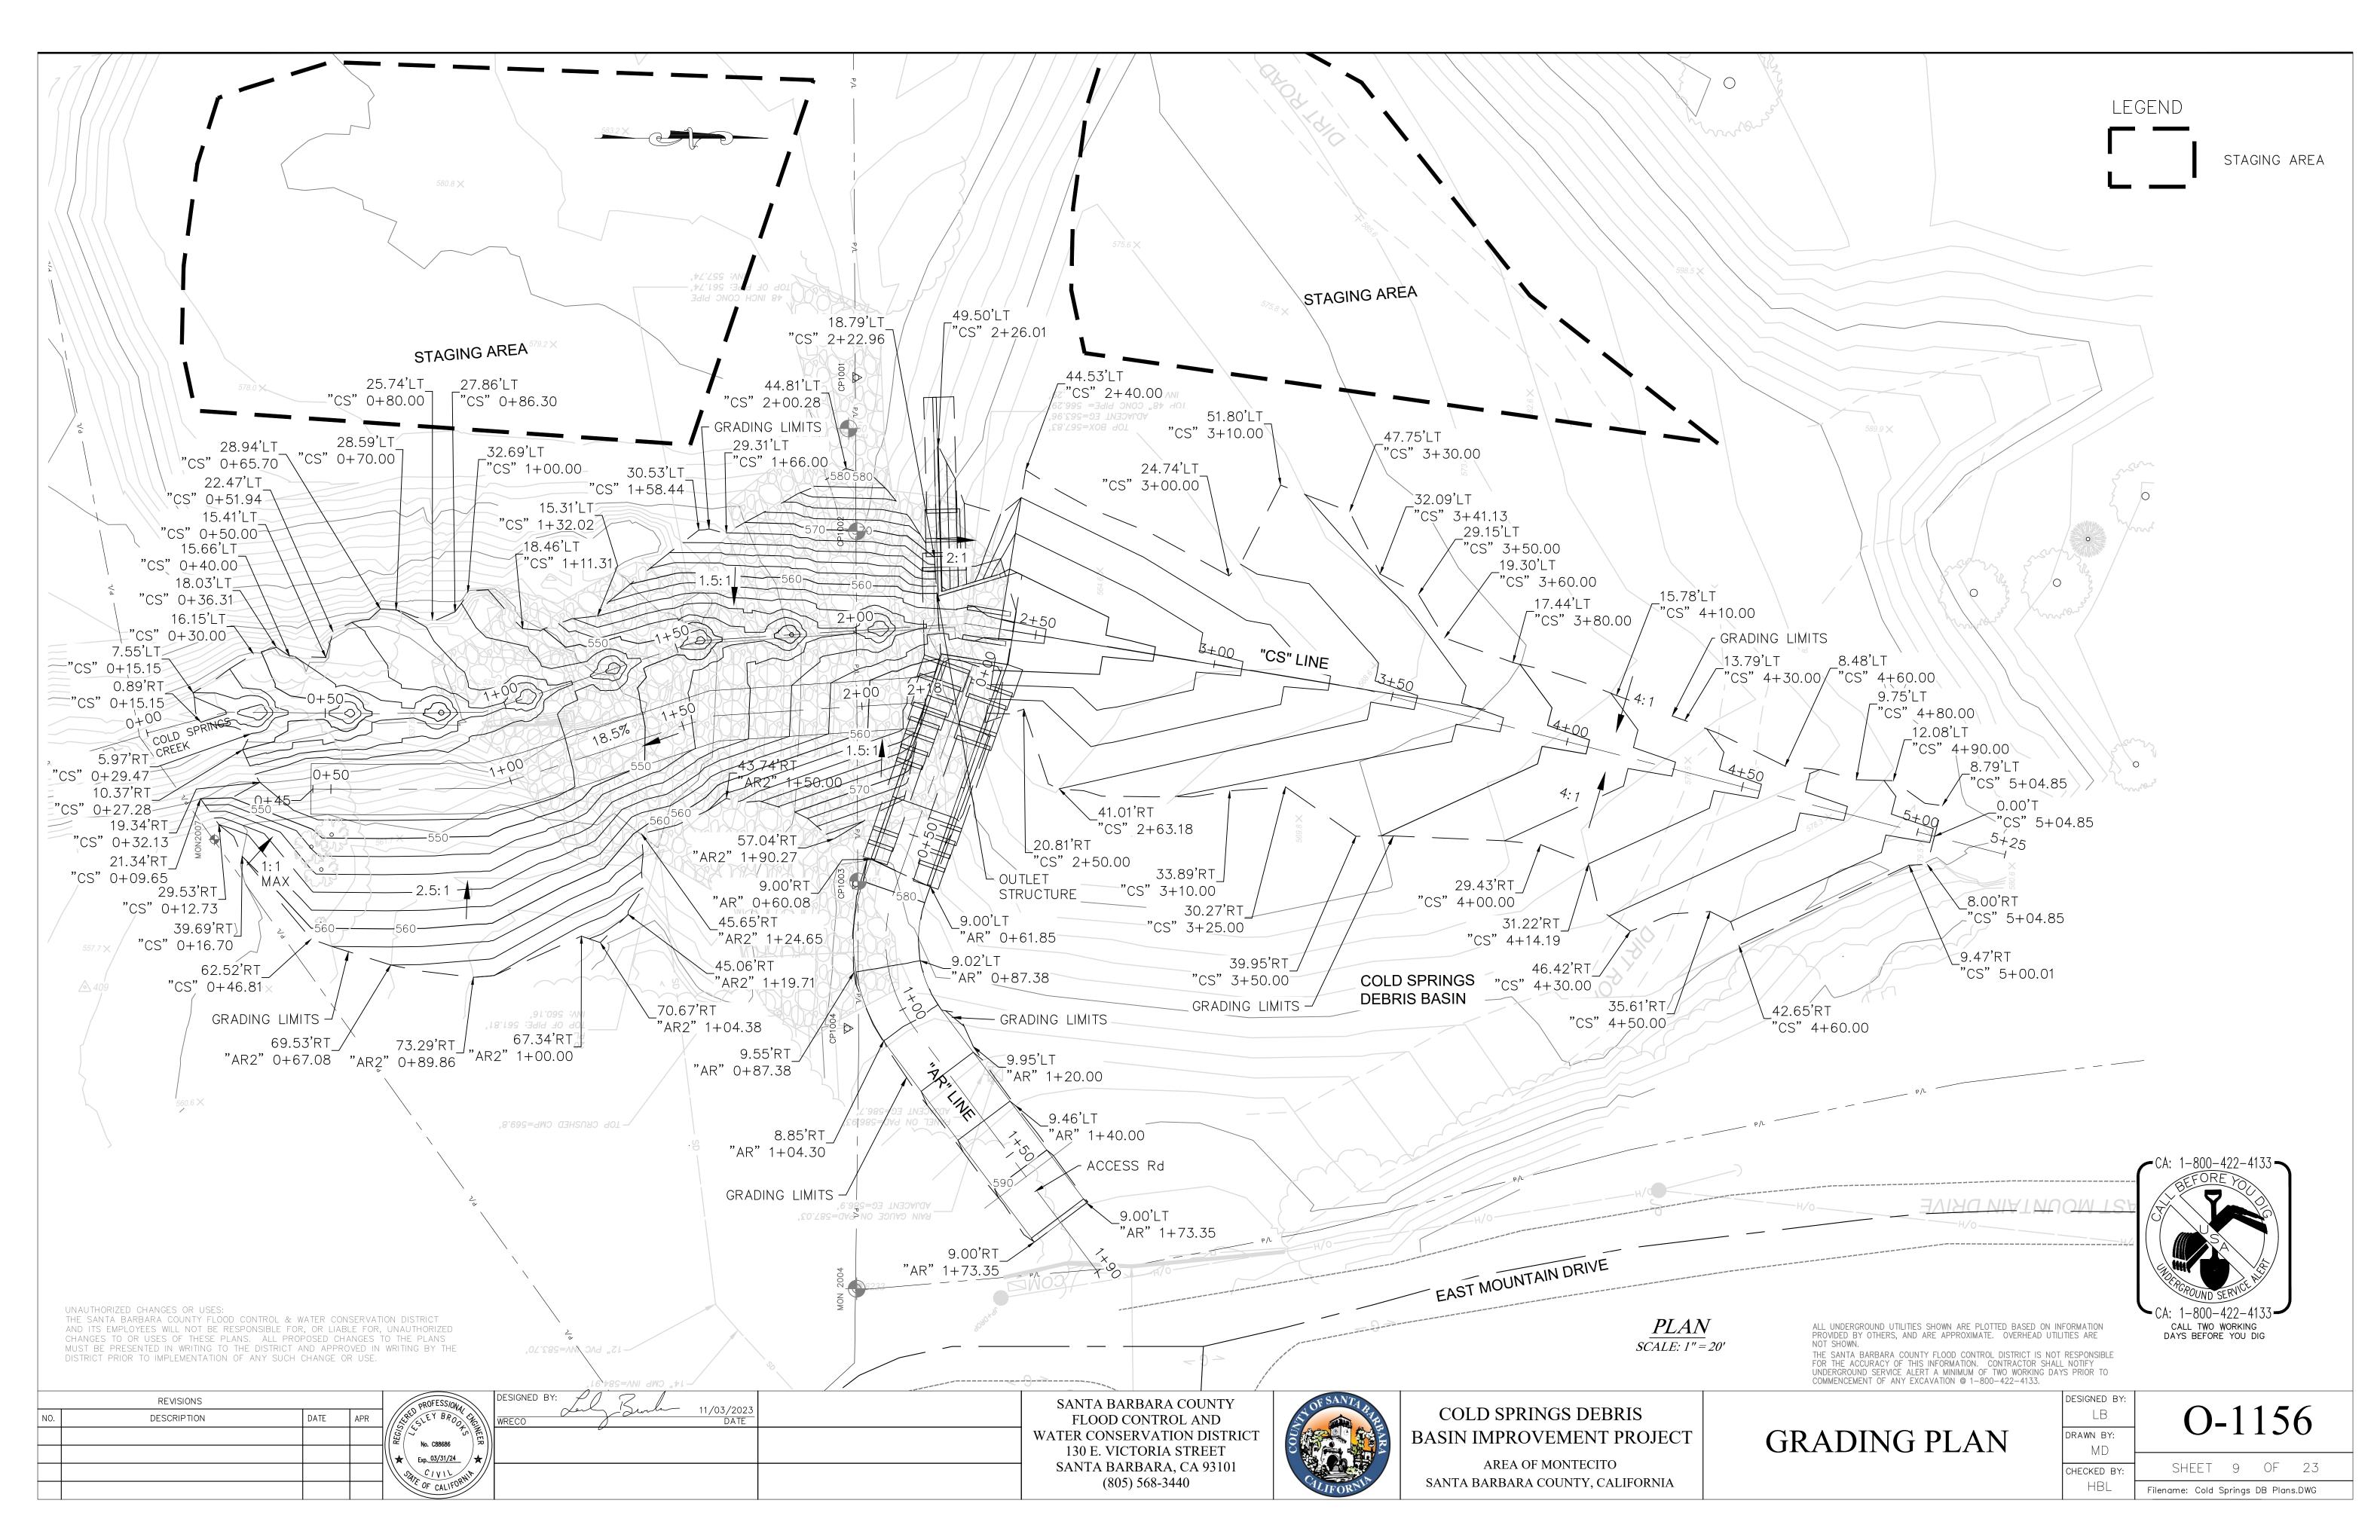


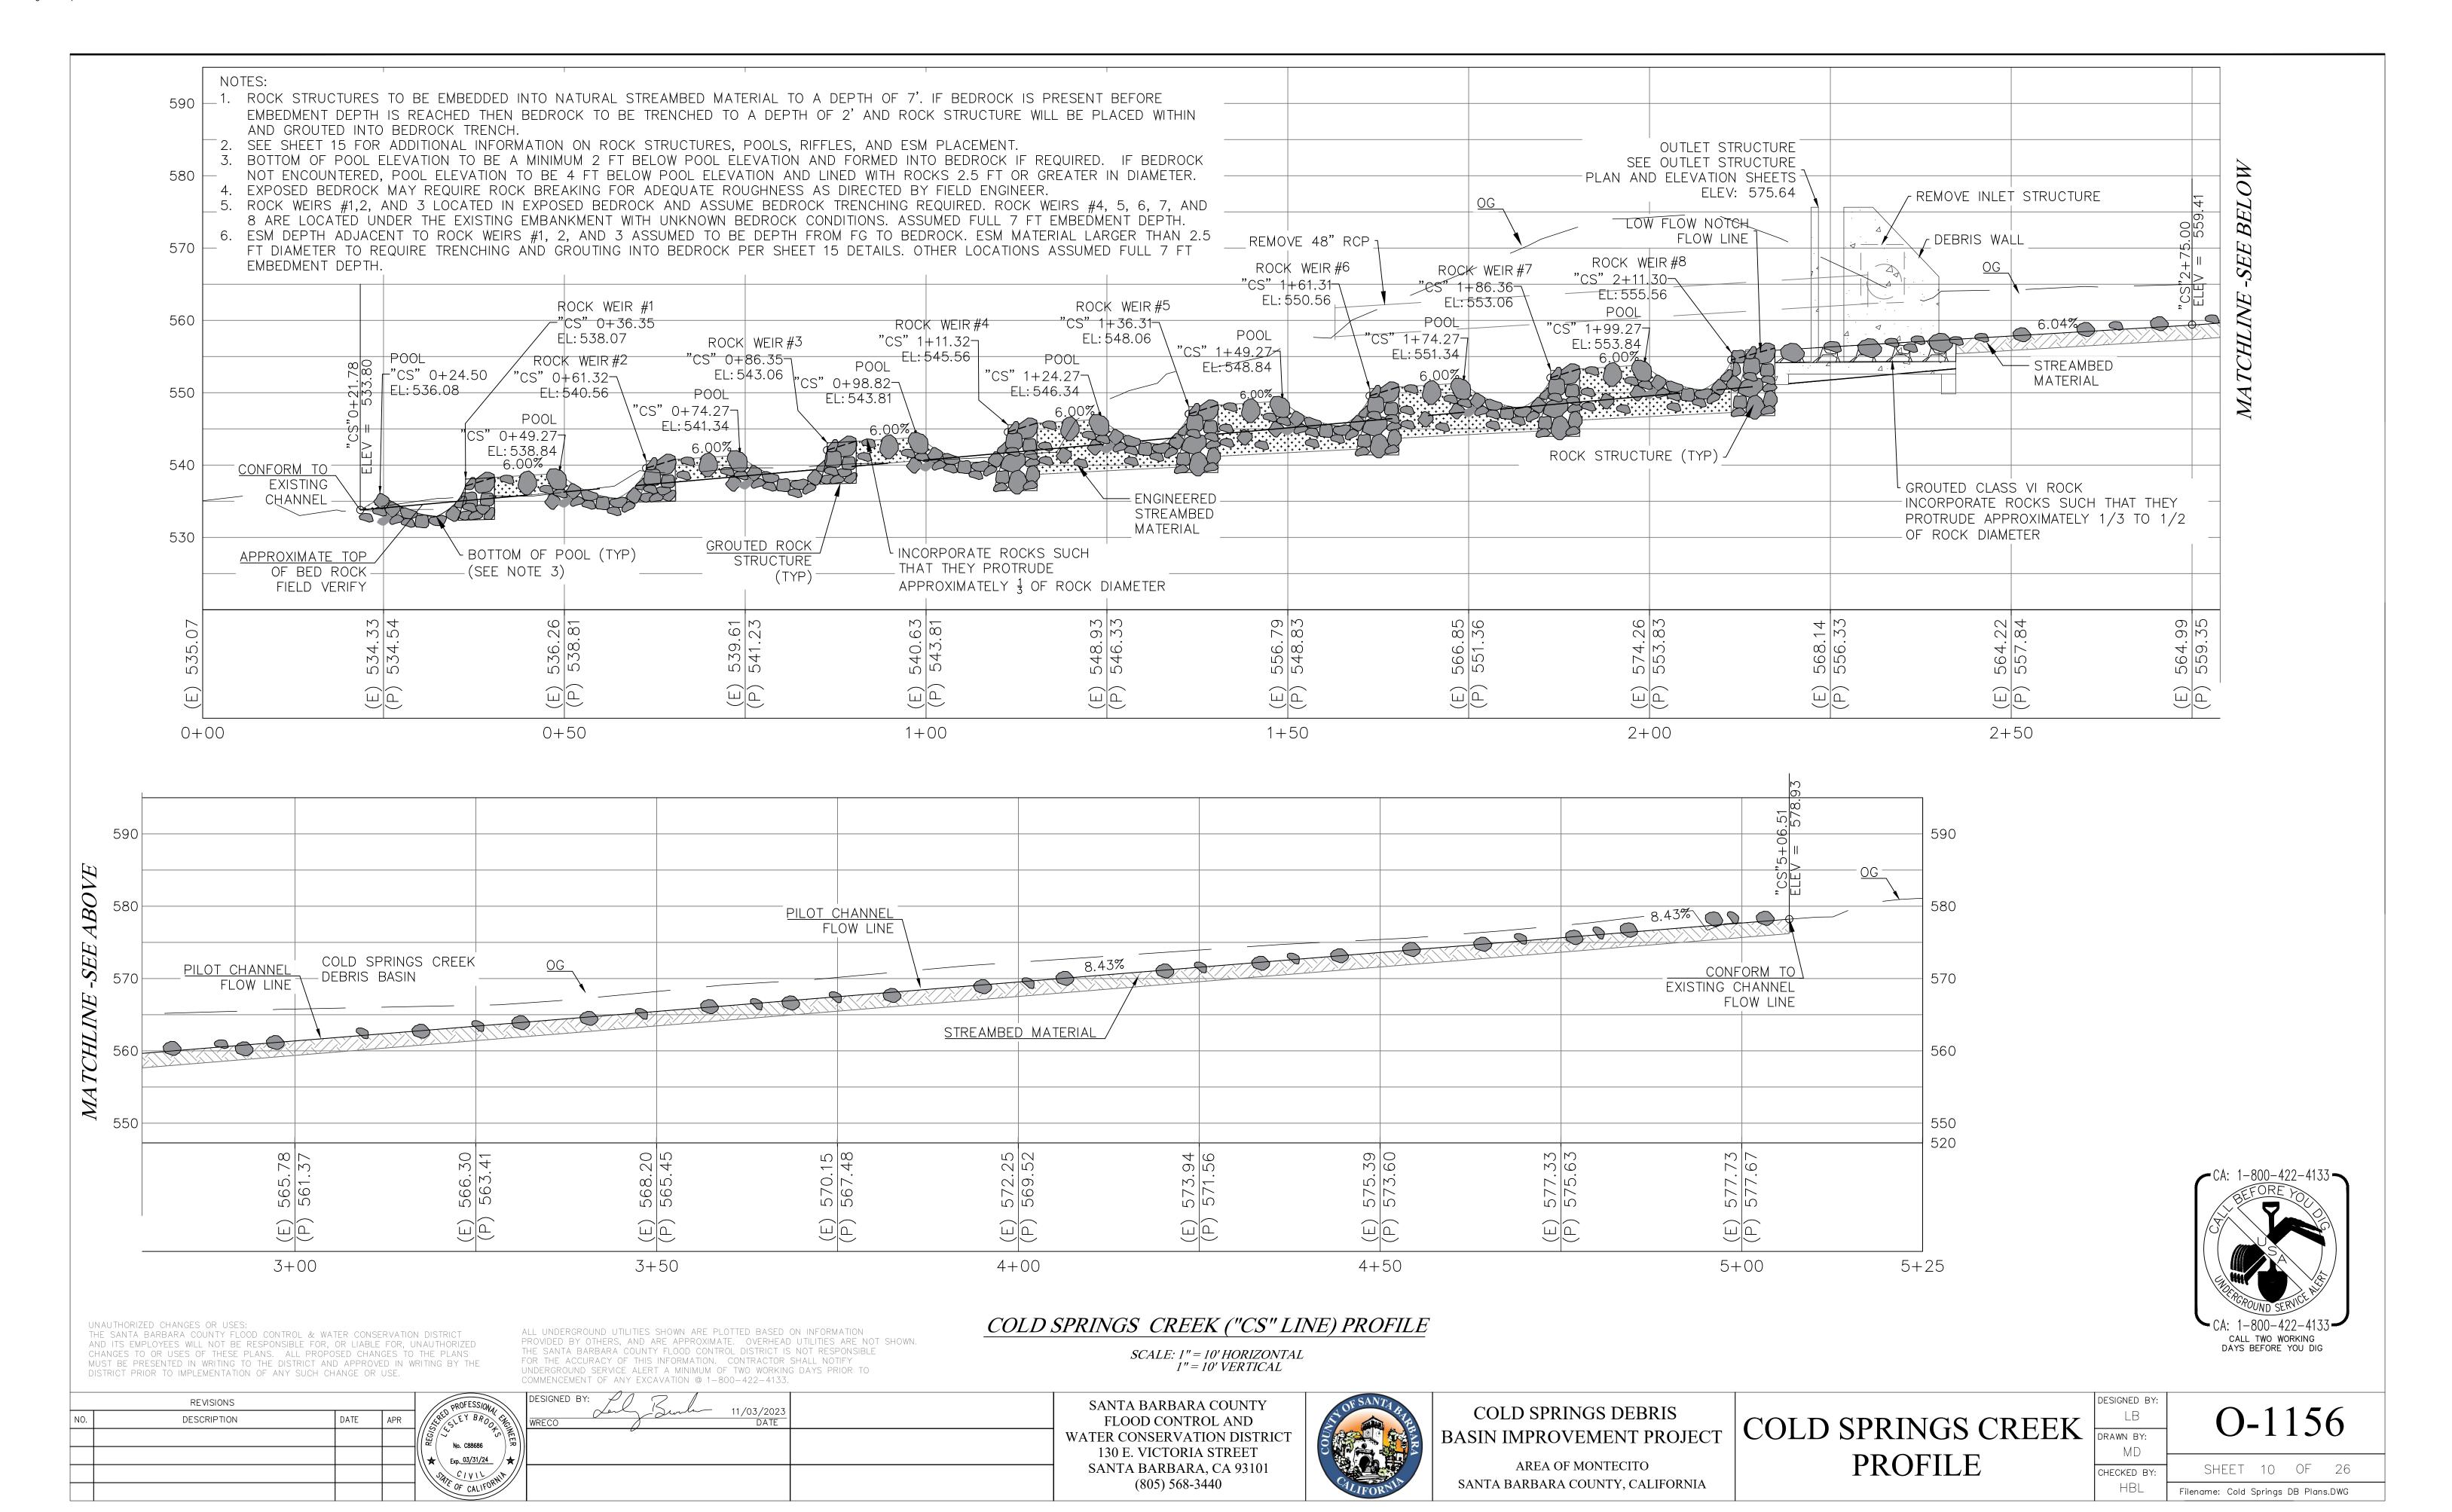

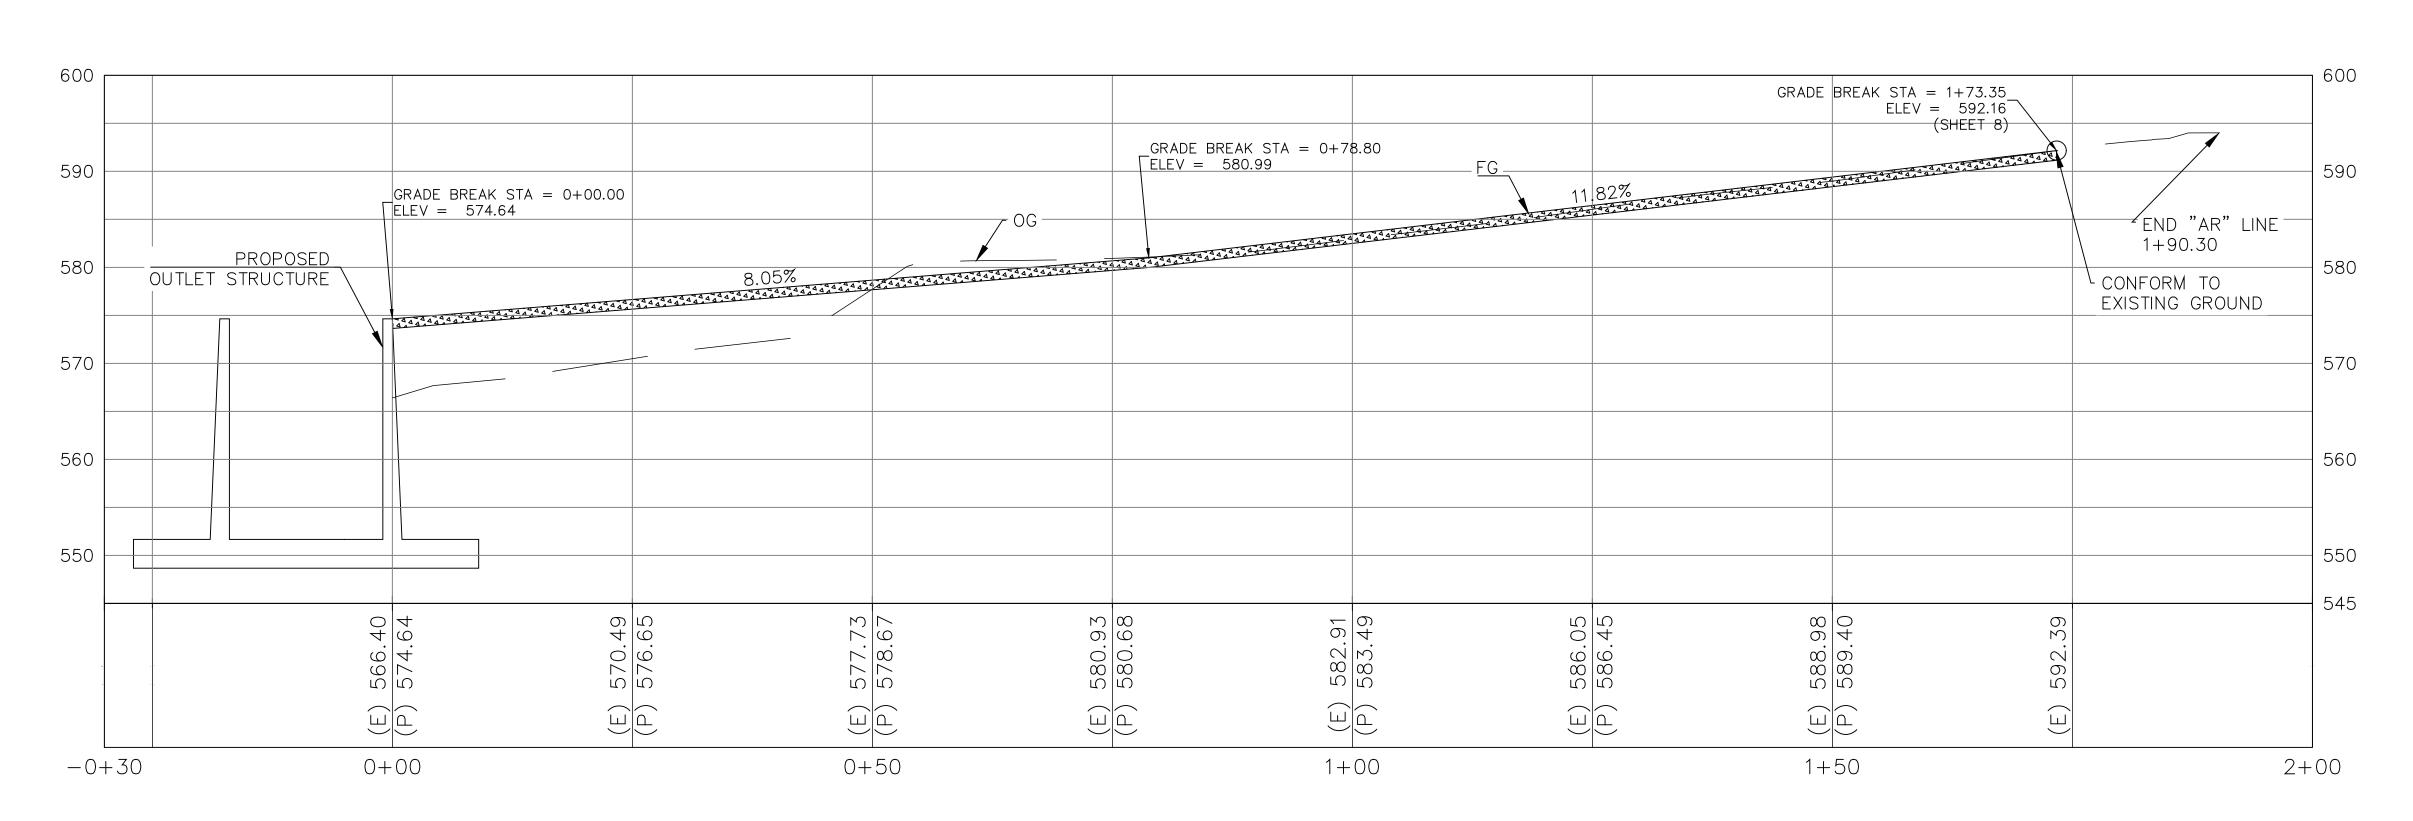

ACCESS ROAD ("AR" LINE) PROFILE

SCALE: 1" = 10' HORIZONTAL 1" = 10' VERTICAL

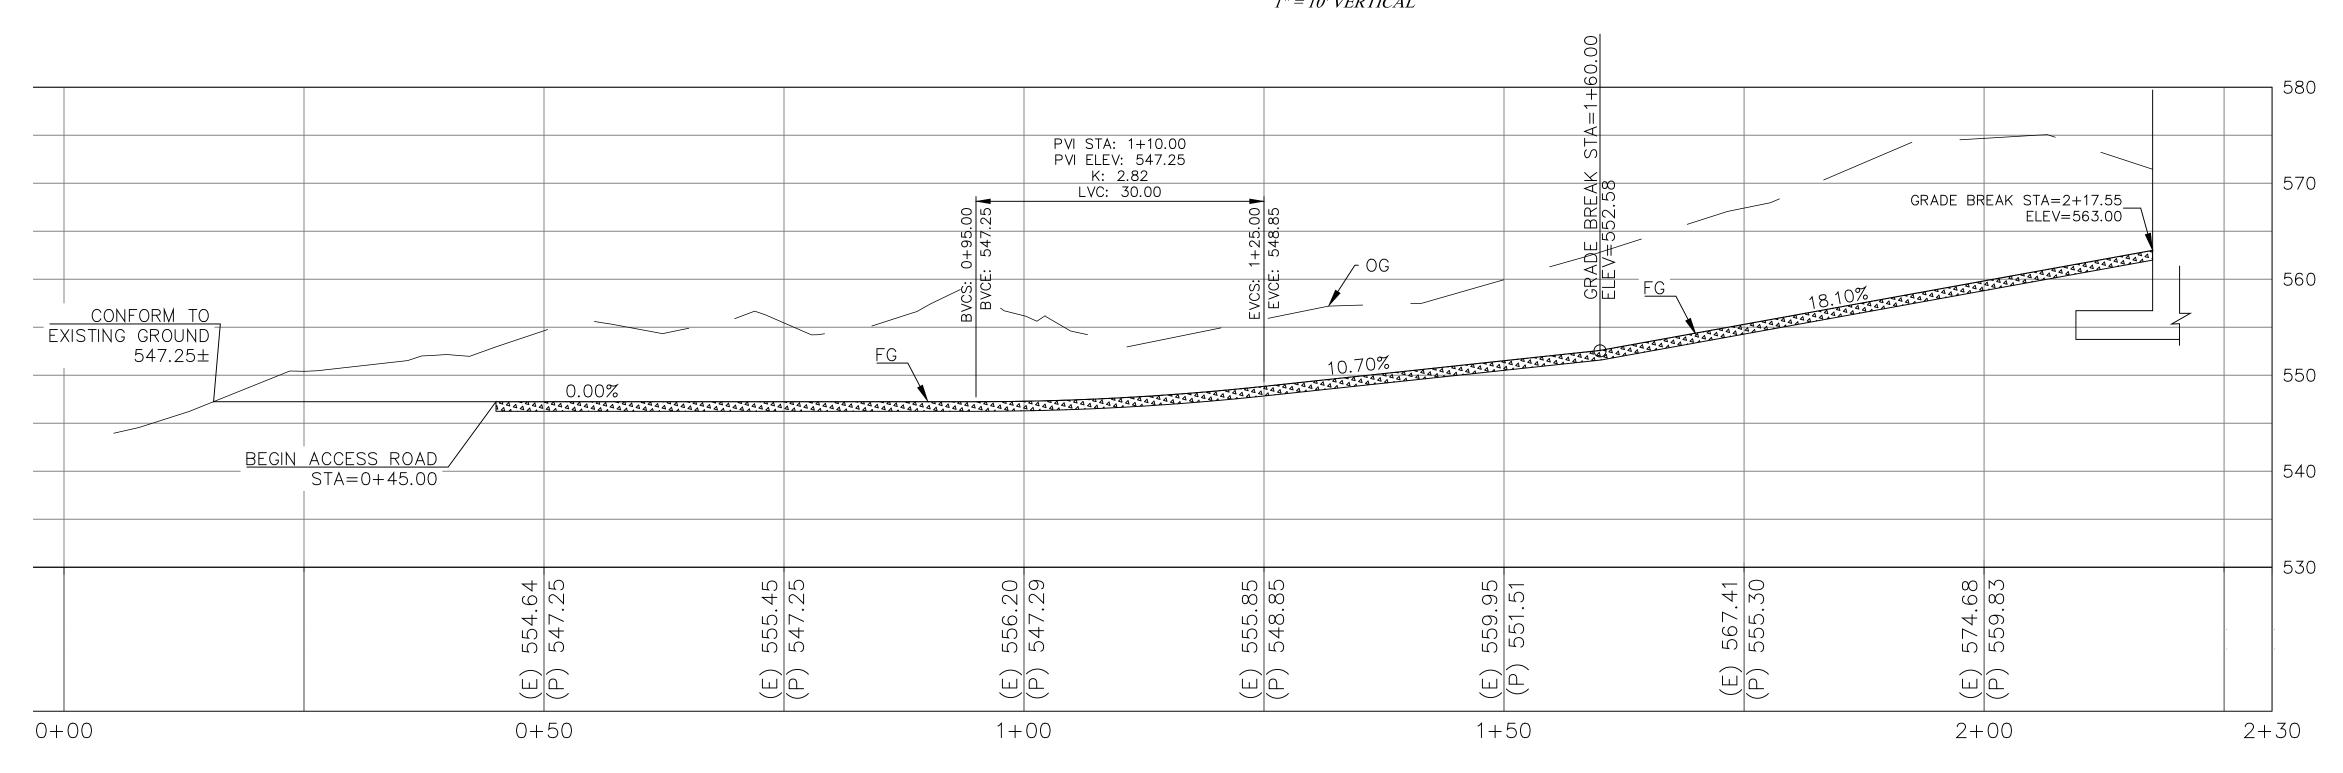



UNAUTHORIZED CHANGES OR USES: THE SANTA BARBARA COUNTY FLOOD CONTROL & WATER CONSERVATION DISTRICT AND ITS EMPLOYEES WILL NOT BE RESPONSIBLE FOR, OR LIABLE FOR, UNAUTHORIZED CHANGES TO OR USES OF THESE PLANS. ALL PROPOSED CHANGES TO THE PLANS MUST BE PRESENTED IN WRITING TO THE DISTRICT AND APPROVED IN WRITING BY THE DISTRICT PRIOR TO IMPLEMENTATION OF ANY SUCH CHANGE OR USE.

ACCESS ROAD 2 ("AR2" LINE) PROFILE

SCALE: 1" = 10' HORIZONTAL 1" = 10' VERTICAL

ALL UNDERGROUND UTILITIES SHOWN ARE PLOTTED BASED ON INFORMATION PROVIDED BY OTHERS, AND ARE APPROXIMATE. OVERHEAD UTILITIES ARE NOT SHOWN. THE SANTA BARBARA COUNTY FLOOD CONTROL DISTRICT IS NOT RESPONSIBLE FOR THE ACCURACY OF THIS INFORMATION. CONTRACTOR SHALL NOTIFY UNDERGROUND SERVICE ALERT A MINIMUM OF TWO WORKING DAYS PRIOR TO COMMENCEMENT OF ANY EXCAVATION @ 1-800-422-4133.

	REVISIONS	_		DESIGNED BY: June 11/03/2023	SAN
NO	DESCRIPTION	DATE	APR	WRECO DATE	FL
				(2 2 2 2 2 2 2 2 2	WATER
				\\ \star\ \ \ \ \ \ \ \ \ \ \ \ \ \ \ \ \ \ \	130
				SA CIVIL WIT	SAN
				OF CALIFORNIA	

SANTA BARBARA COUNTY FLOOD CONTROL AND ATER CONSERVATION DISTRICT 130 E. VICTORIA STREET SANTA BARBARA, CA 93101 (805) 568-3440	
(805) 568-3440	


COLD SPRINGS DEBRIS BASIN IMPROVEMENT PROJECT


AREA OF MONTECITO SANTA BARBARA COUNTY, CALIFORNIA


ACCESS RD PROFILE


DESIGNED BY:	()-1	15	6
DRAWN BY:) 1	1)	O
CHECKED BY:	SHE	ET 11	OF	26


SHE	EET	11	OF	26	
Filename:	Cold	Springs	DB Plar	ns.DWG	

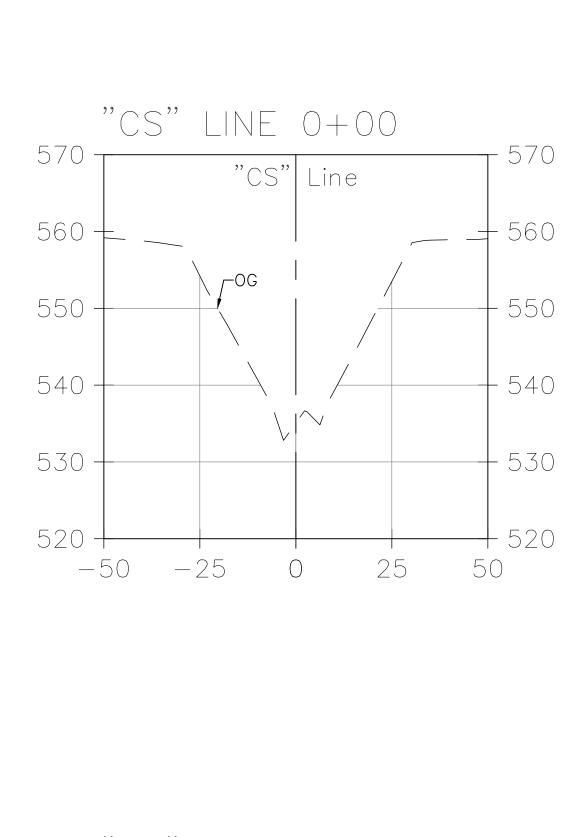


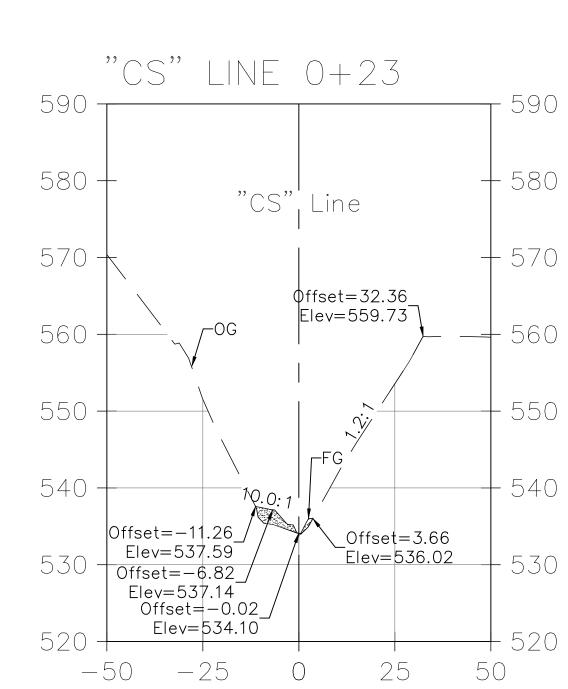


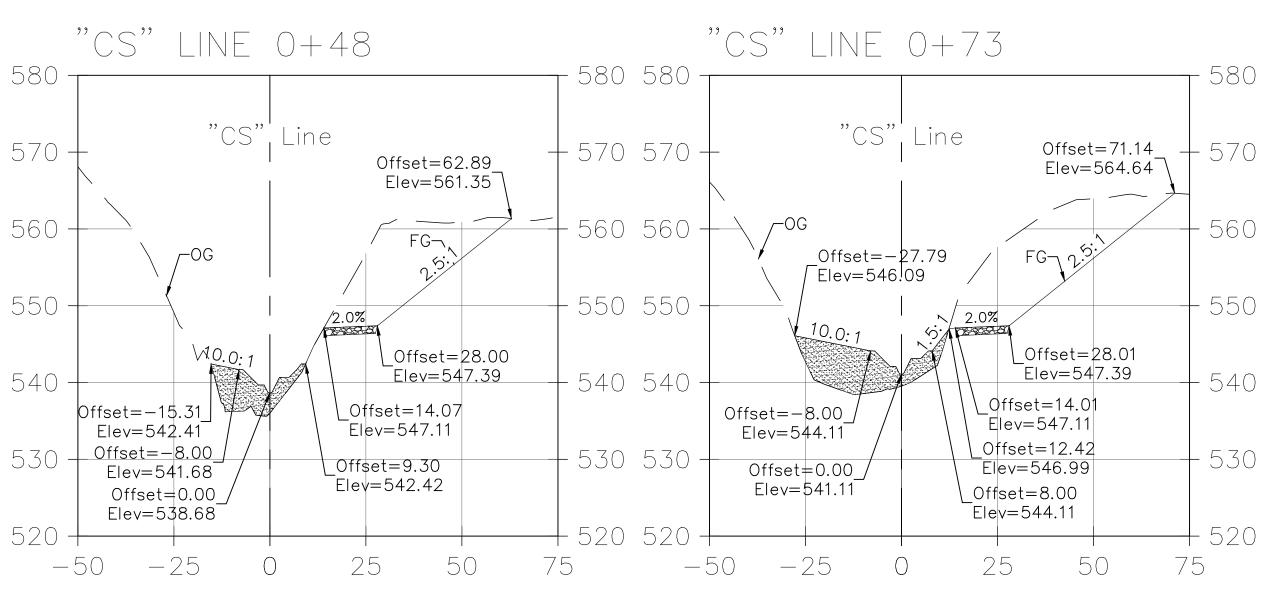


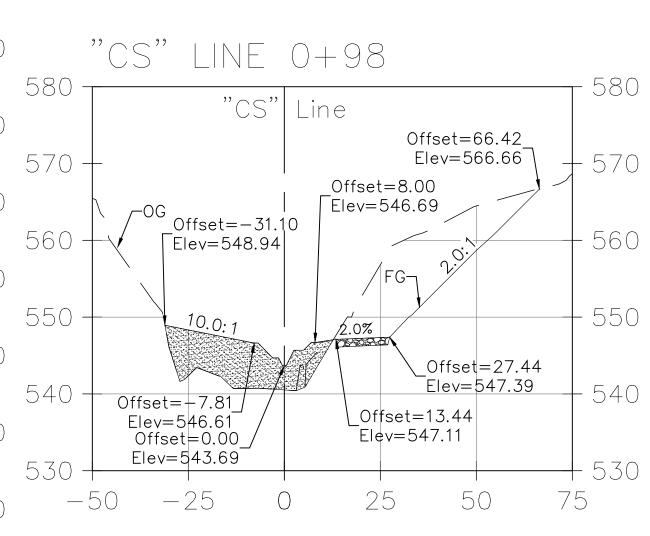

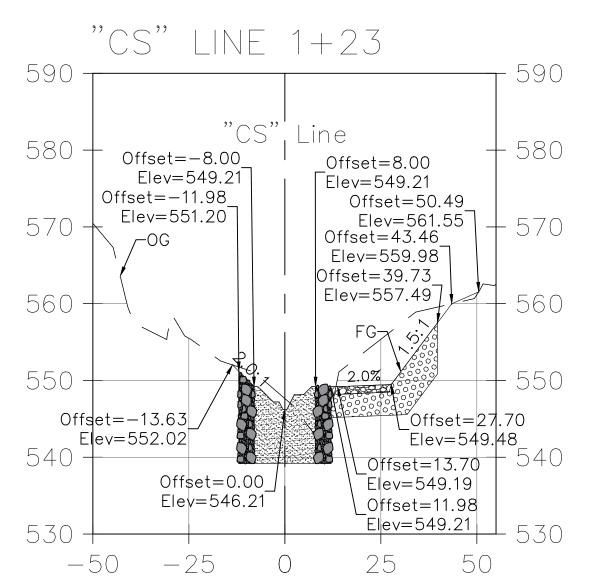

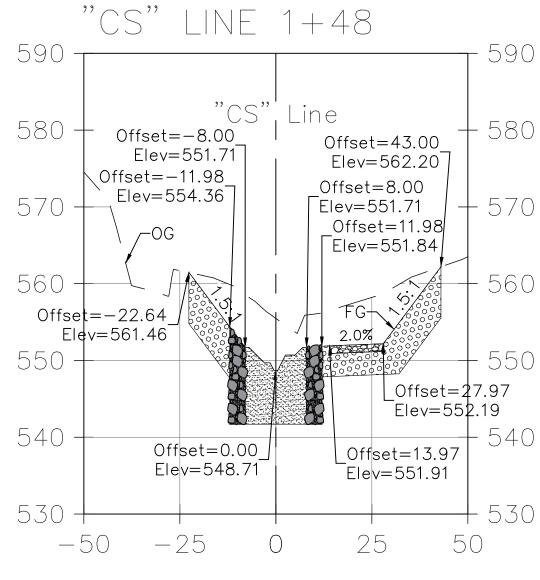

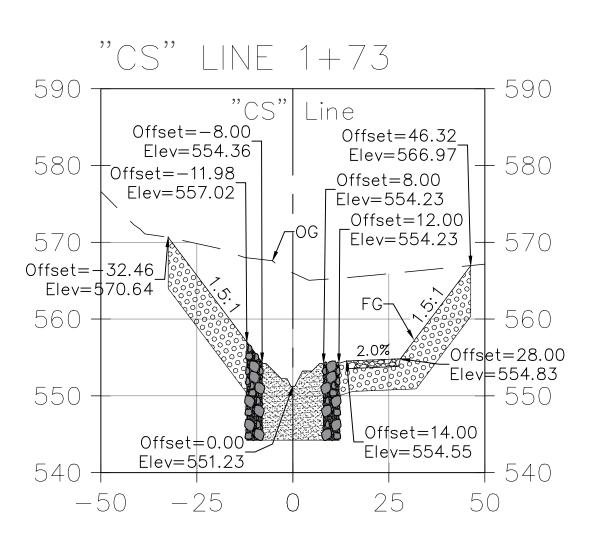

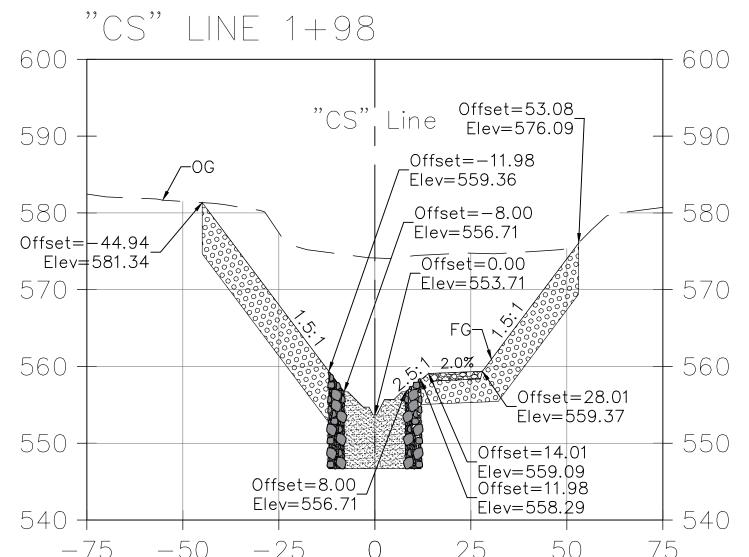

UNAUTHORIZED CHANGES OR USES:
THE SANTA BARBARA COUNTY FLOOD CONTROL & WATER CONSERVATION DISTRICT
AND ITS EMPLOYEES WILL NOT BE RESPONSIBLE FOR, OR LIABLE FOR, UNAUTHORIZED
CHANGES TO OR USES OF THESE PLANS. ALL PROPOSED CHANGES TO THE PLANS
MUST BE PRESENTED IN WRITING TO THE DISTRICT AND APPROVED IN WRITING BY THE
DISTRICT PRIOR TO IMPLEMENTATION OF ANY SUCH CHANGE OR USE.

SECTIONS

VERTICAL SCALE: 1" = 12.5'

HORIZONTAL SCALE: 1" = 25'

ALL UNDERGROUND UTILITIES SHOWN ARE PLOTTED BASED ON INFORMATION PROVIDED BY OTHERS, AND ARE APPROXIMATE. OVERHEAD UTILITIES ARE NOT SHOWN.

THE SANTA BARBARA COUNTY FLOOD CONTROL DISTRICT IS NOT RESPONSIBLE FOR THE ACCURACY OF THIS INFORMATION. CONTRACTOR SHALL NOTIFY UNDERGROUND SERVICE ALERT A MINIMUM OF TWO WORKING DAYS PRIOR TO COMMENCEMENT OF ANY EXCAVATION @ 1-800-422-4133.

	SA SA SERVICE NO ALTON
•	CA: 1-800-422-4133 CALL TWO WORKING DAYS BEFORE YOU DIG

·CA: 1-800-422-4133 -

	REVISIONS			// ORUFESS/ON/ \	DESIGNED BY:	
NO.	DESCRIPTION	DATE	APR	SLEY BROOKE	WRECO 11/03/2023 DATE	
				No. C88686]
				Exp. 03/31/24		
				STATE CIVIL SUIT		1
				OF CALIFORN		




COLD SPRINGS DEBRIS	
BASIN IMPROVEMENT PROJECT	
AREA OF MONTECITO	
SANTA BARBARA COUNTY, CALIFORNIA	


SECTIONS	1


DESIGNED BY:				
LB	() _1	15	6
DRAWN BY:		ノ 1	1)	O
CHECKED BY:	SHE	ET 12	OF	26


SHEET 12 OF 26

Filename: Cold Springs DB Plans.DWG

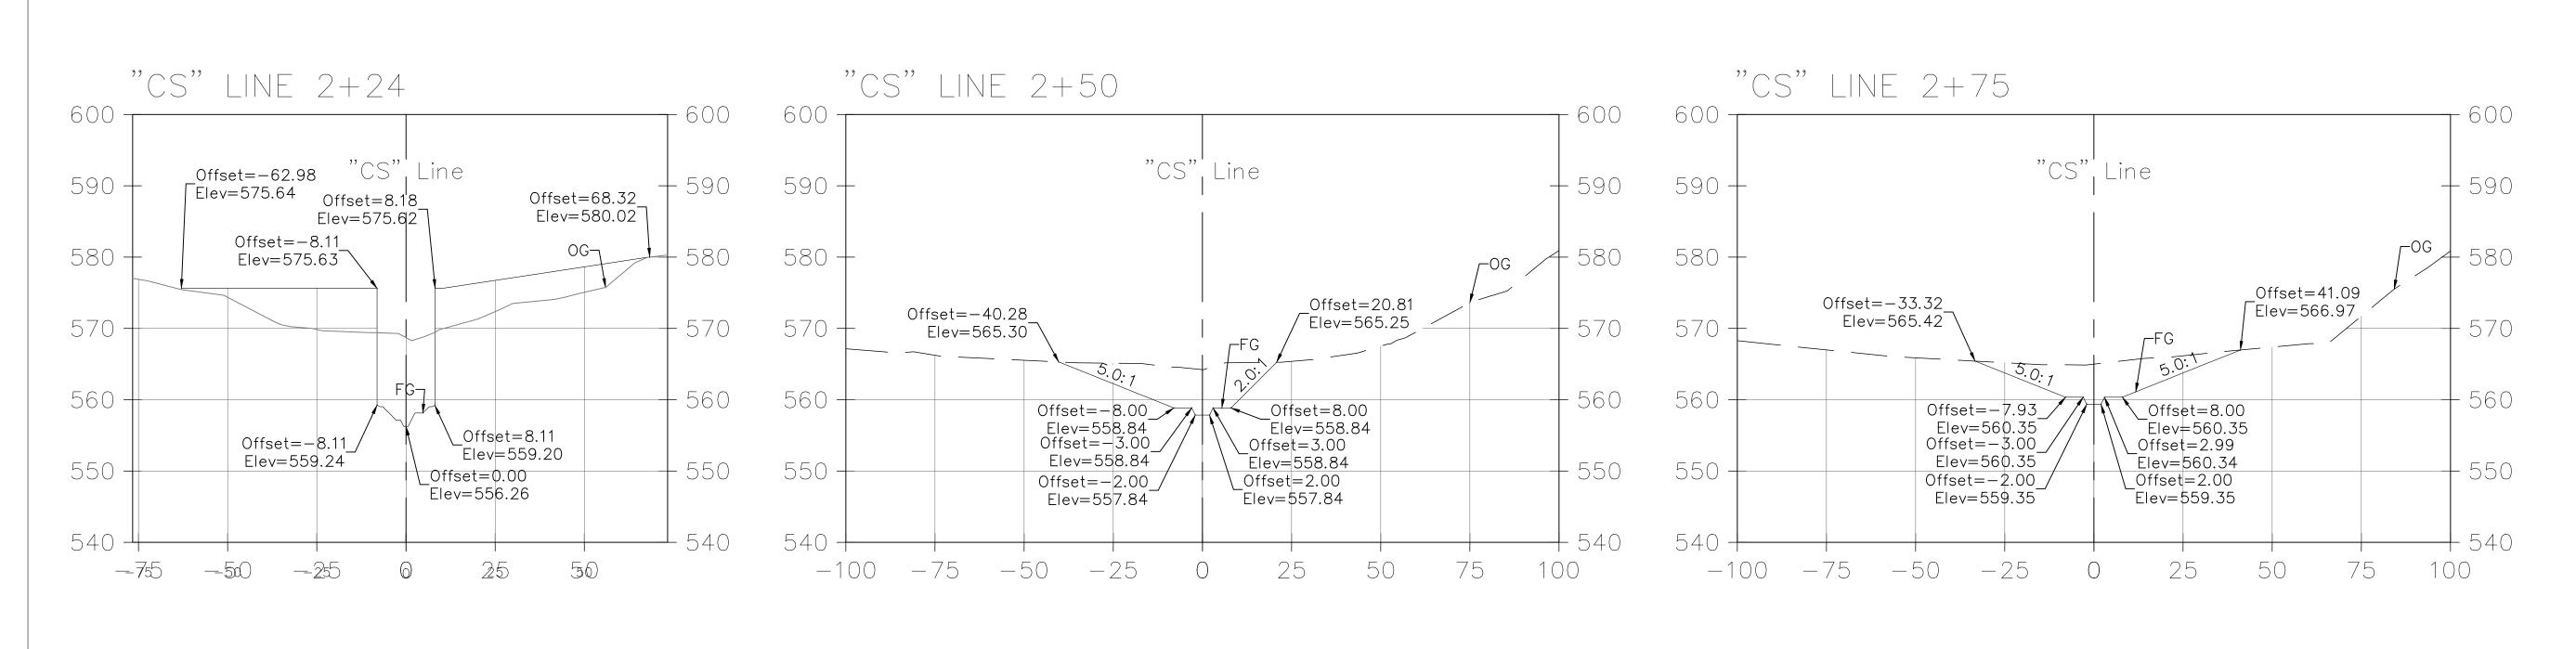

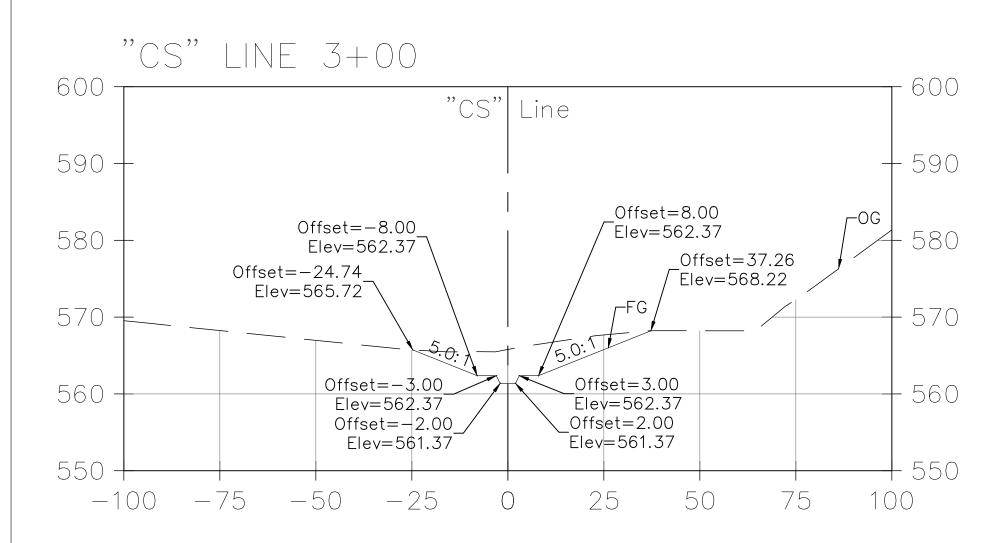

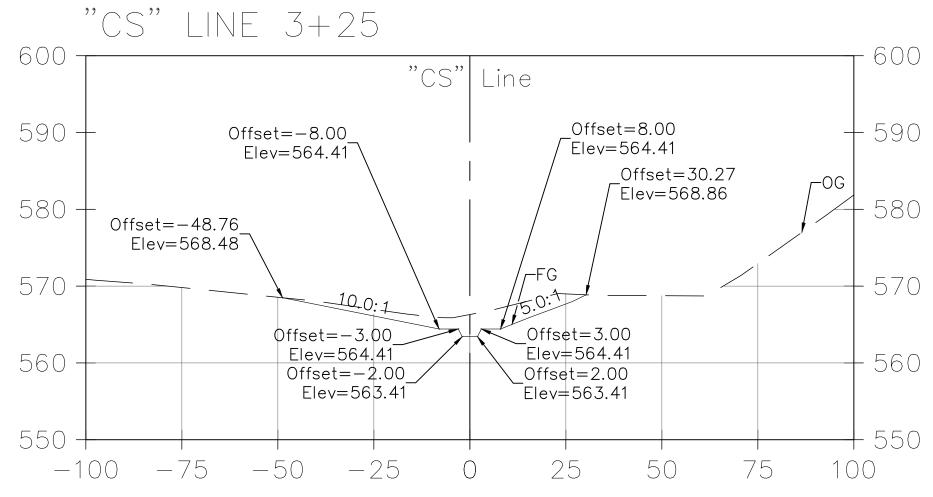

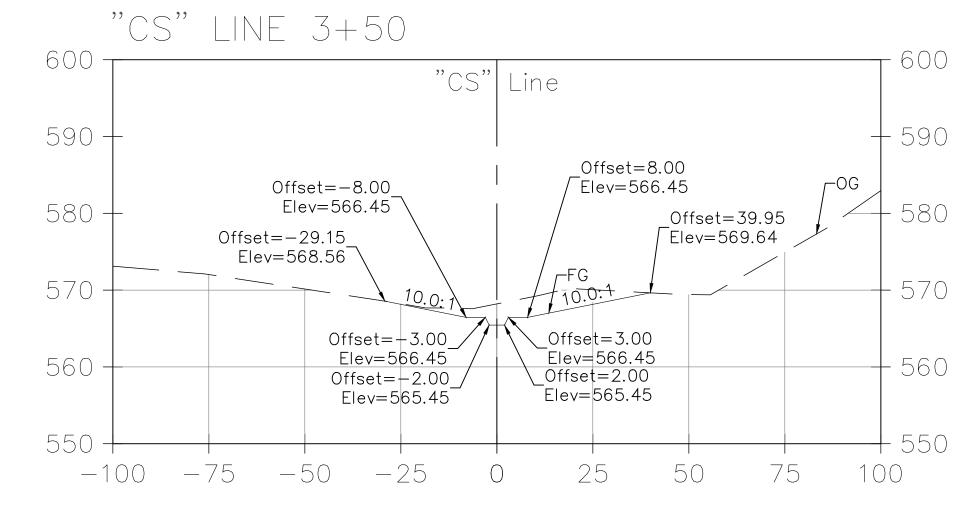

UNAUTHORIZED CHANGES OR USES: THE SANTA BARBARA COUNTY FLOOD CONTROL & WATER CONSERVATION DISTRICT AND ITS EMPLOYEES WILL NOT BE RESPONSIBLE FOR, OR LIABLE FOR, UNAUTHORIZED CHANGES TO OR USES OF THESE PLANS. ALL PROPOSED CHANGES TO THE PLANS MUST BE PRESENTED IN WRITING TO THE DISTRICT AND APPROVED IN WRITING BY THE DISTRICT PRIOR TO IMPLEMENTATION OF ANY SUCH CHANGE OR USE.

SECTIONS VERTICAL SCALE: 1" = 12.5' *HORIZONTAL SCALE: 1" = 25'* ALL UNDERGROUND UTILITIES SHOWN ARE PLOTTED BASED ON INFORMATION PROVIDED BY OTHERS, AND ARE APPROXIMATE. OVERHEAD UTILITIES ARE NOT SHOWN. THE SANTA BARBARA COUNTY FLOOD CONTROL DISTRICT IS NOT RESPONSIBLE FOR THE ACCURACY OF THIS INFORMATION. CONTRACTOR SHALL NOTIFY UNDERGROUND SERVICE ALERT A MINIMUM OF TWO WORKING DAYS PRIOR TO COMMENCEMENT OF ANY EXCAVATION @ 1-800-422-4133.

	REVISIONS			PROFESS/ONA	DESIGNED BY:		SANTA BARBARA COUNTY
NO.	DESCRIPTION	DATE	APR	LEVEL SLEY BROOKS	WRECO 11/03/2023	-	FLOOD CONTROL AND
				No. C88686			WATER CONSERVATION DISTRICT
				Exp. 03/31/24			130 E. VICTORIA STREET
				SZ CIVIL WA			SANTA BARBARA, CA 93101
				OF CALIFORN			(805) 568-3440



COLD SPRINGS DEBRIS	
BASIN IMPROVEMENT PROJECT	
AREA OF MONTECITO	
SANTA BARBARA COUNTY, CALIFORNIA	

SECTIONS 2


DESIGNED BY:	
LB	
DRAWN BY:	
MD	
1,112	
CHECKED BY:	
l HRI	


|--|


•CA: 1-800-422-4133 **-**


CALL TWO WORKING DAYS BEFORE YOU DIG


SHEET 13 OF 26 Filename: Cold Springs DB Plans.DWG

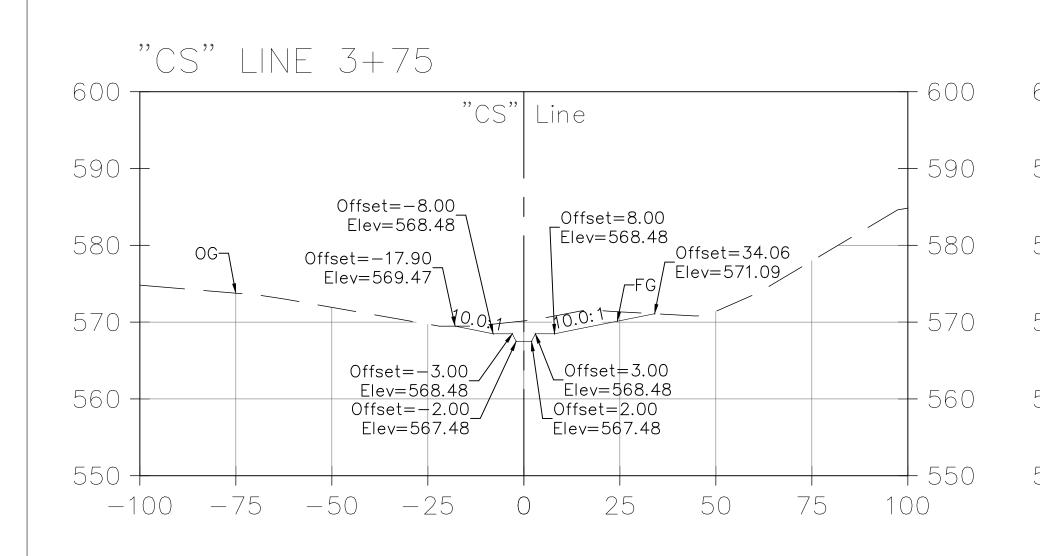


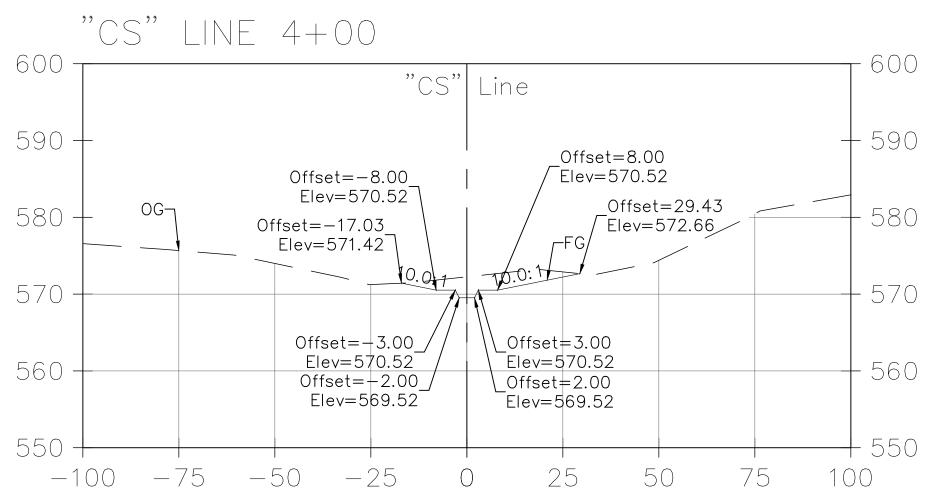


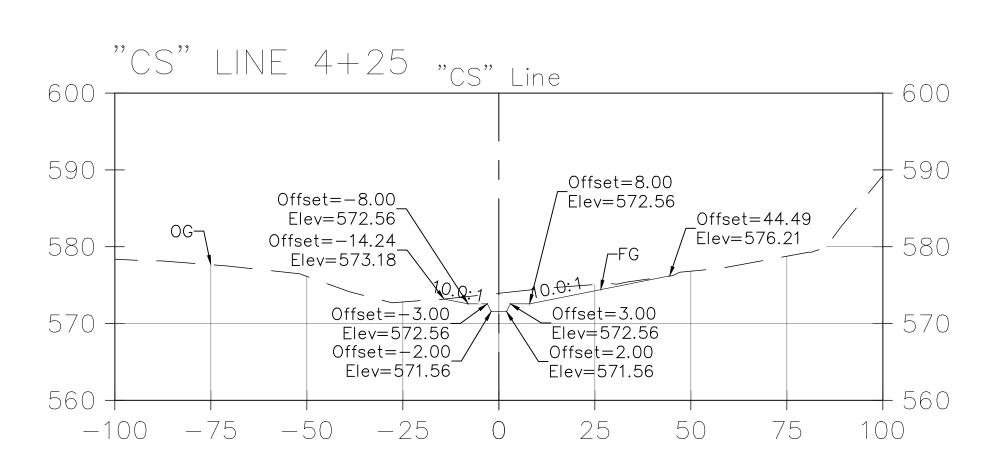

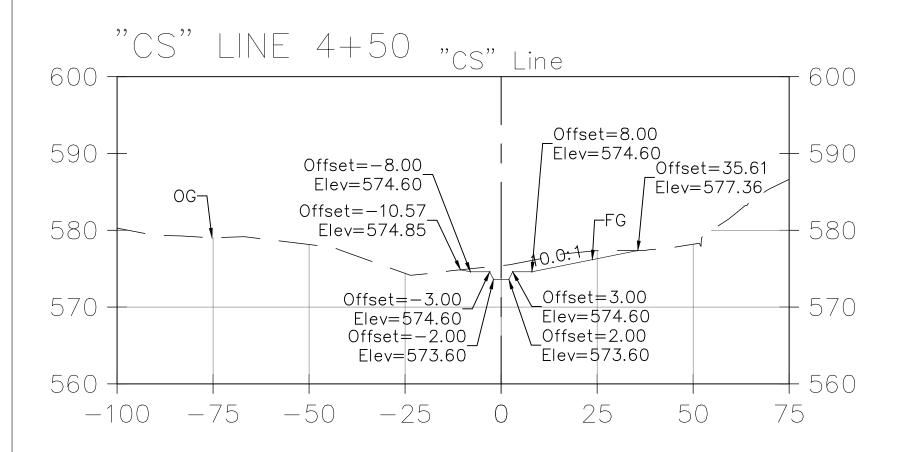

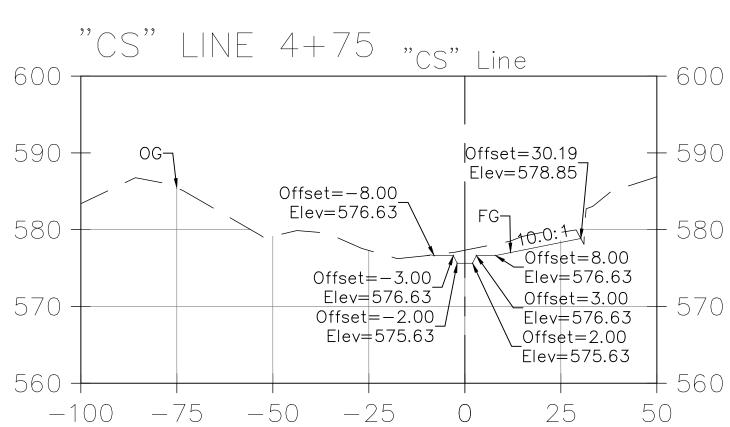

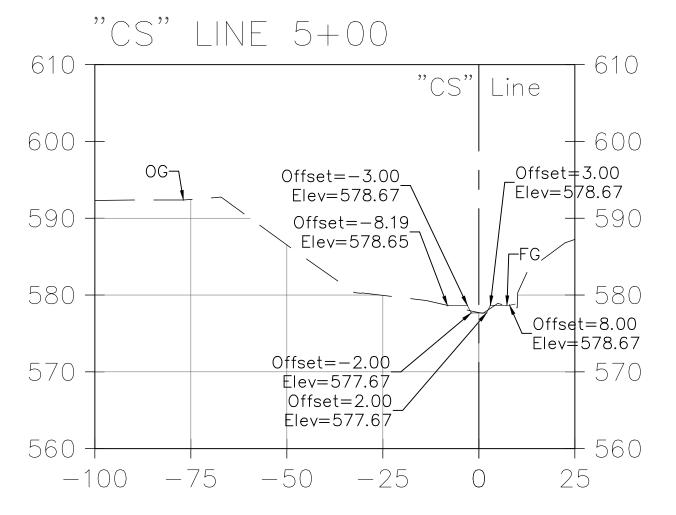

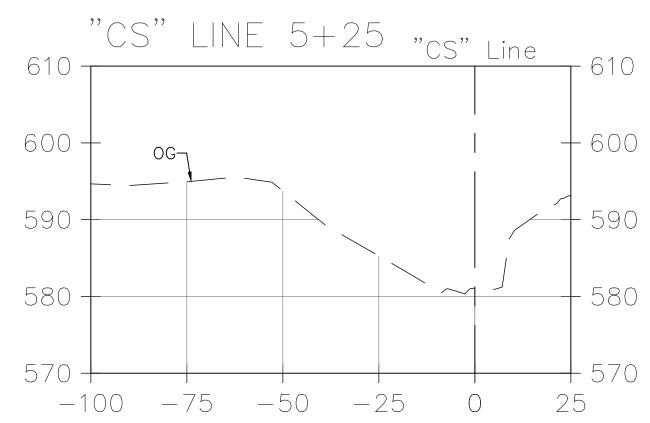

UNAUTHORIZED CHANGES OR USES:
THE SANTA BARBARA COUNTY FLOOD CONTROL & WATER CONSERVATION DISTRICT
AND ITS EMPLOYEES WILL NOT BE RESPONSIBLE FOR, OR LIABLE FOR, UNAUTHORIZED
CHANGES TO OR USES OF THESE PLANS. ALL PROPOSED CHANGES TO THE PLANS
MUST BE PRESENTED IN WRITING TO THE DISTRICT AND APPROVED IN WRITING BY THE
DISTRICT PRIOR TO IMPLEMENTATION OF ANY SUCH CHANGE OR USE.

SECTIONS

VERTICAL SCALE: 1" = 12.5'

HORIZONTAL SCALE: 1" = 25'

PROVIDED BY OTHERS, AND ARE APPROXIMATE. OVERHEAD UTILITIES ARE NOT SHOWN.

THE SANTA BARBARA COUNTY FLOOD CONTROL DISTRICT IS NOT RESPONSIBLE FOR THE ACCURACY OF THIS INFORMATION. CONTRACTOR SHALL NOTIFY UNDERGROUND SERVICE ALERT A MINIMUM OF TWO WORKING DAYS PRIOR TO COMMENCEMENT OF ANY EXCAVATION @ 1-800-422-4133.

ALL UNDERGROUND UTILITIES SHOWN ARE PLOTTED BASED ON INFORMATION

REFORE FORE FORE FORE FORE FORE FORE FOR
CA: 1-800-422-4133 CALL TWO WORKING DAYS BEFORE YOU DIG

					^		
	REVISIONS			PROFESS/ON	DESIGNED BY:	7	SA
NO.	DESCRIPTION	DATE	APR	LEVER BROOKE	WRECO DATE	2-]
				No. C88686 / No. C88686			WATE
				Exp. 03/31/24			1.
				SAT CIVIL QUIT			SA
				OF CALIFORN			




COLD SPRINGS DEBRIS	
BASIN IMPROVEMENT PROJECT	
AREA OF MONTECITO	
SANTA BARBARA COUNTY, CALIFORNIA	


DESIGNED BY: LB	0-1
drawn by: MD	
IVID	
CHECKED BY:	SHEET 14

SHEET 14 OF 26

Filename: Cold Springs DB Plans.DWG

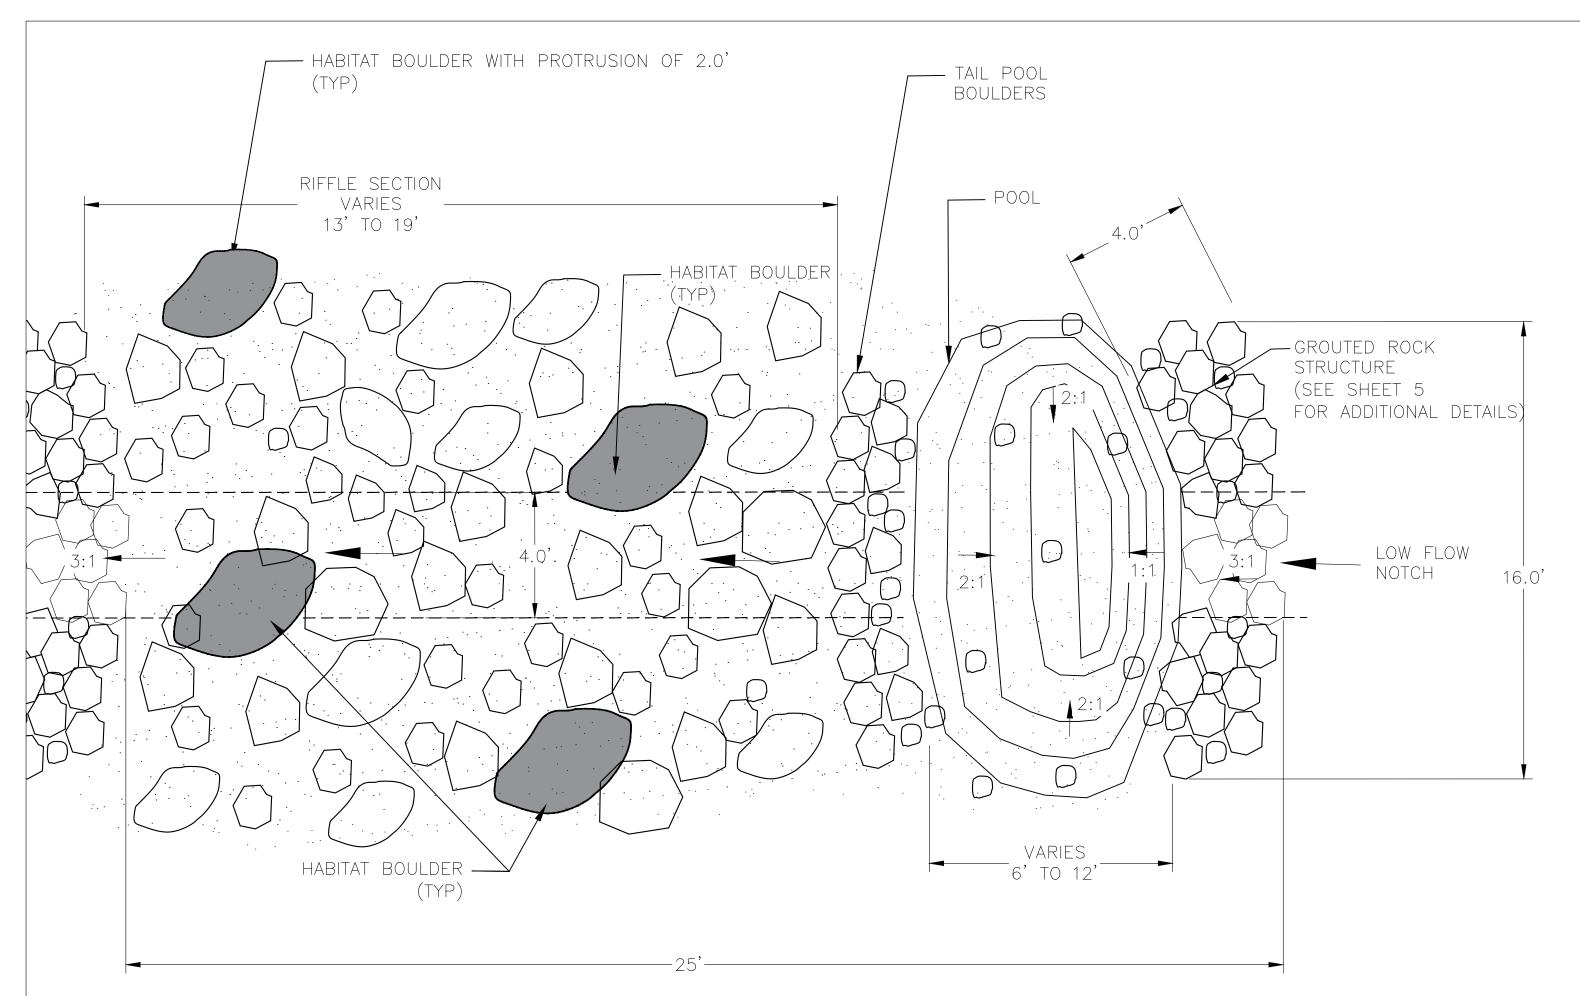

A TYPICAL POOL AND GROUTED ROCK STRUCTURE (PLAN) SCALE: NO SCALE

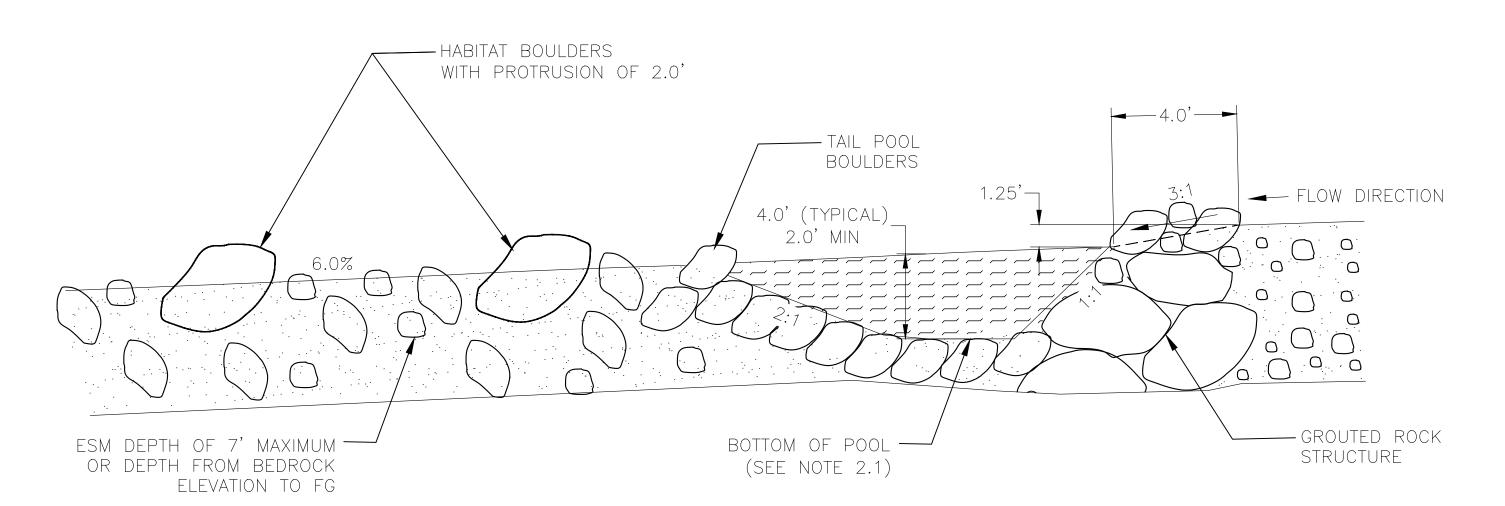

B TYPICAL POOL AND GROUTED ROCK STRUCTURE (PROFILE)

SCALE: NO SCALE



1. GROUTED ROCK STRUCTURES

- 1.1. GROUTED ROCK STRUCTURES TO BE ALIGNED IN THE UPSTREAM DIRECTION AT ROUGHLY 15 DEGREES.
- 1.2. LOW FLOW NOTCH IN GROUTED ROCK STRUCTURE TO BE SLOPED AT A 3:1 IN THE DOWNSTREAM DIRECTION.
- 1.3. ROCKS PROTRUDING FROM THE GROUTED ROCK STRUCTURE SHALL NOT BE VERTICAL OR CREATE AN OVERHANG ON THE DOWNSTREAM SIDE THAT WOULD OBSTRUCT FISH MIGRATION.
- 1.4. ROCK SELECTION FOR THE GROUTED ROCK STRUCTURES TO BE SUPERVISED BY FIELD ENGINEER.

2. <u>POOL</u>


2.1. POOL DEPTHS TO BE 4' TYPICAL. WHERE POOL DEPTHS INTRUDE INTO BEDROCK, BEDROCK TO BE EXCAVATED TO PROVIDE A MINIMUM 2' POOL DEPTH. EXPOSED BEDROCK MAY REQUIRE ROCK BREAKING TO PROVIDE ADEQUATE ROUGHNESS AS DIRECTED BY FIELD ENGINEER.

3. TAIL POOL BOULDERS

3.1. TAIL POOL BOULDERS TO CONSIST OF BUTRESSED 2.5' OR LARGER DIAMETER ROCK. TAIL POOL BOULDERS TO BE EMBEDDED WITH 1/3 TO 1/2 ROCK DIAMETER PROTRUDING. IF DEPTH FROM FINISHED GRADE TO BEDROCK IS NOT SUFFICIENT FOR EMBEDMENT, THEN TAIL POOL BOULDERS TO BE TRENCHED AND GROUTED INTO BEDROCK PER DETAIL D-15.

4. RIFFLE SECTION

- 4.1. RIFFLE SECTION TO BE COMPRISED OF ESM MATERIAL. MATERIAL OF 2.5' DIAMETER OR LARGER THAT CANNOT BE EMBEDDED INTO ESM DUE TO DEPTH OF BEDROCK SHALL BE TRENCH AND GROUTED INTO BEDROCK PER DETAIL D-15.
- 4.2. A MINIMUM OF FOUR HABITAT BOULDERS 4' IN DIAMETER OR LARGER TO BE PLACED PER RIFFLE SECTION AS FIELD DIRECTED.
- 4.3. HABITAT BOULDERS TO PROTRUDE A MINIMUM OF 2' ABOVE FG AND SHALL EITHER BE EMBEDDED OR TRENCHED AND GROUTED INTO BEDROCK PER DETAIL D-15.

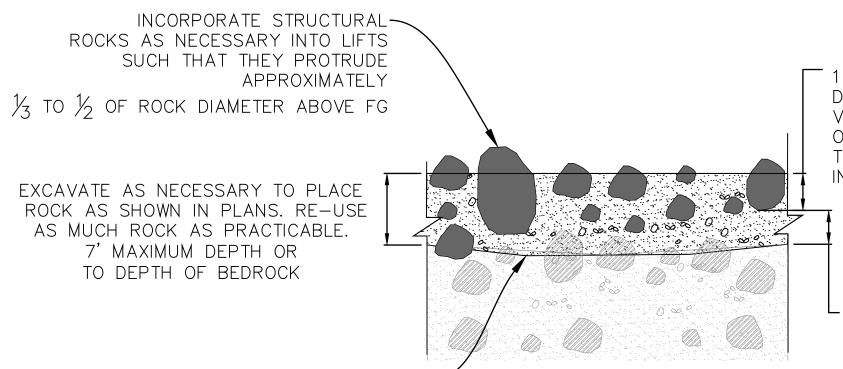

1 FOOT LIFT WITH D84 MATERIAL AND LARGER PLACED AS FIELD DIRECTED. FILL VOIDS WITH REMAINING MATERIAL. TAMP TO FILL VOIDS. SEAL TOP WITH FINES SO WATER REMAINS FLOWING ON THE SURFACE. IF BEDROCK DEPTH PROHIBITS EMBEDMENT THEN D84 MATERIAL AND LARGER TO BE TRENCHED AND GROUTED INTO BEDROCK PER D-15 DETAIL.

LIFT WITH D84 (SEE ROCK SIZING TABLE) AND LARGER MATERIAL. FILL VOIDS WITH REMAINING MATERIAL. TAMP TO FILL VOIDS. SEAL TOP WITH FINES SO WATER REMAINS FLOWING ON THE SURFACE.

APPROXIMATE BEDROCK OR BOTTOM——OF 7 FT EMBEDMENT DEPTH

-CA: 1-800-422-4133-

CALL TWO WORKING DAYS BEFORE YOU DIG

C TYPICAL ESM LIFT PLACEMENT DETAIL SCALE: NO SCALE


UNAUTHORIZED CHANGES OR USES:
THE SANTA BARBARA COUNTY FLOOD CONTROL & WATER CONSERVATION DISTRICT
AND ITS EMPLOYEES WILL NOT BE RESPONSIBLE FOR, OR LIABLE FOR, UNAUTHORIZED
CHANGES TO OR USES OF THESE PLANS. ALL PROPOSED CHANGES TO THE PLANS
MUST BE PRESENTED IN WRITING TO THE DISTRICT AND APPROVED IN WRITING BY THE
DISTRICT PRIOR TO IMPLEMENTATION OF ANY SUCH CHANGE OR USE.

ROCK SIZING

ENGINEERED STREAMBED MATERIAL (ESM)
(INCLUDES HABITAT BOULDERS AND TAIL POOL BOULDERS)

ROCK DIAMETER CLASSIFICATION	B-AXIS SIZE RANGE	<u>%</u>
D100	>5.9 FT	16
D84	2.4-5.9 FT	34
D50	1.0-2.4 FT	34
D16	0.084-12 IN	11
	< 0.084 IN (NO.8 SEIVE)	5

VOLUME PERCENT OF MIX

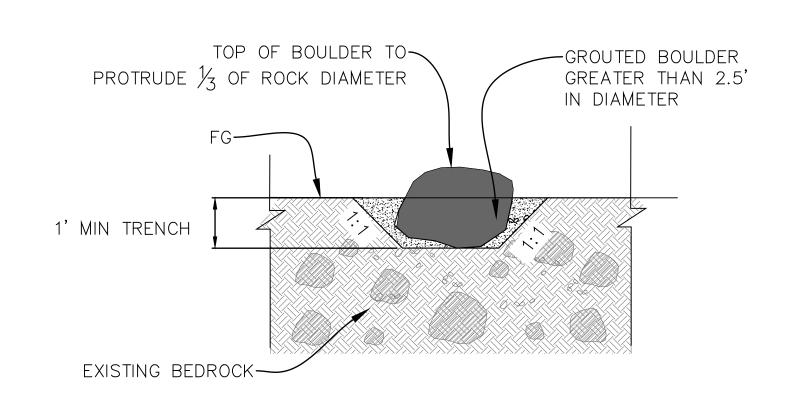

TYPICAL TRENCHED & GROUTED BOULDER DETAIL

SCALE: NO SCALE

(FOR USE WHERE BEDROCK DEPTH
PROHIBITS EMBEDMENT OF LARGE ESM MATERIAL)

NO.	REVISIONS DESCRIPTION DATE APR	LERD PROFESSIONAL EXPERIENCE P	DESIGNED BY: Sunta 11/03/2023 WRECO DATE	SANTA BARBARA COUNTY FLOOD CONTROL AND
		No. C88686		WATER CONSERVATION DISTR 130 E. VICTORIA STREET
		SATE OF CALIFORNIA		SANTA BARBARA, CA 93101 (805) 568-3440



COLD SPRINGS DEBRIS
BASIN IMPROVEMENTS PROJECT


AREA OF MONTECITO SANTA BARBARA COUNTY, CALIFORNIA

POOL, RIFFLE, AN
ESM DETAIL


ID	DESIGNED BY: LB	
	drawn by: MD	
	CHECKED BY:	S

LB		().	_1	15	6
AWN BY:		O	1	1)	U
ECKED BY:	S	HEET	15	OF	26

Filename: Cold Springs DB Plans.DWG

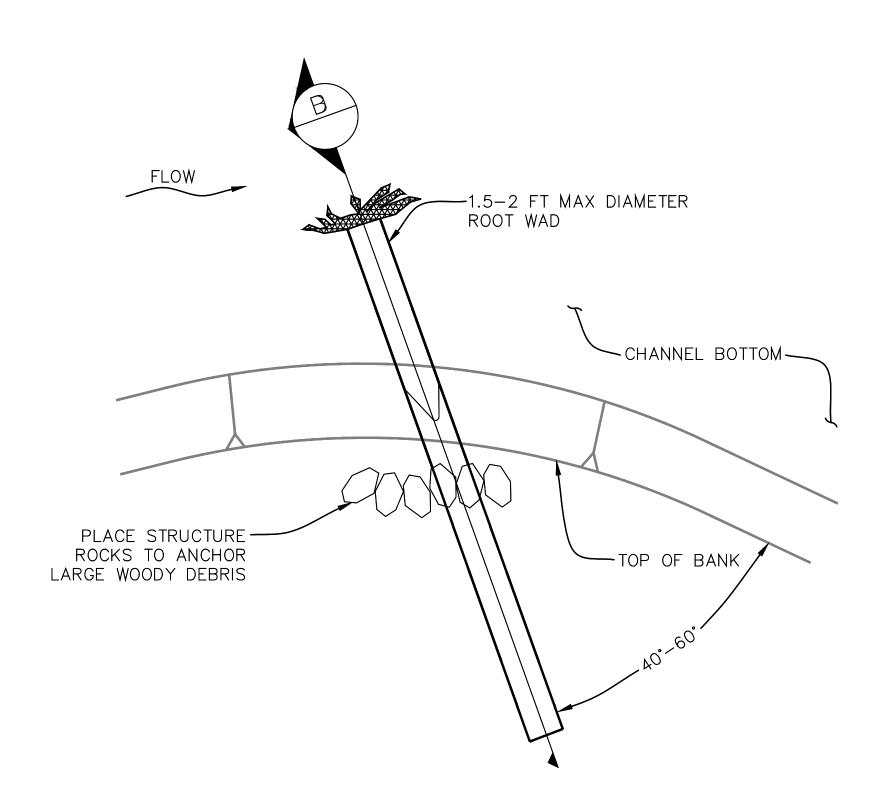



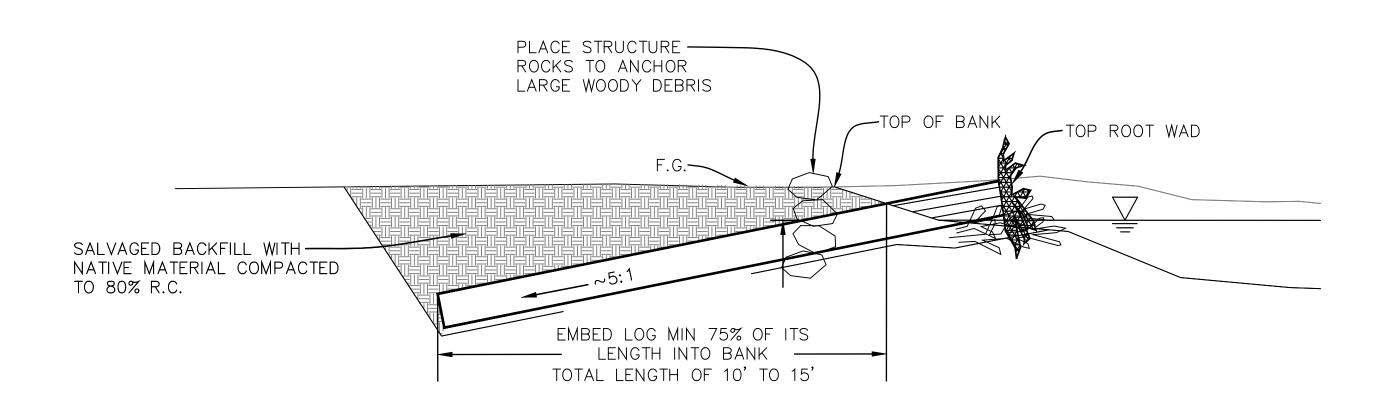

B SECTION VIEW-LARGE WOODY DEBRIS

UNAUTHORIZED CHANGES OR USES: THE SANTA BARBARA COUNTY FLOOD CONTROL & WATER CONSERVATION DISTRICT AND ITS EMPLOYEES WILL NOT BE RESPONSIBLE FOR, OR LIABLE FOR, UNAUTHORIZED CHANGES TO OR USES OF THESE PLANS. ALL PROPOSED CHANGES TO THE PLANS MUST BE PRESENTED IN WRITING TO THE DISTRICT AND APPROVED IN WRITING BY THE DISTRICT PRIOR TO IMPLEMENTATION OF ANY SUCH CHANGE OR USE.

ALL UNDERGROUND UTILITIES SHOWN ARE PLOTTED BASED ON INFORMATION PROVIDED BY OTHERS, AND ARE APPROXIMATE. OVERHEAD UTILITIES ARE NOT SHOWN. THE SANTA BARBARA COUNTY FLOOD CONTROL DISTRICT IS NOT RESPONSIBLE FOR THE ACCURACY OF THIS INFORMATION. CONTRACTOR SHALL NOTIFY UNDERGROUND SERVICE ALERT A MINIMUM OF TWO WORKING DAYS PRIOR TO COMMENCEMENT OF ANY EXCAVATION @ 1-800-422-4133.

REVISIONS			PROFESS/ON	DESIGNED BY: Sunla 11/03/2023	SANTA BARBARA COUNTY
DESCRIPTION	DATE	APR	LEREN SLEY BROOKS	WRECO DATE	FLOOD CONTROL AND
			No. C88686	V	WATER CONSERVATION DISTRICT
			Exp. 03/31/24		130 E. VICTORIA STREET
			ST CIVIL MA		SANTA BARBARA, CA 93101
			OF CALIFORN		(805) 568-3440



COLD SPRINGS DEBRIS BASIN IMPROVEMENT PROJECT AREA OF MONTECITO SANTA BARBARA COUNTY, CALIFORNIA

1. LARGE WOODY DEBRIS TREES TO BE PROVIDED BY AND CONVEYED TO THE PROJECT SITE BY THE COUNTY
2. LARGE WOODY DEBRIS FINAL PLACEMENT AND LOCATION TO BE FIELD DIRECTED BY COUNTY ENGINEER.
3. STRUCTURE ROCKS TO BE GREATER THAN 2.5 FT IN DIAMETER SHALL BE SELECTED AND PLACED AS

DIRECTED BY THE FIELD ENGINEER.

DETAILS


DESIGNED BY:	
LB	
DRAWN BY:	
MD	
CHECKED BY:	

Y:	O-	-1	15	6
Y:	SHEET	16	OF	26

Filename: Cold Springs DB Plans.DWG

CA: 1-800-422-4133 CALL TWO WORKING DAYS BEFORE YOU DIG

-CA: 1-800-422-4133-

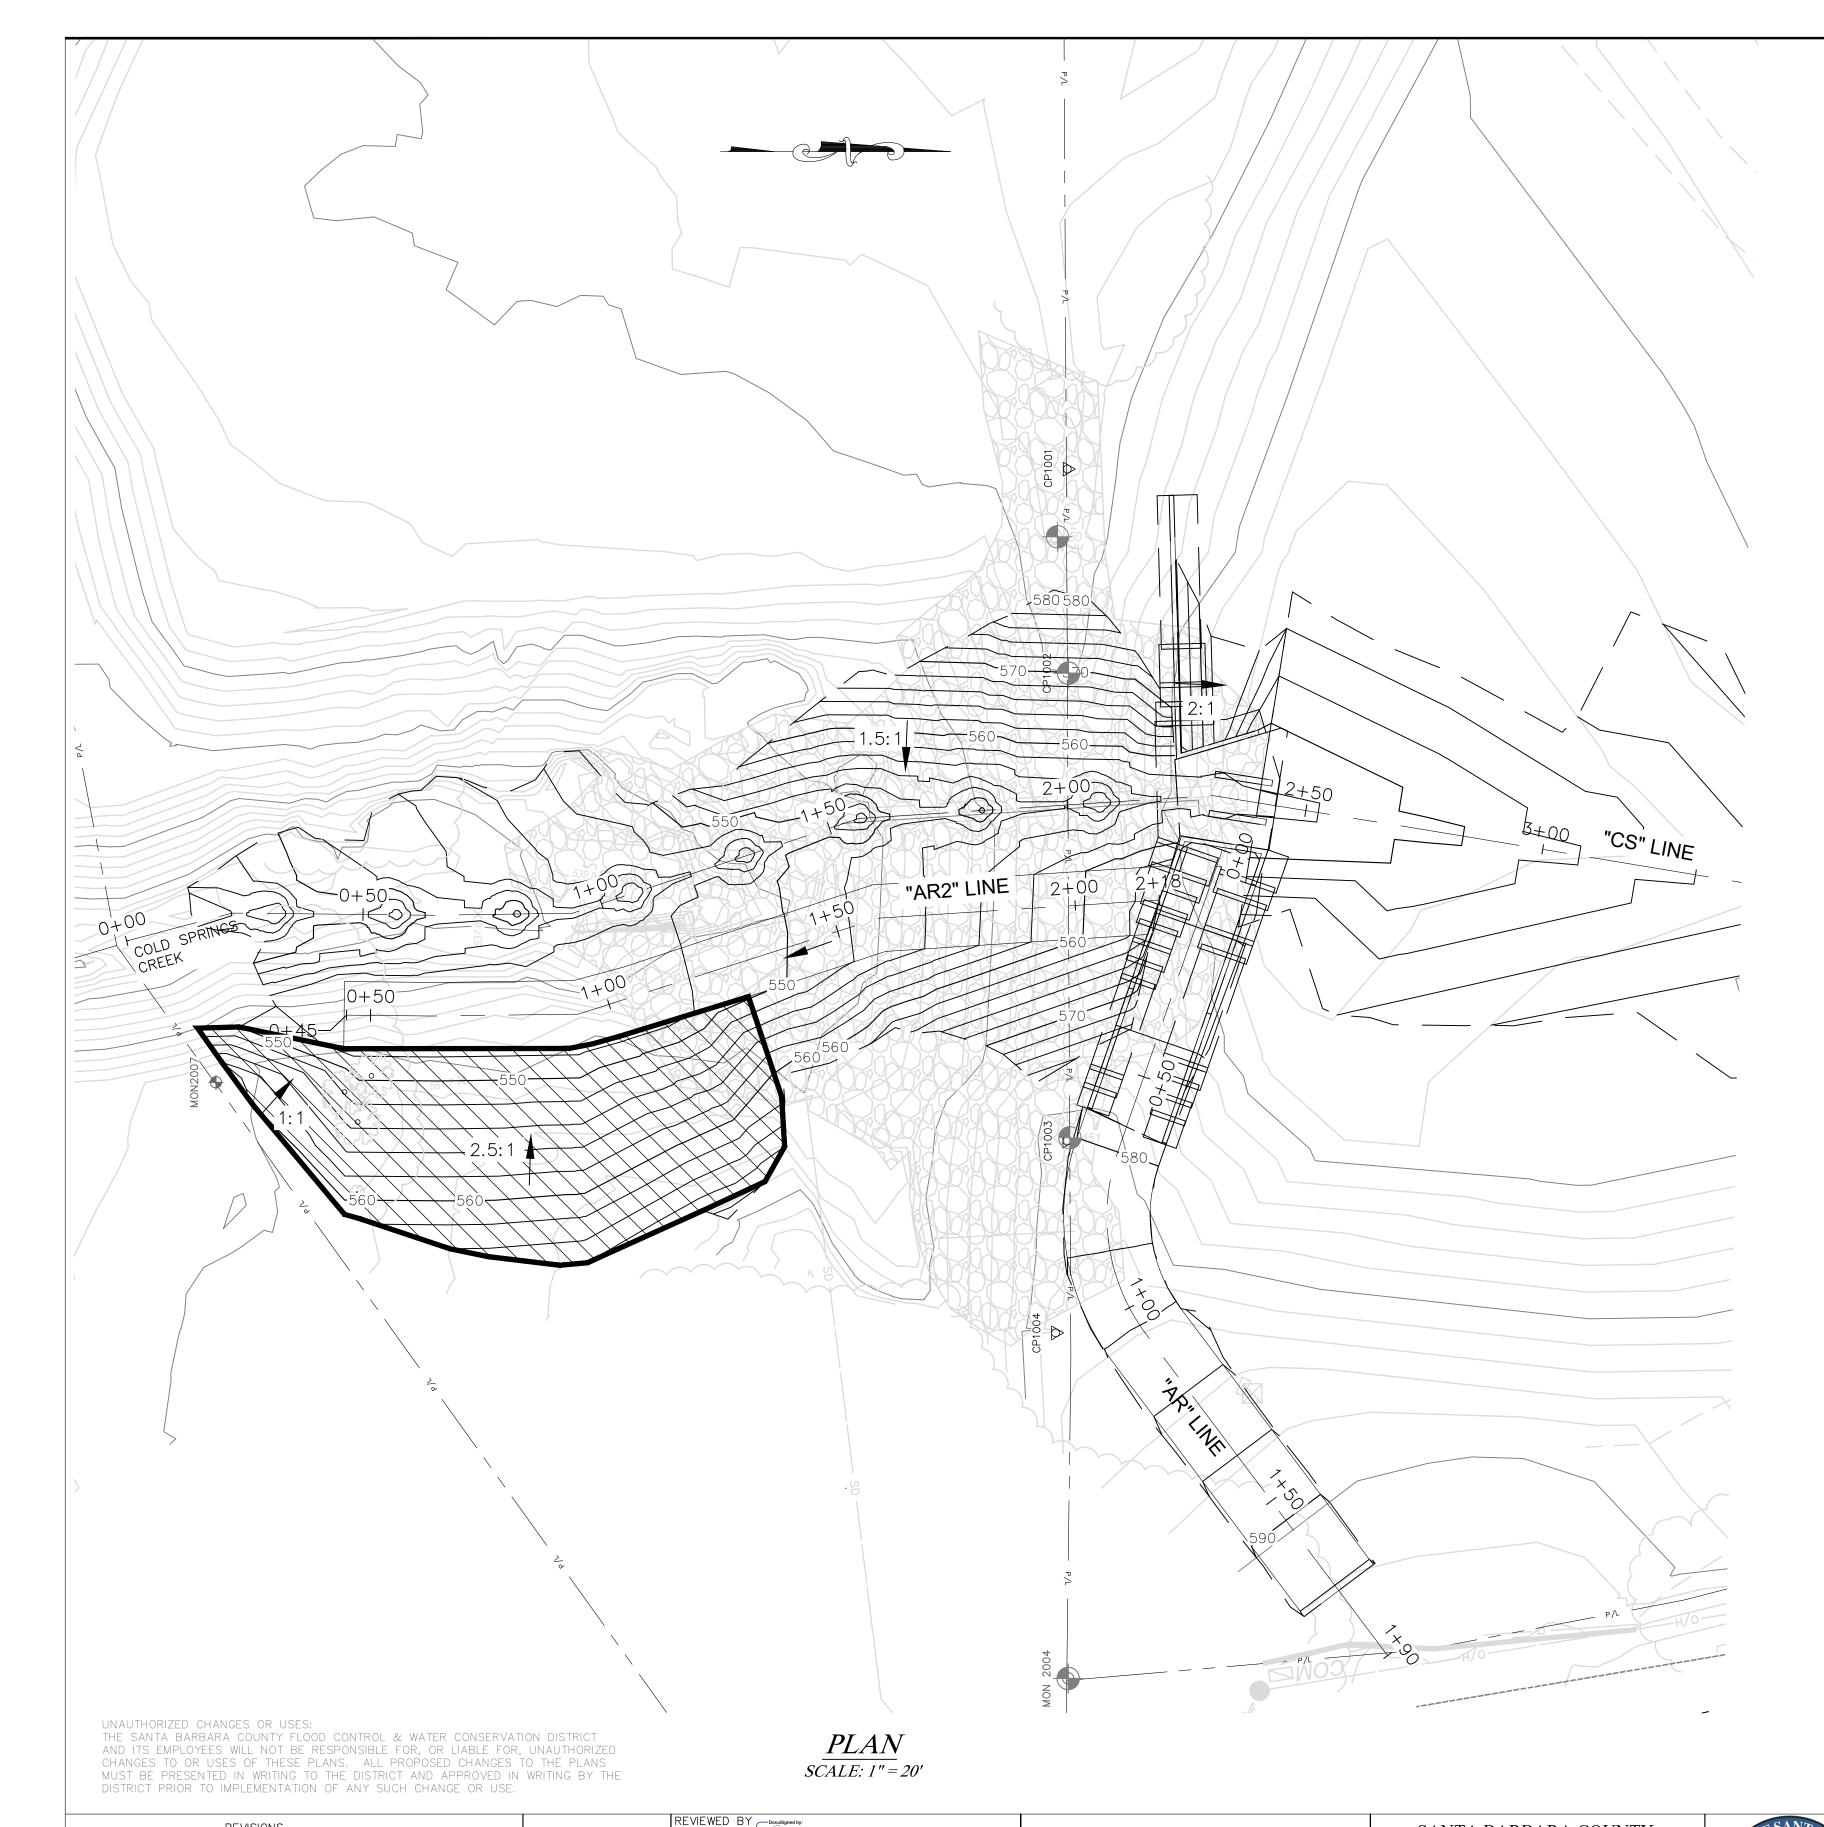

LEGEND

PLANTING AREA

Species	Number Planted
Toyon	10
Sycamore	15
Mulefat	15
alder	12
Lemonadeberry	10
Laurel sumac	18
Arroyo willow	15
Cyn sunflower	10
Elderberry	10
Mugwort	10
black sage	15
Calif Sagebrush	10
TOTAL PLANTS	150

GENERAL NOTES

- 1. PLANTS ARE BEING GROWN AT SANTA BARBARA NATIVES NURSERY UNDER SEPARATE CONTRACT.
- 2. REVEGETATION CONTRACTOR WILL ARRANGE FOR PICKUP AND DELIVERY OF PLANTS FROM THE NURSERY TO THE JOB SITE.

SANTA BARBARA NATIVES Inc. 14900 CALLE REAL GAVIOTA, CALIFORNIA 93117 EMAIL: JEFF@SBNATIVES.COM JEFF NIGHMAN: (805) 698-4994 JOHN WARNER: (805) 729-3855

- 3. PLANT INSTALLATION SHOULD OCCUR BETWEEN OCTOBER 15TH AND DECEMBER 1ST.
- 4. PLANTING AREA ENCOMPASSES 4600 SQUARE FEET. (SEE FIGURE).
- 5. ALL PLANTS WILL BE 1-GALLON CONTAINERS EXCEPT SYCAMORE AND ALDERS (MAY BE LARGER 5 TO 15-GALLON CONTAINERS).
- 6. INSTALL PLANTS IN A MIXED DISTRIBUTION PER FIELD DIRECTION BY DISTRICT STAFF.
- 7. DIG PLANTING PIT TWICE AS WIDE AND DEEP ENOUGH SO THAT THE TOP OF THE SOIL WITHIN CONTAINER IS LEVEL WITH TOP OF PIT AND PROVIDE SOIL AMENDMENT TO EACH PLANTING PIT.
- 8. BACKFILL EACH PLANTING PIT AND FORM A MOUND OF SOIL AROUND EACH PLANT TO FORM A WATERING BASIN.
- 9. PROVIDE INITIAL WATERING AFTER INSTALL, ENOUGH TO DELIVER 5—GALLONS OF WATER TO EACH PLANT WITHIN 24 HOURS OF PLANT INSTALLATION.
- 10. REMOVE WEEDS FROM EACH PLANTING BASIN.
- 11. MULCH EACH PLANTING BASIN TO A DEPTH OF 3-INCHES.
- 12. PLANTS TO BE WATERED ONCE PER WEEK UNTIL FINAL JOB COMPLETION SIGN OFF IS OBTAINED.
- 13. WATER IS NOT AVAILABLE ONSITE; CONTRACTOR TO DELIVER WATER TO THE SITE VIA WATER TRUCK SOURCED BY THE CONTRACTOR.



ALL UNDERGROUND UTILITIES SHOWN ARE PLOTTED BASED ON INFORMATION PROVIDED BY OTHERS, AND ARE APPROXIMATE. OVERHEAD UTILITIES ARE NOT SHOWN.

THE SANTA BARBARA COUNTY FLOOD CONTROL DISTRICT IS NOT RESPONSIBLE FOR THE ACCURACY OF THIS INFORMATION. CONTRACTOR SHALL NOTIFY UNDERGROUND SERVICE ALERT A MINIMUM OF TWO WORKING DAYS PRIOR TO COMMENCEMENT OF ANY EXCAVATION @ 1-800-422-4133.

REVISIONS		
DESCRIPTION	DATE	APR

12/20/2023 11:49 AM PST	SAN
ENVIRONMENTAL SERVICES MANAGER DATE	\mathbf{F}
	WATER
	130
	SAN



COLD SPRINGS DEBRIS BASIN IMPROVEMENT PROJECT


AREA OF MONTECITO SANTA BARBARA COUNTY, CALIFORNIA

PLANTING PLA	N
--------------	---

DESIGNED E
AR
DRAWN BY:
MD
CHECKED B
AR

O-11	56
------	----

SHEET 17 OF 26 Filename: Cold Springs DB Plans.DWG

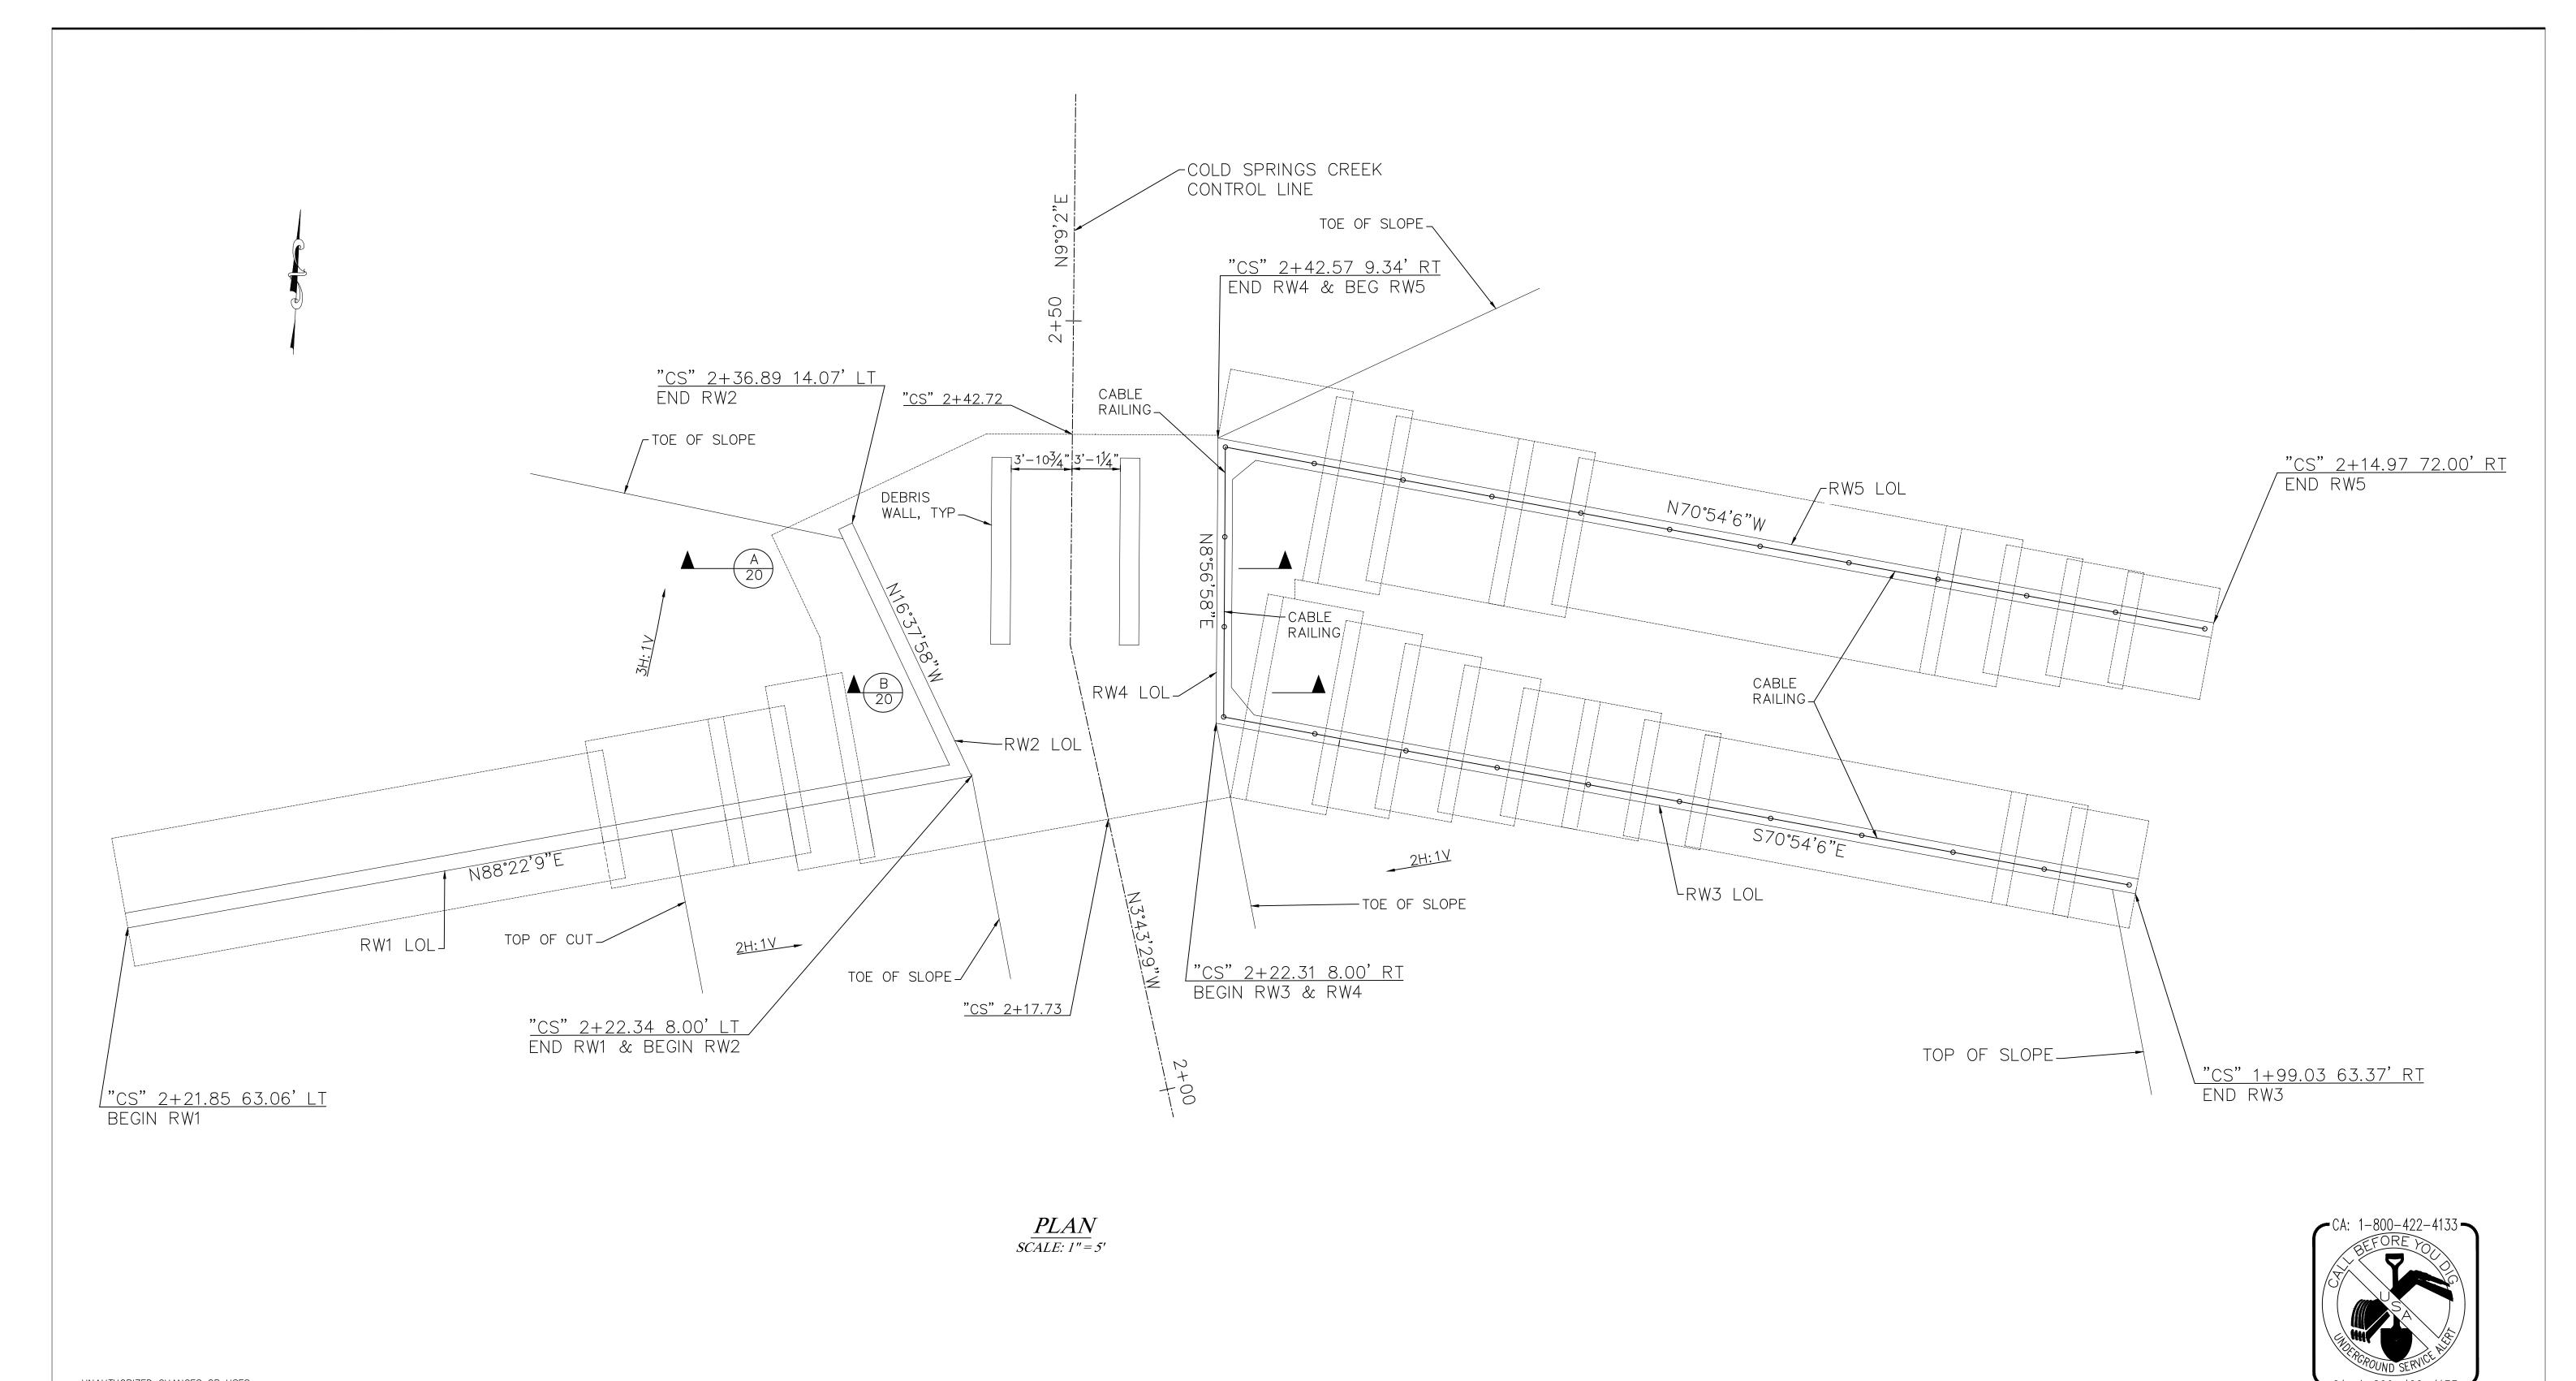

UNAUTHORIZED CHANGES OR USES: THE SANTA BARBARA COUNTY FLOOD CONTROL & WATER CONSERVATION DISTRICT AND ITS EMPLOYEES WILL NOT BE RESPONSIBLE FOR, OR LIABLE FOR, UNAUTHORIZED CHANGES TO OR USES OF THESE PLANS. ALL PROPOSED CHANGES TO THE PLANS MUST BE PRESENTED IN WRITING TO THE DISTRICT AND APPROVED IN WRITING BY THE DISTRICT PRIOR TO IMPLEMENTATION OF ANY SUCH CHANGE OR USE.

ALL UNDERGROUND UTILITIES SHOWN ARE PLOTTED BASED ON INFORMATION PROVIDED BY OTHERS, AND ARE APPROXIMATE. OVERHEAD UTILITIES ARE NOT SHOWN.

THE SANTA BARBARA COUNTY FLOOD CONTROL DISTRICT IS NOT RESPONSIBLE FOR THE ACCURACY OF THIS INFORMATION. CONTRACTOR SHALL NOTIFY UNDERGROUND SERVICE ALERT A MINIMUM OF TWO WORKING DAYS PRIOR TO COMMENCEMENT OF ANY EXCAVATION @ 1-800-422-4133.

OUTLET
STRUCTURE PLAN

DESIGNED BY:	
DRAWN BY: SC	
30	
CHECKED BY:	S
IR	

O-1156

CALL TWO WORKING DAYS BEFORE YOU DIG


SHEET 18 OF 26 Filename: Cold Springs DB Plans.DWG


John Bish REVISIONS 11/03/2023 DATE APR DESCRIPTION BISHOP ENGINEERING No. S 4059 Exp. 9/30/25

SANTA BARBARA COUNTY FLOOD CONTROL AND WATER CONSERVATION DISTRICT 130 E. VICTORIA STREET SANTA BARBARA, CA 93101 (805) 568-3440

COLD SPRINGS DEBRIS BASIN IMPROVEMENT PROJECT AREA OF MONTECITO

SANTA BARBARA COUNTY, CALIFORNIA

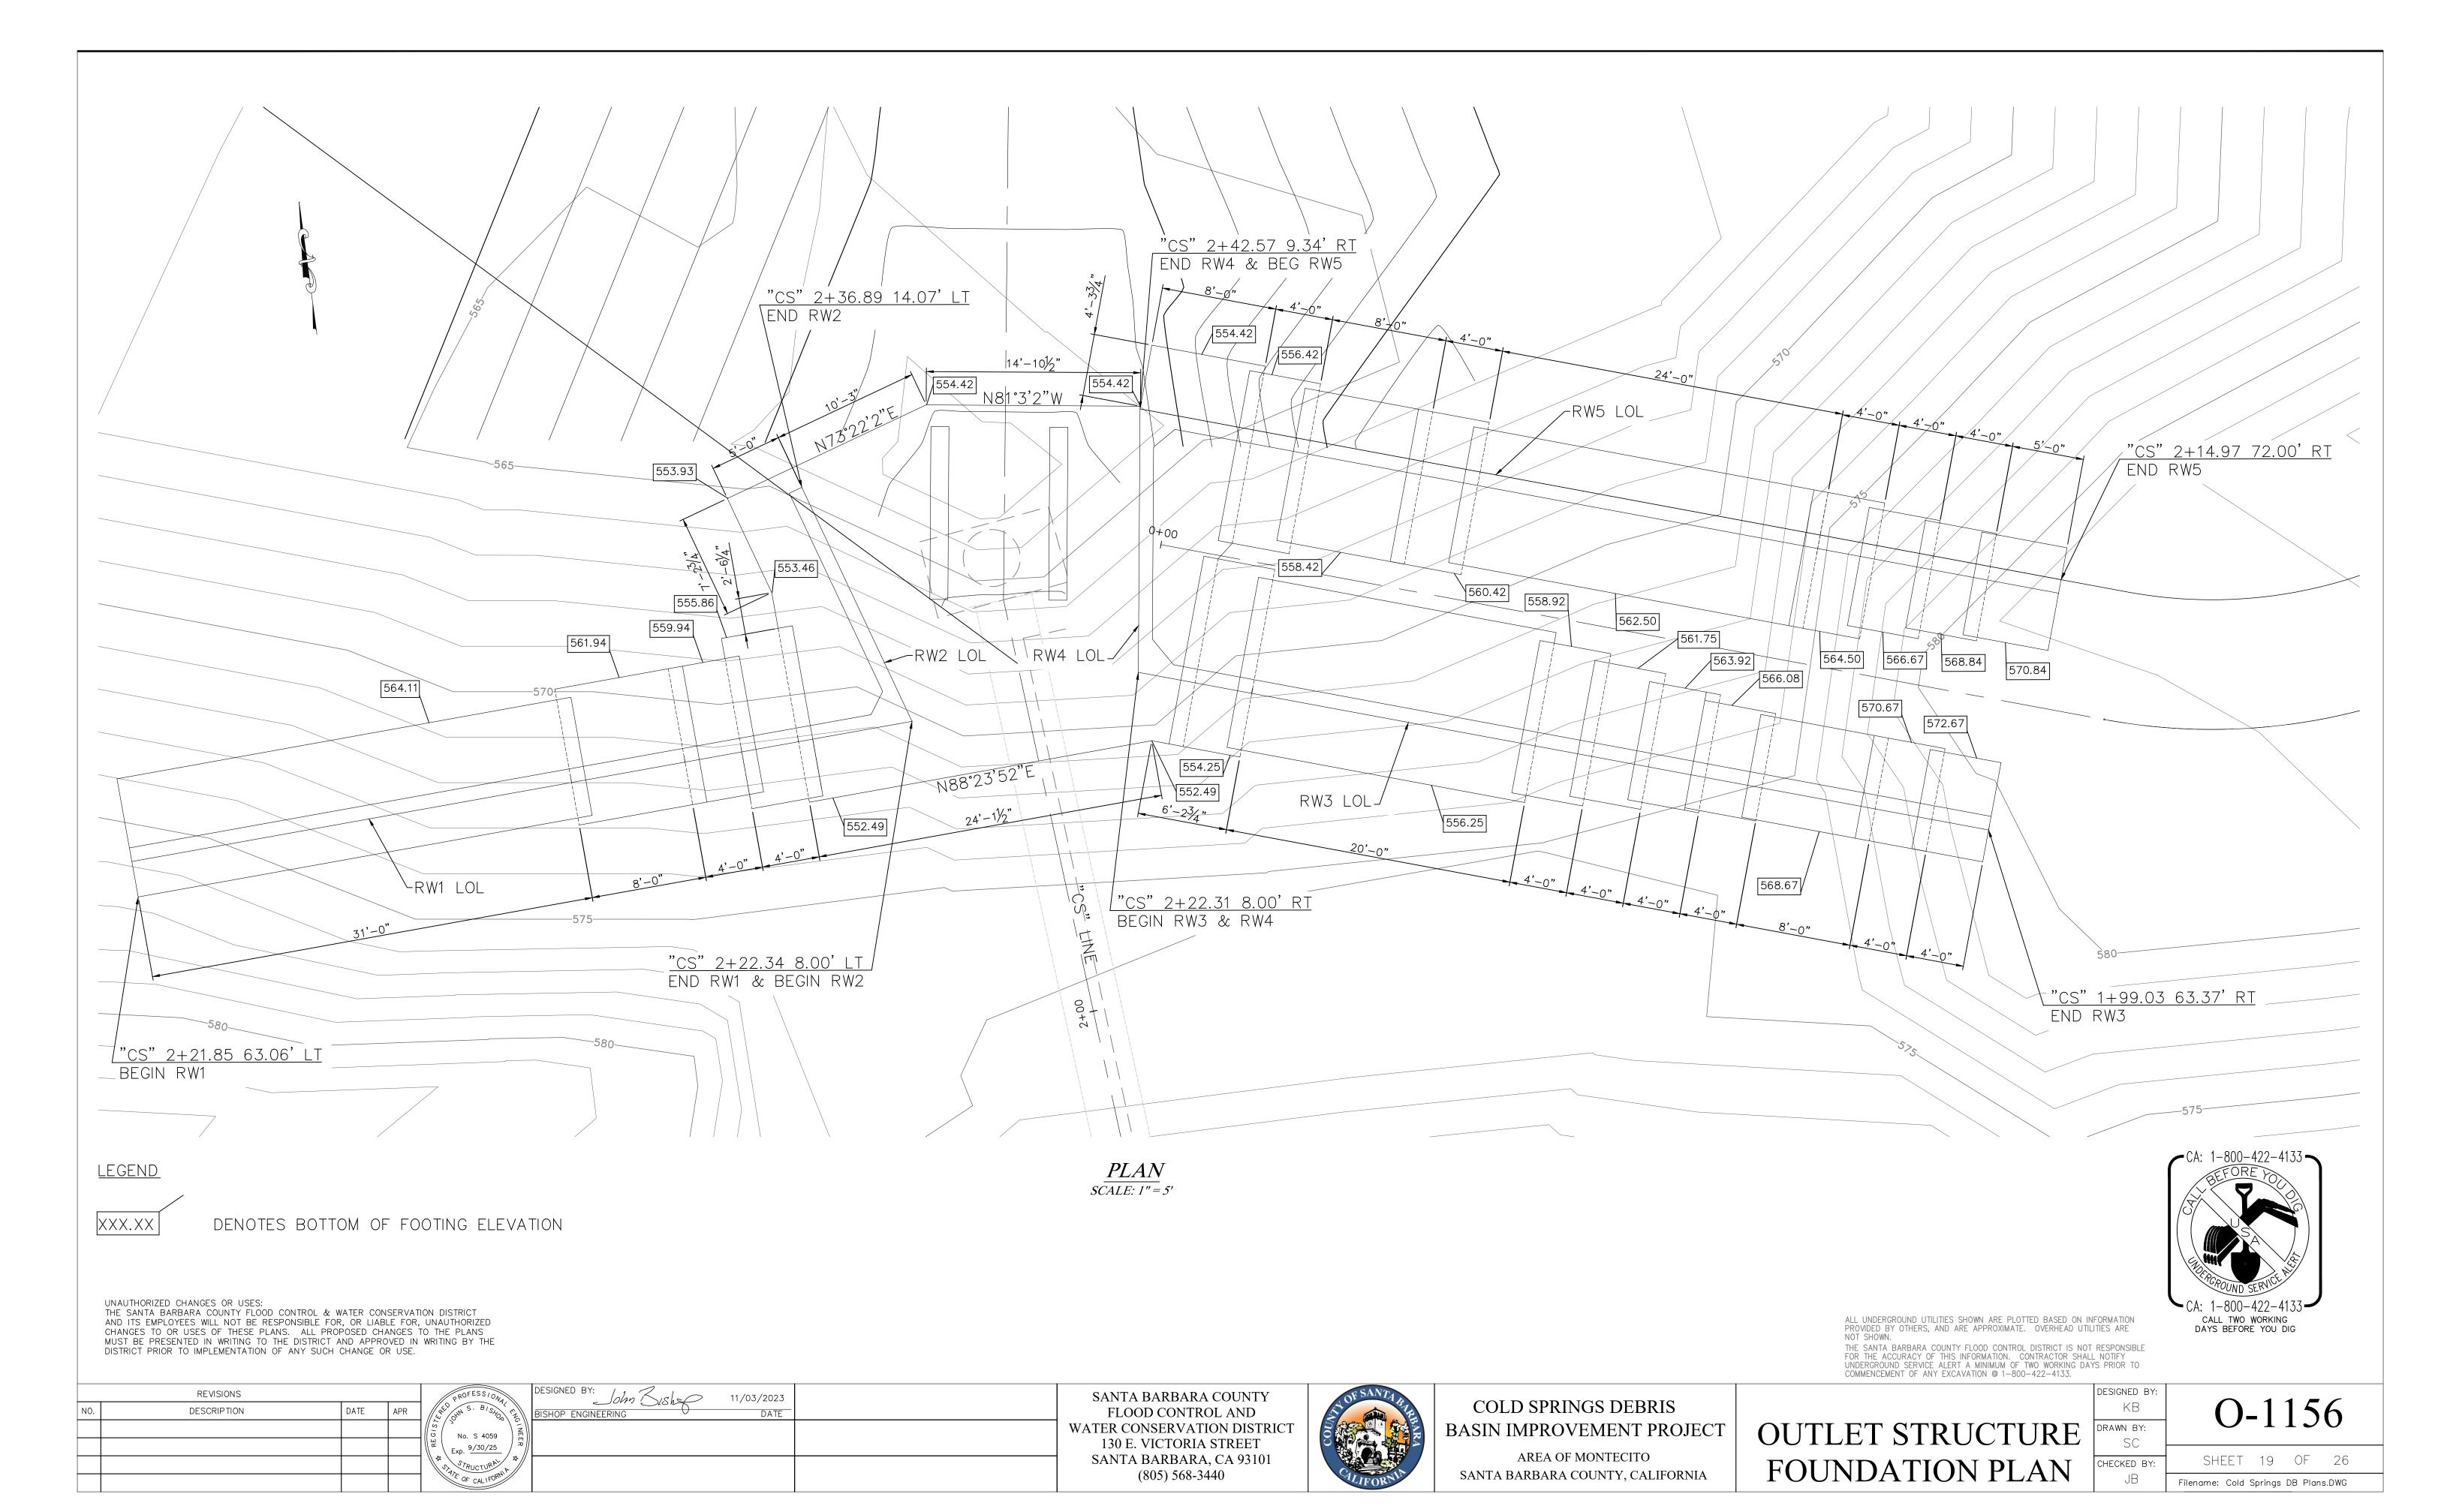

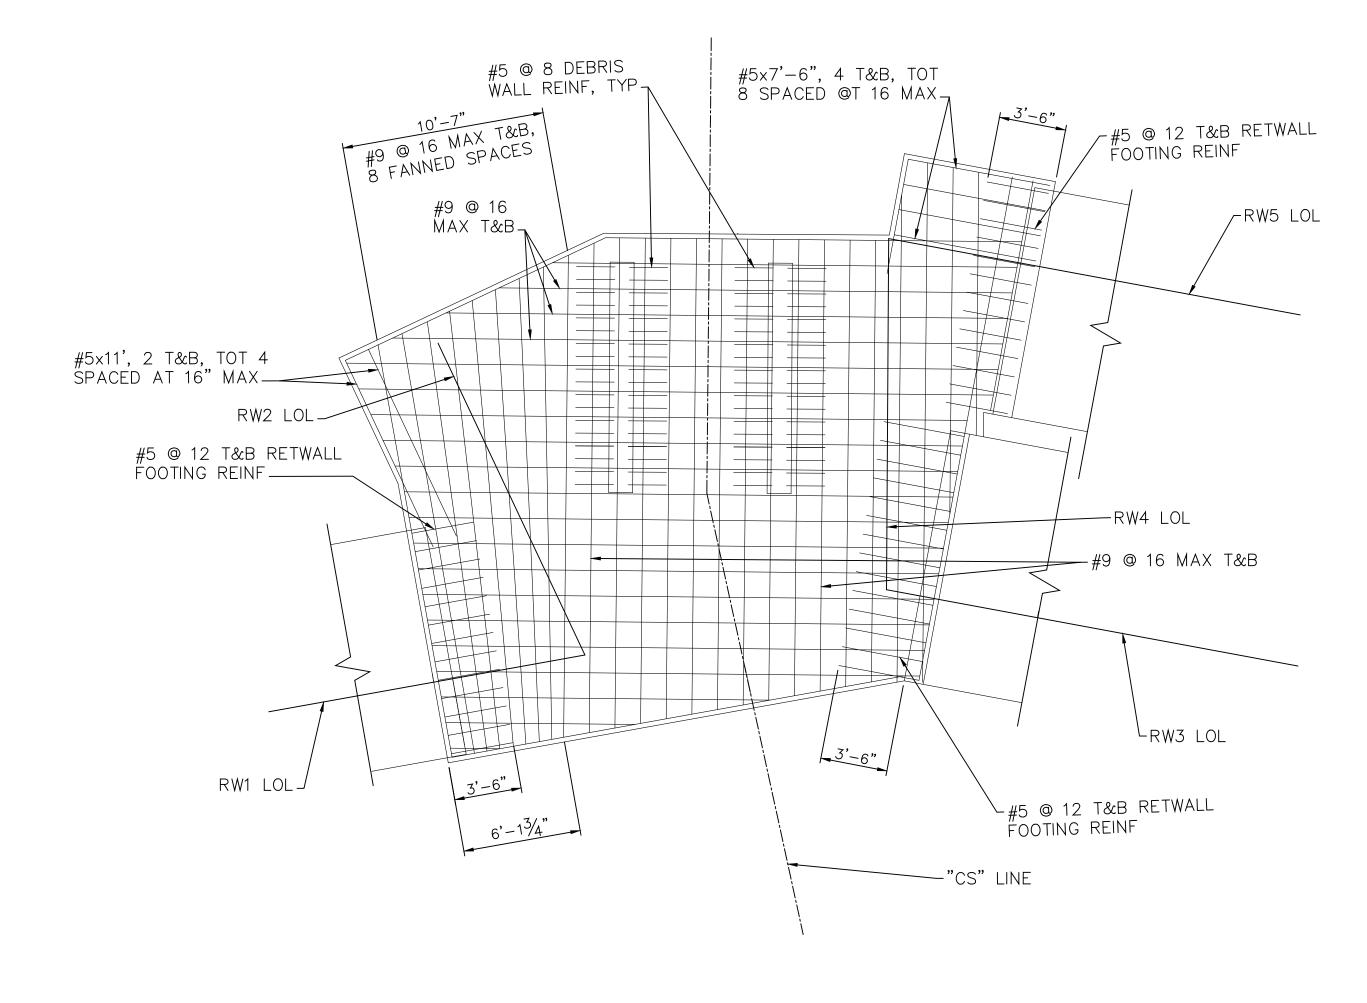

PLANSCALE: 1" = 5'



UNAUTHORIZED CHANGES OR USES:

THE SANTA BARBARA COUNTY FLOOD CONTROL & WATER CONSERVATION DISTRICT AND ITS EMPLOYEES WILL NOT BE RESPONSIBLE FOR, OR LIABLE FOR, UNAUTHORIZED CHANGES TO OR USES OF THESE PLANS. ALL PROPOSED CHANGES TO THE PLANS MUST BE PRESENTED IN WRITING TO THE DISTRICT AND APPROVED IN WRITING BY THE DISTRICT PRIOR TO IMPLEMENTATION OF ANY SUCH CHANGE OR USE.

REVISIONS		PROFESS/ONA	DESIGNED BY: John 7/8h 11/03/2023	SANTA BARBARA COUNTY
DESCRIPTION DATE	APR	LA ONN S. BISHOW MY	BISHOP ENGINEERING DATE	FLOOD CONTROL AND
		No. S 4059		WATER CONSERVATION DISTRIC
		$ \begin{array}{c c} & \text{We} \\ & \text{Exp. } 9/30/25 \end{array} $		130 E. VICTORIA STREET
		STRUCTURAL A		SANTA BARBARA, CA 93101
		OF CALIFORN		(805) 568-3440



COLD SPRINGS DEBRIS BASIN IMPROVEMENT PROJECT

AREA OF MONTECITO SANTA BARBARA COUNTY, CALIFORNIA

SLAB REINFORCING
PLAN

ALL UNDERGROUND UTILITIES SHOWN ARE PLOTTED BASED ON INFORMATION PROVIDED BY OTHERS, AND ARE APPROXIMATE. OVERHEAD UTILITIES ARE NOT SHOWN.

THE SANTA BARBARA COUNTY FLOOD CONTROL DISTRICT IS NOT RESPONSIBLE FOR THE ACCURACY OF THIS INFORMATION. CONTRACTOR SHALL NOTIFY UNDERGROUND SERVICE ALERT A MINIMUM OF TWO WORKING DAYS PRIOR TO COMMENCEMENT OF ANY EXCAVATION @ 1-800-422-4133.

ESIGNED BY: JB	\cap
RAWN BY: JB	
HECKED BY:	SHEET

0-	-1	1:	56)


20 OF 26 Filename: Cold Springs DB Plans.DWG

DESCRIPTION

DATE APR

No. S 4059

Exp. 9/30/25

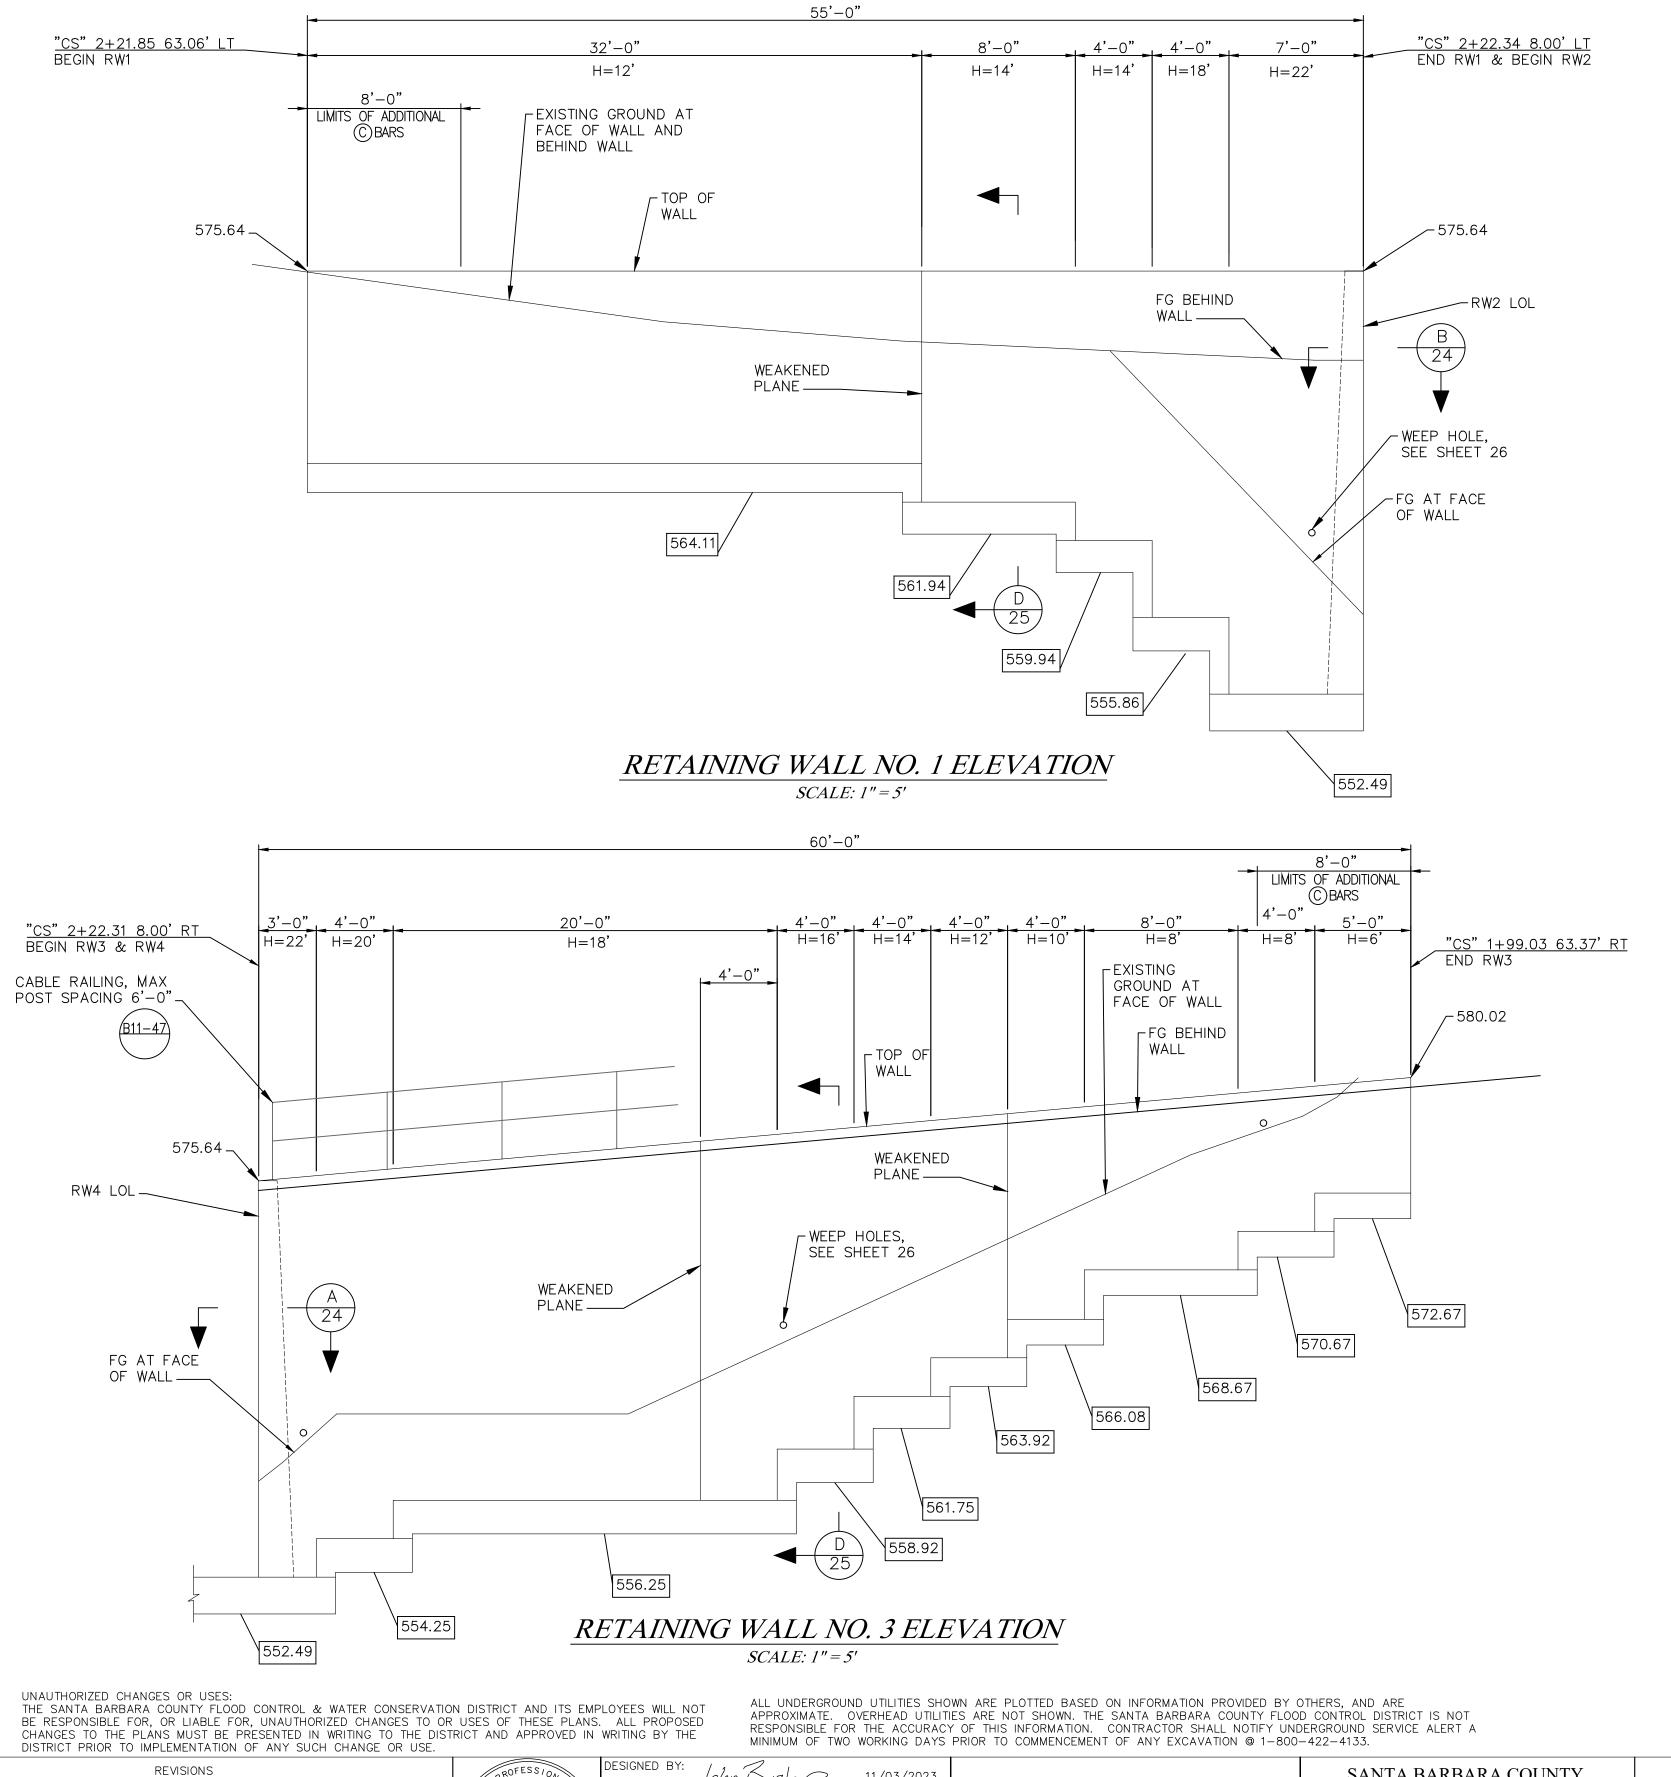


11/03/2023

BISHOP ENGINEERING

17**'**-0" "CS" 2+36.89 14.07' LT END RW2 "CS" 2+22.34 8.00' LT END RW1 & BEGIN RW2 H=22'LIMITS OF ADDITIONAL C BARS TOP OF 575.64 _ WALL —— -EXISTING GROUND AT RW1 LOL_ FACE OF WALL -FINISHED GRADE BEHIND WALL 24 -TOP OF WEEP HOLES, CONCRETE SLAB SEE SHEET 26 _TOP OF -555.05 RSP LBOTTOM OF CONCRETE SLAB

RETAINING WALL NO. 2 ELEVATION

SCALE: 1" = 5'

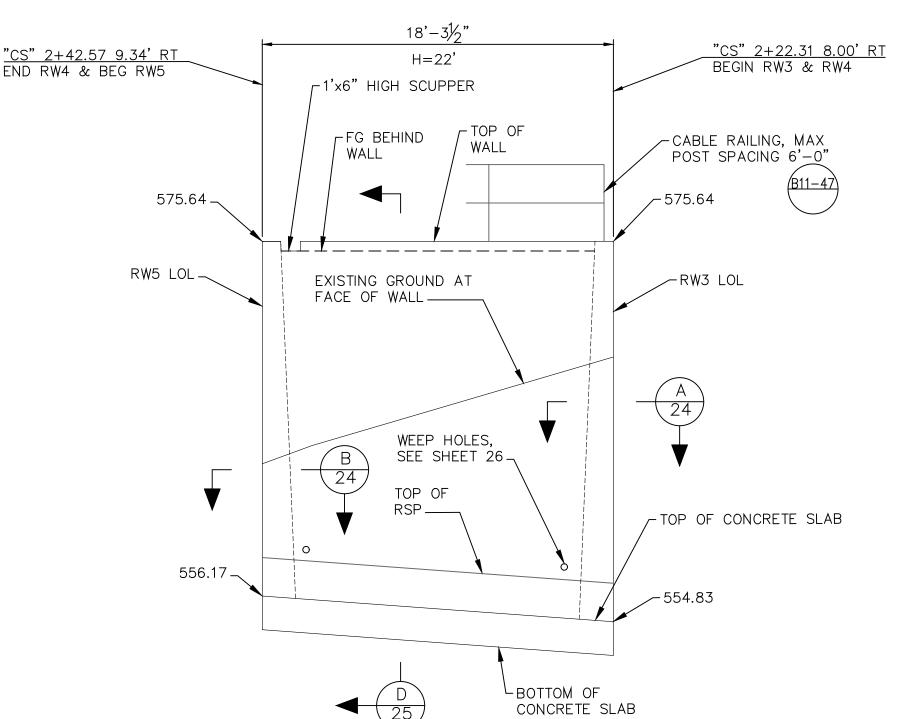

RETAINING WALL NO. 4 ELEVATION SCALE: 1" = 5'

<u>LEGEND</u>

DENOTES BOTTOM OF XXX.XX

NOTES:

- 1. FOR WEAKENED PLANE DETAIL, SEE RETAINING WALL DETAILS NO. 2 SHEET.
- 2. SEE NOTE 2 IN "TABLE OF REINFORCING STEEL, DIMENSIONS AND DATA" ON PAGE 25 FOR ADDITIONAL (C) BAR INFORMATION.



CALL TWO WORKING DAYS BEFORE YOU DIG

COLD SPRINGS DEBRIS

AREA OF MONTECITO SANTA BARBARA COUNTY, CALIFORNIA **OUTLET STRUCTURE** ELEVATIONS NO. 1


KB	
DRAWN BY: SC	•
CHECKED BY:	SH

O-1156

HEET 21 OF 26 Filename: Cold Springs DB Plans.DWG

SANTA BARBARA COUNTY FLOOD CONTROL AND WATER CONSERVATION DISTRICT 130 E. VICTORIA STREET SANTA BARBARA, CA 93101 (805) 568-3440

BASIN IMPROVEMENT PROJECT

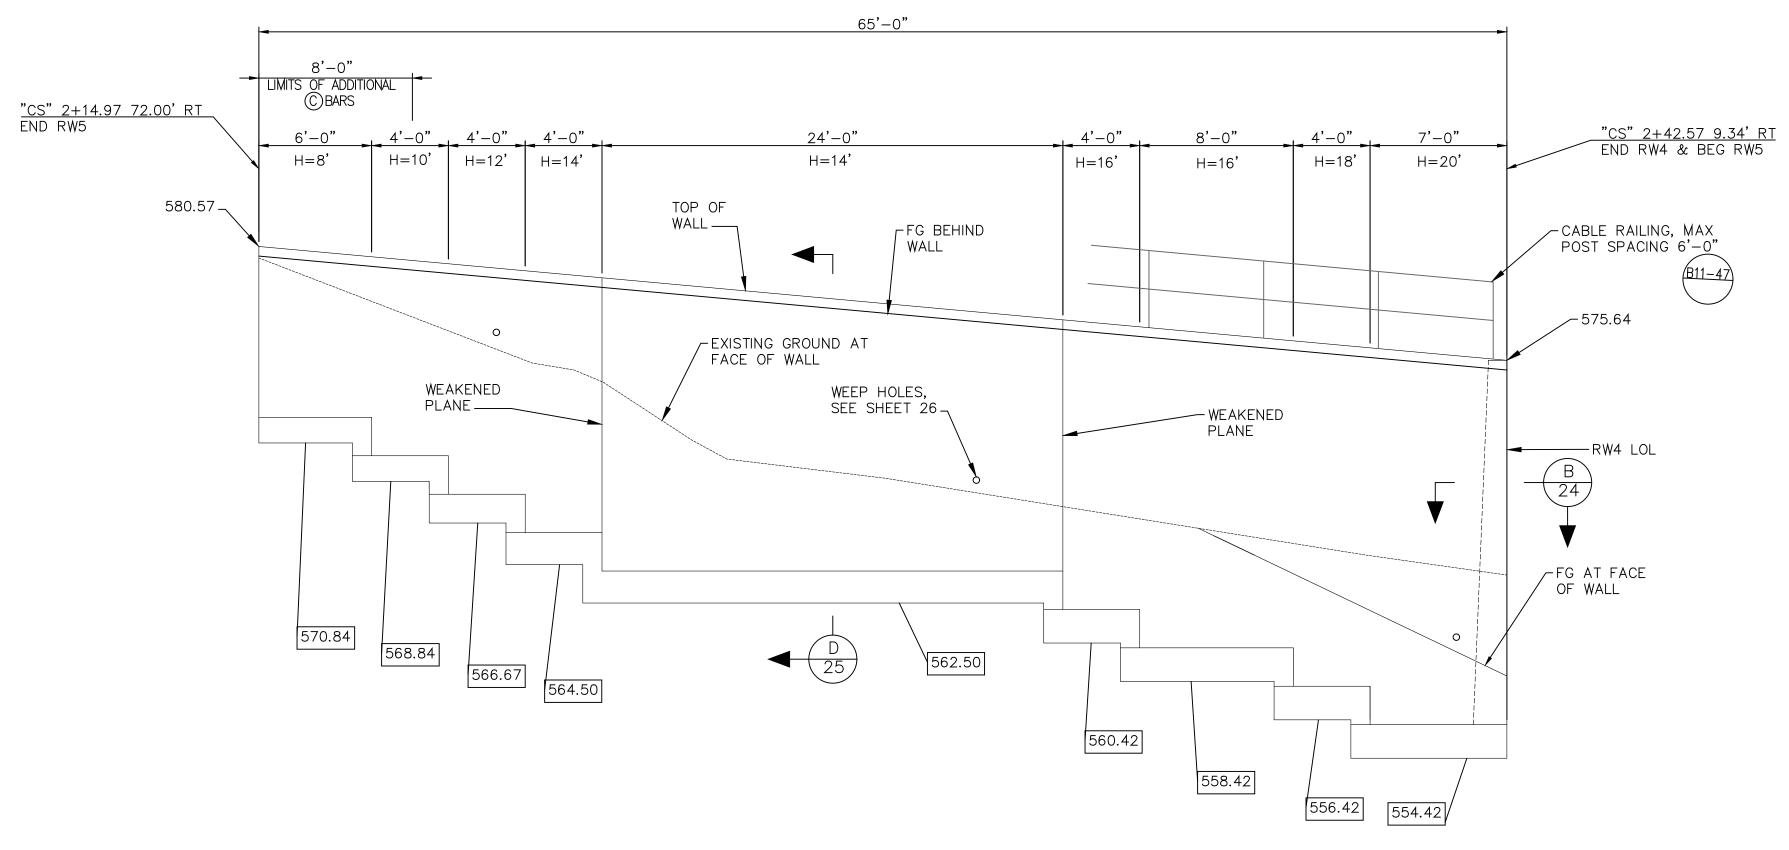

RETAINING WALL NO. 5 ELEVATION SCALE: 1" = 5'

SANTA BARBARA COUNTY

FLOOD CONTROL AND

130 E. VICTORIA STREET SANTA BARBARA, CA 93101

(805) 568-3440

<u>LEGEND</u>

XXX.XX

DENOTES BOTTOM OF FOOTING ELEVATION

UNAUTHORIZED CHANGES OR USES: THE SANTA BARBARA COUNTY FLOOD CONTROL & WATER CONSERVATION DISTRICT AND ITS EMPLOYEES WILL NOT BE RESPONSIBLE FOR, OR LIABLE FOR, UNAUTHORIZED

ALL UNDERGROUND UTILITIES SHOWN ARE PLOTTED BASED ON INFORMATION PROVIDED BY OTHERS, AND ARE APPROXIMATE. OVERHEAD UTILITIES ARE NOT SHOWN. THE SANTA BARBARA COUNTY FLOOD CONTROL DISTRICT IS NOT RESPONSIBLE FOR THE ACCURACY OF THIS INFORMATION. CONTRACTOR SHALL NOTIFY UNDERGROUND SERVICE ALERT A MINIMUM OF TWO WORKING DAYS PRIOR TO

CHANGES TO OR USES OF THESE PLANS. ALL PROPOSED CHANGES TO THE PLANS MUST BE PRESENTED IN WRITING TO THE DISTRICT AND APPROVED IN WRITING BY THE DISTRICT PRIOR TO IMPLEMENTATION OF ANY SUCH CHANGE OR USE. COMMENCEMENT OF ANY EXCAVATION @ 1-800-422-4133.

	REVISIONS			PROFESS/ON	DESIGNED BY: John Sish	11/03/2023	
NO.	DESCRIPTION	DATE	APR	OLIN S. BISHOP RIZ	BISHOP ENGINEERING	DATE	
				No. S 4059			
				Exp. 9/30/25			
				STRUCTURA			
				OF CALIFORN			



COLD SPRINGS DEBRIS BASIN IMPROVEMENT PROJECT AREA OF MONTECITO SANTA BARBARA COUNTY, CALIFORNIA

OUTLET STRUCTURE ELEVATIONS NO. 2

NOTES:

1. FOR WEAKENED PLANE DETAILS, SEE RETAINING WALL DETAILS NO. 2

2. SEE NOTE 2 IN "TABLE OF REINFORCING STEEL, DIMENSIONS AND


DATA" ON PAGE 25 FOR ADDITIONAL © BAR INFORMATION.


KB DRAWN BY: SC	O-	-11	56
CHECKED BY:	SHEET	22 ()F 26
JB	Filename: Cold	Springs DB	Plans.DWG


CA: 1-800-422-4133	
BEFORE YOU	
GROUND SERVICE REP	
TOUND SERV	
CA: 1-800-422-4133	
CALL TWO WORKING DAYS BEFORE YOU DIG	


NOTES:

1. ENHANCED-ROUGHNESS BOULDERS WITHIN DEBRIS WALLS TO INCLUDE AT LEAST FOUR LARGE BOULDERS (28-42" DIAMETER) FROM THE CLASS VI ROCK, WITH TWO BOULDERS PLACED ALONG THE EDGE OF EACH DEBRIS WALL, SPACED AT APPROXIMATELY 6' APART, AND PROTRUDING 1/3 TO 1/2 DIAMETER. GROUTED ROCK ESM PLACEMENT AND ENHANCED-ROUGHNESS BOULDERS WITHIN DEBRIS WALLS TO BE PLACED UNDER FIELD DIRECTION OF DISTRICT ENGINEERING/ENVIRONMENTAL STAFF.

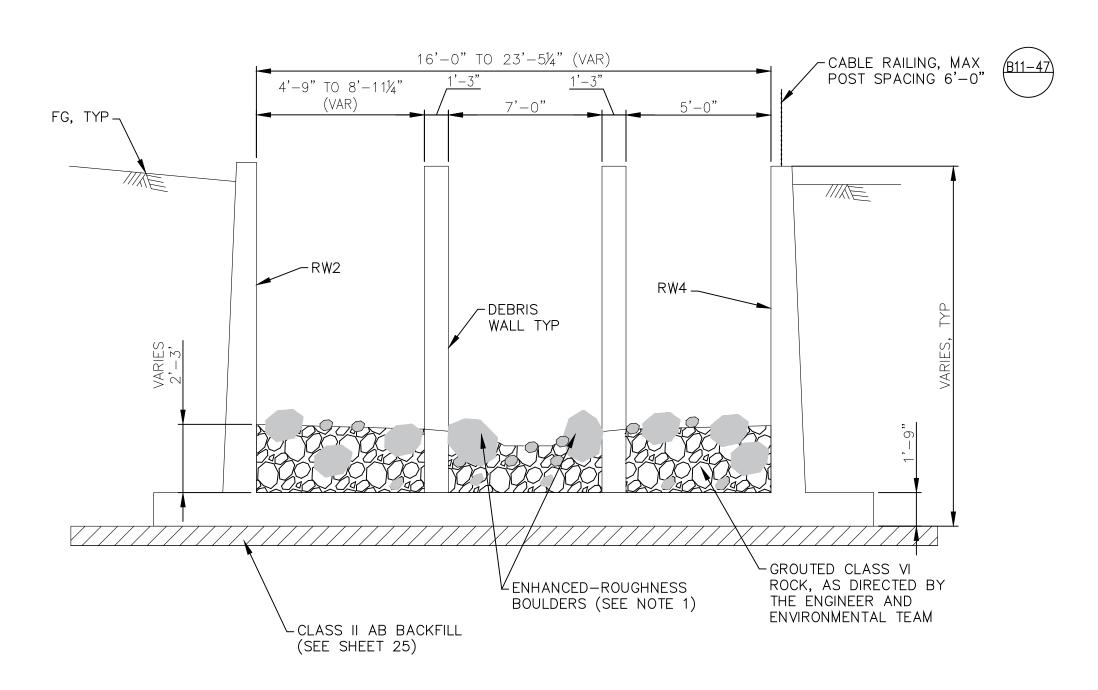

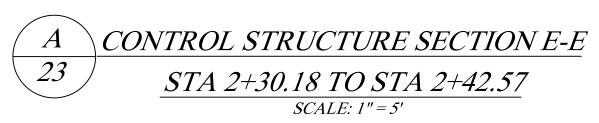

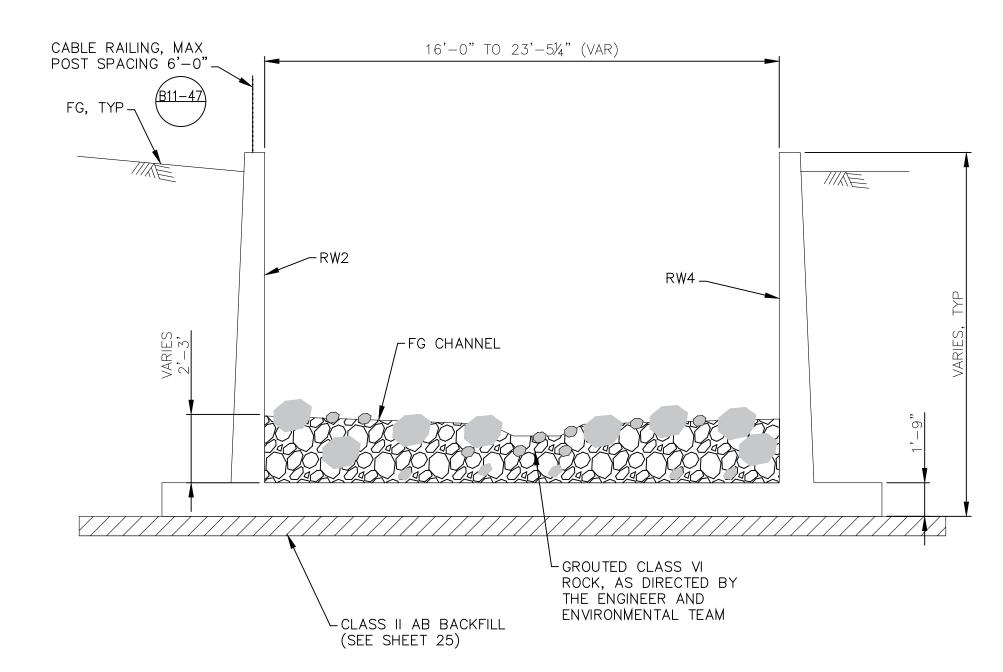

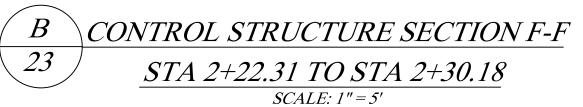



ALL UNDERGROUND UTILITIES SHOWN ARE PLOTTED BASED ON INFORMATION PROVIDED BY OTHERS, AND ARE APPROXIMATE. OVERHEAD UTILITIES ARE NOT SHOWN.

THE SANTA BARBARA COUNTY FLOOD CONTROL DISTRICT IS NOT RESPONSIBLE

THE SANTA BARBARA COUNTY FLOOD CONTROL DISTRICT IS NOT RESPONSIBLE FOR THE ACCURACY OF THIS INFORMATION. CONTRACTOR SHALL NOTIFY UNDERGROUND SERVICE ALERT A MINIMUM OF TWO WORKING DAYS PRIOR TO COMMENCEMENT OF ANY EXCAVATION @ 1-800-422-4133.

UNAUTHORIZED CHANGES OR USES:
THE SANTA BARBARA COUNTY FLOOD CONTROL & WATER CONSERVATION DISTRICT
AND ITS EMPLOYEES WILL NOT BE RESPONSIBLE FOR, OR LIABLE FOR, UNAUTHORIZED
CHANGES TO OR USES OF THESE PLANS. ALL PROPOSED CHANGES TO THE PLANS
MUST BE PRESENTED IN WRITING TO THE DISTRICT AND APPROVED IN WRITING BY THE
DISTRICT PRIOR TO IMPLEMENTATION OF ANY SUCH CHANGE OR USE.

NO.	REVISIONS DESCRIPTION	DATE	APR	PROFESSIONAL S. BISHOS CZ	DESIGNED BY: John Jish BISHOP ENGINEERING	/03/2023 DATE	SANTA BARBARA COUNTY FLOOD CONTROL AND
				No. S 4059 Exp. 9/30/25			WATER CONSERVATION DISTRICT 130 E. VICTORIA STREET
				TO STRUCTURAL A			SANTA BARBARA, CA 93101 (805) 568-3440



COLD SPRINGS DEBRIS BASIN IMPROVEMENT PROJECT


AREA OF MONTECITO SANTA BARBARA COUNTY, CALIFORNIA


OUTLET STRUCTURE
TYPICAL SECTIONS


DESIGNED BY:	\bigcirc	_1	15
DRAWN BY:	O	1	1)
CHECKED BY:	SHEET	23	OF

SHEET 23 OF 26

Filename: Cold Springs DB Plans.DWG

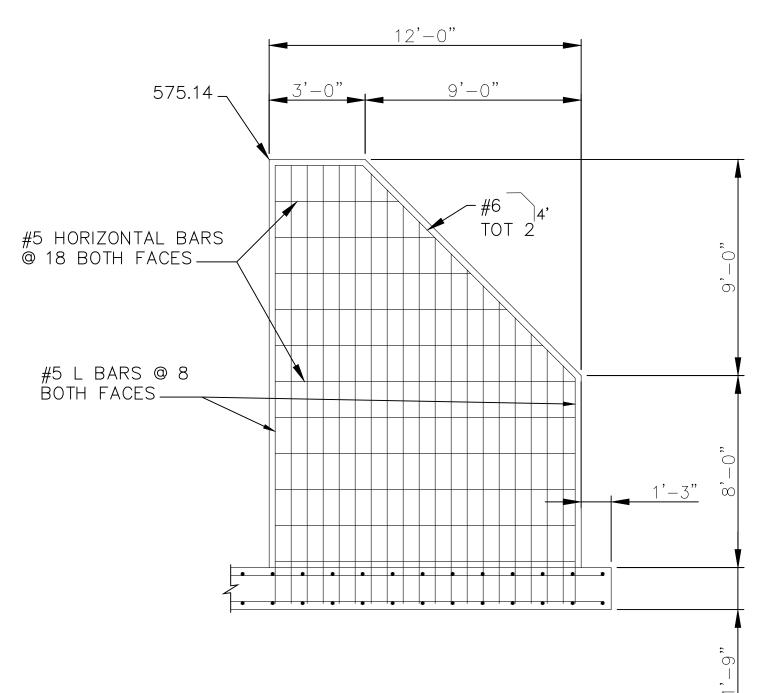

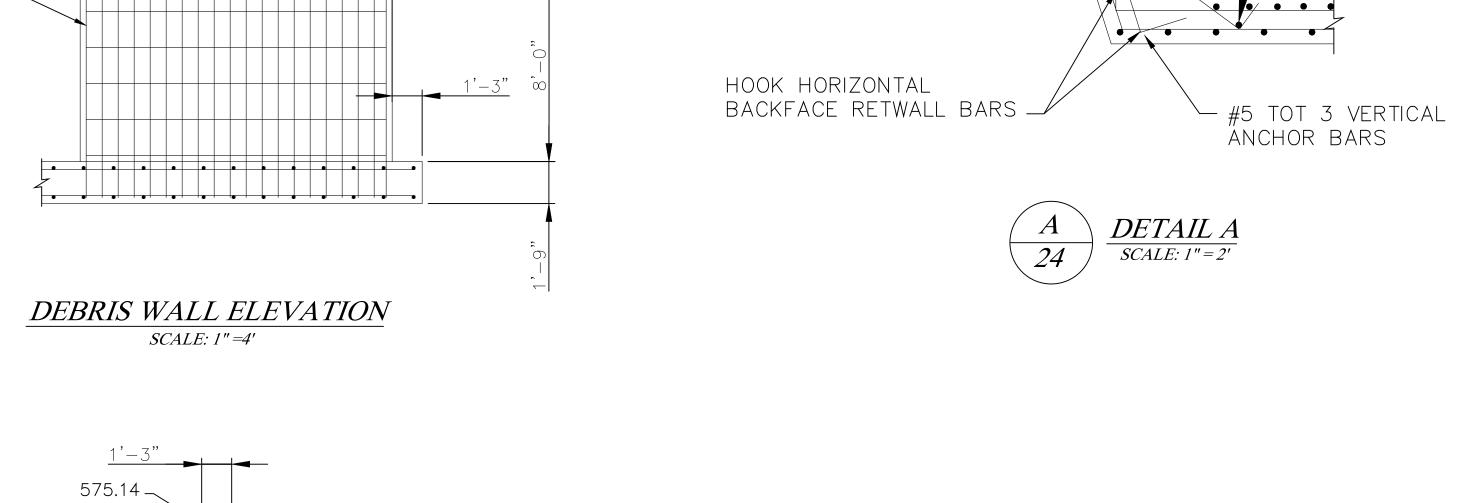

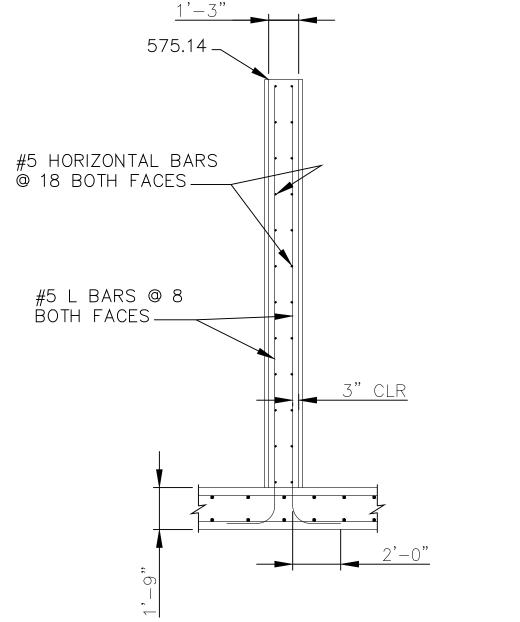

DEBRIS WALL SECTION SCALE: 1" = 4'

@ 12 MAY BE ROTATED FOR TAIL FITMENT IN STEM 1'-6" CHAMFER -



UNAUTHORIZED CHANGES OR USES: THE SANTA BARBARA COUNTY FLOOD CONTROL & WATER CONSERVATION DISTRICT AND ITS EMPLOYEES WILL NOT BE RESPONSIBLE FOR, OR LIABLE FOR, UNAUTHORIZED CHANGES TO OR USES OF THESE PLANS. ALL PROPOSED CHANGES TO THE PLANS MUST BE PRESENTED IN WRITING TO THE DISTRICT AND APPROVED IN WRITING BY THE

DISTRICT PRIOR TO IMPLEMENTATION OF ANY SUCH CHANGE OR USE.

ALL UNDERGROUND UTILITIES SHOWN ARE PLOTTED BASED ON INFORMATION PROVIDED BY OTHERS, AND ARE APPROXIMATE. OVERHEAD UTILITIES ARE NOT SHOWN.
THE SANTA BARBARA COUNTY FLOOD CONTROL DISTRICT IS NOT RESPONSIBLE FOR THE ACCURACY OF THIS INFORMATION. CONTRACTOR SHALL NOTIFY UNDERGROUND SERVICE ALERT A MINIMUM OF TWO WORKING DAYS PRIOR TO COMMENCEMENT OF ANY EXCAVATION @ 1-800-422-4133.

	REVISIONS			PROFESS/ON	DESIGNED BY: 11/03/2023		SANTA BARBARA COUNTY
NO.	DESCRIPTION	DATE	APR	S. BISHOR F.	BISHOP ENGINEERING DATE	_	FLOOD CONTROL AND
				No. S 4059			WATER CONSERVATION DISTRICT
				Exp. 9/30/25			130 E. VICTORIA STREET
				STRUCTURAL A			SANTA BARBARA, CA 93101
		1		OF CALIFORNI			(805) 568-3440



@ 12 MAY BE ROTATED

FOR TAIL FITMENT IN STEM

1'-6" CHAMFER

COLD SPRINGS DEBRIS BASIN IMPROVEMENTS PROJECT AREA OF MONTECITO SANTA BARBARA COUNTY, CALIFORNIA

OUTLET	DRAWN BY: SC
STRUCTURE DETAILS	CHECKED BY: JB

	CA: 1-800-422-4133- CALL TWO WORKING DAYS BEFORE YOU DIG
DESIGNED BY:	O-1156
DRAWN BY:	0 1130
CHECKED BY:	SHEET 24 OF 26

Filename: Cold Springs DB Plans.DWG

► CA: 1-800-422-4133 **-**

UNAUTHORIZED CHANGES OR USES:


THE SANTA BARBARA COUNTY FLOOD CONTROL & WATER CONSERVATION DISTRICT

DISTRICT PRIOR TO IMPLEMENTATION OF ANY SUCH CHANGE OR USE.

AND ITS EMPLOYEES WILL NOT BE RESPONSIBLE FOR, OR LIABLE FOR, UNAUTHORIZED

MUST BE PRESENTED IN WRITING TO THE DISTRICT AND APPROVED IN WRITING BY THE

CHANGES TO OR USES OF THESE PLANS. ALL PROPOSED CHANGES TO THE PLANS

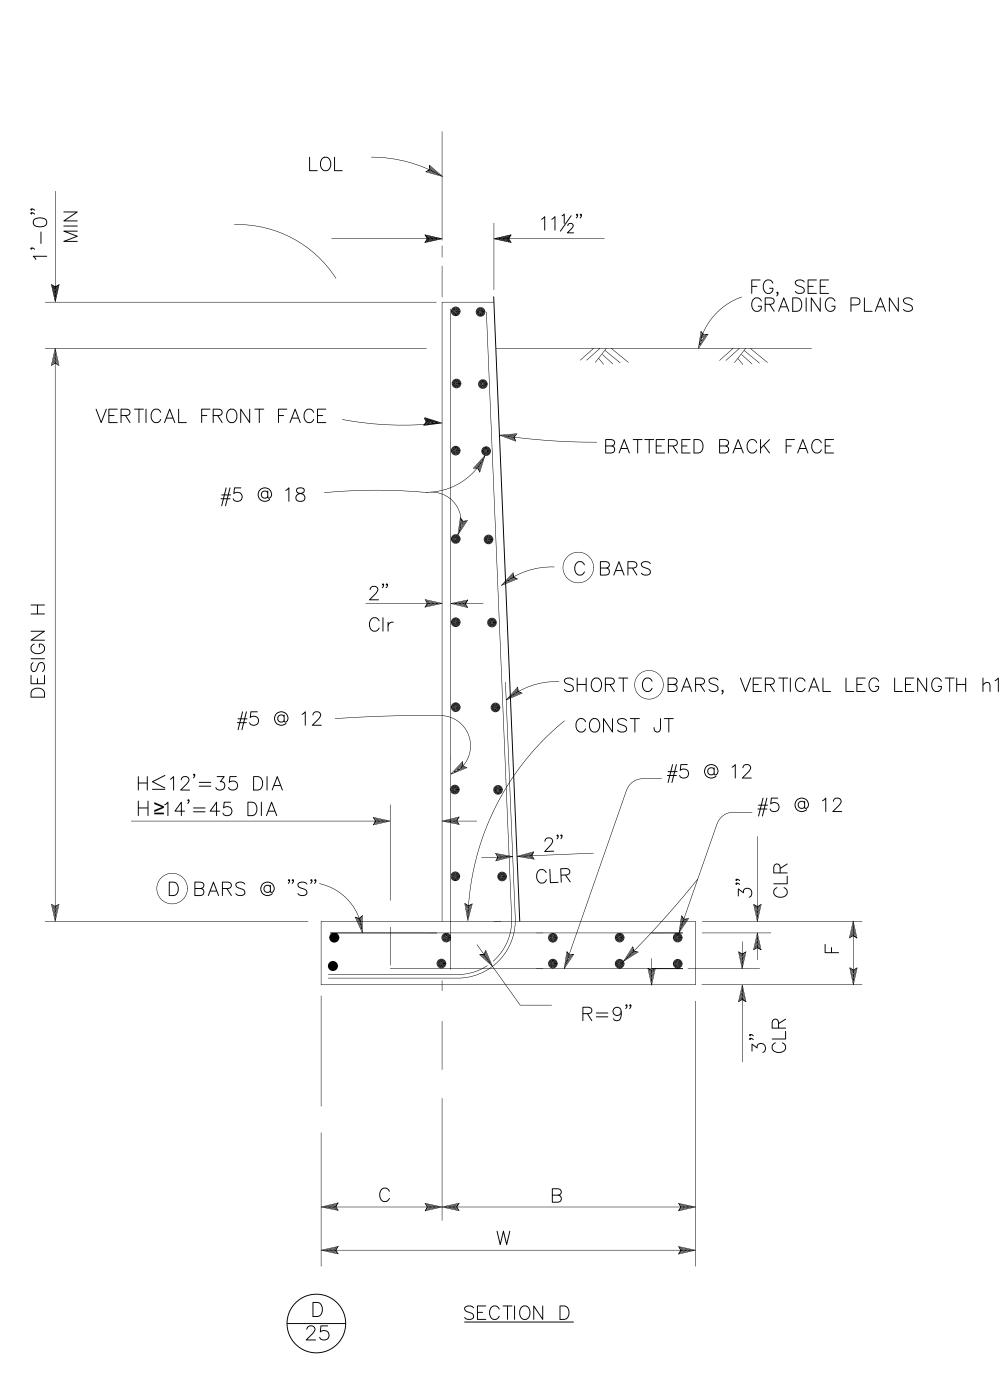

PLACE CONCRETE IN TOE AGAINST UNDISTURBED MATERIAL, EXCEPT AS PERMITTED BY THE ENGINEER.

PROVIDED BY OTHERS, AND ARE APPROXIMATE. OVERHEAD UTILITIES ARE NOT SHOWN. THE SANTA BARBARA COUNTY FLOOD CONTROL DISTRICT IS NOT RESPONSIBLE FOR THE ACCURACY OF THIS INFORMATION. CONTRACTOR SHALL NOTIFY UNDERGROUND SERVICE ALERT A MINIMUM OF TWO WORKING DAYS PRIOR TO COMMENCEMENT OF ANY EXCAVATION @ 1-800-422-4133.

ALL UNDERGROUND UTILITIES SHOWN ARE PLOTTED BASED ON INFORMATION

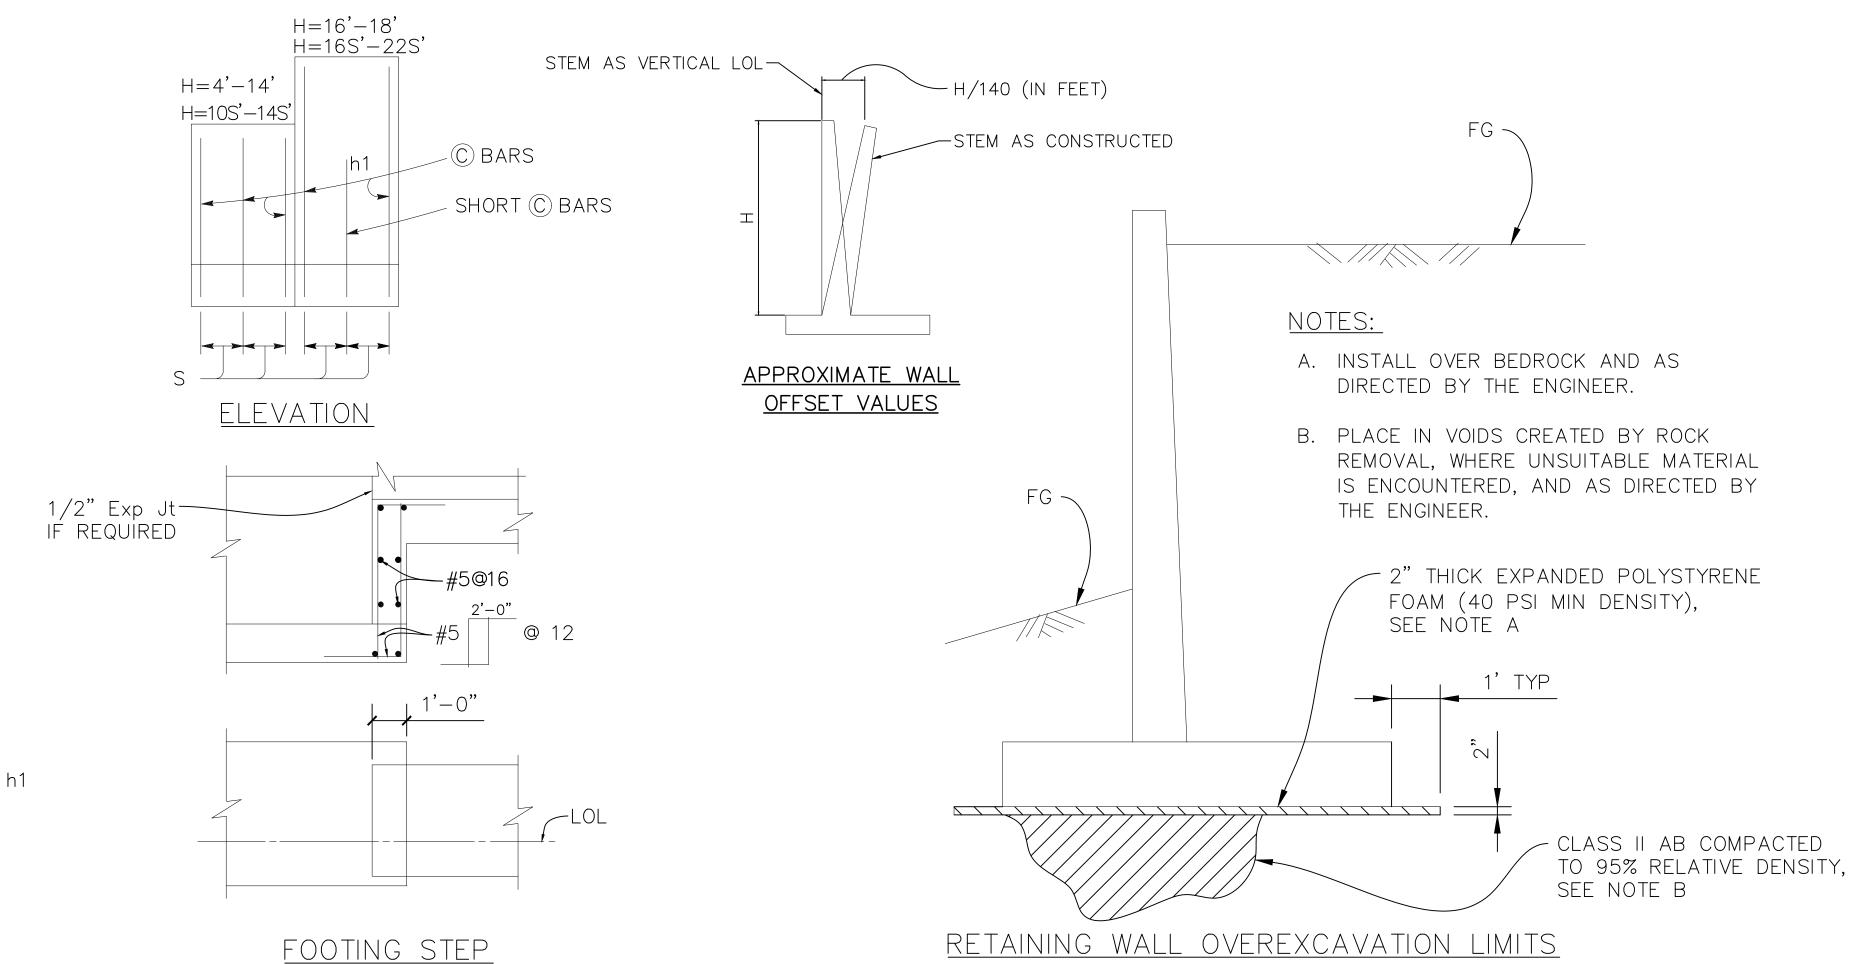


TABLE OF REINFORCING STEEL, DIMENSIONS AND DATA										
DESIGN H	4'	6'	8'	10'	12'	14'	16'	18'	20'	22'
W	6'-10"	7'-0"	7'-3"	7'-7"	8'-4"	9'-7"	10'-9"	12'-0"	12'-0"	
С	2'-2"	2'-3"	2'-3"	2'-4"	2'-6"	3'-0"	3'-6"	4'-0"	4'-0"	NOT APPLICABLE
В	4'-8"	4'-9"	5'-0"	5'-3"	5'-10"	6'-7"	7'-3"	8'-0"	8'-0"	7 (I I EIO/IBEE
F	1'-4"	1'-4"	1'-4"	1'-4"	1'-6"	1'-8"	1'-9"	1'-9"	1'-9"	1'-9"
BATTER	½:12	½:12	½:12	½:12	1/2:12	½:12	1/2:12	½:12	½:12	1/2:12
SPACING "S"	9"	9"	9"	9"	9"	7"	6"	5"	6"	6"
C BARS	#6	#6	#6	#6	#6	#6	#7	#7	#8	#9
D BARS	# 5	#5	#6	#6	#6	#6	#7	#8	#8	#9
h1 (SHORT C BAR LENGTH)	_	_	_	_	_	_	5'-9"	5'-10"	8'-0"	9'-0"
Ser: B', q'o	6.8, 0.7	6.5, 1.0	6.2, 1.3	6.0, 1.6	6.3, 2.0	7.5, 2.1	8.6, 2.2	9.8, 2.3	9.8, 2.3	
Str: B', qo	6.6, 1.6	5.0, 1.8	3.6, 2.3	3.0, 3.3	3.2, 4.0	4.3, 3.8	5.3, 3.7	6.4, 3.7	6.4, 3.7	NOT
Ext I: B', qo	5.2, 1.1	4.7, 1.5	3.9, 2.2	3.1, 3.4	2.8, 4.8	3.2, 5.3	3.6, 5.7	4.1, 6.1	4.1, 6.1	APPLICABLE
Ext II: B', qo	2.6, 2.2	2.7, 2.6	2.8, 3.1	2.9, 3.6	3.7, 3.6	5.2, 3.3	6.7, 3.1	8.3, 3.0	8.3, 3.0	

NOTES:

- 1. SPLICES IN © BARS SHALL NOT BE ALLOWED IN THE WALL STEM WITHIN A DISTANCE OF H/4 OR MINIMUM OF 1'-8" FROM TOP OF FOOTING.
- 2. SEE WALL ELEVATIONS ON SHEETS 21 AND 22 FOR LIMITS OF ADDITIONAL © BARS CONSISTING OF FULL HEIGHT #6 L BARS BUNDLED WITH STANDARD © BARS IN TABLE ABOVE.
- 3. HORIZONTAL LEGS OF © BARS IN STEM WALLS FOUNDED ON STRUCTURAL SLAB SHALL BE 4'-0" LONG AND PLACED PARALLEL WITH TRANSVERSE #9 @ 16 IN STRUCTURAL SLAB.

CT	OF SANTARAPE OF SANTARAPE

RETAINING WALL DETAILS NO. 1

	CA: 1-800-422-4133 CALL TWO WORKING DAYS BEFORE YOU DIG
DESIGNED BY: KB	O-1156
DRAWN BY:	0 1130
CHECKED BY:	SHEET 25 OF 26

25 OF 26 Filename: Cold Springs DB Plans.DWG


CA: 1-800-422-4133 **-**

	REVISIONS			PROFESS/ON	DESIGNED BY: Jan Rush = 11/03/2023		SANTA BARBARA COUNTY
,	DESCRIPTION	DATE	APR	S. BISHOW THE	BISHOP ENGINEERING DATE	-	FLOOD CONTROL AND
				No. S 4059			WATER CONSERVATION DISTRICT
				\mathbb{Z} Exp. $\frac{9/30/25}{2}$			130 E. VICTORIA STREET
				STRUCTURAL A			SANTA BARBARA, CA 93101
				OF CALIFORN			(805) 568-3440


COLD SPRINGS DEBRIS BASIN IMPROVEMENTS PROJECT AREA OF MONTECITO SANTA BARBARA COUNTY, CALIFORNIA

NOTES:


- A. 4"\phi PVC SCHEDULE 80 DRAINS \@ 25'-0" MAXIMUM CENTER TO CENTER. EXPOSED WALL DRAINS SHALL BE LOCATED 3"± ABOVE FINISHED GRADE
- B. 6" SQUARE ALUMINUM OR GALVANIZED STEEL WIRE 1/2" MESH HARDWARE CLOTH. MINIMUM WIRE DIAMETER 0.025". ANCHOR FIRMLY TO BACKFACE.
- C. ONE CUBIC FOOT PER LINEAR FOOT OF WALL PERVIOUS BACKFILL MATERIAL IN NONWOVEN FILTER FABRIC, SECURELY TIED.
- D. PERVIOUS BACKFILL MATERIAL CONTINUOUS BEHIND RETAINING WALL

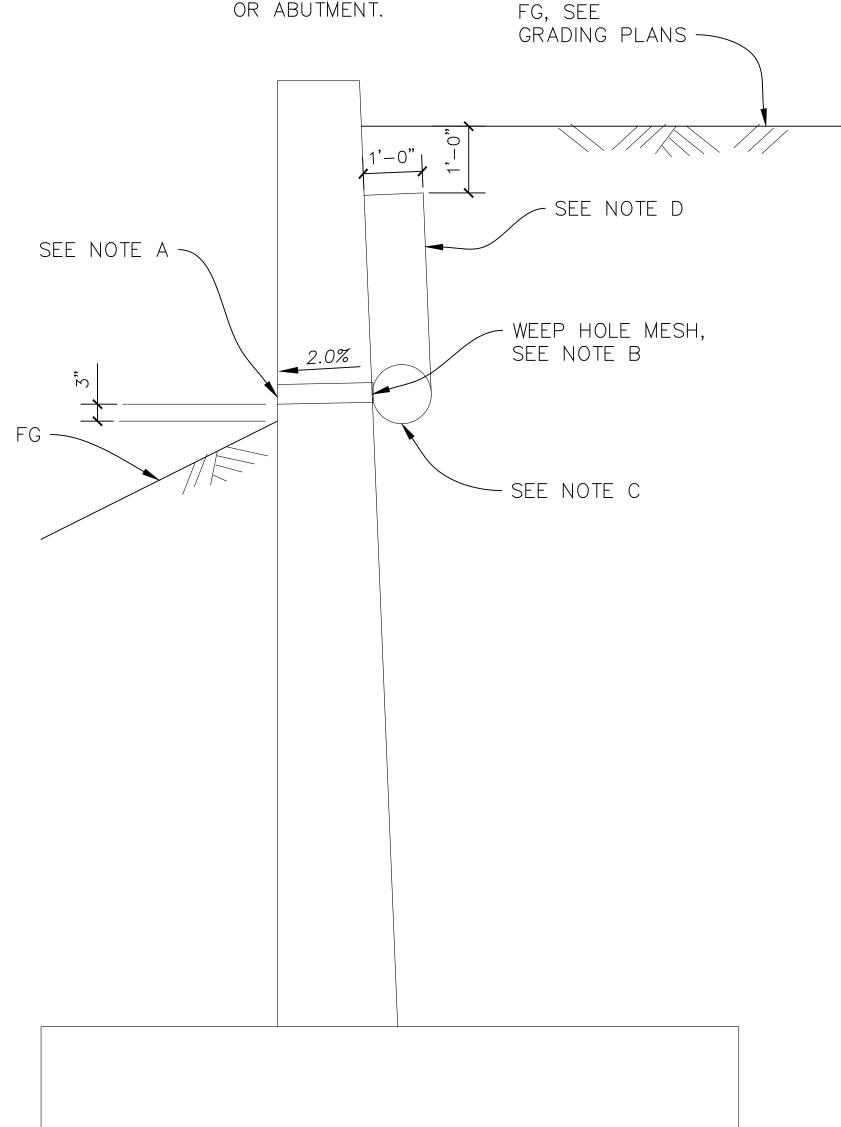


WEEP HOLE AND PERVIOUS BACKFILL SECTION

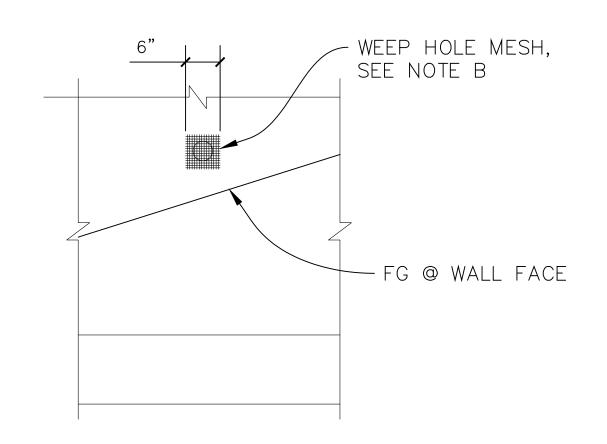

WEEP HOLE MESH

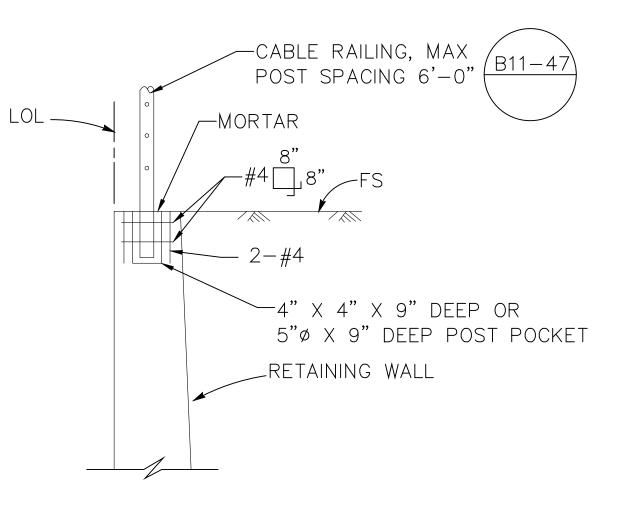

CABLE RAILING POST POCKET

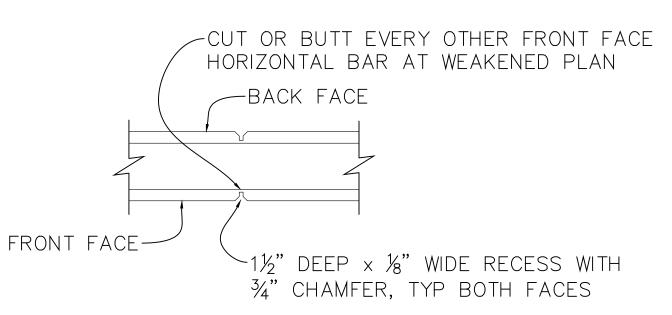

WEAKENED PLANE

SYMBOLS:

Ser - SERVICE LIMIT STATE I Str - STRENGTH LIMIT STATE I

Ext I — EXTREME EVENT LIMIT STATE I Ext II — EXTREME EVENT LIMIT STATE II

B' — EFFECTIVE FOOTING WIDTH (ft)

q'o — NET BEARING STRESS (ksf), OG ASSUMED TO BE FG AT TOE

qo — GROSS UNIFORM BEARING STRESS (ksf)

DESIGN CONDITIONS:

DESIGN H MAY BE EXCEEDED BY 6" BEFORE GOING TO THE NEXT SIZE. SPECIAL FOOTING DESIGN IS REQUIRED WHERE FOUNDATION MATERIAL IS INCAPABLE OF SUPPORTING BEARING STRESS LISTED IN THE TABLE.

DESIGN NOTES:

DESIGN: AASHTO LRFD BRIDGE DESIGN SPECIFICATIONS,

4TH EDITION WITH CALIFORNIA AMENDMENTS

240PSF SURCHARGE ON LIMITS OF MAINTENANCE ROAD LS:

DC: STEEL ARMOR FOR CONCRETE FACES UP TO 13/4"

THICK (75 PSF) CONSIDERED

54 KIP TRANSVERSE FORCE APPLIED AT HE = 32", DISTRIBUTED OVER 10 FEET AT THE TOP OF WALL CT:

AND 1: 1 DISTRIBUTION DOWN AND OUTWARD.

DISTRIBUTION BELOW FOOTING TAKEN NO LESS THAN 40'.

SEISMIC: $k_h = 0.2$ $k_{V} = 0.0$

SOIL: $\phi = 34^{\circ}$ $\gamma = 120 \text{ pcf}$

REINFORCED

CONCRETE: f'c = 3,600 psify = 60,000 psi

LOAD COMBINATIONS AND LIMIT STATES:

Q = 1.00DC+1.00EV+1.00EH+1.00LSService I

 $Q = \alpha DC + \beta EV + \eta EH + 1.75LS$ Strength I

Q = 1.00DC + 1.00EV + 1.00EH + 1.00EQD + 1.00EQEExtreme I

Q = 1.00DC + 1.00EV + 1.00EH + 1.00CT

Where:

FORCE EFFECTS

1.25 OR 0.90, WHICHEVER CONTROLS DESIGN α: 1.35 OR 1.00, WHICHEVER CONTROLS DESIGN 1.50 OR 0.90, WHICHEVER CONTROLS DESIGN DEAD LOAD OF STRUCTURE COMPONENTS

HORIZONTAL EARTH FILL PRESSURE

VERTICAL EARTH PRESSURE FROM EARTH FILL WEIGHT EV:

LIVE LOAD SURCHARGE

LS: EQE: SEISMIC EARTH PRESSURE

SOIL AND STRUCTURAL AND NONSTRUCTURAL COMPONENTS INERTIA EQD:


VEHICULAR COLLISION FORCE



UNAUTHORIZED CHANGES OR USES: THE SANTA BARBARA COUNTY FLOOD CONTROL & WATER CONSERVATION DISTRICT AND ITS EMPLOYEES WILL NOT BE RESPONSIBLE FOR, OR LIABLE FOR, UNAUTHORIZED CHANGES TO OR USES OF THESE PLANS. ALL PROPOSED CHANGES TO THE PLANS MUST BE PRESENTED IN WRITING TO THE DISTRICT AND APPROVED IN WRITING BY THE DISTRICT PRIOR TO IMPLEMENTATION OF ANY SUCH CHANGE OR USE.

ALL UNDERGROUND UTILITIES SHOWN ARE PLOTTED BASED ON INFORMATION PROVIDED BY OTHERS, AND ARE APPROXIMATE. OVERHEAD UTILITIES ARE NOT SHOWN. THE SANTA BARBARA COUNTY FLOOD CONTROL DISTRICT IS NOT RESPONSIBLE FOR THE ACCURACY OF THIS INFORMATION. CONTRACTOR SHALL NOTIFY UNDERGROUND SERVICE ALERT A MINIMUM OF TWO WORKING DAYS PRIOR TO COMMENCEMENT OF ANY EXCAVATION @ 1-800-422-4133.

	REVISIONS			PROFESS/ONA	DESIGNED BY: John Bish	11/03/2023	SANTA BARBARA COUNTY
NO.	DESCRIPTION	DATE	APR	Oth S. BISHOR FI	BISHOP ENGINEERING	DATE	FLOOD CONTROL AND
				No. S 4059			WATER CONSERVATION DISTRIC
				Exp. 9/30/25			130 E. VICTORIA STREET
				STRUCTURAL #			SANTA BARBARA, CA 93101
				OF CALIFORNIE			(805) 568-3440

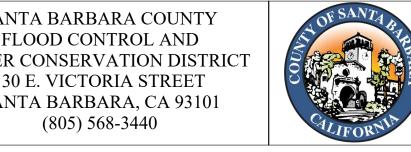

COLD SPRINGS DEBRIS BASIN IMPROVEMENTS PROJECT

AREA OF MONTECITO SANTA BARBARA COUNTY, CALIFORNIA RETAINING WALL DETAILS NO. 2

	DESIGNED BY:
	KB
_	DRAWN BY:
	SC
	CHECKED BY:

O-1156

SHEET 26 OF 26 Filename: Cold Springs DB Plans.DWG