SLO CULTIVATION

2019 EDITION

2019 EDITION

2019 EDITION

2019 EDITION

2019 EDITION

CALIFORNIA PLUMBING CODE


CALIFORNIA ENERGY CODE

CALIFORNIA FIRE CODE

CALIFORNIA MECHANICAL CODE

CALIFORNIA GREEN BUILDING STANDARDS CODE

SITE

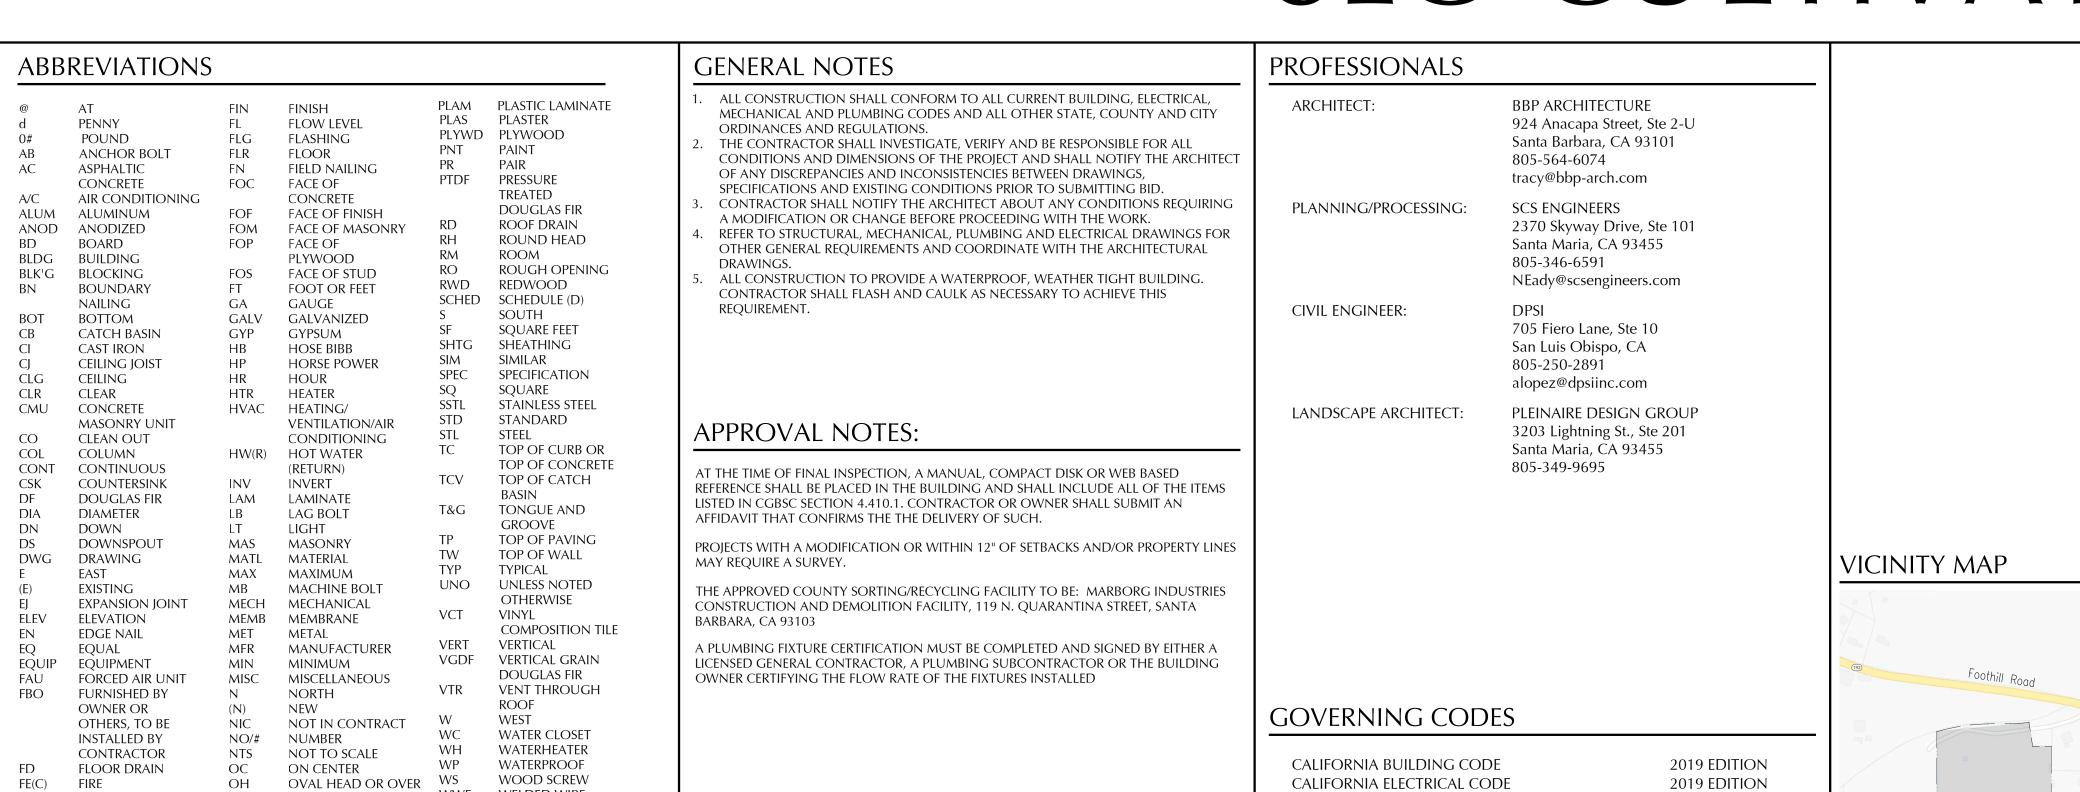

(N) PROCESSING BUILDING

SITE ELEVATION - NORTH

WWF

W/

W/O

HEAD

PROPOSED

PLATE OR PROPERTY LINE

OPNG OPENING

(P)

PL

EXTINGUISHER

FINISH FLOOR

FINISHED GRADE

(& CABINET)

FLAT HEAD

WELDED WIRE

SPECIAL INSPECTIONS

SEE SHEET S-1.0 FOR LIST OF SPECIAL INSPECTIONS REQUIRED

FABRIC

WITHOUT

WITH

(E) GREENHOUSE #1

PROJECT DATA OWNER: SLO Cultivation, Inc, dba Cresco California 3861 Foothill Road Carpinteria, CA 93013 (805) 346-6591 PROJECT ADDRESS: 3861 FOOTHILL RD CARPINTERIA, CA 005-310-024 ZONE: AG-1-10 OCCUPANCY: CONSTRUCTION TYPE: V-B SPRINKLERED: **SQUARE FOOTAGE:** LOT: **GREENHOUSE #1** GREENHOUSE #2 GREENHOUSE #3 GREENHOUSE #4 TOTAL BUILDING FOOTAGE: **EXISTING LOT COVERAGE: BUILDING COVERAGE:** 386,600 SF (65%) 18,178 SF (3%) HARDSCAPE/IMPERMEABLE LANDSCAPING/UNDEVELOPED: 190,252 SF (32%) TOTAL: 595,030 SF (100%) PROPOSED BUILDING FOOTAGE: GREENHOUSE #1 ADDITION TO GREENHOUSE #1: GREENHOUSE #1 NEW TOTAL: PROCESSING BUILDING: FIRST FLOOR: SECOND FLOOR: PROCESSING BUILDING TOTAL TOTAL BUILDING FOOTAGE: PROPOSED LOT COVERAGE: **BUILDING COVERAGE:** 350,983 SF (59%) HARDSCAPE/IMPERMEABLE 30,916 SF (5%) LANDSCAPING/UNDEVELOPED: 213,131 SF (36%) TOTAL: 595,030 SF (100%) GRADING PROPOSED FILL: EXPORT: DISTURBED AREA: 215,160 SQ FT (4.93 AC) Per Santa Barbara Coastal Development Code Section 35-113: 2 spaces per acre of cultivation use. ACRES OF CULTIVATION: SPACES REQUIRED $(7.5 \times 2 = 15)$ PROCESSING BUILDING: (R&D; 1 per 500 SF: 24,751/500) TOTAL PARKING REQUIRED: TOTAL PARKING PROVIDED:

SCOPE OF WORK

SHEET INDEX

G-2.2 Photo Exhibit (Photo Rendering)

Processing Building Floor Plans

Processing Building Elevations

GH-2 Greenhouse Addition Plans & Elevations

L-1.3 Landscape Screening and Detention Basin Enlargement

A-1.1 Security & Fencing Site Plan

GH-1 Greenhouse 1 Existing Plans

.-1.1 Screening Plan Existing Photos

.-1.4 Rendered Existing Landscaping

C-1 Preliminary Grading Plan

TOTAL - 15

.-1.5 Rendered Proposed Landscaping

-1.0 Landscape Fencing

.-1.2 Tree Inventory Plan

G-0 Cover Sheet

A-1 Site Plan

A-1.2 Site Lighting Plan

A-1.3 Odor Control Plan

required. Install fire department hammerhead turn-around.

Remove (3) existing Japanese greenhouses. Permit existing greenhouse #1 (264,500 SF, 17'-7" height). Construct addition

Provide 65 parking spaces on permeable surface. Add 26,215 SF landscape screening focused primarily to parking lot and

to greenhouse #1 (61,840 SF, 17'-7" height). Construct new cannabis processing building (24,751 SF, 26'-0" height).

to processing building. Remove un-permitted shipping containers. Construct expansion storm water basins. Install

cannabis irrigation systems. Install greenhouse odor mitigation system. Install security fencing, lighting and cameras as

15 SPACES 50 SPACES 65 SPACES 65 SPACES REN. 05/21

sheet description

6-1-2021 7-6-2021 9-15-2021

10-1-2021

STRUC

sheet no:

ARCHITECTURE 924 anacapa st suite: 2-U santa barbara, ca 93101

805.564.6074

13.66 AC

GROSS 264,500 SF

40,700 SF

40,700 SF

40,700 SF

386,600 SF

264,500 SF

61,840 SF

326,340 SF

22,633 SF

2,118 SF

24,751 SF

351,091 SF

6,030 CY

3,950 CY

2,080 CY

COVERSHEET

8-7-2020 8-20-2020 8-28-2020 9-3-2020 9-9-2020 9-17-2020 12-9-2020 12-18-2020 12-29-2020 1-13-2021 2-3-2021 2-9-2021 2-10-2021 2-18-2021 4-27-2021

PHOTO RENDERING FROM FOOTHILL (Exist'g Condition)

Only existing landscaping shown. Proposed Processing Building upper roof partially seen from Foothill Road.




PROPOSED PROCESSING
BUILDING BEYOND ———

A R C H I T E C T U R E

924 anacapa st suite: 2-U santa barbara, ca 93101

805.564.6074

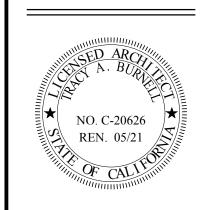

sheet description PHOTO EXHIBIT LANDSCAPING

8-7-2020 8-20-2020 8-28-2020 9-3-2020 9-9-2020 9-17-2020 12-9-2020 12-18-2020 1-13-2021 2-3-2021 2-9-2021 2-10-2021 2-18-2021 2-18-2021 4-27-2021 6-1-2021

G-2.2

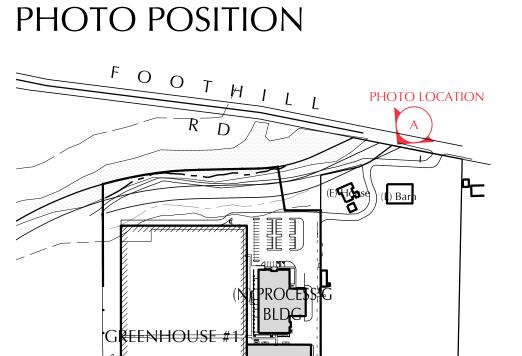




PHOTO RENDERING FROM FOOTHILL (+ Project Landscaping and Caltrans Landscaping)

By further adding landscaping proposed by Caltrans, existing fence also becomes





(N) GREENHOUS

SITE PLAN GENERAL NOTES:

- This plan is for architectural reference. See civil plans for specific grading and drainage information.

 Positive drainage shall be provided away from the structure at a minimum slope of 5% for 10 feet.
- Contractor shall verify location of all underground utilities prior to excavation.
 Rain gutters and downspouts shall collect and discharge roof rain water run-off through an approved storm drain system. See civil plans for additional information.
- Verify depth & separation of utilities within trenches w/ governing jurisdiction and comply w/ all applicable codes. Architect to be notified of any conflicts.



ARCHITECTURE

924 anacapa st suite: 2-U santa barbara, ca 93101 805.564.6074




sheet description SITE PLAN

8-20-2020 8-28-2020 9-3-2020 9-9-2020 9-17-2020 12-9-2020 12-18-2020 12-29-2020 1-13-2021 2-3-2021 2-9-2021 2-10-2021 2-18-2021 4-27-2021 6-1-2021 7-6-2021

sheet no:

9-15-2021 10-1-2021

1"=50'

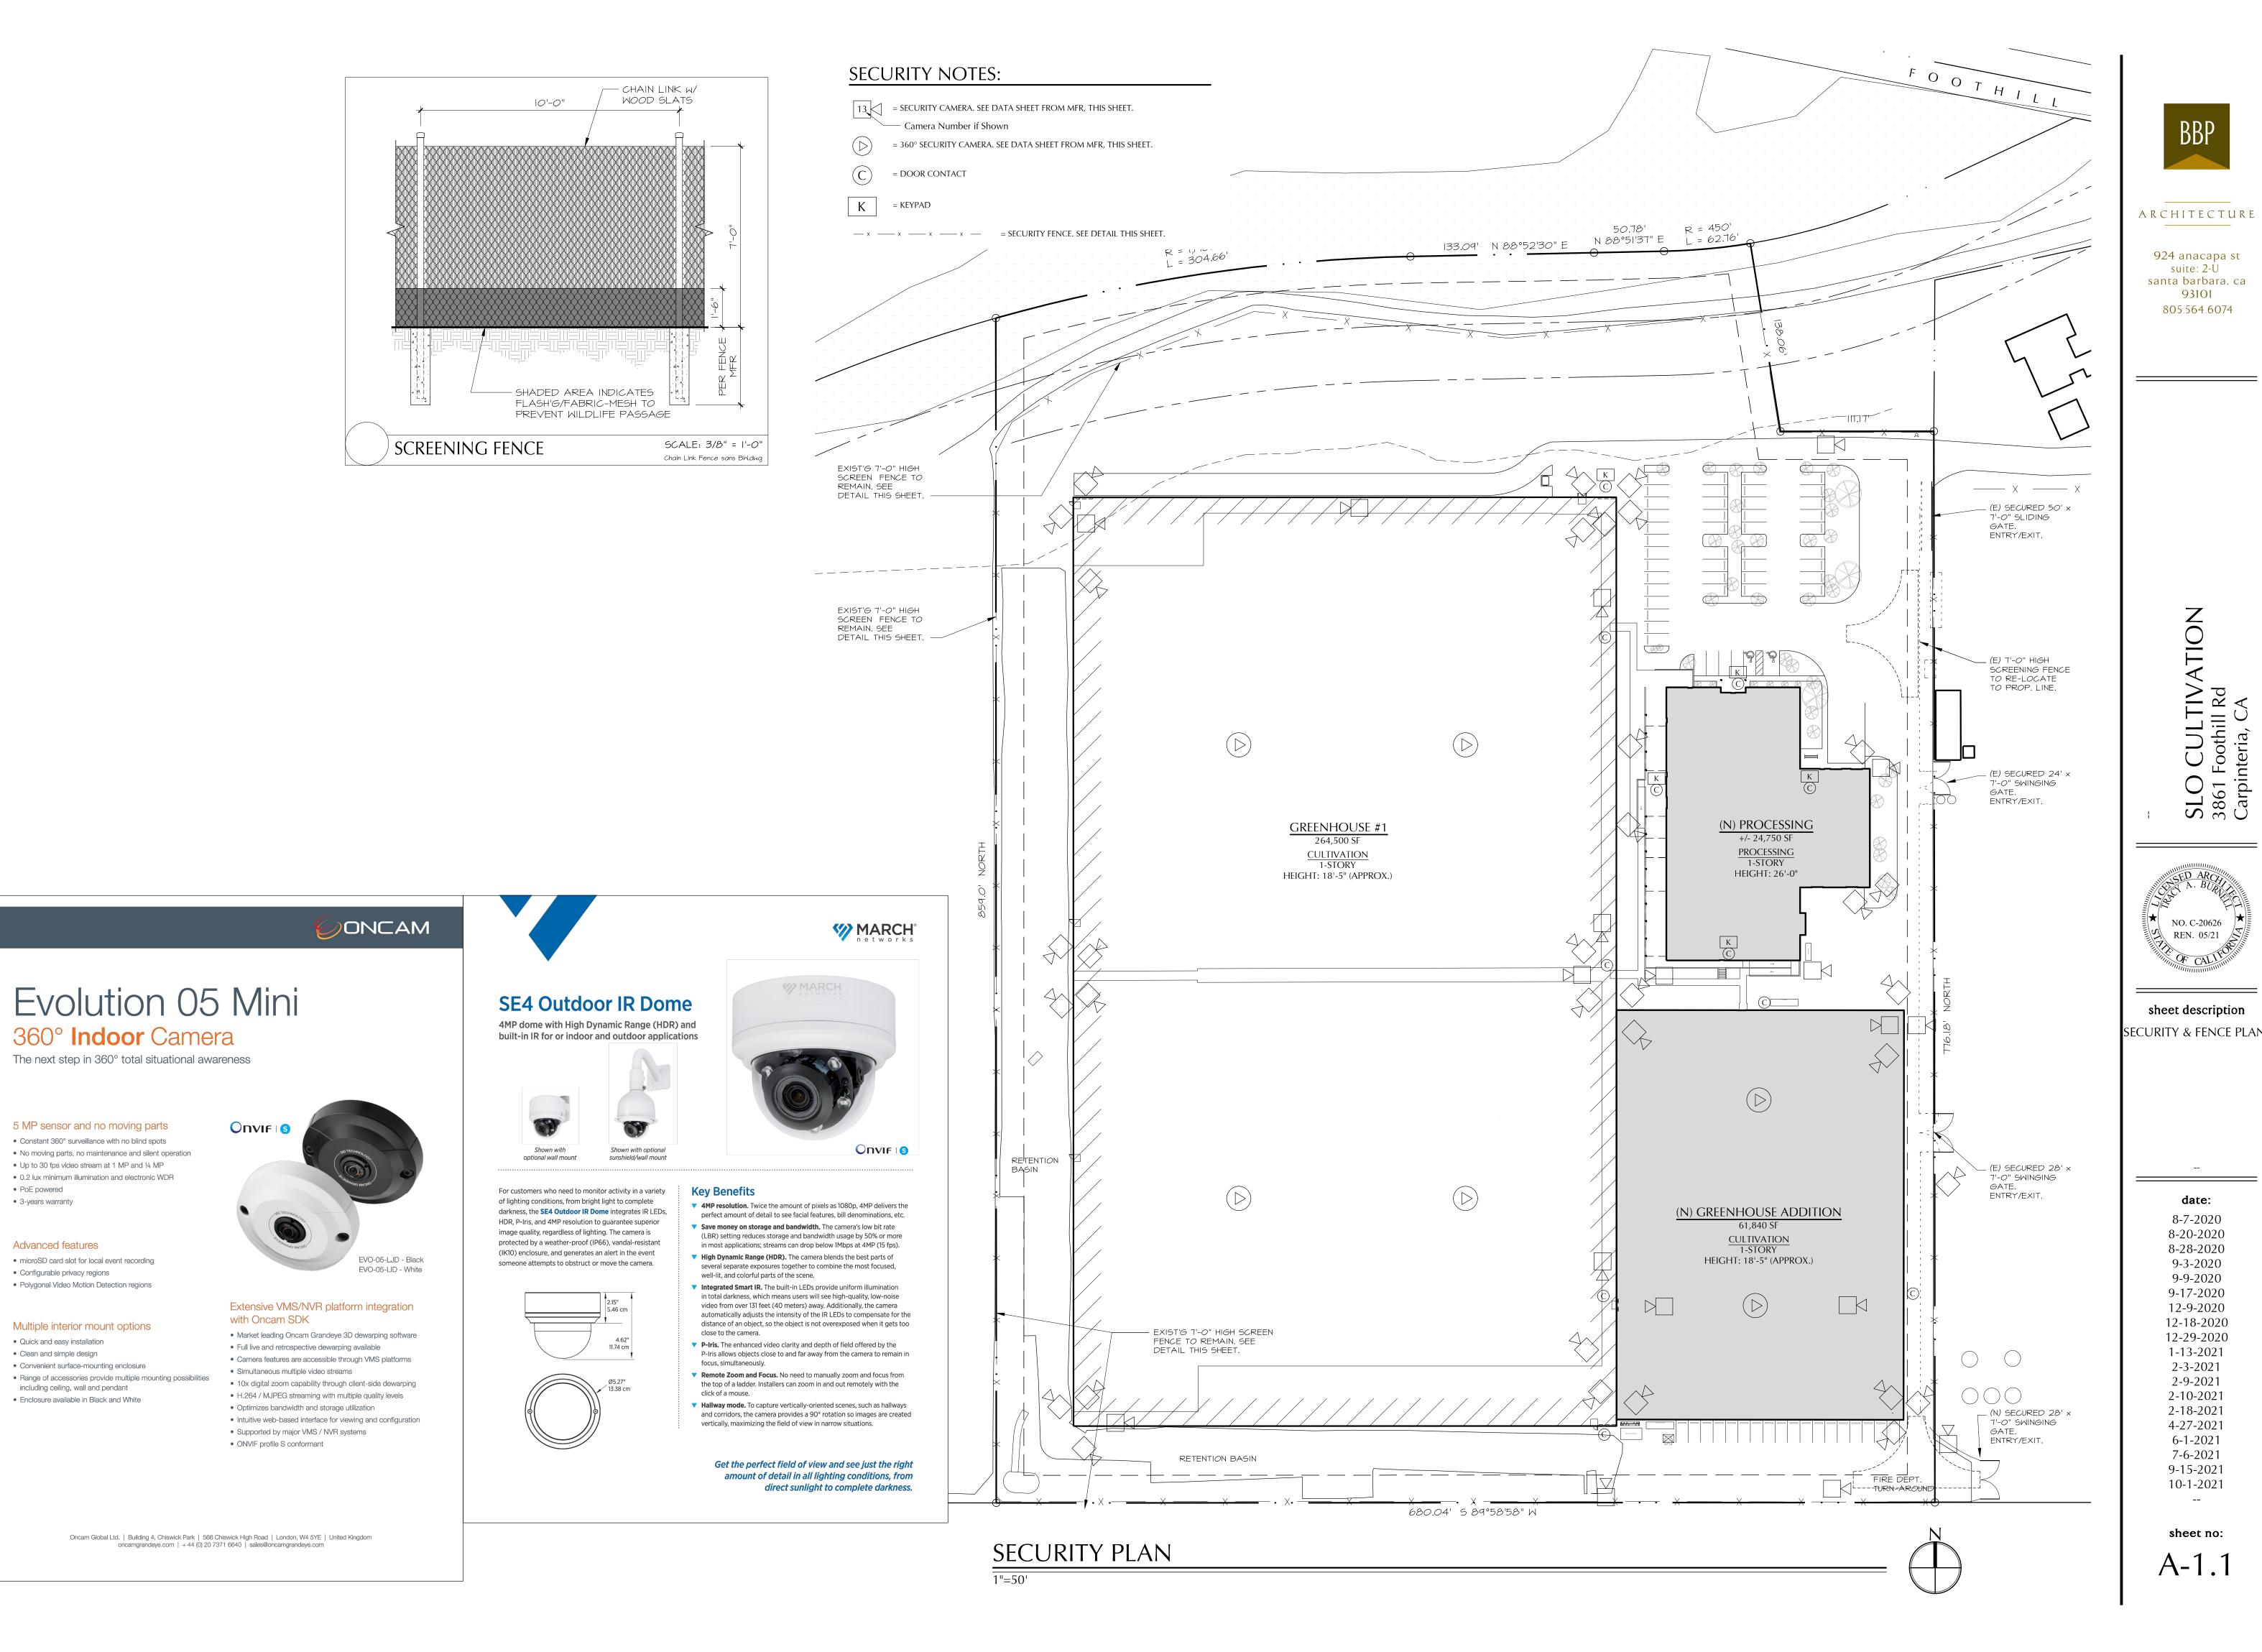

PoE powered

3-years warranty

Advanced features

Configurable privacy regions

Quick and easy installation

Clean and simple design

microSD card slot for local event recording


Polygonal Video Motion Detection regions

Multiple interior mount options

Convenient surface-mounting enclosure


including ceiling, wall and pendant

Enclosure available in Black and White

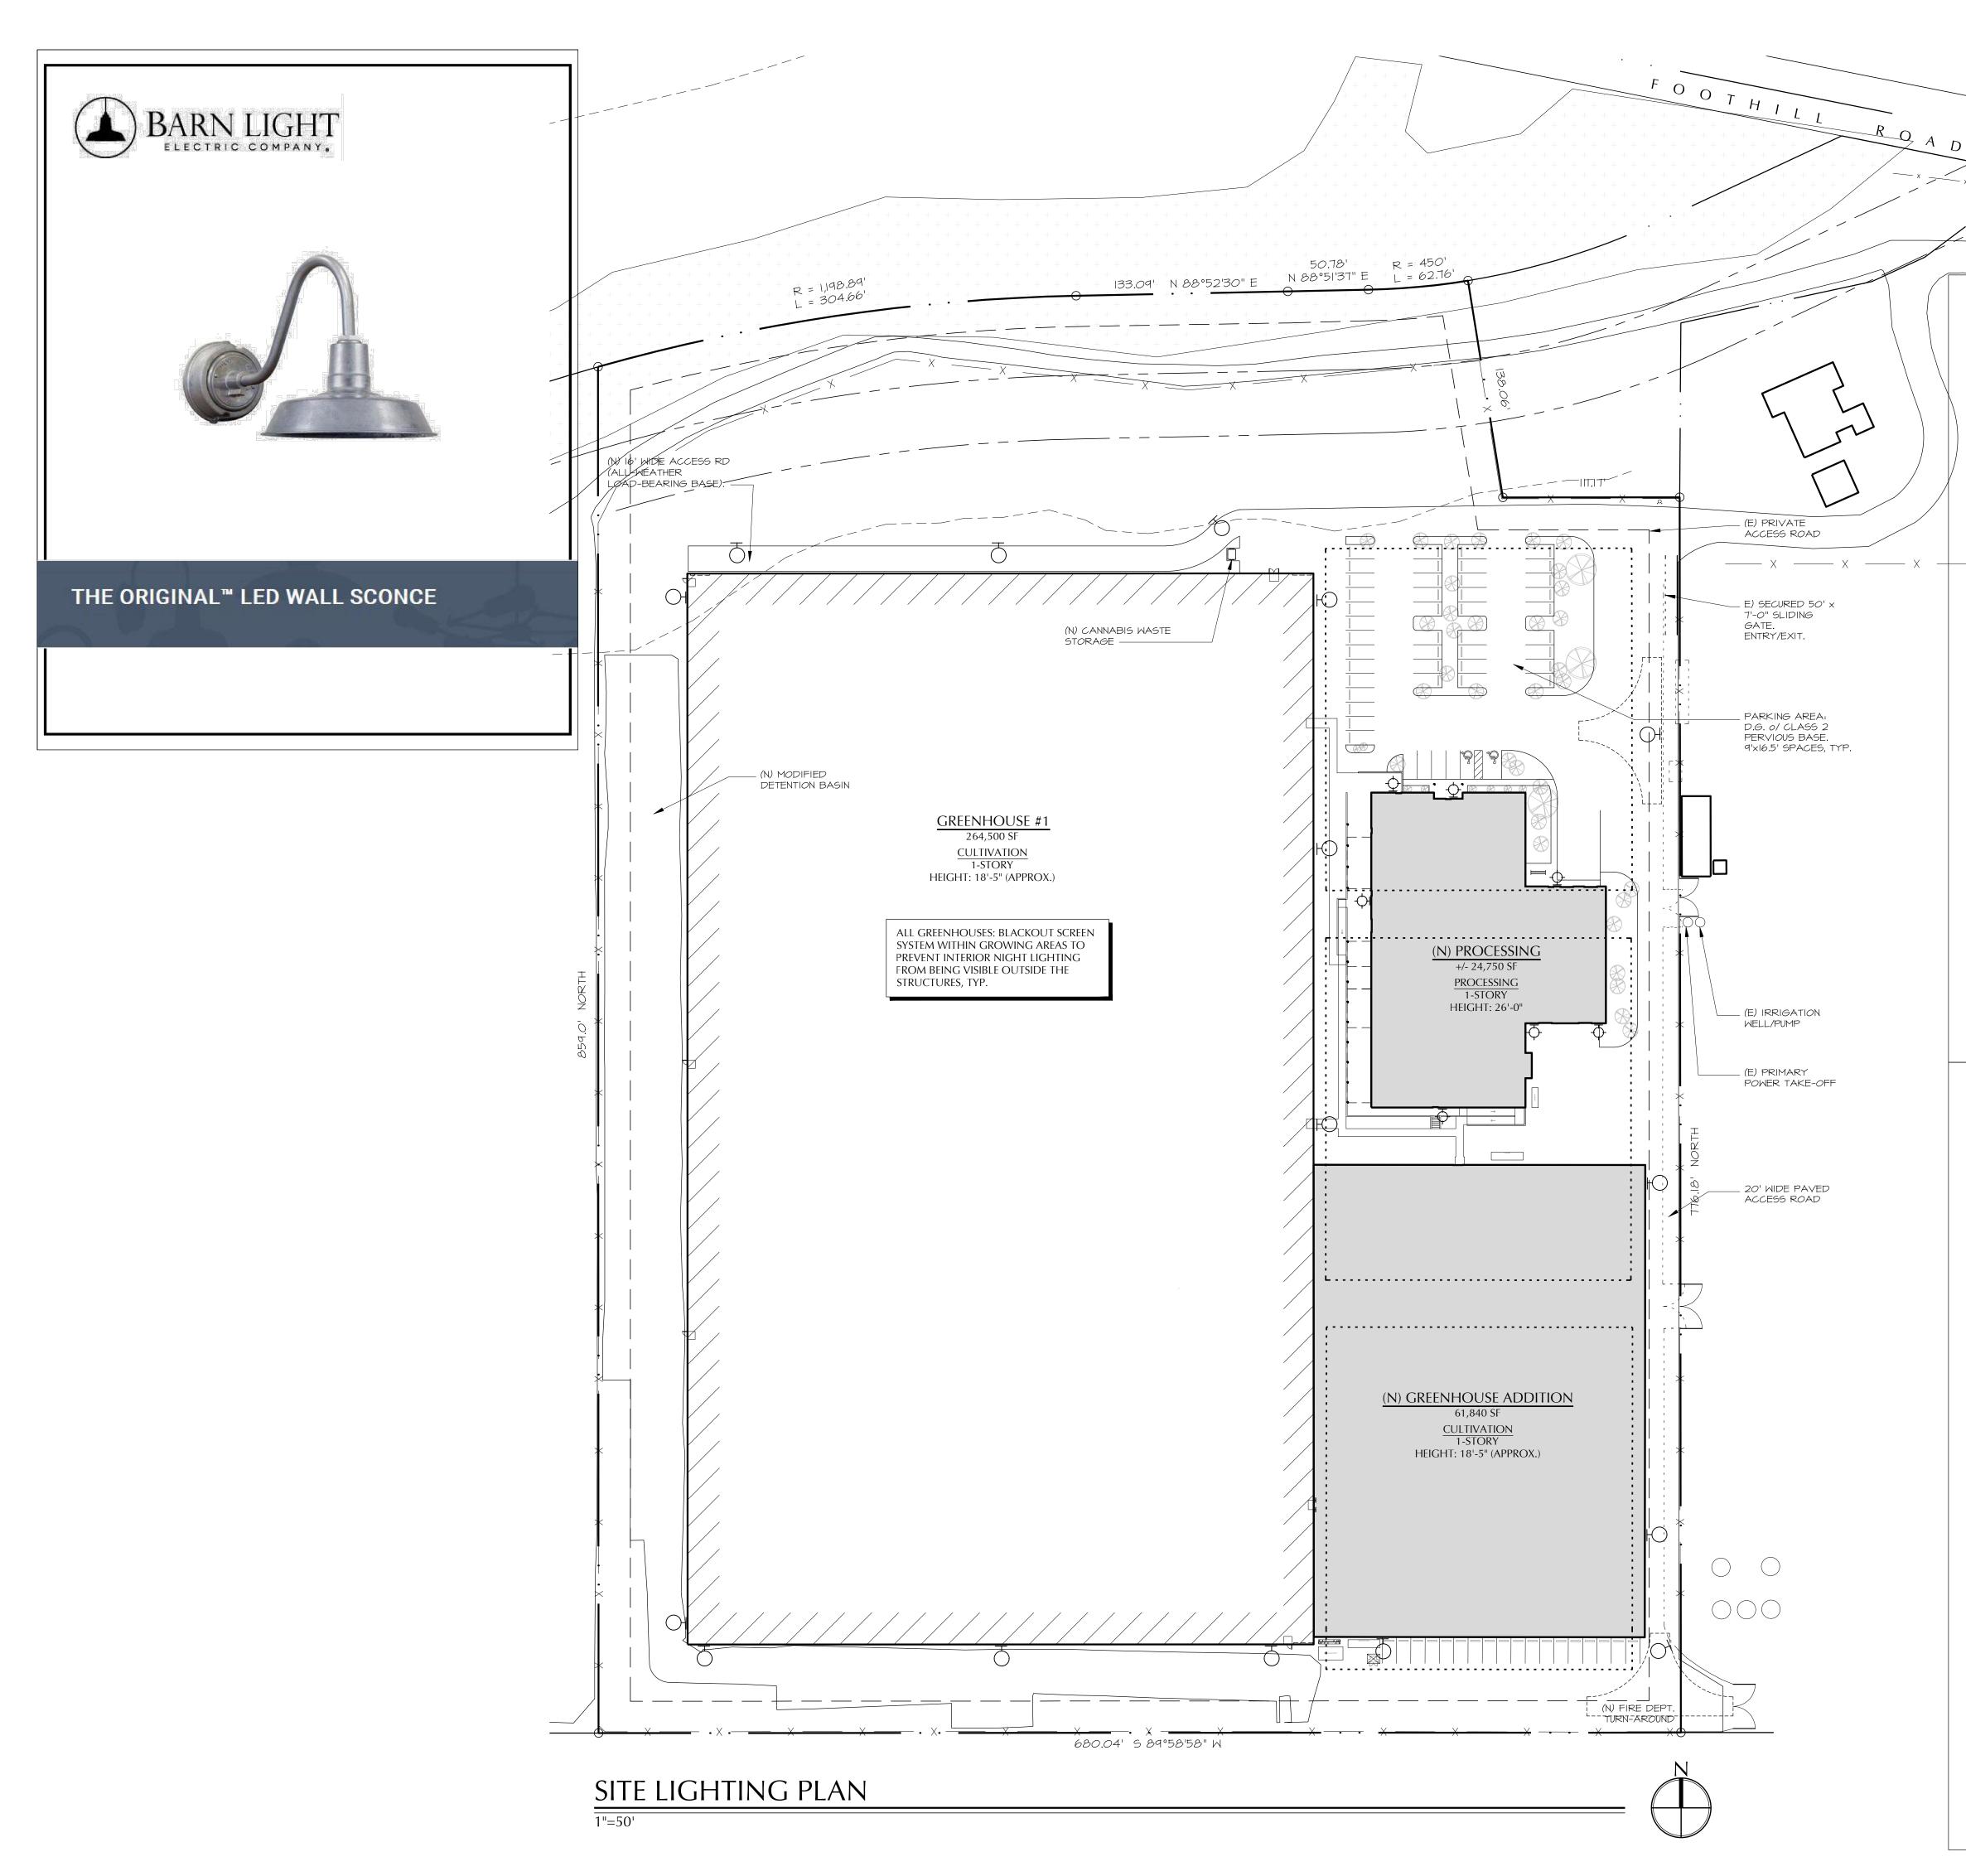


LIGHTING SYMBOLS:

- = LED FLOODLIGHT w/ MOTION SENSOR. LIGHTS TO BE DIRECTED DOWNWARD. WALL-MOUNTED, +10'-0". SEE MFR SPEC'S. THIS SHEET.
- LED FLOODLIGHT w/ MOTION SENSOR. LIGHTS TO BE DIRECTED DOWNWARD. POLE-MOUNTED, +8'-0". SEE MFR SPEC'S. THIS SHEET.
- = LED BARNLIGHT w/ MOTION SENSOR. LIGHTS TO BE DIRECTED DOWNWARD. WALL-MOUNTED, +8'-0". SEE MFR SPEC'S. THIS SHEET.

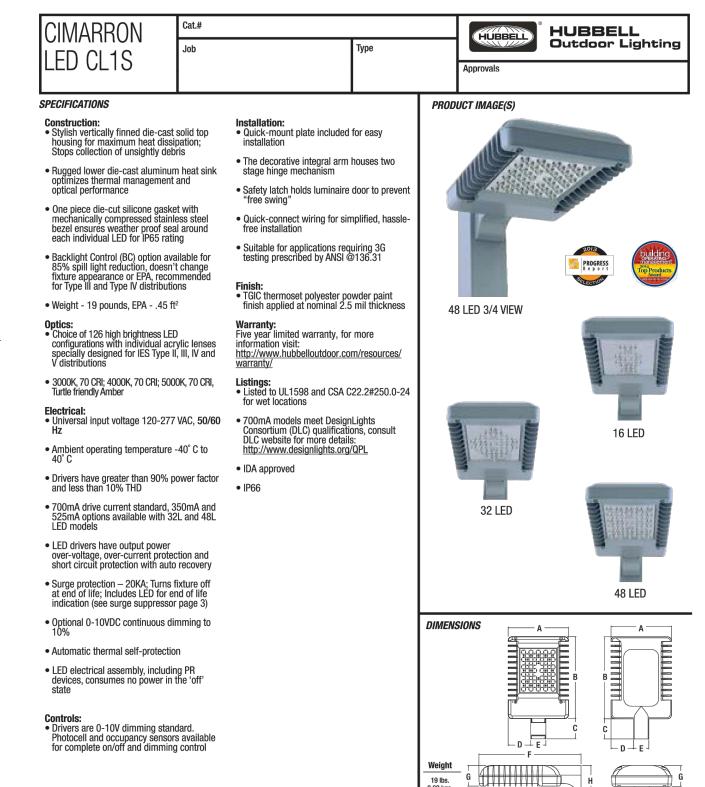

CERTIFICATIONS/LISTINGS

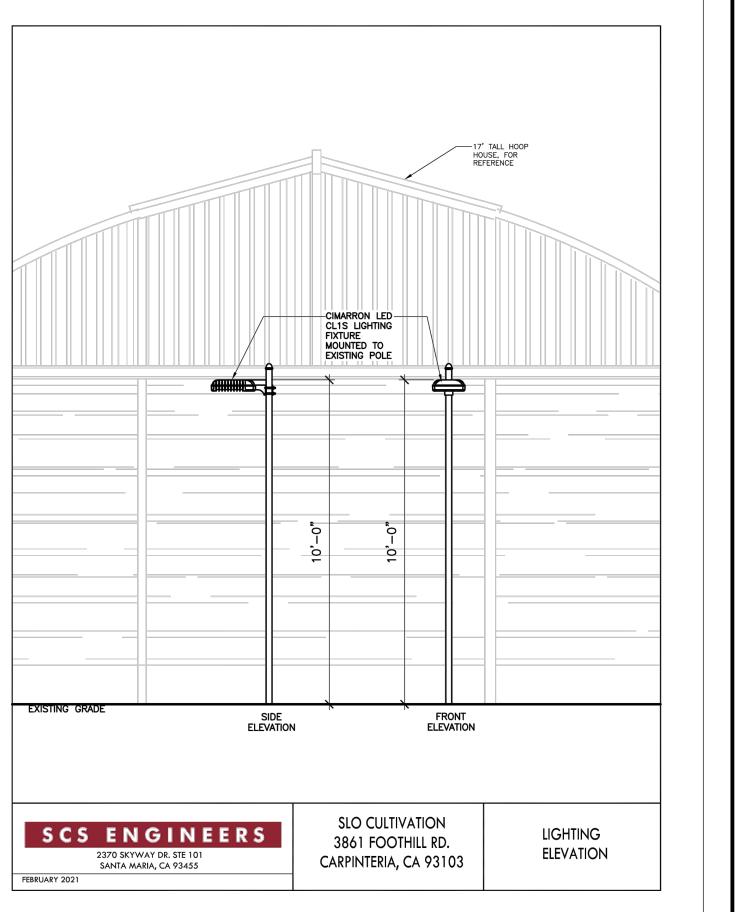

Hubbell Outdoor Lighting • 701 Millennium Boulevard • Greenville, SC 29607 • Phone: 864-678-1000

Due to our continued efforts to improve our products, product specifications are subject to change without notice.

Due to our continued efforts to improve our products, product specifications are subject to change without notice.


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ARCHITECTURE

924 anacapa st suite: 2-U santa barbara, ca 93101

805.564.6074



sheet description SITE LIGHTING PLAN

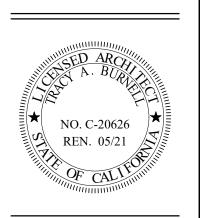8-7-2020 8-20-2020 8-28-2020 9-3-2020 9-9-2020 9-17-2020 12-9-2020 12-18-2020 12-29-2020 1-13-2021 2-3-2021 2-9-2021 2-10-2021

2-18-2021 4-27-2021 6-1-2021 7-6-2021 9-15-2021

10-1-2021

sheet no: A-1.2

ODOR CONTROL NOTES:

- 1. Odor Abatement: Dry Vapor Odor Control System (by Byers, U.N.O.) on Concrete Pad. See
- Odor Abatement Plan by SCS Engineers for Additional Information.
 Locate Neutralizing Agent and Blower per MFR.
 Distribution Pipe to be PVC, U.N.O.



ARCHITECTURE

924 anacapa st suite: 2-U santa barbara, ca 93101 805.564.6074

SLO CULTIVATION 3861 Foothill Rd Carpinteria, CA



sheet description ODOR CONTROL PLAN

8-7-2020 8-20-2020 8-28-2020 9-3-2020 9-9-2020 9-17-2020 12-9-2020 12-18-2020 12-29-2020 1-13-2021 2-3-2021 2-9-2021 2-10-2021 2-18-2021 4-27-2021 6-1-2021 7-6-2021 9-15-2021

sheet no: A-1.3

10-1-2021


3/32"=1'-0"



ARCHITECTURE

924 anacapa st suite: 2-U santa barbara, ca 93101 805.564.6074

> SLO CULTIVATION 3861 Foothill Rd Carpinteria, CA

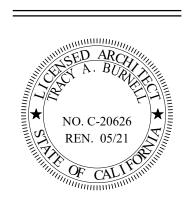

sheet description
PROCESSING BLDG
FLOOR PLANS

date:

date:

8-7-2020

8-20-2020

8-28-2020

9-3-2020

9-9-2020

9-17-2020

12-18-2020

12-18-2020

1-13-2021

2-3-2021

2-9-2021

2-10-2021

2-18-2021

4-27-2021

6-1-2021

7-6-2021

9-15-2021

10-1-2021

CONSTRUCTION

© BURNELL, BRANCH & PESILL.

Preliminary:

sheet no:

A-2

35' HEIGHT LIMIT

Processing Bldg North Elevation
3/32"=1'-0"



Processing Bldg East Elevation 3/32"=1'-0"



Processing Bldg South Elevation 3/32"=1'-0"



Processing Bldg West Elevation 3/32"=1'-0"

MATERIAL SCHEDULE:

Aluminum, Corrugated; AEP Span: Color: Cool Zinc Gray

Aluminum, Batten Siding; AEP Span: Flex Siding, Color: Cool Parchement


Aluminum Clad, Dark Bronze Aluminum Clad, Dark Bronze



ARCHITECTURE

924 anacapa st suite: 2-U santa barbara, ca 93101 805.564.6074

SLO CULTIVATION 3861 Foothill Rd Carpinteria, CA

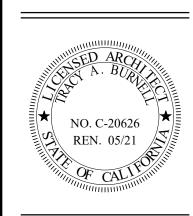

sheet description PROCESSING

BLDG ELEVATIONS

8-20-2020 8-28-2020 9-3-2020 9-9-2020 9-17-2020 12-9-2020 12-18-2020 12-29-2020 1-13-2021 2-3-2021 2-9-2021 2-10-2021 2-18-2021 4-27-2021 6-1-2021 7-6-2021 9-15-2021 10-1-2021


sheet no: **A-**3

BBP

ARCHITECTURE

924 anacapa st suite: 2-U santa barbara, ca 93101 805.564.6074

CULTIVATION sothill Rd eria, CA

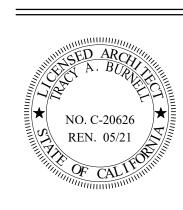


sheet description GREENHOUSE 1 EXIST'G FLR PLAN

ate:

date:
8-7-2020
8-20-2020
8-28-2020
9-3-2020
9-9-2020
9-17-2020
12-9-2020
12-18-2020
12-29-2020
1-13-2021
2-3-2021
2-10-2021
2-18-2021
4-27-2021
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7-6-2021
9-15-2021
10-1-2021

sheet no:

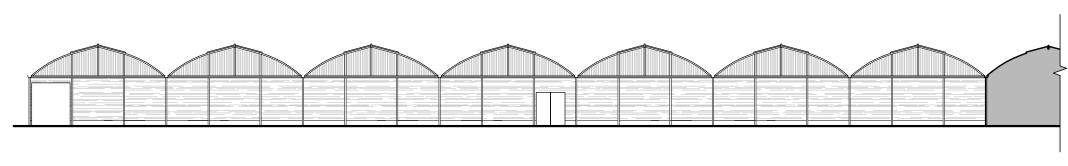


NORTH ELEVATION


1"=20"

										=

EAST ELEVATION (WEST ELEV = GREENHOUSE #1

1"=20"

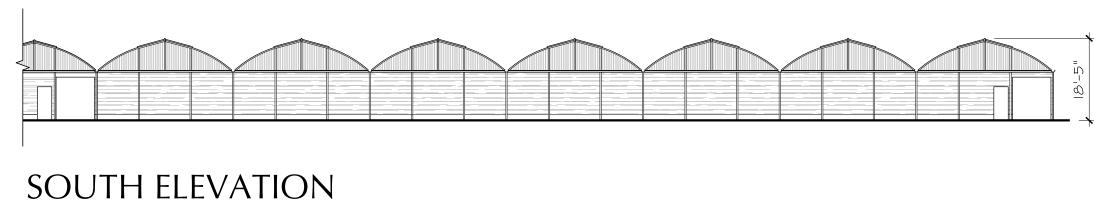

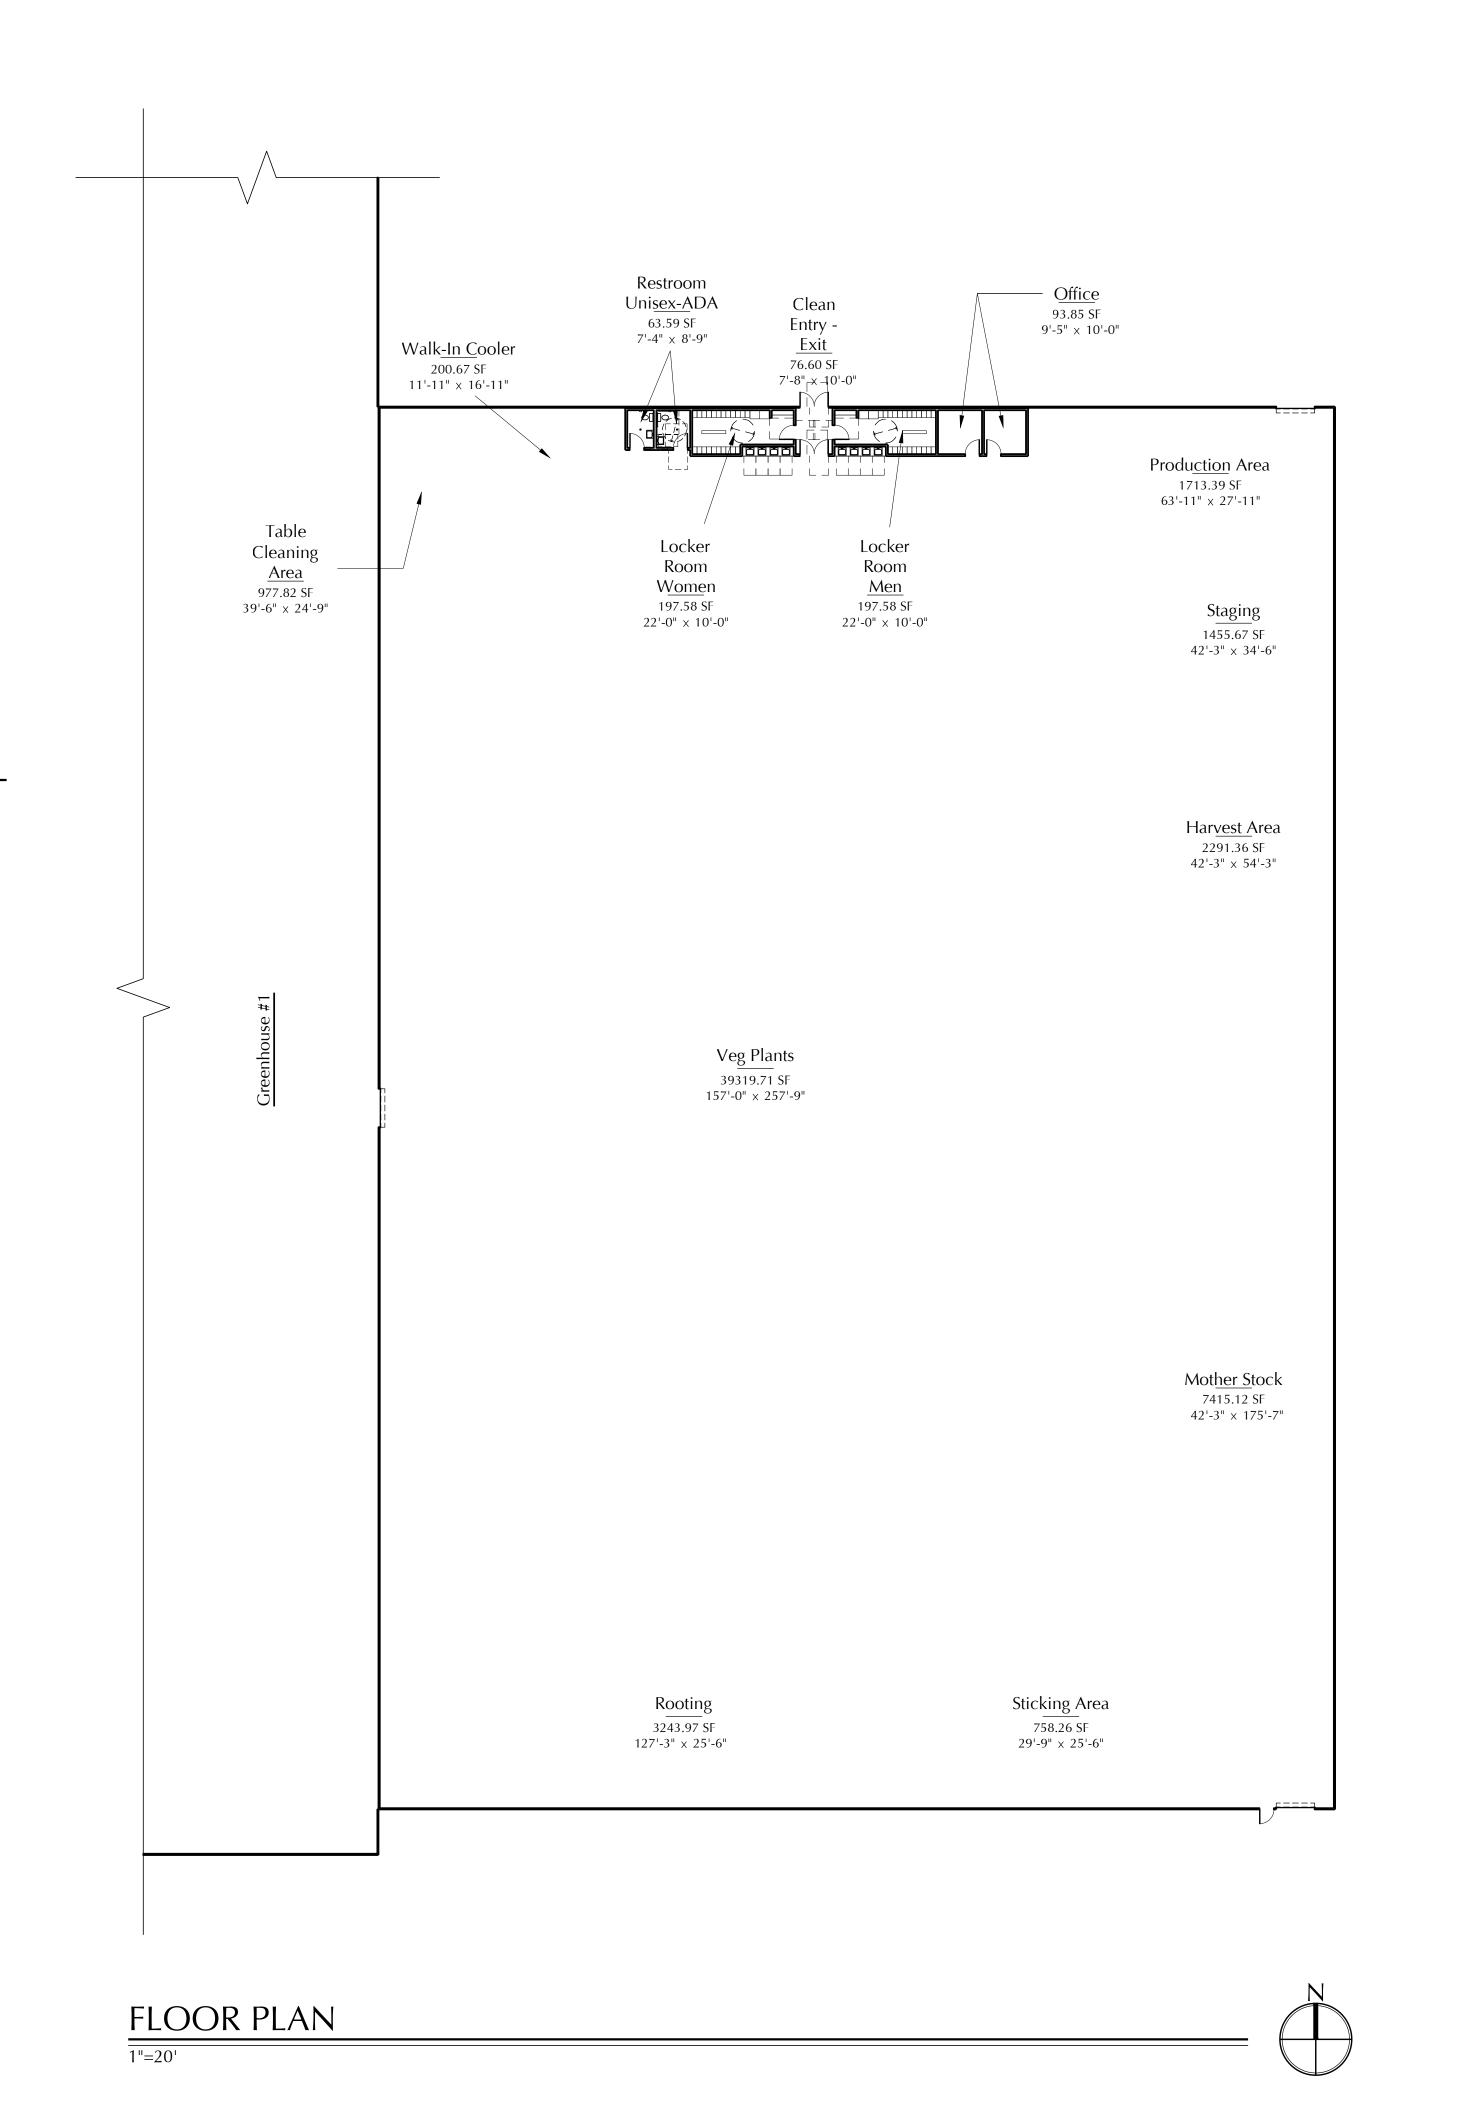



A R C H I T E C T U R E

924 anacapa st suite: 2-U santa barbara, ca 93101 805.564.6074

SLO CULTIVATION 3861 Foothill Rd Carpinteria, CA



sheet description GREENHOUSE ADDITION

8-7-2020 8-20-2020 8-28-2020 9-3-2020 9-9-2020 9-17-2020 12-9-2020 12-18-2020 12-29-2020 1-13-2021 2-3-2021 2-9-2021 2-10-2021 2-18-2021 4-27-2021 6-1-2021 7-6-2021 9-15-2021

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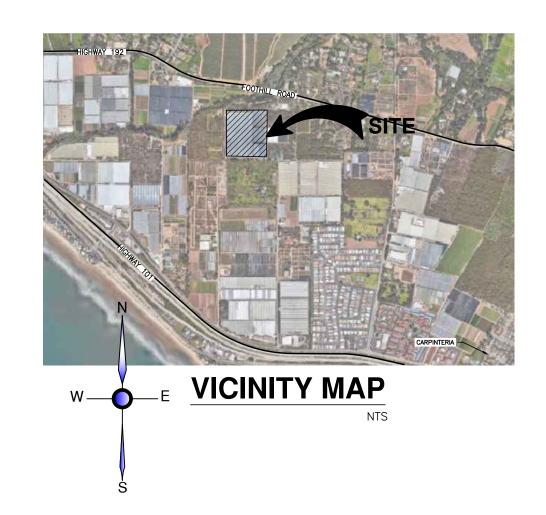
© BURNELL, BRANCH & PESTER ARCHITECTUR
Preliminary:


sheet no:

FOR

SLO CULTIVATION - 3861 FOOTHILL RD

CARPINTERIA, CALIFORNIA **COUNTY OF SANTA BARBARA**



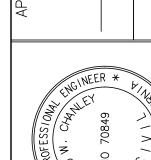



COUNTY GENERAL NOTES

- 1. OWNER AND OR OWNER'S CONTRACTOR SHALL PROTECT PUBLIC INFRASTRUCTURE FROM DAMAGE DURING THE COURSE OF CONSTRUCTION. NOTE: THE EXISTING STREET SECTIONS MAY BE SUBSTANDARD, AND THE CONTRACTOR SHALL PROTECT THE PUBLIC INFRASTRUCTURE FROM DAMAGE BY HEAVY LOADING/ EQUIPMENT DURING THE COURSE OF CONSTRUCTION. THE CONTRACTOR SHALL REPAIR, AT OWNER'S EXPENSE, ANY/ ALL DAMAGE TO PUBLIC INFRASTRUCTURE INCURRED DURING AND/ OR DUE TO CONSTRUCTION, TO THE SATISFACTION OF THE CITY
- 2. WHERE DETERMINED NECESSARY BY THE COUNTY ENGINEER, DAMAGED PORTIONS OF THE EXISTING CURB, GUTTER, AND SIDEWALK ALONG THE PROPERTY FRONTAGE SHALL BE REPLACED TO THE SATISFACTION OF THE CITY ENGINEER BEFORE FINAL
- 3. ENCROACHMENT PERMIT(S) MUST BE OBTAINED BEFORE ANY/ ALL WORK IN
- 4. COUNTY STREETS ARE TO REMAIN OPEN TO THROUGH TRAFFIC AT ALL TIMES. NO TEMPORARY OR LONG TERM PARKING OR STORAGE OF CONSTRUCTION EQUIPMENT OR MATERIALS SHALL OCCUR WITHOUT PRIOR ISSUANCE OF AN ENCROACHMENT
- 5. A TRAFFIC AND PEDESTRIAN CONTROL PLAN IS REQUIRED FOR ANY DETOURS OR REROUTING OF TRAFFIC. DURING CONSTRUCTION, IT SHALL BE THE RESPONSIBILITY OF THE CONTRACTOR TO PROVIDE FOR SAFE TRAFFIC CONTROL IN AND AROUND THE SITE. THIS MAY INCLUDE BUT SHALL NOT BE LIMITED TO SIGNS, FLASHING LIGHTS, BARRICADES AND FLAG PERSONS AS DIRECTED BY THE BUILDING OFFICIAL
- 6. EXCAVATION WITHIN THE STREETS SHALL BE COVERED WITH TRAFFIC RATED STEEL PLATES OR BACKFILLED AND PAVED, TO THE SATISFACTION OF THE COUNTY
- 7. EROSION AND DRAINAGE CONTROL FEATURES SHALL BE INSTALLED TO PREVENT SEDIMENT FROM LEAVING THE SITE. EROSION CONTROL DEVICES SHALL BE INSTALLED AND IN PLACE FOLLOWING DAILY CONSTRUCTION ACTIVITIES. THE APPLICANT SHALL NOTIFY THE ENGINEERING DIVISION OF ANY CHANGES IN CONSTRUCTION WHICH WILL REQUIRE ADDITIONAL EROSION CONTROL MEASURES OR OTHER CHANGES TO THE EROSION CONTROL PLAN.
- 8. WASTE MATERIALS SHALL NOT BE WASHED INTO THE STORM DRAIN SYSTEM. THIS INCLUDES BUT IS NOT LIMITED TO SOIL, PAINT, STUCCO, GROUT, COLOR COAT, CONCRETE DUST. SAW RESIDUES. GRINDINGS. OIL. ETC.
- 9. DURING THE CONSTRUCTION PERIOD, THE PROJECT FRONTAGE(S) SHALL BE SWEPT DAILY AND KEPT FREE OF DIRT, DUST AND DEBRIS. AT THE CONCLUSION OF CONSTRUCTION, PRIOR TO THE ISSUANCE OF AN OCCUPANCY PERMIT, THE FRONTAGE(S) SHALL BE INSPECTED BY THE CITY ENGINEER AND REPAIRS COMPLETED AS DIRECTED TO THE SATISFACTION OF THE COUNTY ENGINEER.

COUNTY GRADING NOTES

- 1. LOT GRADING SHALL MEET THE MINIMUM REQUIREMENTS OF THE LATEST CBC
- 2. DRAINAGE SHALL BE CARRIED TO THE STREET OR OTHER IMPROVED DRAINAGE DEVICE VIA A NON-EROSIVE DRAINAGE DEVICE.
- 3. NO GRADING OR DRAINAGE IMPROVEMENTS WHICH ALTER EXISTING DRAINAGE COURSES OR CONCENTRATE DRAINAGE TO ADJACENT PROPERTIES SHALL BE ALLOWED WITHOUT PRIOR APPROVAL FROM THE COUNTY ENGINEER.

COUNTY STANDARD EROSION CONTROL NOTES

- 1. EROSION CONTROL MEASURES SHALL BE FULLY INSTALLED AT ALL TIMES.
- 2. EROSION CONTROL MEASURES SHALL BE FULLY INSTALLED PRIOR TO GROUND DISTURBANCE. CITY STAFF SHALL BE NOTIFIED AND INSPECT PRIOR TO GROUND
- 3. ALL SITE ACCESS SHALL BE PROTECTED AGAINST EROSION AT ALL TIMES THAT WORK IS NOT BEING PERFORMED ON THE SITE, INCLUDING EVENINGS, WEEKENDS AND HOLIDAYS. SUCH PROTECTION MAY BE REMOVED TO PROVIDE ACCESS TO THE SITE DURING WORK HOURS IF AND WHEN IT IS NOT REQUIRED DUE TO WEATHER
- 4. PROPERTY FRONTAGE SHALL BE SWEPT CLEAN AT THE END OF EACH DAY.
- 5. THE FIRST DOWNSTREAM STORM DRAIN INLET SHALL BE PROTECTED PER DETAIL.
- 6. ALL STOCKPILES SHALL BE PROTECTED AGAINST WIND AND WATER EROSION, PER DETAIL, IMMEDIATELY UPON PLACEMENT.
- 7. PERMANENT EROSION CONTROL MEASURES SHALL BE FULLY ESTABLISHED TO THE SATISFACTION OF THE CITY ENGINEER PRIOR TO FINAL.
- 8. STRUCTURAL STORMWATER CONTROL MEASURES SHALL BE INSPECTED BY THE ENGINEER OF RECORD AND CITY STAFF AT THE TIME OF INSTALLATION.
- 9. PROJECTS SUBJECT TO POST—CONSTRUCTION REQUIREMENTS SHALL HAVE STORMWATER CONTROL PLAN RECORDED WITH THE COUNTY OF SAN LUIS OBISPO PRIOR TO FINAL.
- 10. IN THE EVENT OF OFF-SITE EROSION, THE PROPERTY OWNER AND/ OR HIS REPRESENTATIVE(S) SHALL BE RESPONSIBLE FOR CLEANUP AND ALL ASSOCIATED COSTS OR DAMAGÉS.
- 11. EROSION CONTROL PLANS REPRESENT THE MINIMUM ACCEPTABLE PROTECTION. FURTHER MEASURES WILL BE REQUIRED, TO THE SATISFACTION OF THE COUNTY ENGINEER IN THE EVENT OF INADEQUACY OR FAILURE.



Sheet List Table					
SHEET NUMBER	REV	DRAWING TITLE			
C1	А	TITLE SHEET			
C2	А	GRADING - KEY MAP			
C3	А	GRADING-PROCESSING BUILDING			
C4	А	GRADING-GREENHOUSE ADDITION			
C5	А	GRADING-BASINS			
C6	А	CROSS SECTIONS A-B			
C7	А	UTILITY PLAN			
C8	А	EROSION CONTROL PLAN			
C9	А	EROSION CONTROL DETAILS			
C10	А	DETAILS SHEET			

EARTHWORK QUANTITIES

BASIN GRADING:
• 4,640 CUT CUBIC YARDS
• 345 FILL CUBIC YARDS
•4,295 EXPORT CUBIC YARDS
•40,485 SQ. FT. DISTURBED AREA (0.93 AC)
<u> </u>

EARTHWORK NUMBERS DO NOT INCLUDE SHRINKAGE

DECLARATION OF RESPONSIBLE CHARGE

I HEREBY DECLARE THAT I AM THE ENGINEER OF RECORD FOR THIS PROJECT AND THAT I HAVE EXERCISED RESPONSIBLE CHARGE OVER THE PROJECT AS DEFINED IN SECTION 6703 OF THE BUSINESS AND PROFESSIONS CODE. THESE PLANS AND SPECIFICATIONS, TO THE BEST OF MY KNOWLEDGE, COMPLY WITH CURRENT STANDARDS.

ANY ERRORS, OMISSIONS, OR OTHER VIOLATIONS OF THOSE ORDINANCES, STANDARDS OR DESIGN CRITERIA ENCOUNTERED DURING CONSTRUCTION SHALL BE CORRECTED AND SUCH CORRECTIONS REFLECTED ON CORRECTED PLANS.

PROJECT CONTACTS:

CRESCO LABS 400W. ERIE STREET SUITE 110 CHICAGO, IL 60654

SCS ENGINEERS NATHAN EADY 2370 SKYWAY DRIVE, SUITE 101 SANTA MARIA, CA 93455

DIVERSIFIED PROJECT SERVICES INTERNATIONAL 705 FIERO LANE, SUITE 10 SAN LUIS OBISPO, CA 93401 PH: (805)250-2891 CONTACT: ALBERTO LOPEZ

BBP ARCHITECTURE TRACY BURNELL 924 ANACAPA STREET, SUITE:2-U SANTA BARBARA, CA 93101

ALOPEZ@DPSIINC.COM

PH: (805) 564-6074

GEOCON WEST, INC. REX PANOY 3303 NORTH SAN FERNANDO BOULEVARD SUITE 100 BURBANK, CA 91504

SITE INFORMATION

LOCATION: 3861 FOOTHILL RD, CARPINTERIA, CA 93110 APN: 005-310-024 SITE AREA: 13.66 ACRES

BENCHMARK

ELEVATIONS SHOWN HEREON ARE NAVD88 AND CONTROL WAS PREVIOUSLY ESTABLISHED BY STANTEC.

BASIS OF BEARINGS

THE "BASIS OF BEARING" IS GRID NORTH STATE PLANE COORDINATES FOR ZONE 5 AND OBSERVED LOCALLY BY GPS OBSERVATION.

UNDERGROUND UTILITY STATEMENT

THE EXISTENCE AND LOCATION OF ANY UNDERGROUND UTILITY PIPES OR STRUCTURES SHOWN ON THESE PLANS ARE OBTAINED BY A SEARCH OF THE AVAILABLE RECORDS. TO THE BEST OF OUR KNOWLEDGE THERE ARE NO EXISTING UTILITIES EXCEPT AS SHOWN ON

THE CONTRACTOR IS REQUIRED TO TAKE DUE PRECAUTIONARY MEASURES TO PROTECT THE UTILITY LINES SHOWN AND ANY OTHER LINES NOT OF RECORD OR NOT SHOWN ON THIS DRAWING.

ENGINEER SHALL NOT BE RESPONSIBLE FOR THE ACCURACY OR COMPLETENESS OF ANY SUCH INFORMATION OR DATA. UNDERGROUND SERVICE ALERT SHALL BE CONTACTED TWO WORKING DAYS PRIOR TO CONSTRUCTION BY CALLING (800) 642-2444.

SCOPE OF WORK

GRADING AND DRAINAGE PLAN FOR IMPROVEMENT PLAN OF EXISTING FACILITY INCLUDING DRIVEWAY, DRIVE AISLES, PARKING STALLS, SWALES, DRAINAGE BASINS AND TRASH ENCLOSURES.

LEGEND


	EXISTING CONTOURS - MAJOR
	EXISTING CONTOURS - MINOR
_ · _ · _ · _	EXISTING GRADE BREAK
o	EXISTING CHAINLINK FENCE
X	EXISTING BARB WIRE FENCE
100	CONTOURS - MAJOR
	CONTOURS - MINOR
	GRADE BREAK
	LIMITS OF GRADING
D	STORM DRAIN (SIZE AS NOTED)
→ ···	FLOW LINE
X	EXISTING CHAIN LINK FENCE


DIAL TOLL FREE 811 OR (1-800-227-2600) AT LEAST TWO DAYS BEFORE YOU DIG UNDERGROUND SERVICE ALERT OF CALIFORNIA


THE DELIVERY OF THIS DRAWING SHOULD NOT BE CONSTRUED TO PROVIDE AN EXPRESS WARRANTY OF GUARANTEE TO ANYONE THAT ALL DIMENSIONS AND DETAILS ARE EXACT OR TO INDICATE THAT THE USE OF DRAWING IMPLIES THE REVIEW AND APPROVAL OF DPSLOF ANY FUTURE USE. ANY USE OF THIS INFORMATION IS AT THE SOLE RISK OF THE USER.

DAVID W. CHANLEY

R.C.E. 70849

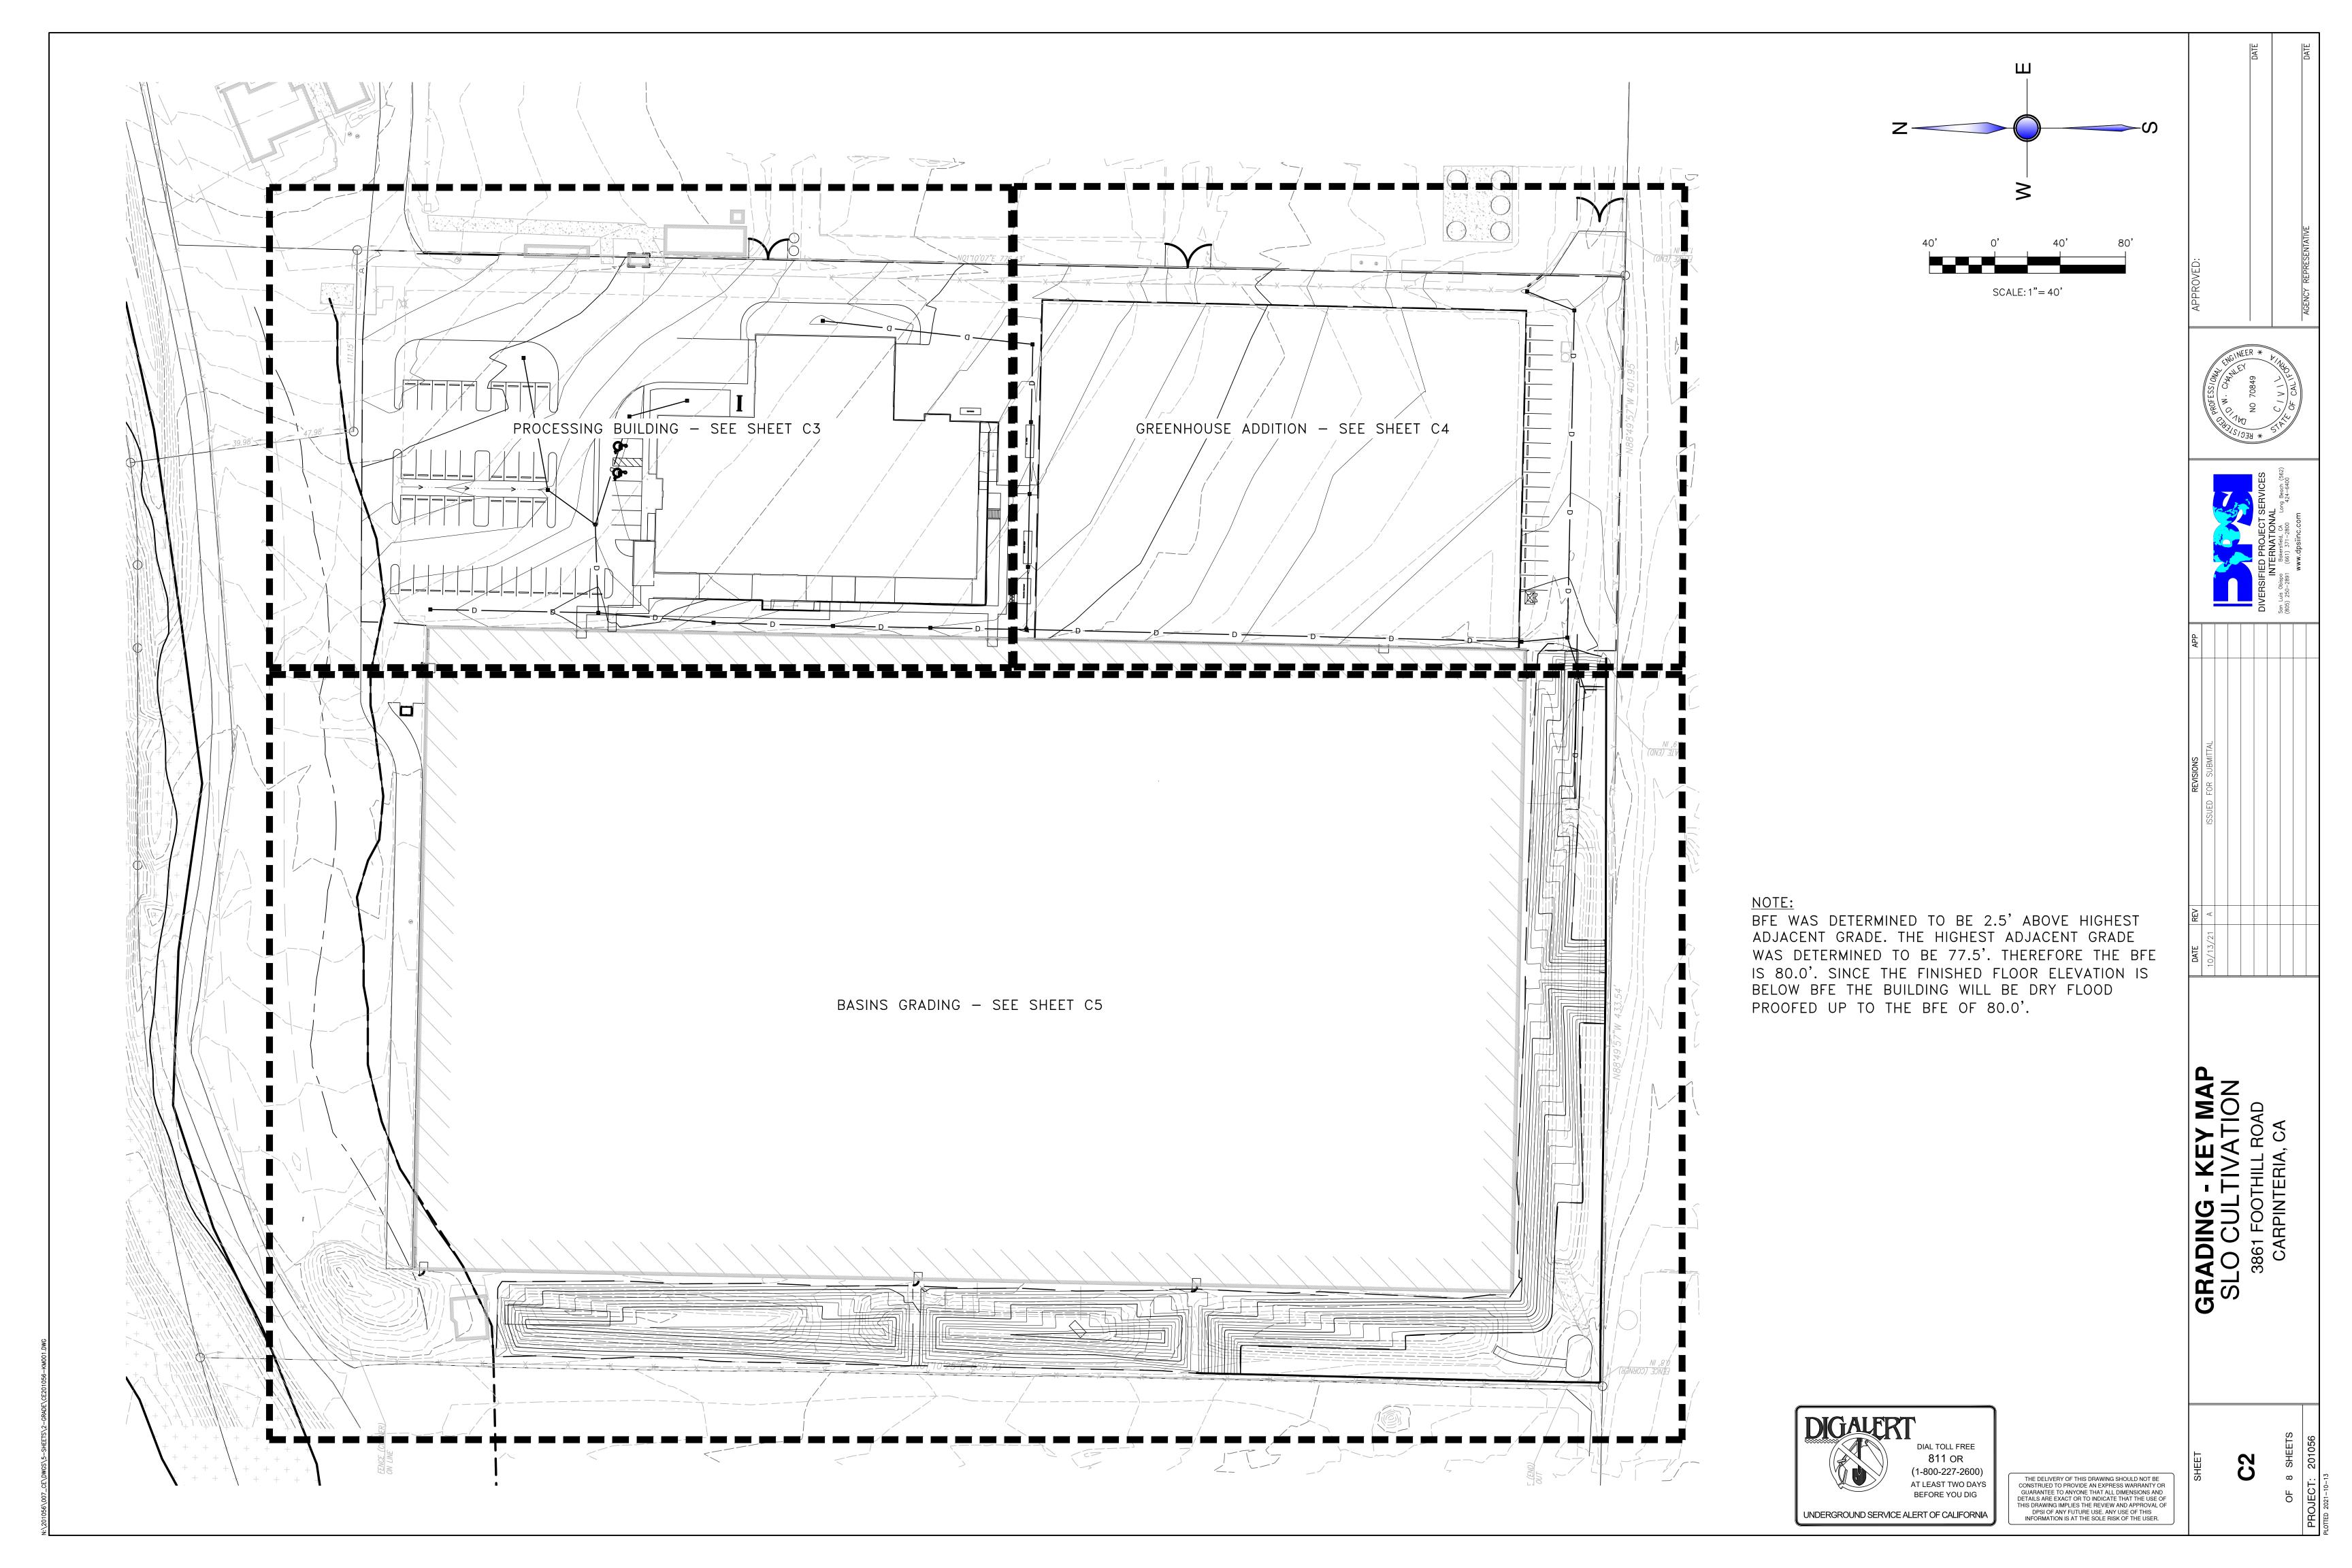

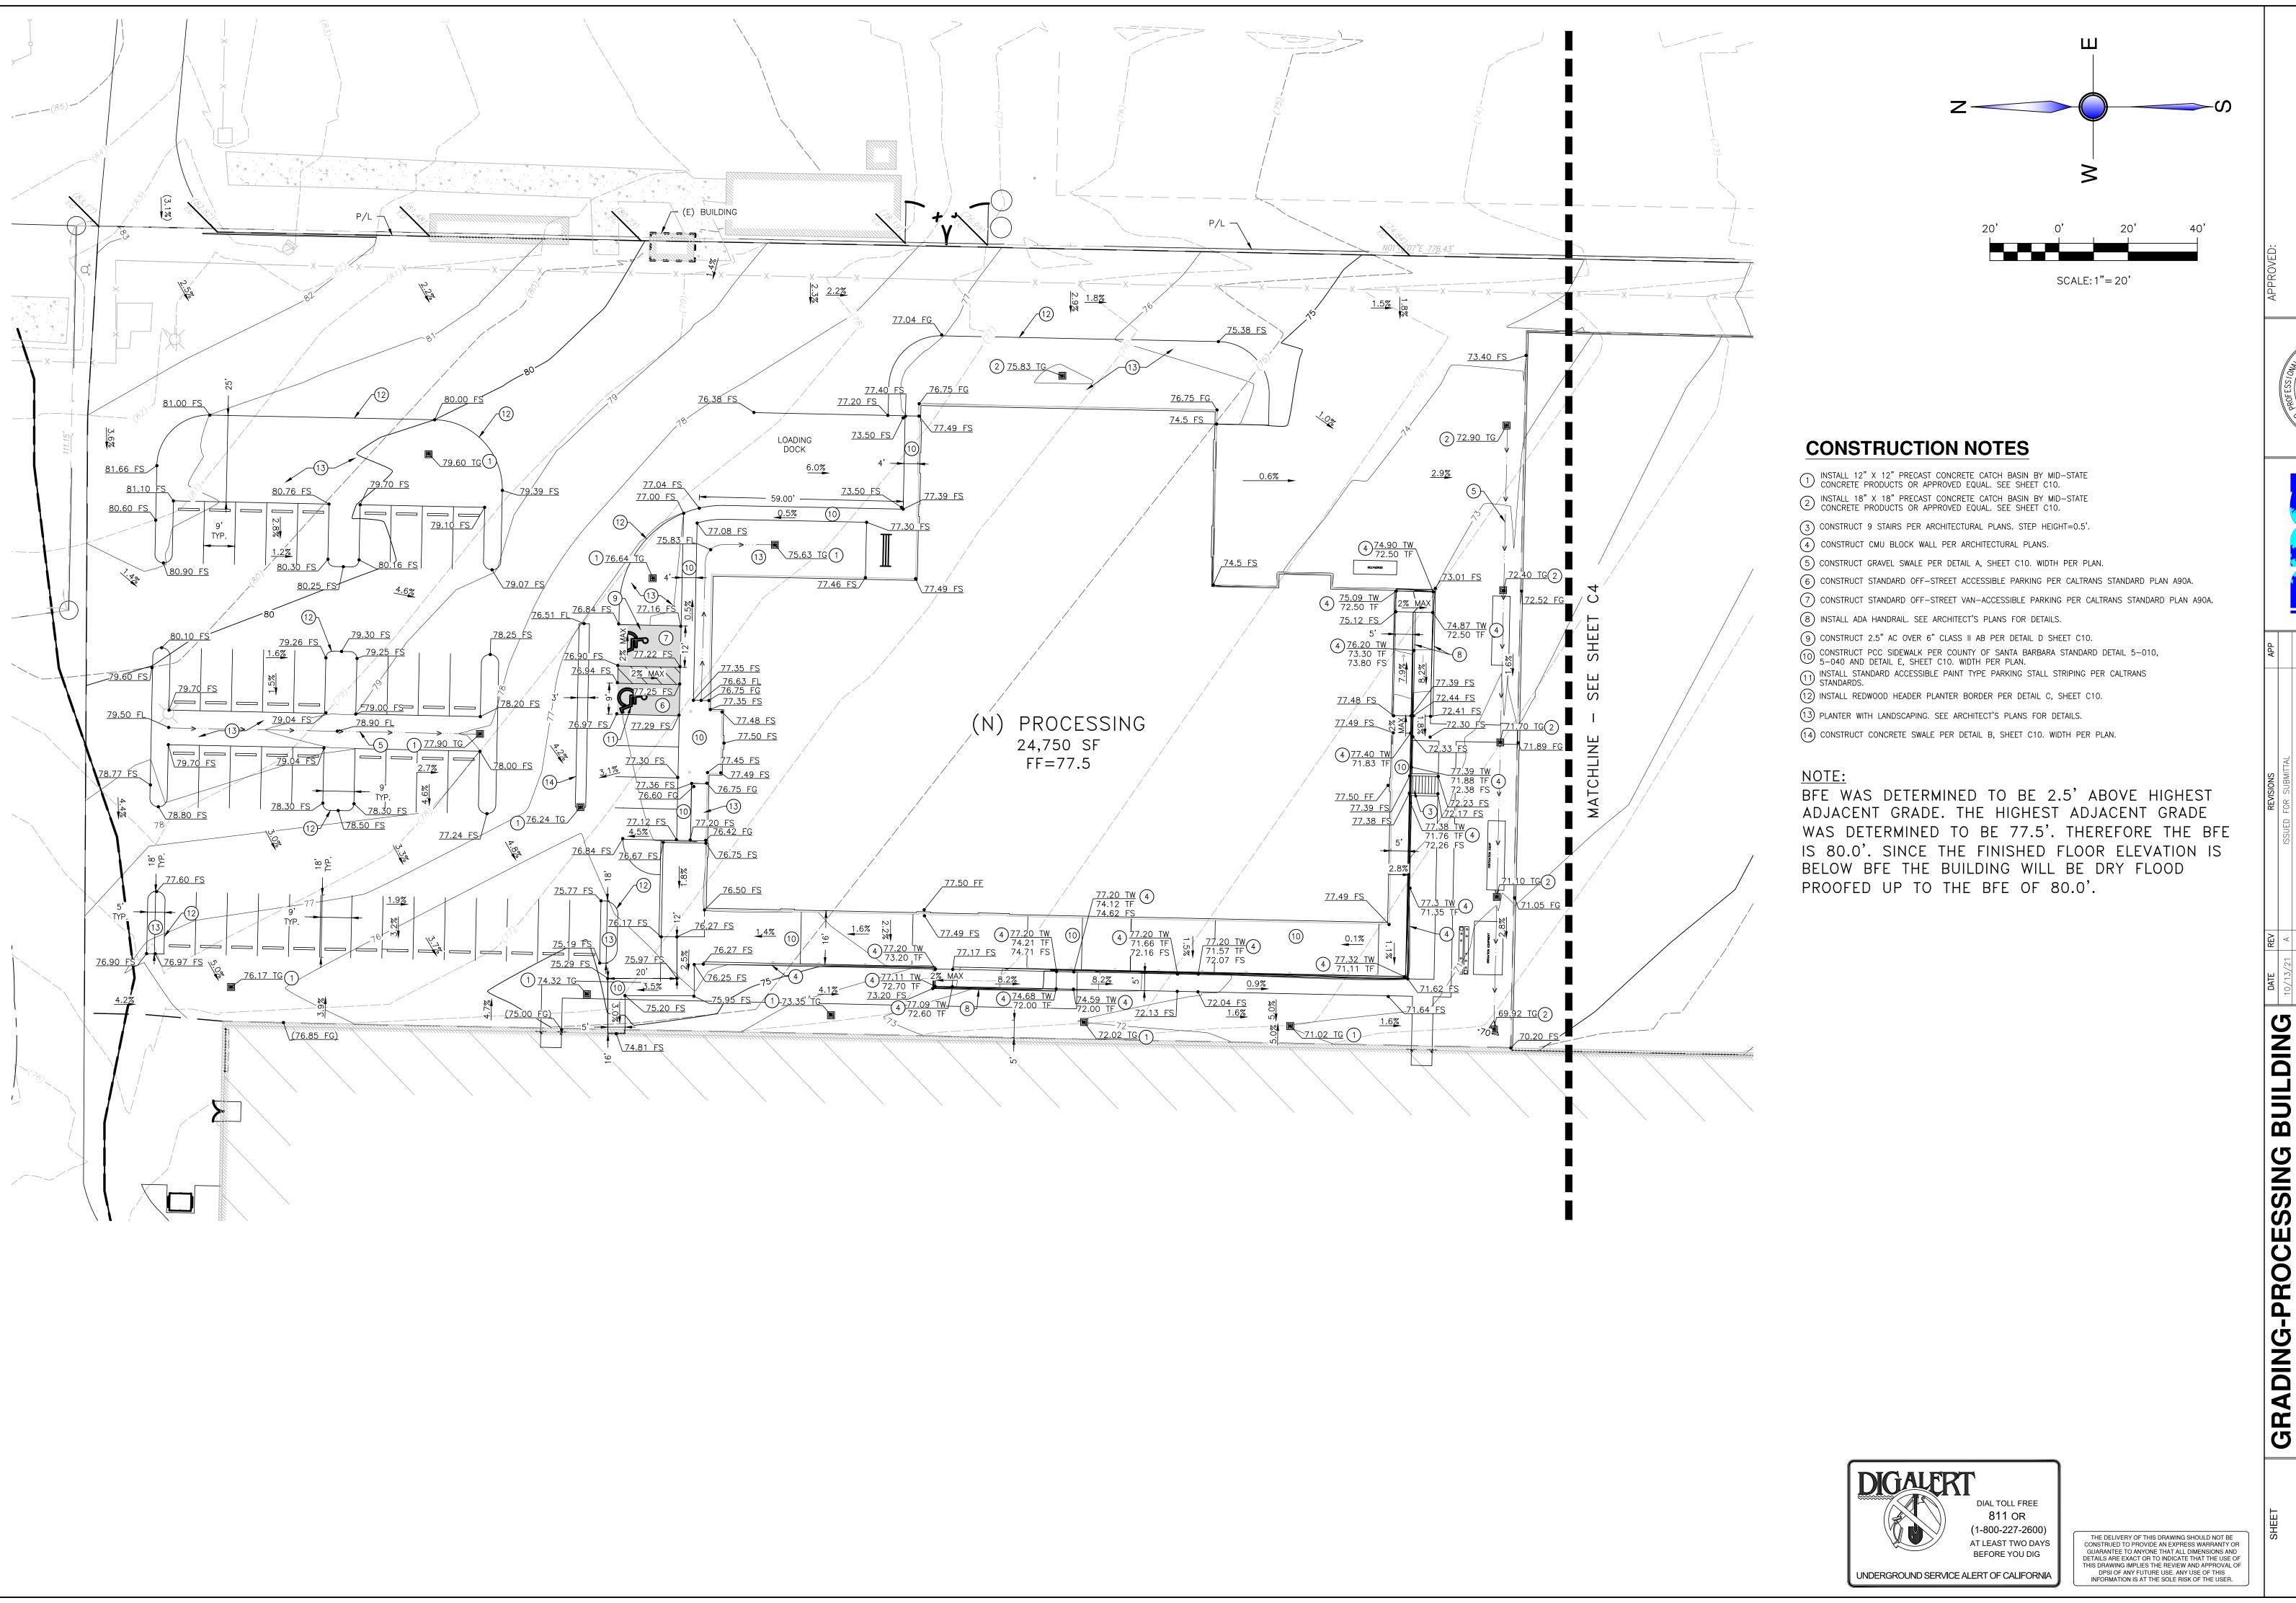


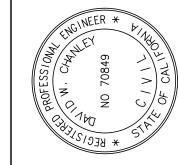




GRADING-PROCESSING BUILDING
SLO CULTIVATION
3861 FOOTHILL ROAD
CARPINTERIA, CA


C3

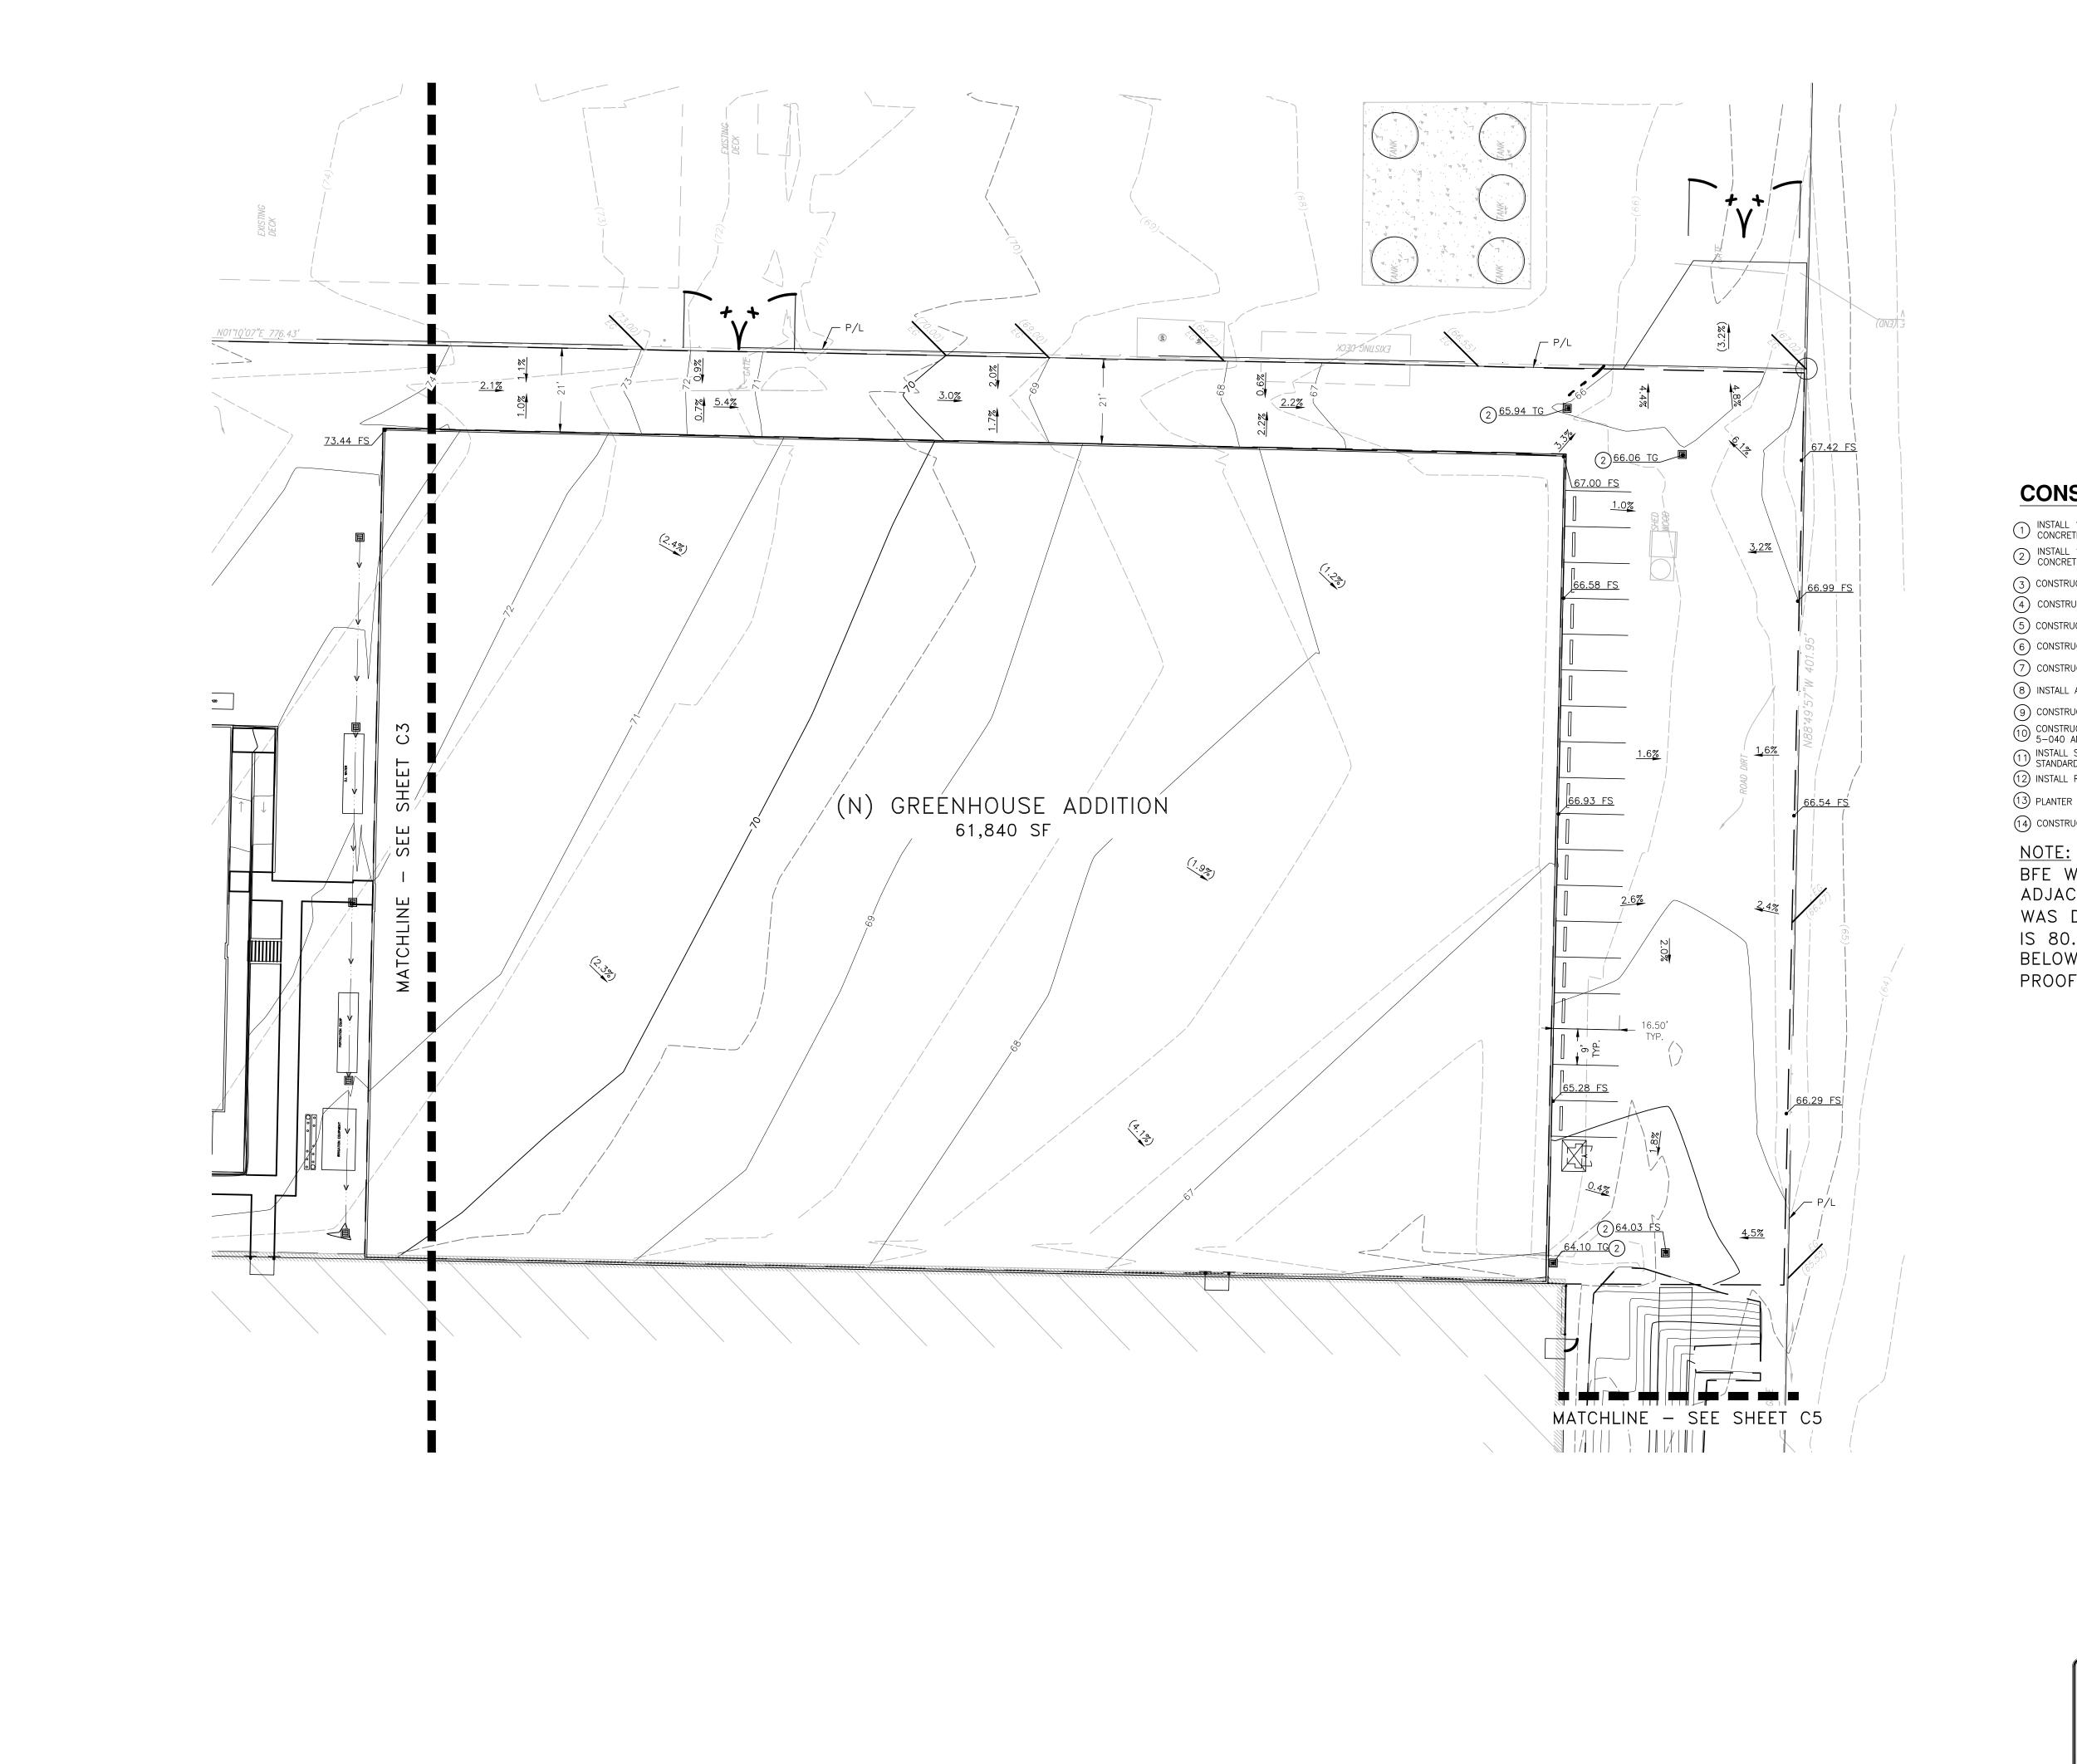


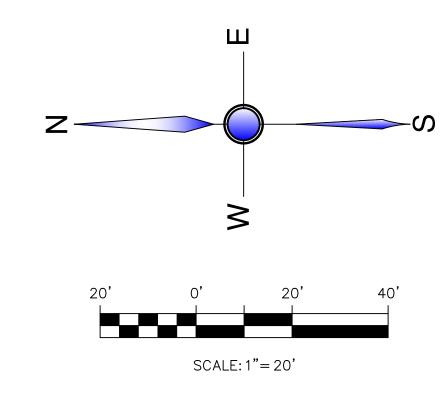

CONSTRUCTION NOTES

- 1) INSTALL 12" X 12" PRECAST CONCRETE CATCH BASIN BY MID-STATE CONCRETE PRODUCTS OR APPROVED EQUAL. SEE SHEET C10.
- 2 INSTALL 18" X 18" PRECAST CONCRETE CATCH BASIN BY MID-STATE CONCRETE PRODUCTS OR APPROVED EQUAL. SEE SHEET C10.
- (3) CONSTRUCT 9 STAIRS PER ARCHITECTURAL PLANS. STEP HEIGHT=0.5'.
- (4) CONSTRUCT CMU BLOCK WALL PER ARCHITECTURAL PLANS.
- (5) CONSTRUCT GRAVEL SWALE PER DETAIL A, SHEET C10. WIDTH PER PLAN.
- (6) CONSTRUCT STANDARD OFF-STREET ACCESSIBLE PARKING PER CALTRANS STANDARD PLAN A90A.
- 7 CONSTRUCT STANDARD OFF-STREET VAN-ACCESSIBLE PARKING PER CALTRANS STANDARD PLAN A90A.
- (8) INSTALL ADA HANDRAIL. SEE ARCHITECT'S PLANS FOR DETAILS.
- (9) CONSTRUCT 2.5" AC OVER 6" CLASS II AB PER DETAIL D SHEET C10.
- CONSTRUCT PCC SIDEWALK PER COUNTY OF SANTA BARBARA STANDARD DETAIL 5-010, 5-040 AND DETAIL E, SHEET C10. WIDTH PER PLAN.
- INSTALL STANDARD ACCESSIBLE PAINT TYPE PARKING STALL STRIPING PER CALTRANS STANDARDS.
- (12) INSTALL REDWOOD HEADER PLANTER BORDER PER DETAIL C, SHEET C10.
- (13) PLANTER WITH LANDSCAPING. SEE ARCHITECT'S PLANS FOR DETAILS. (14) CONSTRUCT CONCRETE SWALE PER DETAIL B, SHEET C10. WIDTH PER PLAN.
- BFE WAS DETERMINED TO BE 2.5' ABOVE HIGHEST ADJACENT GRADE. THE HIGHEST ADJACENT GRADE WAS DETERMINED TO BE 77.5'. THEREFORE THE BFE IS 80.0'. SINCE THE FINISHED FLOOR ELEVATION IS BELOW BFE THE BUILDING WILL BE DRY FLOOD PROOFED UP TO THE BFE OF 80.0'.

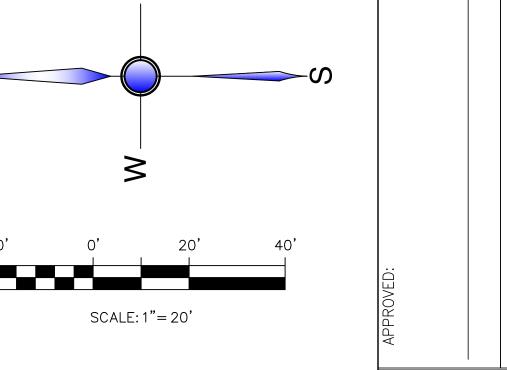

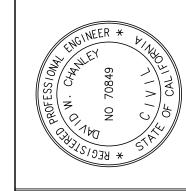





GRADING-GREENHOUSE ADDITION
SLO CULTIVATION
3861 FOOTHILL ROAD
CARPINTERIA, CA

C4

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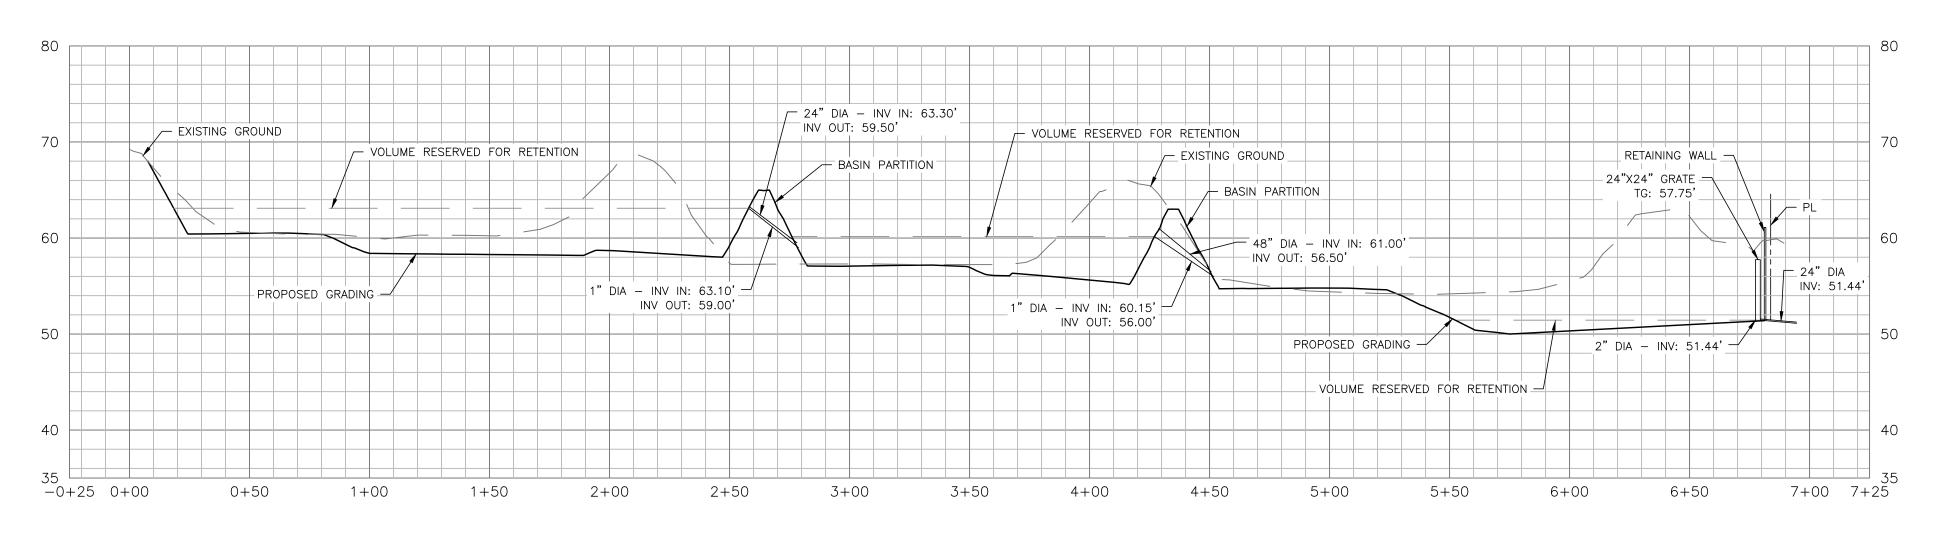
DIGALERT DIAL TOLL FREE 811 OR (1-800-227-2600) AT LEAST TWO DAYS BEFORE YOU DIG UNDERGROUND SERVICE ALERT OF CALIFORNIA



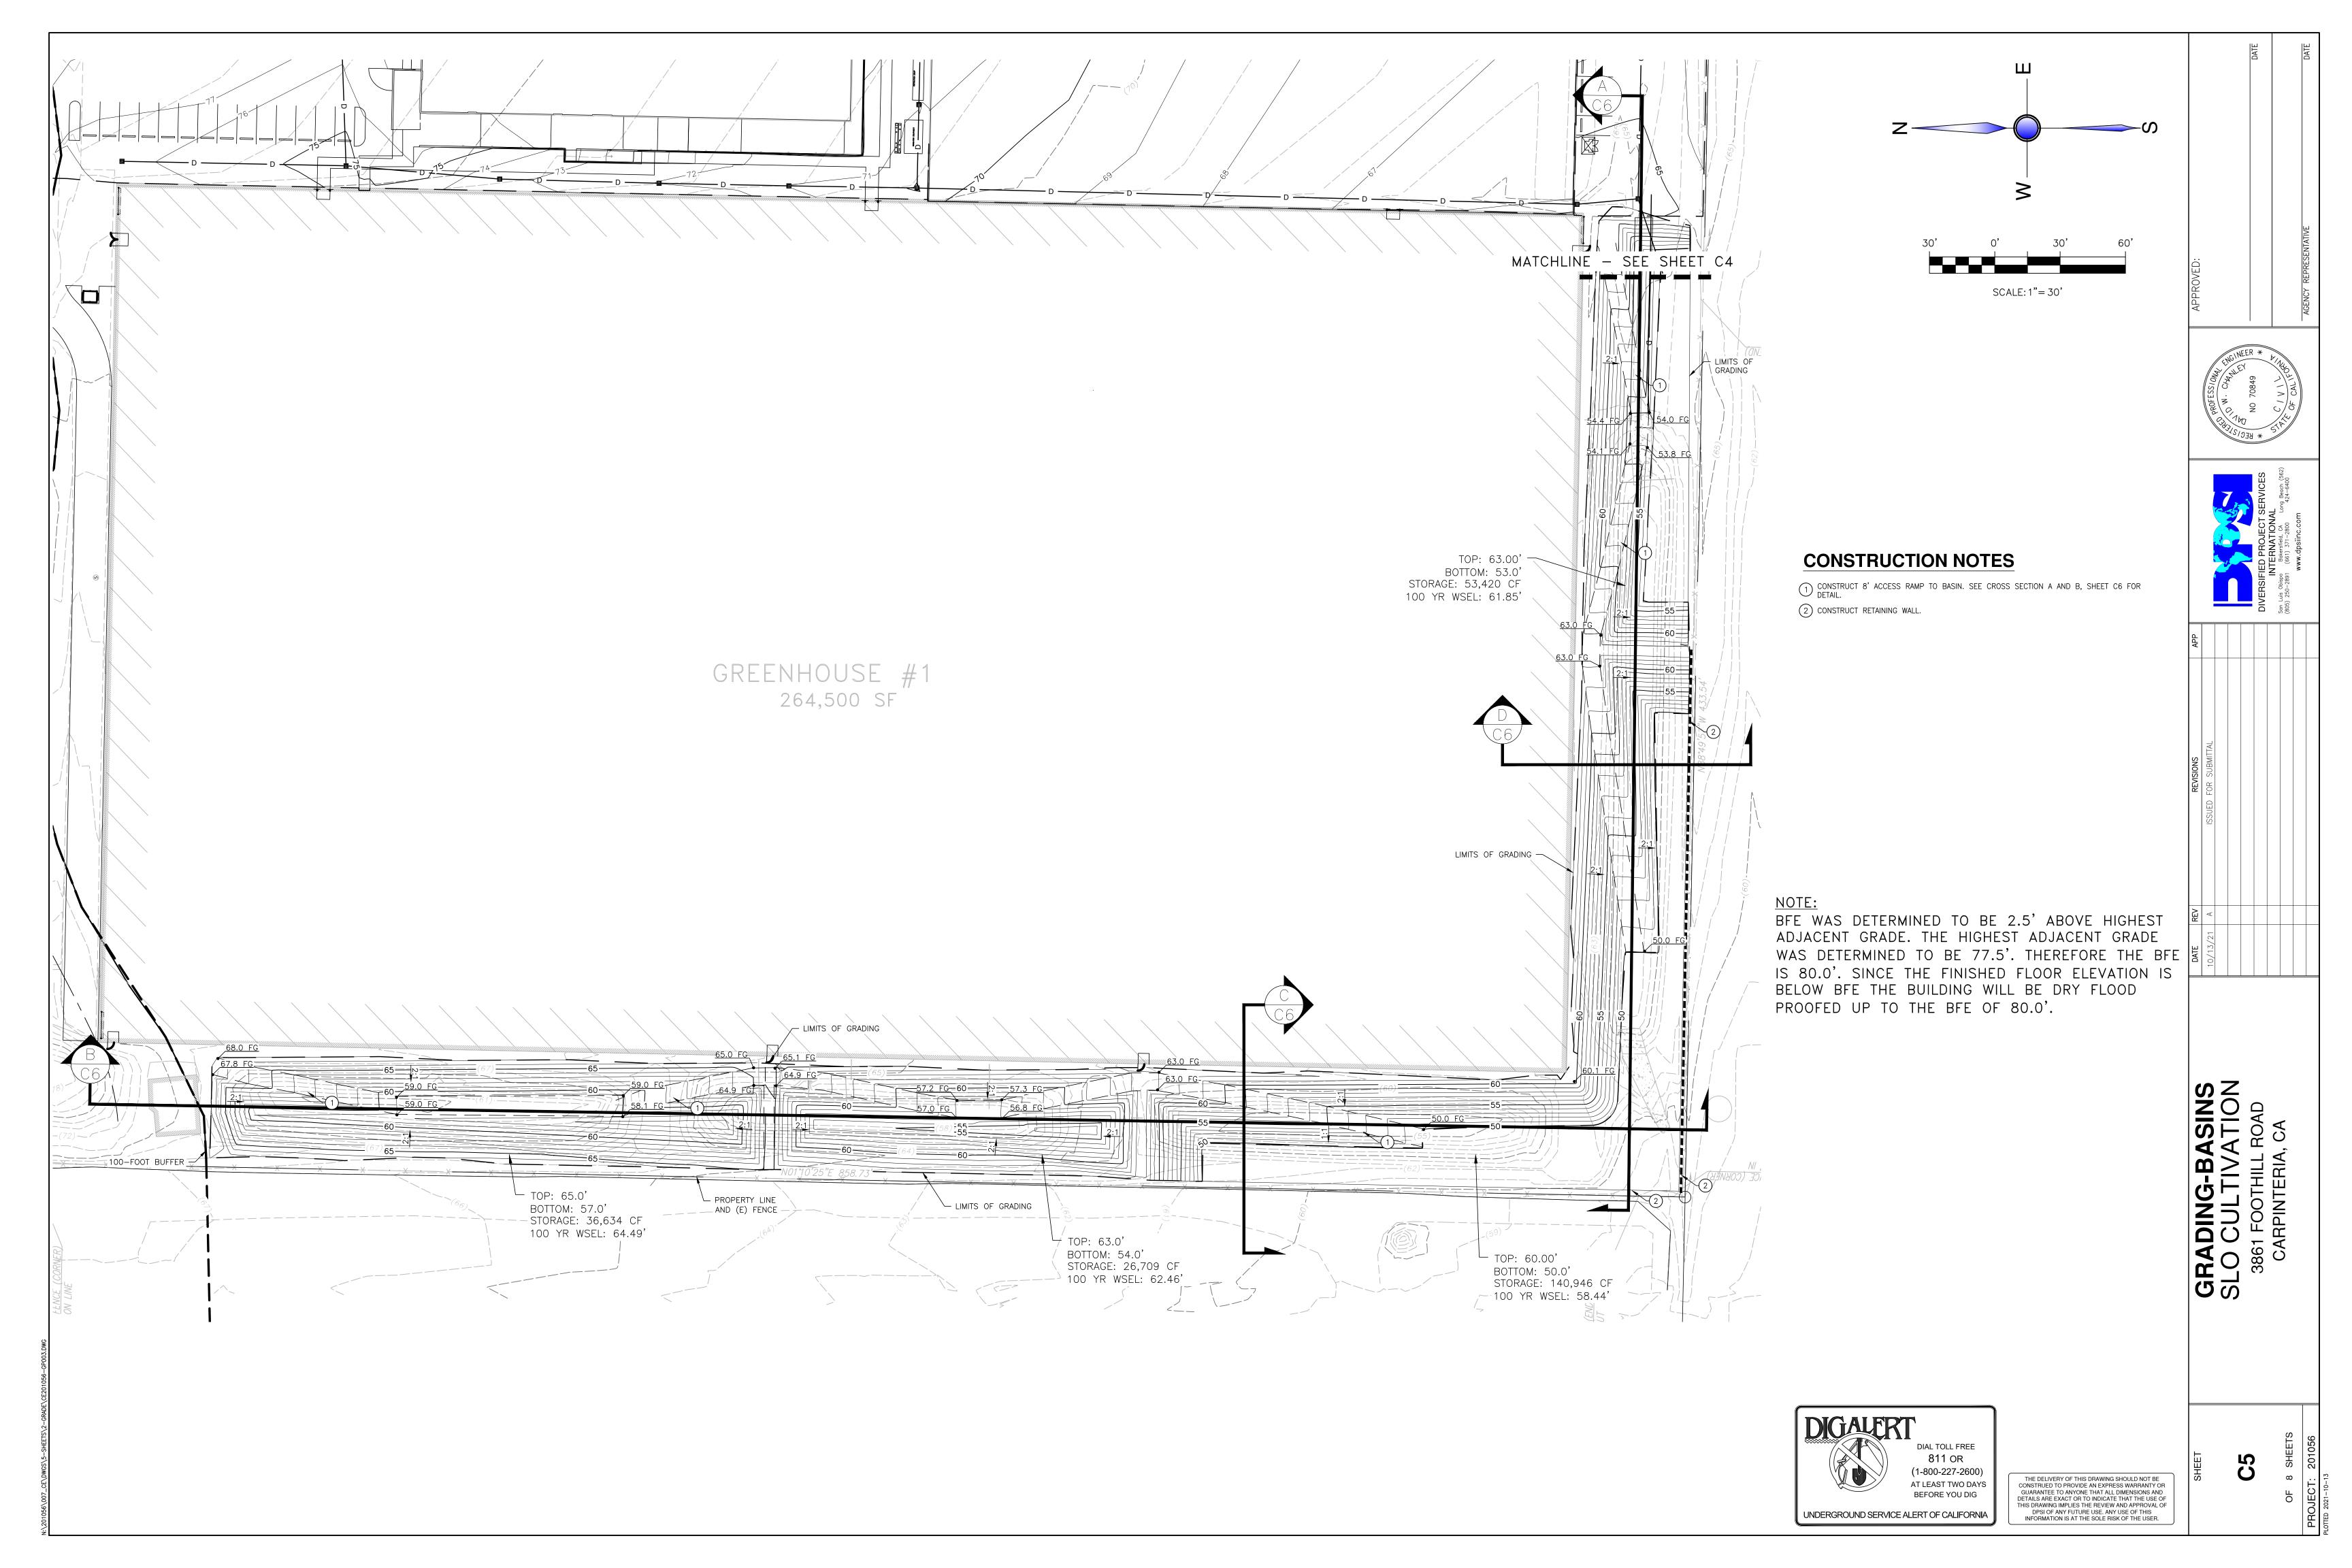


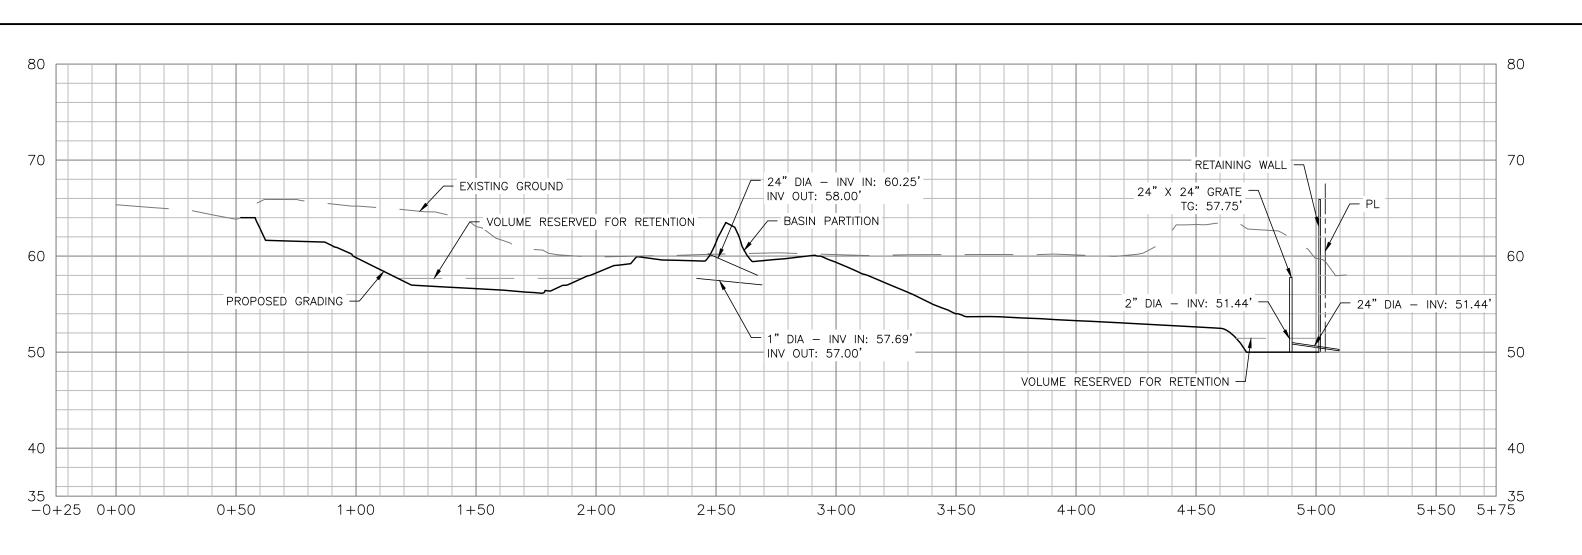EXPANDED BASIN


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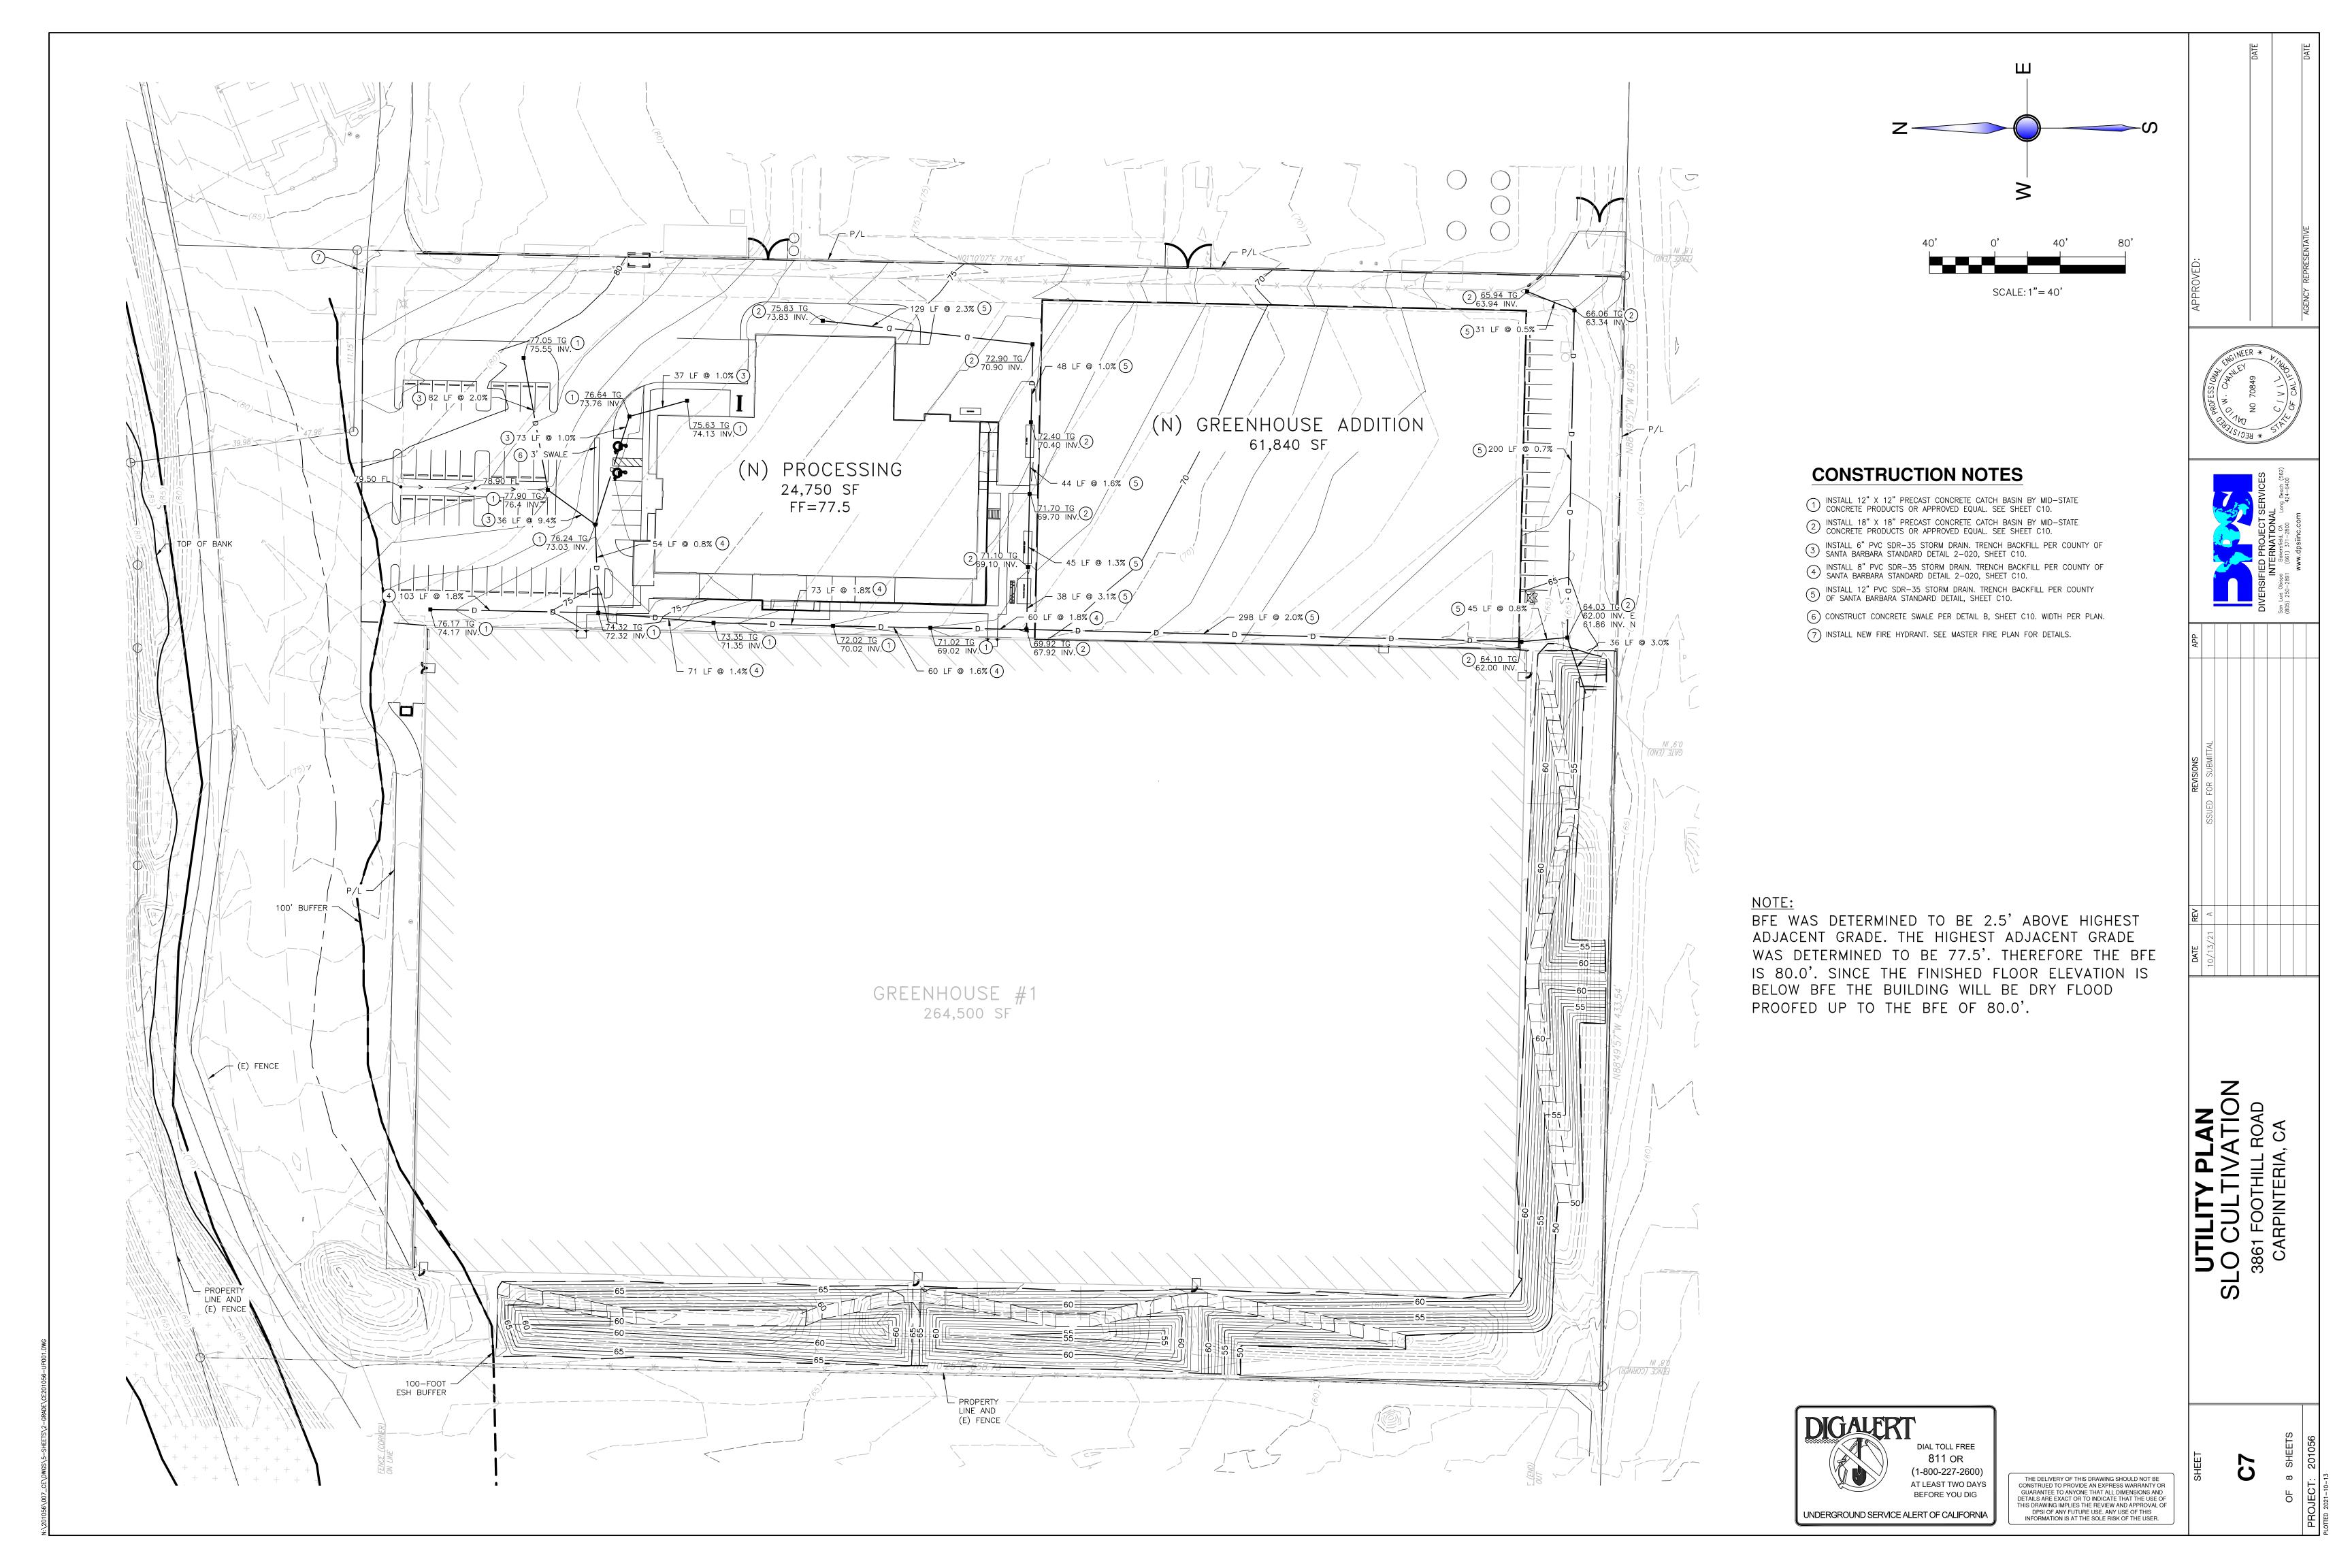





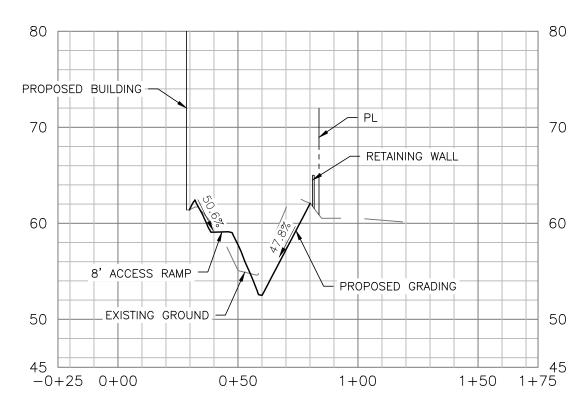



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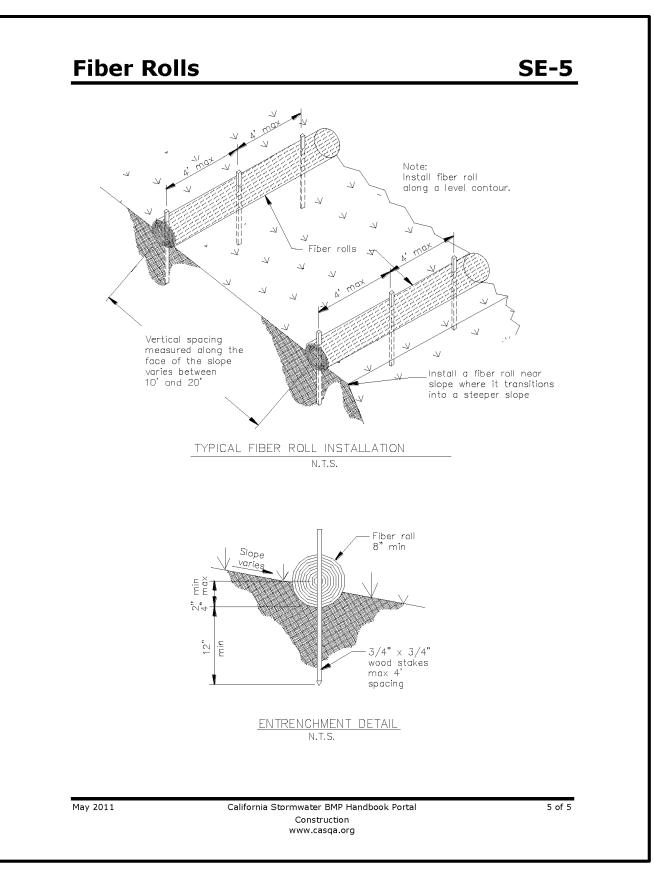
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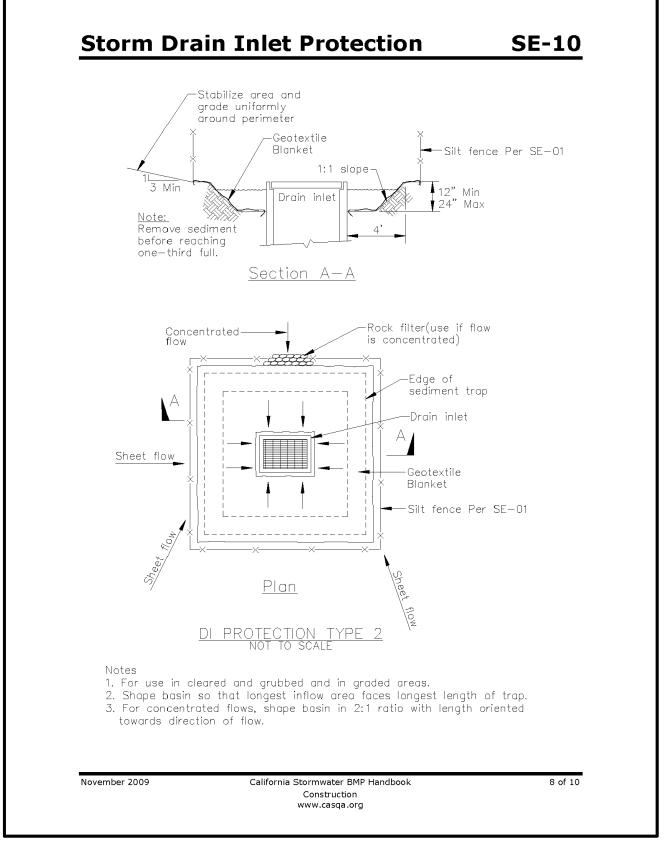





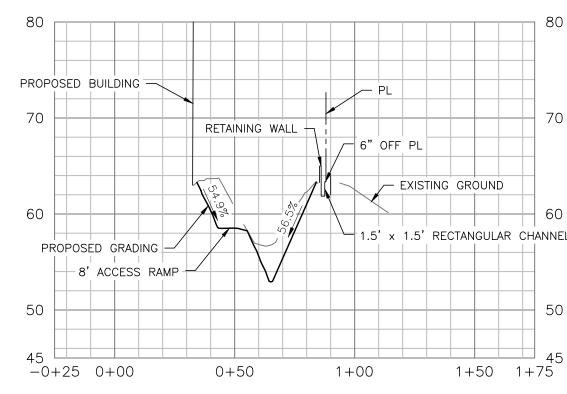


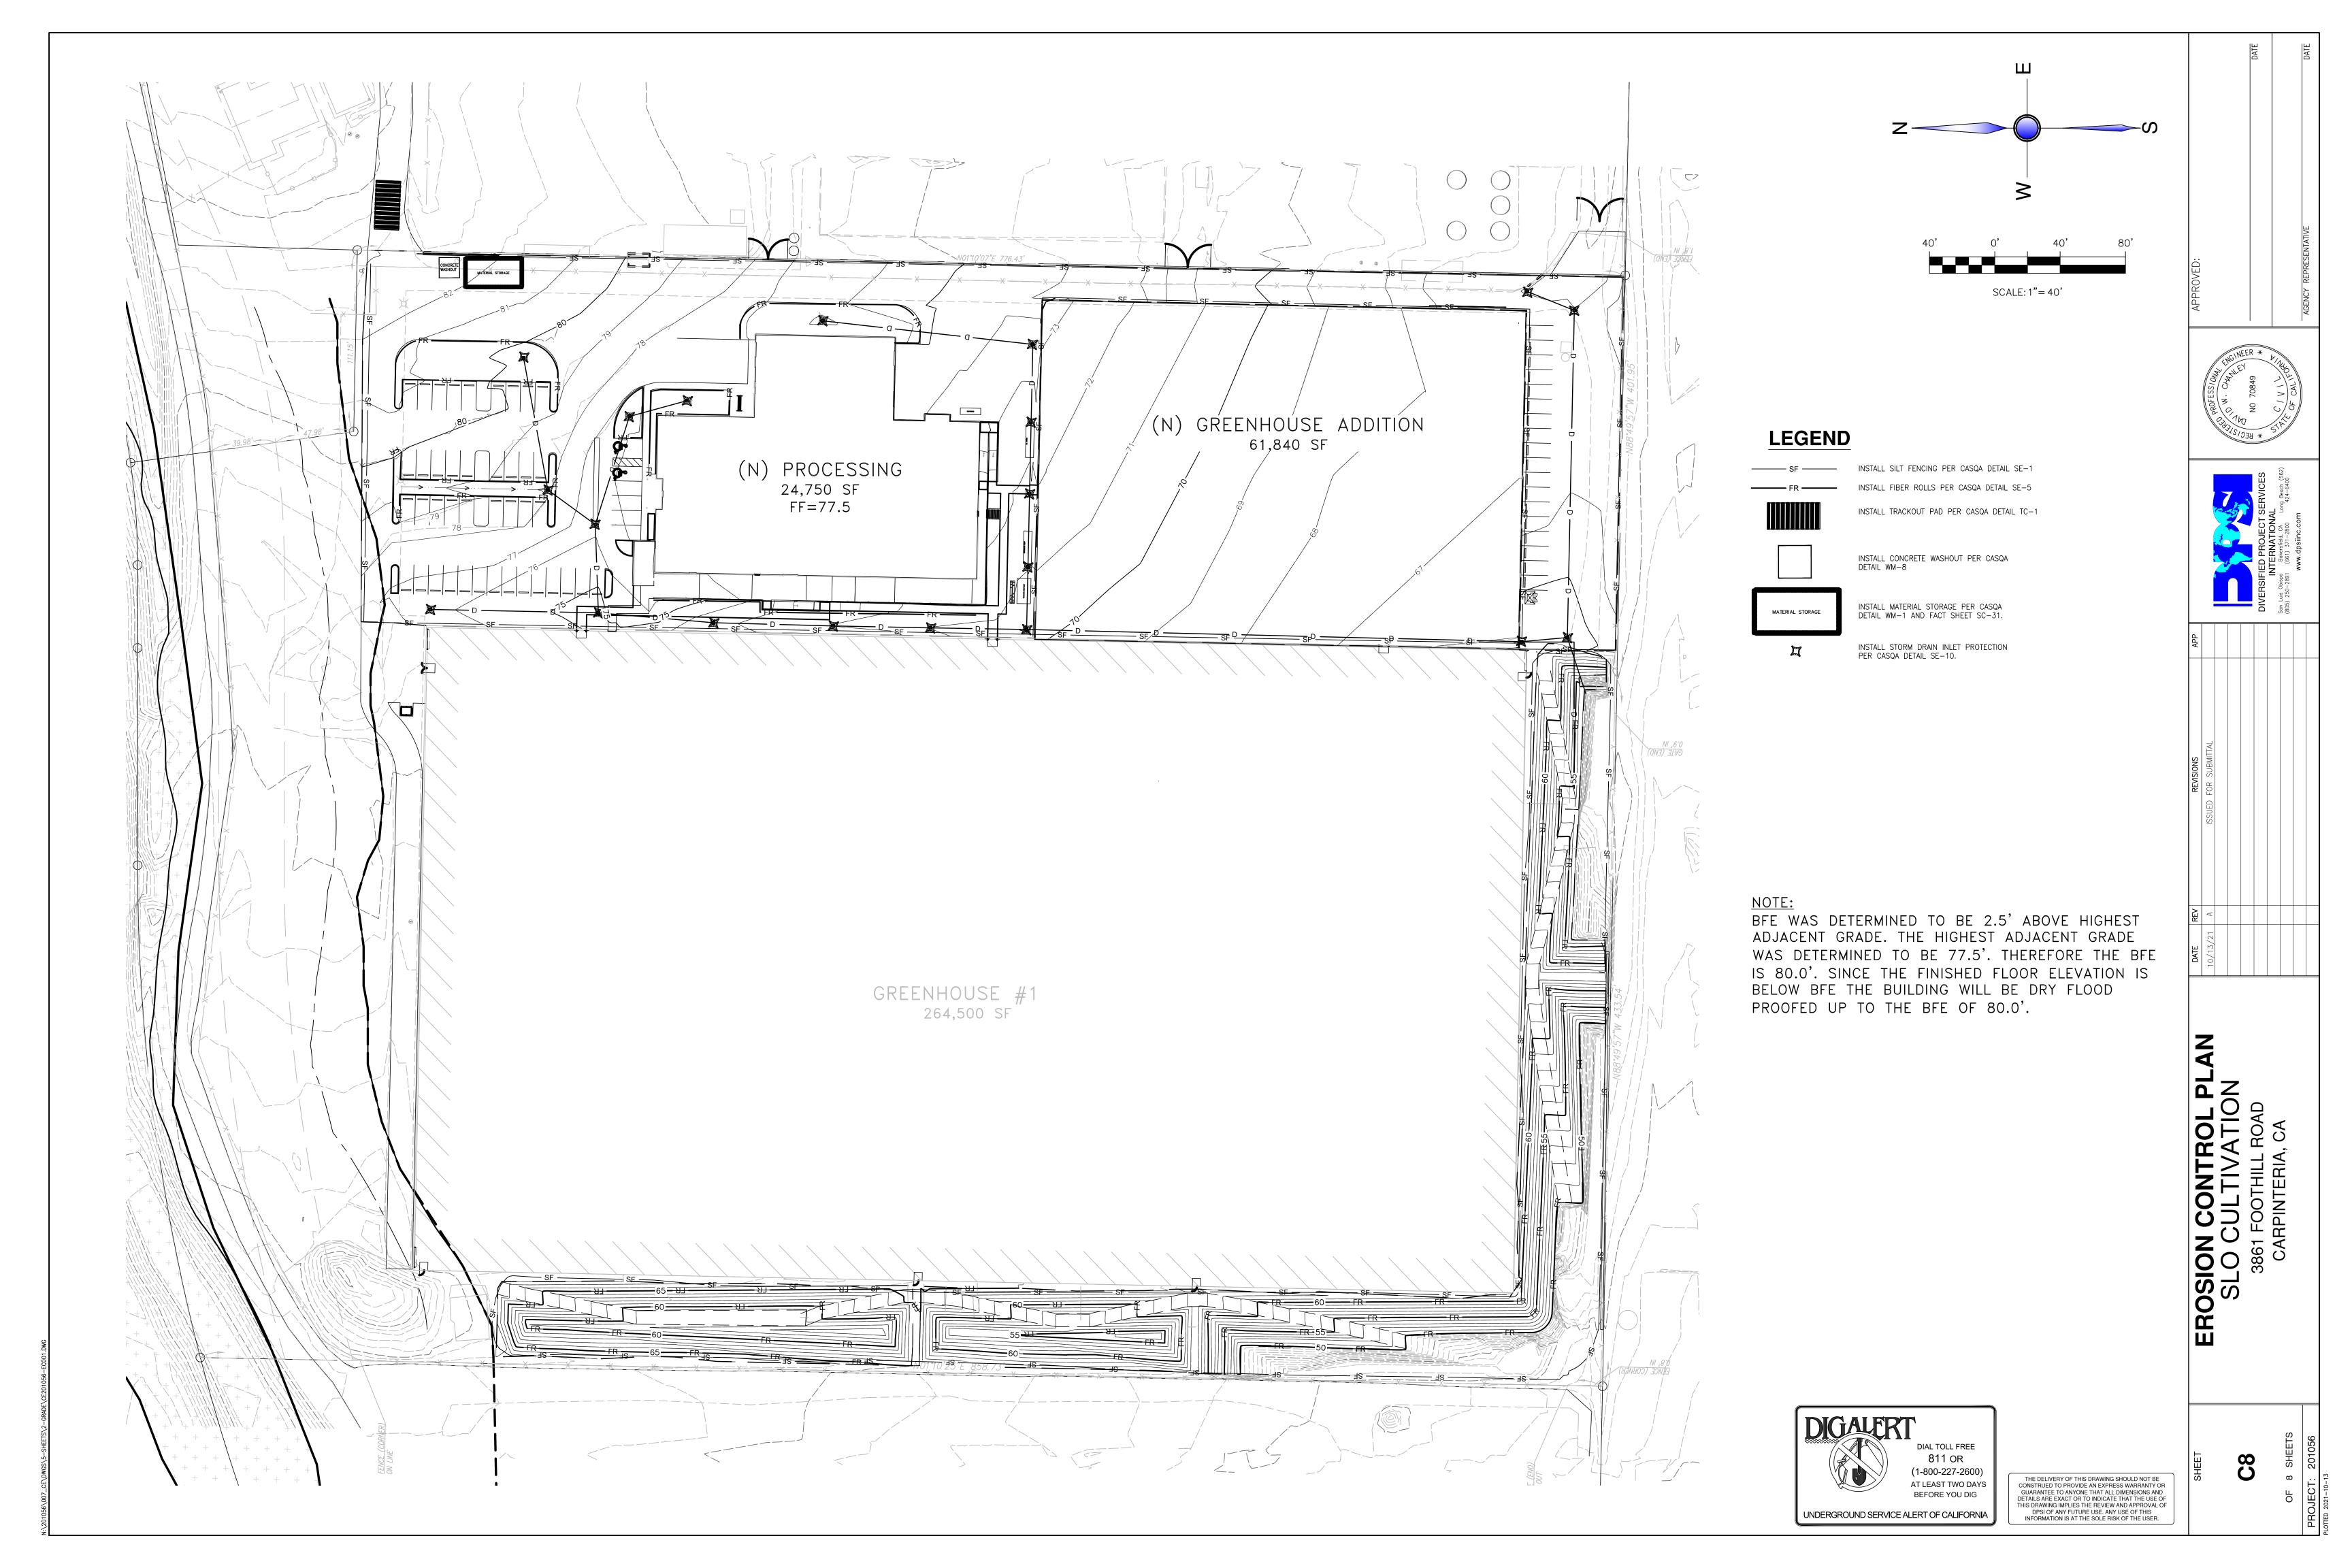

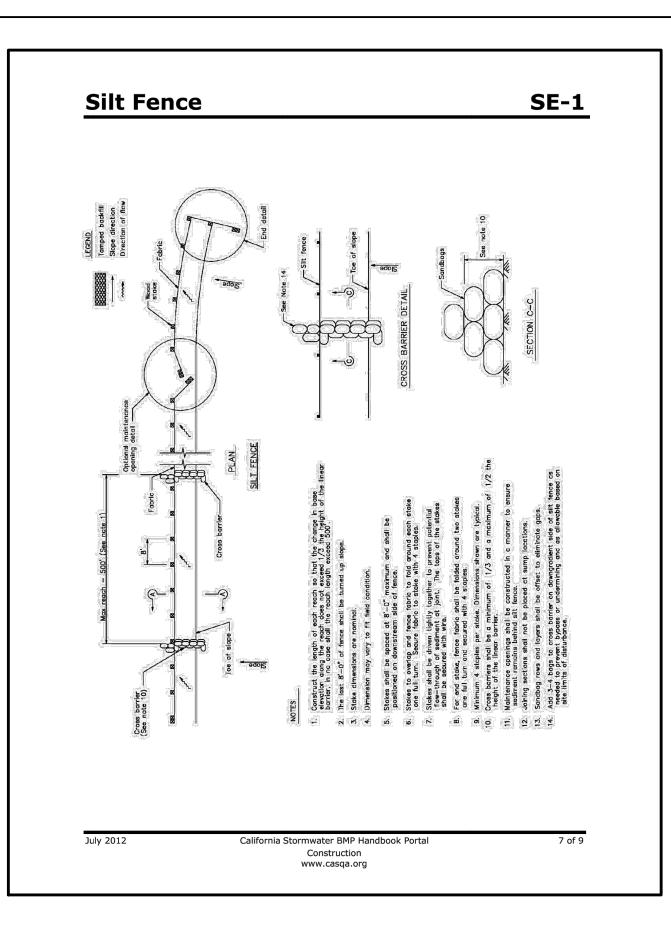

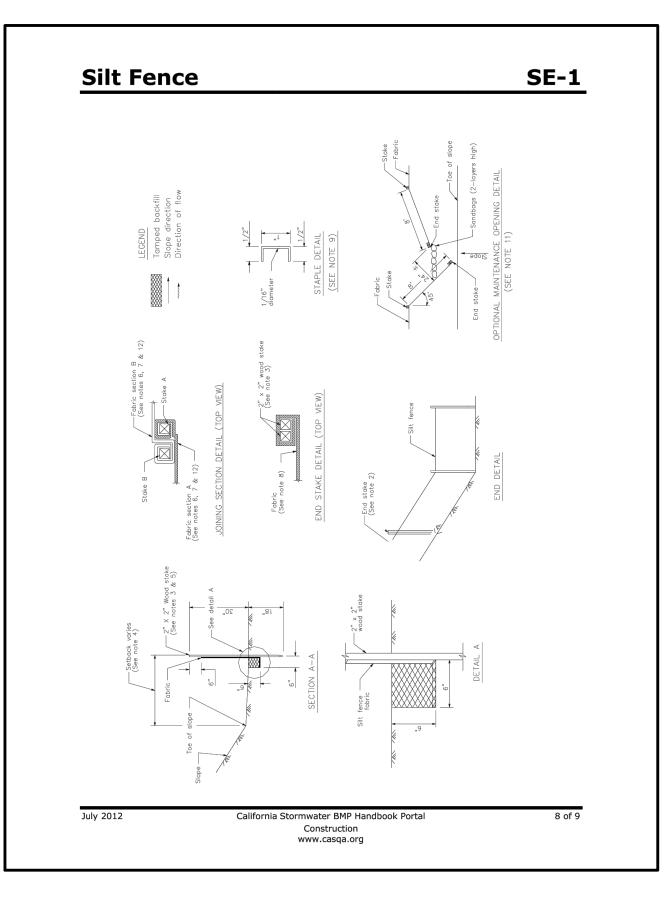


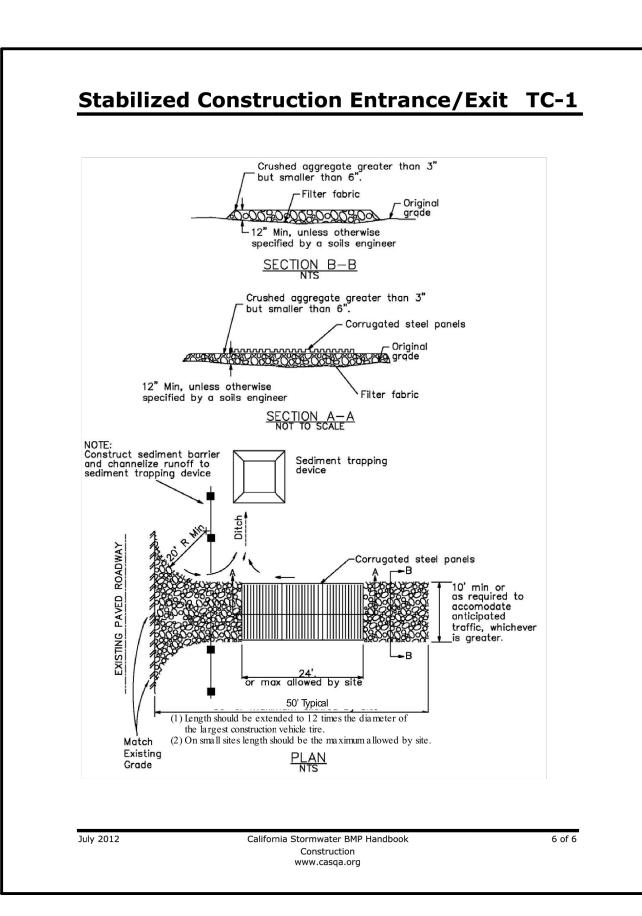


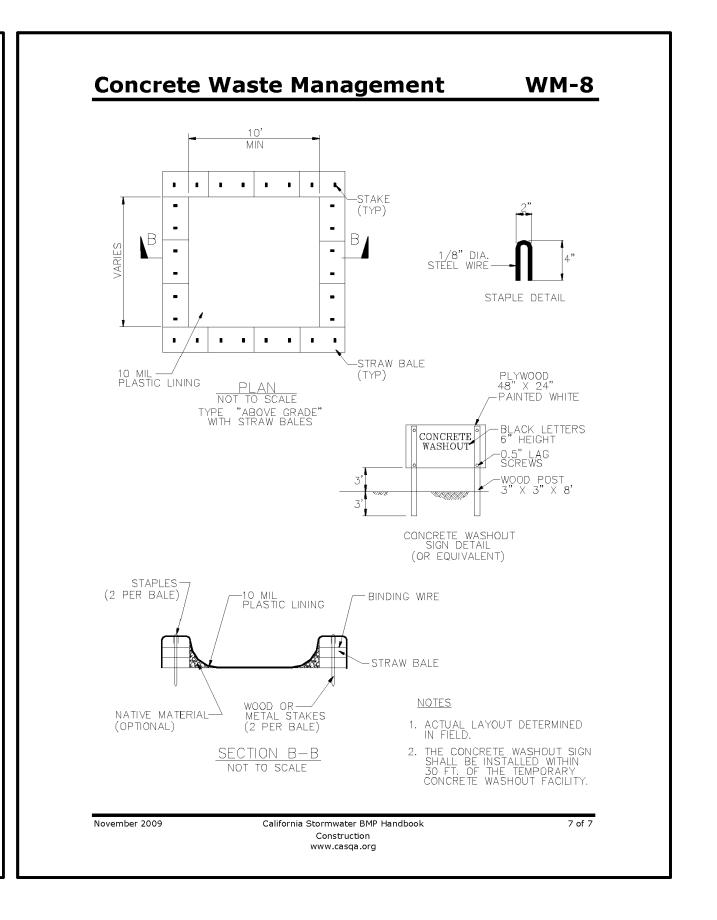






60

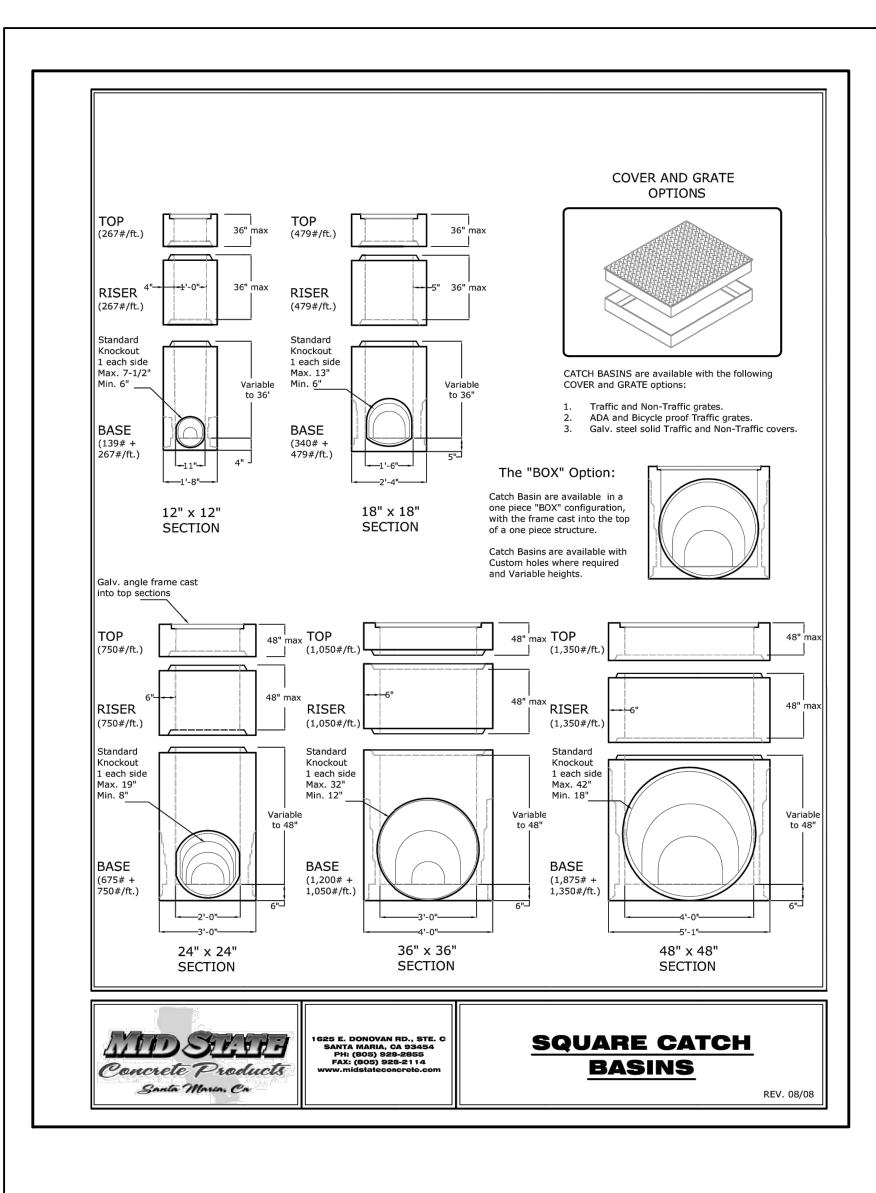

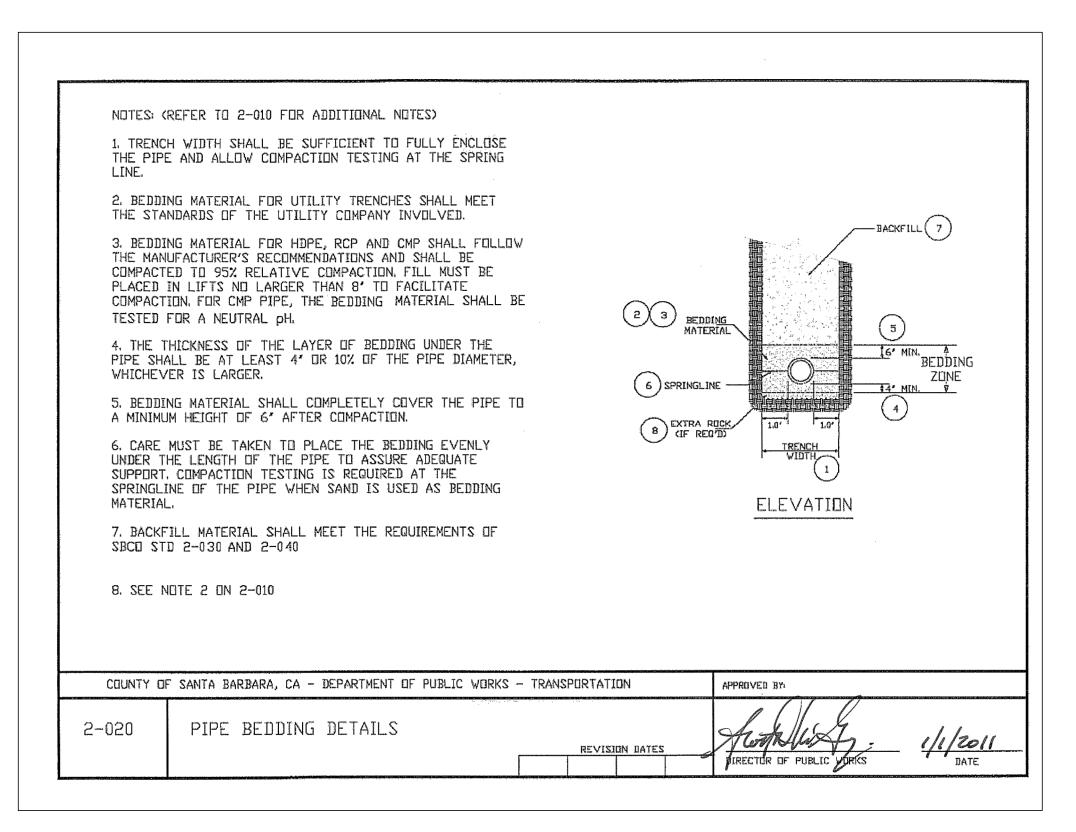

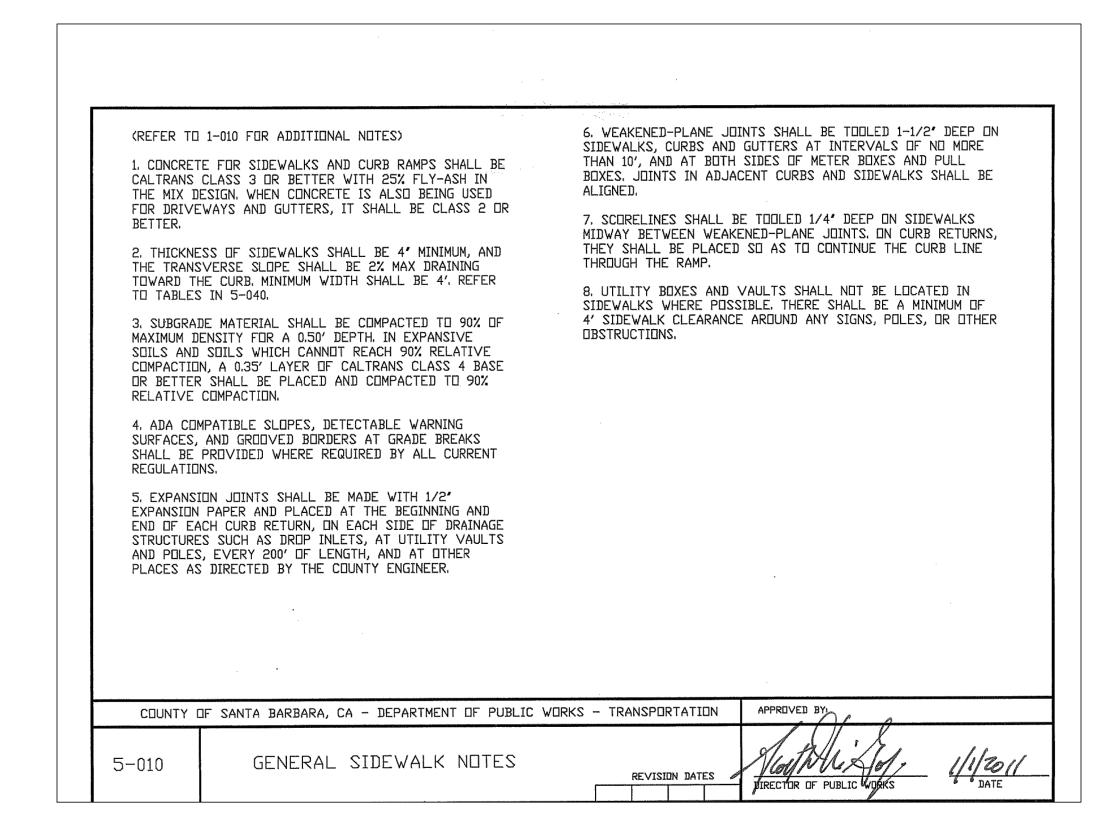

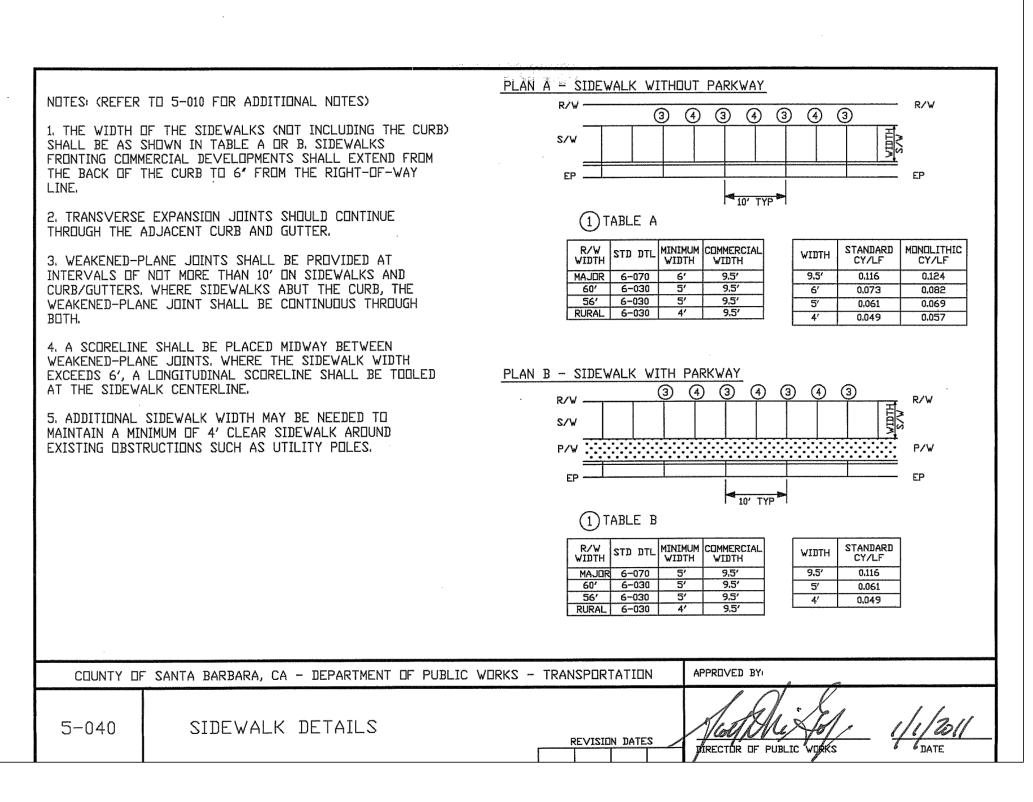

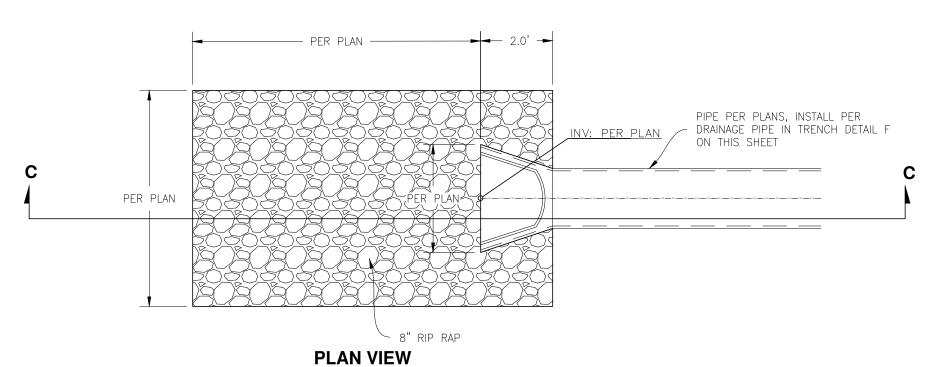

DRAINAGE VELOCITY DISSIPATOR

N.T.S.

VARIES VARIES · · · · — PLANTER WITH LANDSCAPING. SEE ARCHITECTURAL PLANS FOR DETAILS. * * * * **\\ \\ \\ ** INSTALL APPROX. 4-IN THICK LAYER OF 3/4-IN - CRUSHED ROCK RIP-RAP WITHIN SWALE, ÁS INDICATED ON PLANS. 4' GRAVEL SWALE N.T.S. 36" UNLESS SPECIFIED OTHERWISE ──► DECOMPOSED GRANITE -DECOMPOSED GRANITE CLASS '3' CONCRETE (5 1/2 SACK) EXPANSION JOINTS EA. 40' WEAKENED PLANE JTS. EA. 20' **CONCRETE SWALE** N.T.S. - 2X6 REDWOOD HEADER DECOMPOSED GRANITE - PLANTER WITH LANDSCAPING. SEE ARCHITECTURAL PLANS FOR DETAILS. · · · · · · / · · · · · · · — NATIVE SOIL AGGREGATE BASE 2"X2"X12" REDWOOD STAKE AT 48" O.C., AND AT JOINTS

PER PLAN

N.T.S. FINISHED GRADE AC PAVEMENT CLASS II AGG. BASE. COMPACTED TO A MINIMUM 95% OF MAXIMUM DRY DENSITY. COMPACT NATIVE MATERIAL TO 90% OF MAXIMUM DRY DENSITY, AS REQUIRED BY SOILS ENGINEER

REDWOOD HEADER

ASPHALT PAVEMENT SECTION N.T.S. - FINISHED GRADE #3 BARS @ 18" O.C. EACH DIRECTION COMPACT NATIVE MATERIAL TO 90% OF MAXIMUM DRY DENSITY, AS REQUIRED BY SOILS ENGINEER

SIDEWALK SECTION N.T.S.



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C

SHEET IVATION HILL ROAD ERIA, CA

PLEINAIRE

DESIGN GROUP

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CULTIVATION

SHEET TITLE

FENCING & SECURITY PLAN

OWNER Cresco California
P.O. Box 183
Carpinteria, California 93014

DATE 2021.10.12

SHEET NO.

NO.

L-1.0

21839


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2	Persea Americana	Avocado Tree	Grid	2	Remove for new detention basin
3	Persea Americana	Avocado Tree	Grid	2	Remove for new detention basin
4	Persea Americana	Avocado Tree	Grid	2	Remove for new detention basin
5	Persea Americana	Avocado Tree	Grid	2	Remove for new detention basin
6	Persea Americana	Avocado Tree	Grid	2	Remove for new detention basin
7	Persea Americana	Avocado Tree	Grid	2	Remove for new detention basin
8	Persea Americana	Avocado Tree	Grid	2	Remove for new detention basin
9	Persea Americana	Avocado Tree	Grid	2	Remove for new detention basin
10	Persea Americana	Avocado Tree	Grid	2	Remove for new detention basin
11	Persea Americana	Avocado Tree	Grid	2	Remove for new detention basin
12	Persea Americana	Avocado Tree	Grid	2	Remove for new detention basin
13	Persea Americana	Avocado Tree	Grid	2	Remove for new detention basin
14	Persea Americana	Avocado Tree	Grid	2	Remove for new detention basin
15	Persea Americana	Avocado Tree	Grid	2	Remove for new detention basin
16	Persea Americana	Avocado Tree	Grid	2	Remove for new detention basin
17	Persea Americana	Avocado Tree	Grid	2	Remove for new detention basin
18	Persea Americana	Avocado Tree	Grid	2	Remove for new detention basin
19	Persea Americana	Avocado Tree	Grid	2	Remove for new detention basin
20	Persea Americana	Avocado Tree	Grid	2	Remove for new detention basin
21	Persea Americana	Avocado Tree	Grid	2	Remove for new detention basin
22	Persea Americana	Avocado Tree	Grid	2	Remove for new detention basin
23	Persea Americana	Avocado Tree	Grid	2	Remove for new detention basin
24	Persea Americana	Avocado Tree	Grid	2	Remove for new detention basin
25	Persea Americana	Avocado Tree	Grid	2	Remove for new detention basin
26	Persea Americana	Avocado Tree	Grid	2	Remove for new detention basin
27	Persea Americana	Avocado Tree	Grid	2	Remove for new detention basin
28	Persea Americana	Avocado Tree	Grid	2	Remove for new detention basin
29	Persea Americana	Avocado Tree	Grid	2	Remove for new detention basin
30	Persea Americana	Avocado Tree	Grid	2	Remove for new detention basin
31	Persea Americana	Avocado Tree	Grid	2	Remove for new detention basin
32	Persea Americana	Avocado Tree	Grid	2	Remove for new detention basin
33	Quercus agrifolia	Coast Live Oak	25' Dia.	1	DBH = 6.5"
34	Persea Americana	Avocado Tree	Grid	2	Remove for new detention basin
35	Persea Americana	Avocado Tree	Grid	2	Remove for new detention basin
36	Persea Americana	Avocado Tree	Grid	2	Remove for new detention basin
37	Persea Americana	Avocado Tree	Grid	2	Remove for new detention basin
38	Persea Americana	Avocado Tree	Grid	2	Remove for new detention basin
39	Persea Americana	Avocado Tree	Grid	2	Remove for new detention basin
40	Persea Americana	Avocado Tree	Grid	2	Remove for new detention basin
41	Persea Americana	Avocado Tree	Grid	2	Remove for new detention basin
42	Persea Americana	Avocado Tree	Grid	1	In adjacent parcel
43	Persea Americana	Avocado Tree	Grid	1	In adjacent parcel
44	Persea Americana	Avocado Tree	Grid	1	In adjacent parcel
45	Persea Americana	Avocado Tree	Grid	1	In adjacent parcel
46	Persea Americana	Avocado Tree	Grid	1	In adjacent parcel
47	Persea Americana	Avocado Tree	Grid	1	In adjacent parcel
48	Persea Americana	Avocado Tree	Grid	1	In adjacent parcel
49	Persea Americana	Avocado Tree	Grid	1	In adjacent parcel
50	Persea Americana	Avocado Tree	Grid	1	In adjacent parcel
51	Persea Americana	Avocado Tree	Grid	1	In adjacent parcel
52	Persea Americana	Avocado Tree	Grid	1	In adjacent parcel
53	Persea Americana	Avocado Tree	Grid	1	In adjacent parcel
54	Persea Americana	Avocado Tree	Grid	1	In adjacent parcel
55	Persea Americana	Avocado Tree	Grid	1	In adjacent parcel
56	Persea Americana	Avocado Tree	Grid		In adjacent parcel

TREE SURVEY

Persea Americana

58 Persea Americana

☐ TREE INVENTORY PLAN

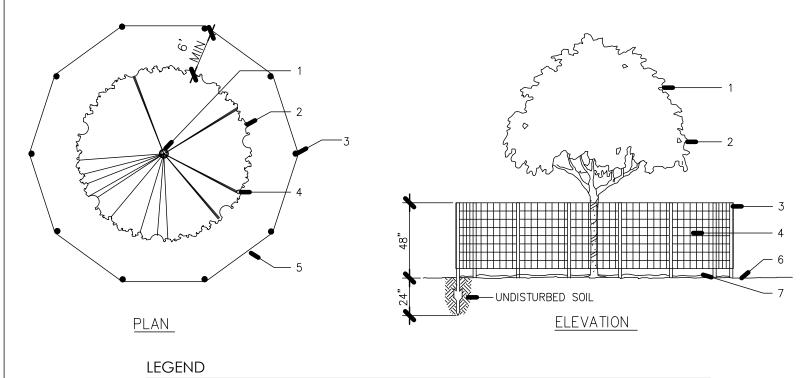

- 1. EXISTING TREE TO REMAIN, AS DESIGNATED ON PLANS. 2. TREE DRIP LINE.
- 3. HEAVY DUTY STEEL T-POST 6' O.C. MAX. DRIVE POST INTO UNDISTURBED SOIL, AVOIDING MAJOR ROOTS AS MUCH AS POSSIBLE.
- 4. ORANGE "HI-VIS" BARRIER FENCING, 48" TALL ATTACHED WITH ZIP TIES, MINIMUM 4
- PER STAKE EQUALLY SPACED.
- 5. SIGNAGE STATING "TREE PROTECTION AREA" SHALL BE PLACED ON FENCING AT 15'
- 6. EXTEND FENCING 6' BEYOND DRIPLINE OF PROTECTED TREES WHERE POSSIBLE, OR
- AS OTHERWISE SHOWN ON PLANS. 7. ALL FENCING AND SIGNS SHALL REMAIN IN PLACE DURING ALL GRADING AND
- CONSTRUCTION ACTIVITIES
- 8. EXISTING GRADE. 9. UNDISTURBED LEAF LITTER.
- NOTE: ALL EXCEPTIONS SHALL BE APPROVED IN THE FIELD BY THE PROJECT ARBORIST PRIOR TO START OF WORK.

TREE PROTECTION NOTES

PRIOR TO PRE-CONSTRUCTION MEETING, BEGINNING OF GRADING, AND DURING ALL GROUND DISTURBANCE AND CONSTRUCTION ACTIVITIES, TEMPORARY ORANGE PLASTIC FENCING SHALL BE INSTALLED AT THE DRIP LINE OF ALL TREES IN ORDER TO CONTROL ACCESS AND DELINEATE AREAS OF NON-DISTURBANCE. FINAL LOCATION OF FENCING TO BE DETERMINED IN FIELD BY LANDSCAPE ARCHITECT.


SCALE: 1" = 40'-0"

- 2. ANY NECESSARY PRUNING SHALL BE IN ACCORDANCE TO THE MOST CURRENT INTERNATIONAL SOCIETY OF ARBORICULTURE PRUNING STANDARDS UNDER THE SUPERVISION OF A CERTIFIED ARBORIST.
- PRIOR TO BEGINNING WORK OR ANY EXCAVATION, THE CONTRACTOR SHALL CONTACT UNDERGROUND SERVICE ALERT AT (800) 442-4133.
- REMOVAL OF WEEDS WITHIN THE DRIP LINE OF THE TREES SHALL BE DONE BY HAND OR BY USE OF A CONTACT HERBICIDE ONLY.
- NO CONSTRUCTION, STORAGE OF MATERIALS, AND/OR PARKING OF VEHICLES SHALL BE PERMITTED WITHIN THE DRIP LINE OF EXISTING TREES.
- NO GRADING SHALL OCCUR WITHIN THE DRIP LINE OF EXISTING TREES EXCEPT AS REQUIRED WITHIN DESIGNATED AREA OF ENCROACHMENT AND UNDER THE SUPERVISION OF THE PROJECT ARBORIST
- 7. IF UTILITY INSTALLATION MUST OCCUR WITHIN THE DRIP LINE OF ANY OF EXISTING TREES, THEN THE FOLLOWING PRECAUTIONS MUST BE OBSERVE AND PERFORMED UNDER THE SUPERVISION OF THE PROJECT ARBORIST
 - A. WHERE IT IS NECESSARY TO EXCAVATE ADJACENT TO EXISTING TREES, THE CONTRACTOR SHALL USE ALL POSSIBLE CARE TO AVOID INJURY TO TREES AND
 - TREE ROOTS. B. EXCAVATION IN THESE AREAS WHERE TWO (2) INCH AND LARGER ROOTS OCCUR SHALL BE DONE BY HAND.
 - C. ALL ROOTS LESS THAN TWO (2) INCHES IN DIAMETER, DIRECTLY IN THE PATH OF THE PIPE OR CONDUIT, SHALL BE CLEANLY CUT UNDER THE DIRECTION OF AN APPROVED ARBORIST.
 - D. ALL ROOTS TWO (2) INCHES AND LARGER IN DIAMETER, EXCEPT DIRECTLY IN THE PATH OF PIPE OR CONDUIT, SHALL BE TUNNELED UNDER AND SHALL BE HEAVILY WRAPPED WITH BURLAP TO PREVENT SCARRING OR EXCESSIVE DRYING.
 - E. ROOTS ONE (1) INCH AND LARGER IN DIAMETER REQUIRING CUTTING SHALL BE PAINTED WITH TWO COATS OF TREE SEAL OR EQUAL.
 - F. WHERE A DITCHING MACHINE IS RUN CLOSE TO TREES HAVING ROOTS SMALLER THAN TWO (2) INCHES IN DIAMETER, THE WALL OF THE TRENCH ADJACENT TO TREES SHALL BE HAND TRIMMED, MAKING CLEAN CUTS THROUGH.
 - G. TRENCHES ADJACENT TO TREES SHOULD BE CLOSED WITHIN TWENTY FOUR (24) HOURS AND WHERE NOT POSSIBLE, THE SIDE OF THE TRENCH ADJACENT TO THE TREES SHALL BE KEPT SHADED WITH BURLAP OR CANVAS.
- 8. ANY DISCREPANCIES AND/ OR QUESTIONS THAT MAY ARISE ON SITE REGARDING EXISTING TREES SHALL BE REFEREED TO THE PROJECT ARBORIST. 9. ALL EXISTING SHRUBBERY AND GROUNDCOVER SHALL BE REMOVED WHERE NECESSARY FOR CONSTRUCTION PURPOSES UNLESS OTHERWISE NOTED TO REMAIN.
- 10. ALL DOWNED WOOD AND UPROOTED STUMPS SHALL BE REMOVED AS PART OF THE SITE CLEAN UP. CONTRACTOR SHALL LEAVE EXISTING LEAF MULCH IN PLACE AS MUCH AS POSSIBLE.
- 11. TREES SHALL BE PROTECTED IN PLACE TO THE GREATEST EXTENT POSSIBLE. ALL TREES LOCATED WITHIN TWENTY FIVE (25) FEET OF PROPOSED BUILDINGS SHALL BE PROTECTED FROM STUCCO OR PAINT DURING CONSTRUCTION.
- 12. ANY PRUNING TO BE SUPERVISED BY PROJECT ARBORIST.

TREE INVENTORY LEGEND

n adjacent parcel


In adjacent parcel

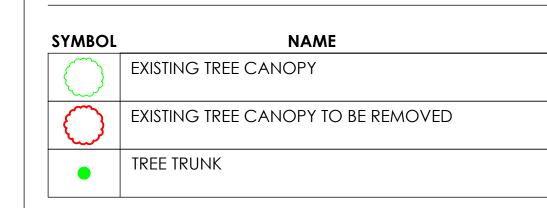

NOTE:

Avocado Tree

GRADING AND SITE DISTURBANCE SHALL REMAIN AT LEAST 6 FEET OUTSIDE OF THE EXISTING OAK'S DRIPLINE WHENEVER FEASIBLE. IF GRADING MUST ENCROACH WITHIN THAT PROTECTED AREA, ALL SUCH WORK SHALL BE CONDUCTED UNDER THE SUPERVISION OF THE LANDSCAPE ARCHITECT/ARBORIST

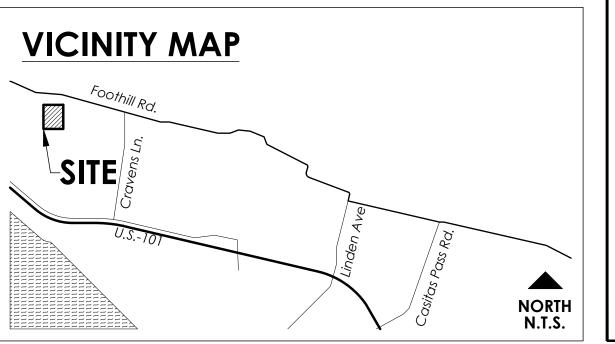

DESIGN GROUP

[1] Remain

[2] Remove [3] Prune

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SHEET TITLE

TREE **INVENTORY PLAN**

OWNER Cresco California P.O. Box 183 Carpinteria, California 93014

2021.10.12

21839

DATE SHEET NO.

L-1.1

A TREE PROTECTION DETAIL

PLANT LEGEND

TREES


SYMBOL	NAME	COMMENTS	SIZE	WUCOLS	QTY.
	QUERCUS AGRIFOLIA COAST LIVE OAK	PLANT PER DETAIL A	48" BOX	V. LOW	15
	MAGNOLIA GRANDIFLORA 'ST. MARY' ST. MARY MAGNOLIA	PLANT PER DETAIL A	24" BOX	MED	5
	LOPHOSTEMON CONFERTUS BRISBANE BOX	PLANT PER DETAIL A	36" BOX	MED	7
	QUERCUS VIRGINIANA SOUTHERN LIVE OAK	PLANT PER DETAIL A	36" BOX	MED	3
	PLATANUS RACEMOSA WESTERN SYCAMORE	PLANT PER DETAIL A REFER TO PLANT LEGEND NOTE #9	36" BOX	MED	6

SHRUBS

SYMBOL	NAME	COMMENTS	SIZE	WUCOLS	QTY.
S1	SI ELYMUS TRITICOIDES CREEPING WILD RYE	PLANT PER DETAIL B	1 GAL.	LOW	38
<u>S2</u>	S2 BACCHARIS SALICIFOLIA MULEFAT	PLANT PER DETAIL B	1 GAL.	LOW	15
\$3	FRANGULA CALIFORNICA COFFEE BERRY	PLANT PER DETAIL B	5 GAL.	V. LOW	26
<u>S4</u>	HETEROMELES ARBUTIFOLIA TOYON	PLANT PER DETAIL B	5 GAL.	V. LOW	14
<u>S5</u>	MUHLENBERGIA RIGENS DEER GRASS	PLANT PER DETAIL B	5 GAL.	LOW	46
<u>S6</u>	S6 ARCTOSTAPHYLOS 'SUNSET' SUNSET MANZANITA	PLANT PER DETAIL B	5 GAL.	LOW	23
<u>\$7</u>	ROSA CALIFORNICA CALIFORNIA WILDROSE	PLANT PER DETAIL B REFER TO PLANT LEGEND NOTE #9	5 GAL.	LOW	23
<u>S8</u>	SAMBUCUS NIGRA SSP. CAERULEA BLUE ELDERBERRY	PLANT PER DETAIL B REFER TO PLANT LEGEND NOTE #9	5 GAL.	LOW	13


GROUNDCOVERS

SYMBOL	NAME	COMMENTS	SIZE	WUCOLS	QTY.
	GI CAREX PRAEGRACILIS CALIFORNIA FIELD SEDGE	PLANT PER DETAIL B 36" O.C.	4" POTS	LOW	19
	G2 CEANOTHUS GLORIOSUS 'ANCHOR BAY' ANCHOR BAY CEANOTHUS	PLANT PER DETAIL B 72" O.C.	5 GAL.	LOW	92
	G3 ACHILLEA MILLEFOLIUM COMMON YARROW	PLANT PER DETAIL B 24" O.C.	1 GAL.	LOW	43
	MOIYO GRAVEL GRAVEL BORDER	2 FOOT WIDE BORDER SURROUNDING THE BUILDING	2"-4"	N/A	423 SQ. FT.

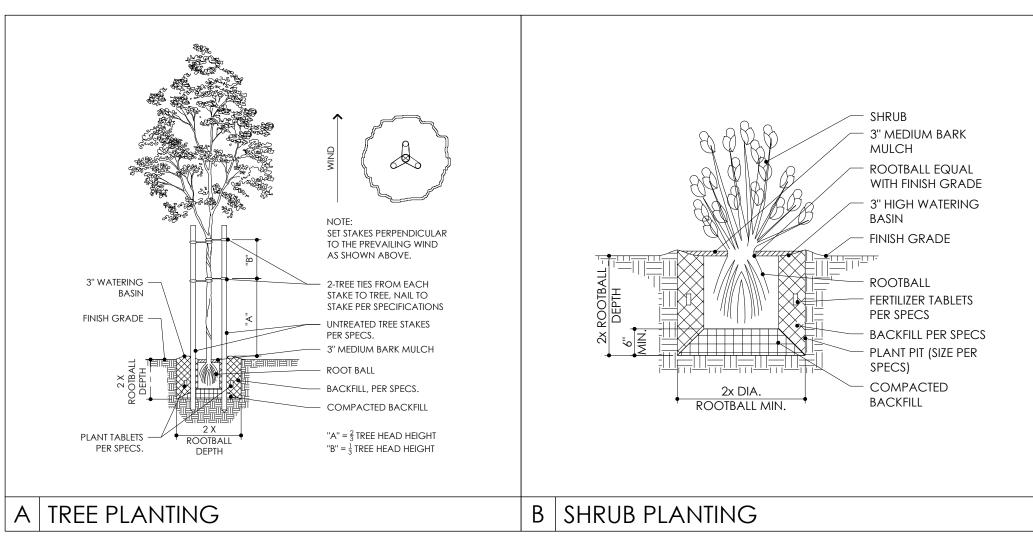

NOTE:

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PLEINAIRE DESIGN GROUP
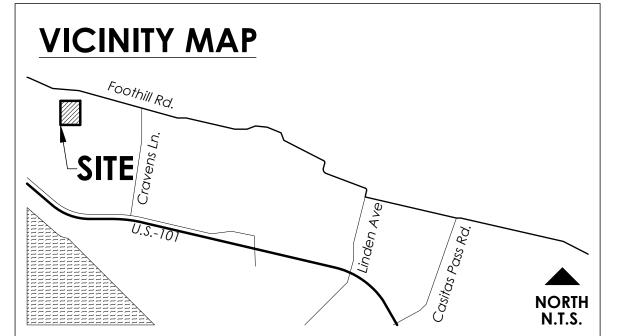
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O CULTIVATION

SHEET TITLE

LANDSCAPE SCREENING PLAN

OWNER Cresco California
P.O. Box 183
Carpinteria, California 93014

DATE

SHEET NO.

L-1.2

2021.10.12

21839

PLEINAIRE DESIGN GROUP

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CULTIVATIO

SHEET TITLE

EXISTING RENDERED SITE PLAN

Cresco California
P.O. Box 183
Carpinteria, California 93014

DATE
2021.10.12
21839

SHEET NO.

L-1.3

DESIGN GROUP

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SHEET TITLE

PROPOSED RENDERED SITE PLAN

OWNER Cresco California P.O. Box 183 Carpinteria, California 93014

DATE

2021.10.12 SHEET NO.

L-1.4