

SANTA BARBARA COUNTY ISLA VISTA TRASH CAPTURE DESIGN PROJECT (56STC) EL COLEGIO ROAD HDS UNIT

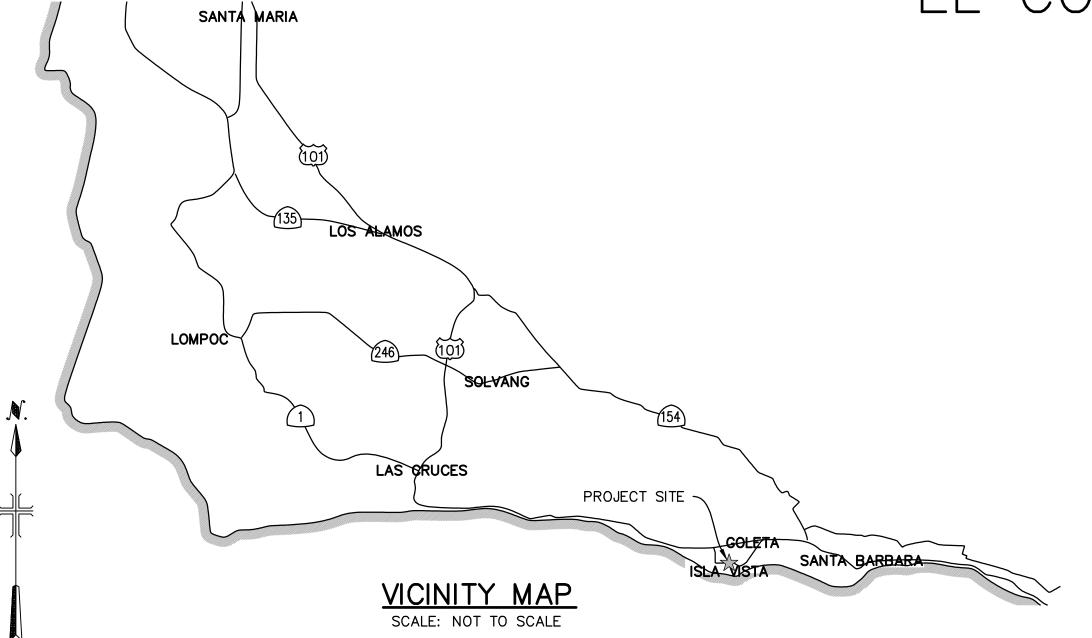

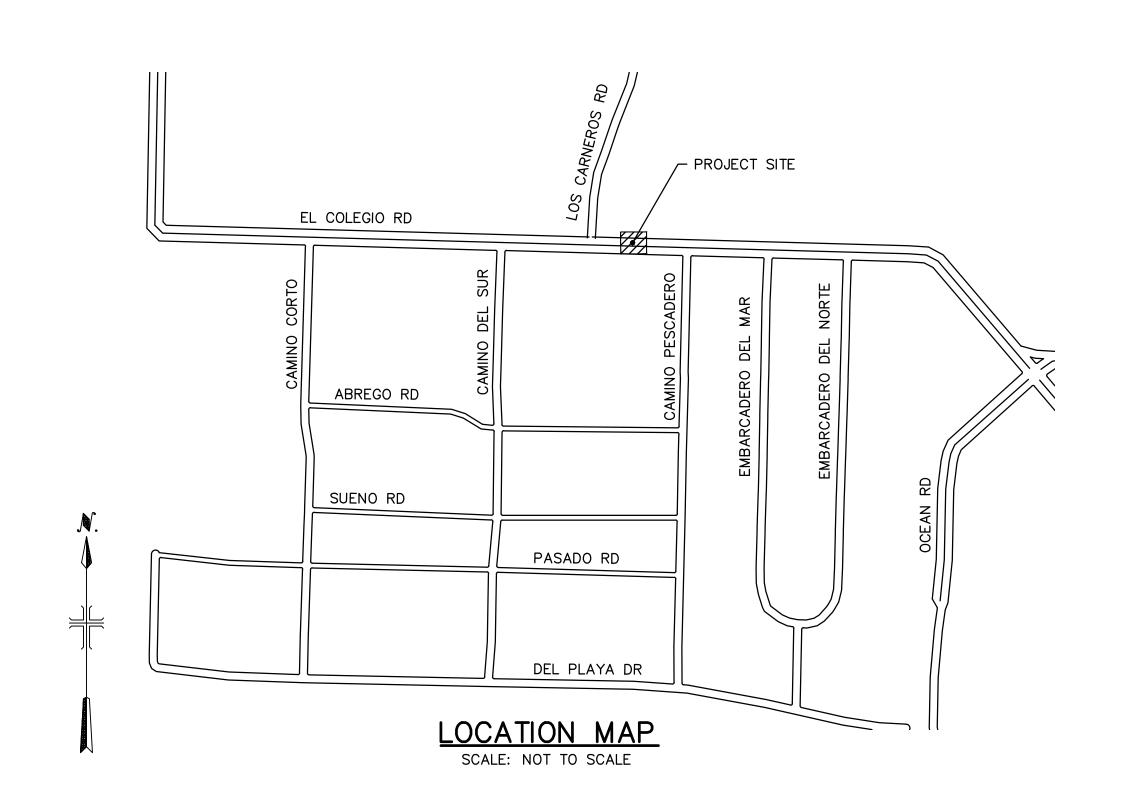

SHEET INDEX							
SHEET NO.	DRAWING NO.	SHEET TITLE					
1	G-01	TITLE SHEET					
2	G-02	NOTES, SPECIFICATIONS, ABBREVIATIONS, & SYMBOLS					
3	C-01	SITE PLAN AND DETAILS					
4	C-02	DETAILS					
5	R-01	REFERENCE STANDARD DETAILS					

LEGEND:

	RIGHT-OF-WAY LINE
	STREET CENTERLINE
SD	PROPOSED STORM DRAIN
SD	EXISTING STORM DRAIN
SS	EXISTING SANITARY SEWER
G	EXISTING NATURAL GAS PIPE
E	EXISTING ELECTRICAL CONDUIT
	EXISTING WATER LINE
RW	EXISTING RECLAIMED WATER LINE
SL	EXISTING STREET LIGHT CONDUIT
30 —	EXISTING CONTOUR
⊸	FLOW ARROW

PROJECT TEAM:

OWNER

SANTA BARBARA COUNTY PUBLIC WORKS 123 EAST ANAPAMU STREET SANTA BARBARA, CA 93101

DESIGN ENGINEER

GEOSYNTEC CONSULTANTS, INC 1831 SOUTH BROADWAY, SUITE 300 LOS ANGELES, CA 90015

APPROVED - CHAIR, BOARD OF SUPERVISORS	DATE
Docusigned by: Clin's Smiddon 67CEC4FE68B848C	5/15/2024 1:58 PM PDT
APPROVED - DIRECTOR OF PUBLIC WORKS	DATE
DocuSigned by: Walter Rubalcava 2745EDA75D27485	5/15/2024 1:56 PM PD
APPROVAL RECOMMENDED - DEPUTY DIRECTOR	DATE

ABBREVIATIONS


/ IDDI IL	
ВОТ	воттом
ВМР	BEST MANAGEMENT PRACTICE
CDS	CONTINUOUS DEFLECTIVE SEPARATION
CL	CENTER LINE
CLR	CLEARANCE
CF	CURB FACE
CONC	CONCRETE
CSB	COUNTY OF SANTA BARBARA
DWG	DRAWING
EL	ELEVATION
ELEC	ELECTRICAL
FG	FINISHED GRADE
FS	FINISHED SURFACE
FT	FOOT/FEET
GULD	GENERAL USE LEVEL DESIGNATION
HDS	HYDRODYNAMIC SEPARATOR
ID	INSIDE DIAMETER
IN	INCH/INCHES
INV	INVERT ELEVATION
LF	LINEAR FEET
MAX	MAXIMUM
мн	MANHOLE
MIN	MINIMUM
OC	ON CENTER
OD	OUTSIDE DIAMETER
OVHD	OVERHEAD
PVC	POLYVINYL CHLORIDE PIPE
PVMT	PAVEMENT
RCP	REINFORCED CONCRETE PIPE
R/W	RIGHT-OF-WAY
S	SLOPE
SCH	SCHEDULE
SD	STORM DRAIN
SS	SANITARY SEWER
STD	STANDARD
STLT	STREET LIGHT
TAPE	TECHNOLOGY ASSESSMENT PROTOCOL - ECOLOGY
TC	TOP OF CURB
TYP	TYPICAL UTILITY BEFO
UTIL	UTILITY

VAULT

TWO WORKING DAYS BEFORE YOU DIG

100% DESIGN

						DESIGNED BY	JA	
						DRAWN BY	DLJ	
						CHECKED BY	AB	
						APPROVED BY	JA	
REV	DATE	BY	СНК	APP	DESCRIPTION	DATE	5/13/2024	

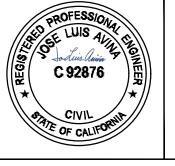





SANTA BARBARA COUNTY PUBLIC WORKS

> 123 EAST ANAPAMU STREET SANTA BARBARA, CA 93101

SANTA BARBARA COUNTY
ISLA VISTA TRASH CAPTURE PROJECT

TITLE SHEET

	JOB NO.	CWR0811
Т	DRAWING NO.	G-01
	SCALE	AS SHOWN
	SHEET NO.	1 OF 5

Under ground Service Alert of Southern California

Call: TOLL FREE

8-1-1

GENERAL NOTES:

- PRIOR TO START OF CONSTRUCTION. VERIFY ALL EXISTING CONDITIONS INCLUDING UTILITIES AND SUBSURFACE CONDITIONS REQUIRED TO PERFORM WORK. IF CONDITIONS DIFFER FROM THOSE SHOWN ON THE DRAWINGS, NOTIFY THE ENGINEER IMMEDIATELY AND STOP WORK UNTIL DIFFERING CONDITIONS HAVE BEEN EVALUATED.
- 2. SHOULD CONFLICTING INFORMATION BE FOUND ON THE PLANS, NOTIFY THE ENGINEER BEFORE PROCEEDING WITH THE WORK IN QUESTION.
- ALL CONSTRUCTION OPERATIONS ARE TO BE ACCOMPLISHED IN ACCORDANCE WITH APPLICABLE STATE STATUTES AND U.S. OCCUPATIONAL SAFETY AND HEALTH ADMINISTRATION REGULATIONS (OSHA). COPIES OF OSHA STANDARDS MAY BE PURCHASED FROM THE U.S. GOVERNMENT PRINTING OFFICE.
- 4. TEMPORARY FACILITIES: CONTRACTOR IS RESPONSIBLE FOR ALL TEMPORARY FACILITIES INCLUDING POWER, WATER, AND SANITARY FACILITIES NEEDED FOR CONSTRUCTION.

SANTA BARBARA COUNTY NOTES:

- 1. INSPECTION BY THE COUNTY ENGINEER SHALL BE REQUESTED BY THE CONTRACTOR IMMEDIATELY PRIOR TO COMMENCING AND IMMEDIATELY AFTER COMPLETING EACH PHASE OF CONSTRUCTION.
- 2. THE STANDARD TEST FOR MAXIMUM DENSITY AND OPTIMUM MOISTURE CONTENT SHALL BE ASTM D 1557 (CURRENT VERSION) METHOD "A", "B", OR "C". FIELD TEST FOR IN PLACE DENSITY AND MOISTURE CONTENT SHALL BE ASTM D 2922 AND D 3017 (CURRENT VERSIONS). TEST METHOD "C" MAY BE MODIFIED TO ALLOW THE USE OF CALIFORNIA TEST METHOD 370 FOR DETERMINING MOISTURE CONTENT OF MINERAL AGGREGATE USING MICROWAVE OVENS.
- WATER FOR COMPACTION AND DUST CONTROL SHALL BE MADE AVAILABLE BY THE CONTRACTOR. DUST AND EROSION CONTROL ARE THE RESPONSIBILITY OF THE CONTRACTOR AND SHALL BE AS DIRECTED BY THE COUNTY ENGINEER.
- 4. ASPHALT CONCRETE USED FOR PAVING SHALL BE MADE WITH PERFORMANCE-GRADE ASPHALT AND AGGREGATE SORTED TO CALTRANS STANDARD SPECIFICATIONS, SECTION 39. THE MIX DESIGN SHALL BE APPROVED BY THE COUNTY ENGINEER PRIOR TO PLACEMENT. THE CALTRANS SPECIFICATIONS FOR MIXING, HAULING, SPREADING, AND COMPACTING SHALL BE STRICTLY FOLLOWED.
- 5. OVERLAY SECTIONS SHALL CONSIST OF 1/2" MAX AGGREGATE WITH MEDIUM GRADING.

EROSION & SEDIMENT CONTROL NOTES:

- ALL CONSTRUCTION/DEMOLITION, GRADING, AND STORAGE OF BULK MATERIALS MUST COMPLY WITH THE SANTA BARBARA COUNTY AIR POLLUTION CONTROL DISTRICT RULE 345, CONTROL OF FUGITIVE DUST FROM CONSTRUCTION AND DEMOLITION ACTIVITIES.
- 2. ALL DEBRIS SHALL BE CLEANED UP DAILY AND SECURED AT THE END OF THE
- PROTECT DOWNSTREAM CATCH BASIN AND SURFACE WATERS FROM CONVEYANCE OF CONSTRUCTION POLLUTANTS. MAINTAIN AND MODIFY AS NEEDED DURING CONSTRUCTION.

SURVEY NOTES:

- 1. LOCAL BENCHMARK: THE BENCHMARK FOR THIS SURVEY IS POINT 421 AS SHOWN HEREON HAVING AN ELEVATION OF 29.57.
- 2. VERTICAL AND PROJECT BENCHMARK: THE VERTICAL DATUM FOR THIS SURVEY IS NAVD88 BASED ON STATIC TIES TO CORS STATION COPR USING A PUBLISHED ELEVATION OF 45.41' PER THE RECORD OF SURVEY FIELD IN BOOK 212 PAGE 48 ET SEQ OF RECORDS OF SURVEYS.
- 3. BASIS OF BEARINGS: THE BASIS OF BEARINGS FOR THIS SURVEY IS CCS83 (2017.50) BASED ON STATIC TIES TO CORS STATION COPR USING COORDINATES PUBLISHED ON THE RECORD OF SURVEY FIELD IN BOOK 212 PAGE 38 SEQ OF RECORD OF SURVEYS.

SPECIFICATIONS:

1. GENERAL:

- 1.1. ALL WORK SHALL CONFORM TO THE 2023 EDITION OF CALTRANS STANDARD SPECIFICATIONS.
- 1.2. INSTALL MATERIALS AND EQUIPMENT IN ACCORDANCE WITH MANUFACTURER GUIDELINES UNLESS OTHERWISE NOTED ON DRAWINGS AND SPECIFICATIONS.
- 1.3. EQUAL PRODUCTS: CONTRACTOR CAN PROVIDE "EQUAL" PRODUCTS FOR ALL MATERIALS SPECIFIED. IF EQUAL PRODUCTS ARE PROPOSED, IT IS THE CONTRACTOR'S RESPONSIBILITY TO DEMONSTRATE THAT THE PROPOSED PRODUCTS ARE EQUAL TO THE SPECIFIED PRODUCT. PRE-APPROVED MATERIALS ARE NOTED IN PARENTHESIS.

2. EARTHWORK:

- 2.1. NO FILL TO BE PLACED UNTIL EXCAVATION BOTTOM HAS BEEN INSPECTED AND APPROVED BY THE ENGINEER.
- 2.2. SUBGRADE PREPARATION: SCARIFY AND RE-COMPACT TOP 6 INCHES OF LOOSE OR DISTURBED SUBGRADE UNLESS OTHERWISE DIRECTED BY THE ENGINEER. FILL MAY BE PLACED DIRECTLY ON TOP OF UNDISTURBED NATIVE MATERIALS AS DETERMINED BY THE ENGINEER.
- 2.3. FILL MATERIAL: SCREENED NATIVE MATERIALS ARE SUITABLE FOR USE AS FILL MATERIAL. SCREENED NATIVE MATERIALS SHALL BE FREE OF ORGANIC MATTER, DELETERIOUS MATERIALS, AND ROCKS OR OTHER OBJECTS LARGER THAN 2 INCHES.
- 2.4. ALL FILL SHALL BE COMPACTED TO THE FOLLOWING MINIMUM RELATIVE COMPACTION CRITERIA:
 - 2.4.1. BASE MATERIAL UNDER ALL PAVEMENT MATERIALS INCLUDING CONCRETE AND ASPHALT CONCRETE: 95 PERCENT
 - 2.4.2. BASE MATERIAL UNDER ALL CONCRETE STRUCTURES AND IMPROVEMENTS INCLUDING CURB, GUTTER, SIDEWALK, CURB RAMPS, AND DRIVEWAYS: 95 PERCENT
 - 2.4.3. SOIL BACKFILL: 90 PERCENT
- 2.4.4. DISTURBED SUBGRADE: 90 PERCENT

3. PIPE AND FITTINGS:

- 3.1. PIPE AND FITTINGS:
 - 3.1.1. PIPE BETWEEN DIVERSION MANHOLE AND HYDRODYNAMIC SEPARATOR: CORRUGATED DUAL WALLED HDPE WATER TIGHT (ADS N-12 DUAL WALL WT)
 - 3.1.2. PROVIDE FITTINGS AND ADAPTERS AS NECESSARY TO COMPLETE WORK
- 3.2. PROVIDE MINIMUM SLOPE OF 1% UNLESS OTHERWISE SHOWN ON DRAWINGS
- 3.3. PIPE BEDDING, WHERE REQUIRED, SHALL BE ONE OF THE FOLLOWING:
 - 3.3.1. SAND
 - 3.3.2. CALTRANS STANDARD SPECIFICATIONS SECTION 25 CLASS 1 AGGREGATE SUBBASE
- 3.3.3. UNDISTURBED NATIVE FREE DRAINING MATERIAL
- 4. TRASH COLLECTION STRUCTURES:
 - 4.1. DIVERSION MANHOLE STRUCTURE: 8-FOOT ID PRECAST MANHOLE WITH 30-INCH CLEAR OPENINGS, H-20 TRAFFIC RATED FRAME AND COVER
 - 4.2. NOT USED
- 5. ROCK MATERIALS:
 - 5.1. ROAD BASE: CALTRANS STANDARD SPECIFICATIONS SECTION 26 CLASS 2 AGGREGATE BASE
 - 5.2. WASHED CRUSHED ROCK: CALTRANS STANDARD SPECIFICATIONS SECTION 26 CLASS 2 3/4" AGGREGATE BASE

6. CONCRETE MATERIALS:

- 6.1. CAST-IN-PLACE OR PRECAST DRAINAGE STRUCTURES: CALTRANS STANDARD SPECIFICATIONS 51 590 LB/CU YD, MAX COMPRESSIVE STRENGTH = 3,600 PSI, MAX AGGREGATE SIZE = 1 INCH
- 6.2. MORTAR: CALTRANS STANDARD SPECIFICATIONS SECTION 51
- 6.3. CONCRETE SLURRY: CALTRANS STANDARD SPECIFICATIONS SECTION 19
- 6.4. CONCRETE FINISH: CALTRANS STANDARD SPECIFICATIONS SECTION 51 ORDINARY SURFACE FINISH
- 6.5. CONCRETE CURING: CALTRANS STANDARD SPECIFICATIONS SECTION 90 TYPE I-D MEMBRANE CURING COMPOUND
- 6.6. EPOXY ADHESIVE ANCHOR: HILTI HIT-RE 100
- 7. BITUMINOUS MATERIALS:
 - 7.1. CALTRANS STANDARD SPECIFICATIONS SECTION 39

100% DESIGN

						DESIGNED BY	JA
						DRAWN BY	DLJ
						CHECKED BY	AB
						APPROVED BY	JA
REV	DATE	BY	СНК	APP	DESCRIPTION	DATE	5/13/2024







SANTA BARBARA COUNTY PUBLIC WORKS

> 123 EAST ANAPAMU STREET SANTA BARBARA, CA 93101


SANTA BARBARA COUNTY ISLA VISTA TRASH CAPTURE PROJECT

NOTES AND SPECIFICATIONS

DRAWING NO. G-02 SCALE SHEET NO. 2 OF 5

CWR0811

NONE

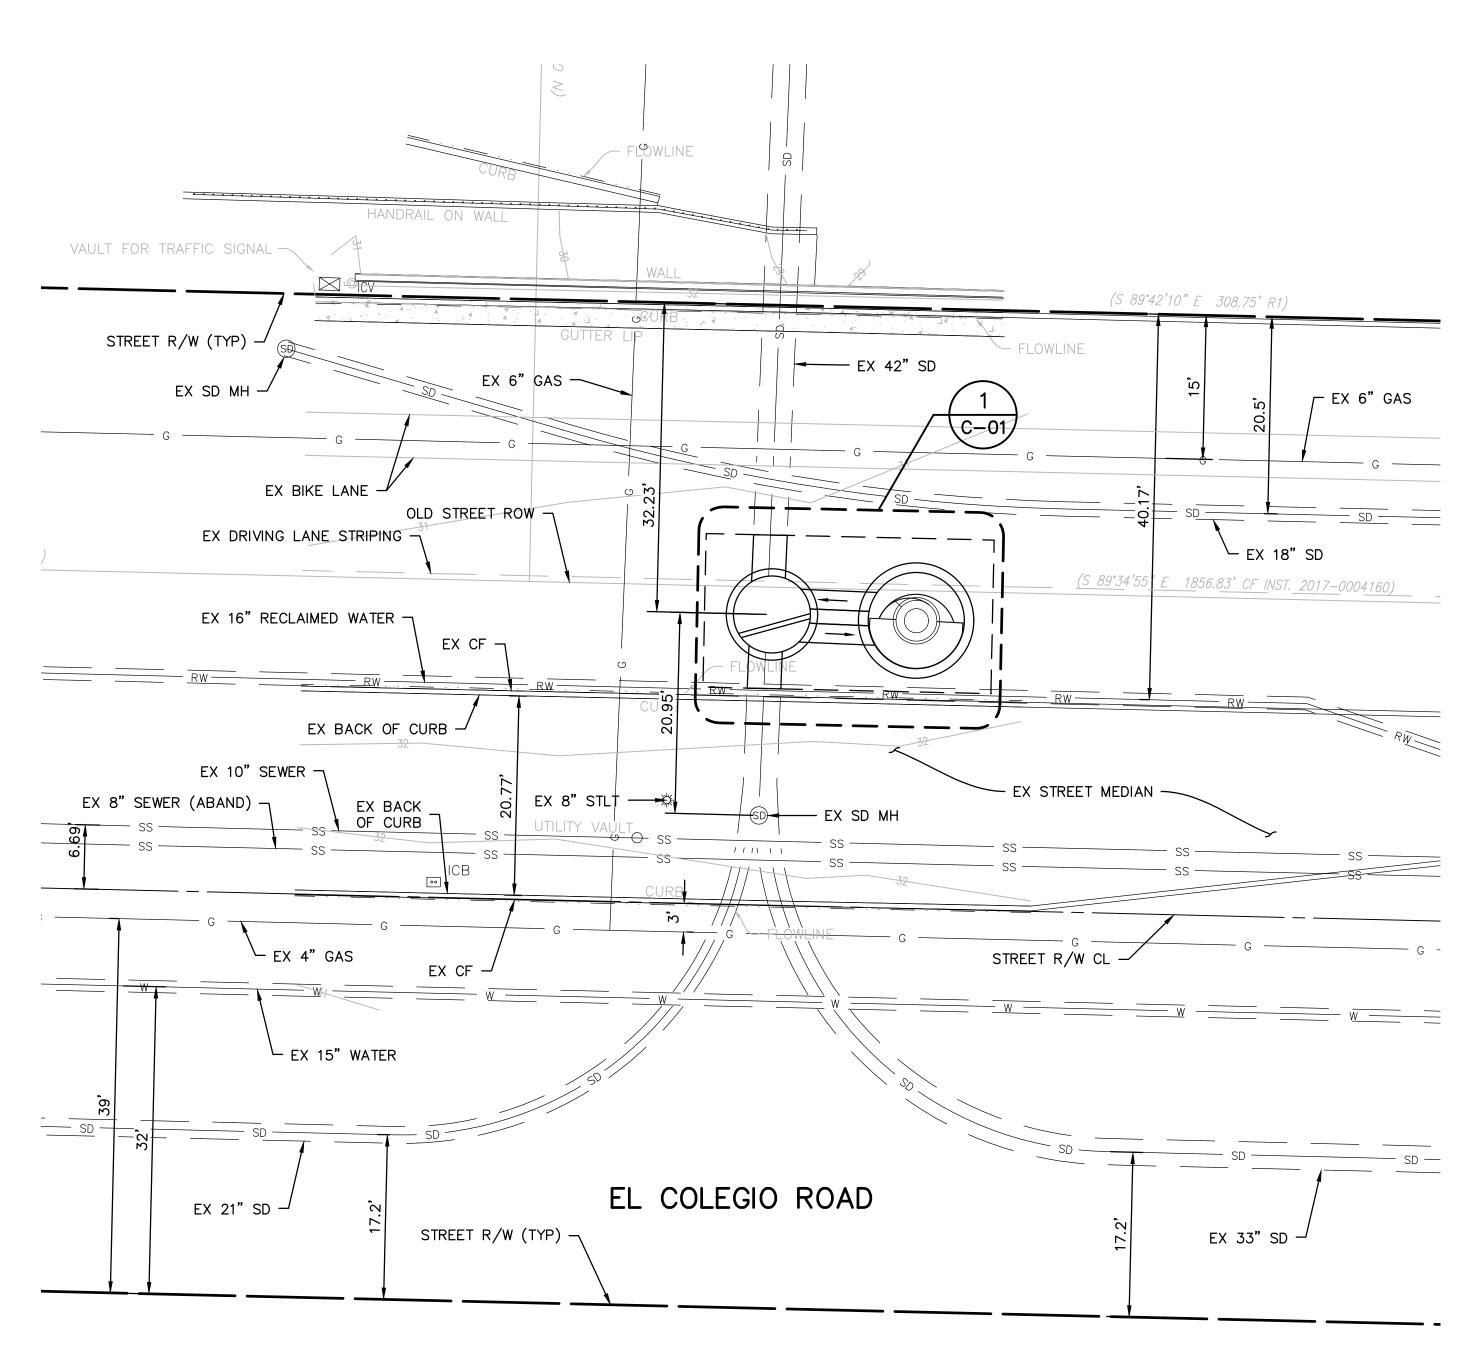

SITE PLAN:

SCALE: 1" = 10'



- 1. POTHOLE ALL EXISTING UTILITIES THAT MEET ANY OF THE FOLLOWING CONDITIONS:
- 1.1. EXISTING UTILITIES TO BE CROSSED BY PROPOSED DRAIN PIPE
- 1.2. EXISTING UTILITIES LOCATED WITHIN PROPOSED EXCAVATION FOOTPRINT
- 2. FINAL DIVERSION MANHOLE AND HYDRODYNAMIC SEPARATOR UNIT LOCATION AND ROUTING OF PROPOSED DRAIN PIPE BETWEEN DIVERSION MANHOLE AND HYDRODYNAMIC SEPARATOR UNIT MAY BE FIELD ADJUSTED BY THE ENGINEER.
- 3. FOR HEAVY EQUIPMENT, MAINTAIN 10' MINIMUM HORIZONTAL CLEARANCE FROM EXISTING OVERHEAD UTILITIES AND UTILITY POLES.
- 4. PROTECT IN PLACE ALL UTILITIES ENCOUNTERED NEAR IMPROVEMENT LOCATIONS.

CONSTRUCTION NOTES:

19.10 INV -

30" FRAME AND COVER, CENTERED OVER STRUCTURE

19.19 INV —

∕−(31.77)FS

6" (TYP)

X SEE CORRESPONDING CONSTRUCTION NOTES BELOW:

SAWCUT; REMOVE EXISTING AND INSTALL NEW BASE MATERIAL (6" MIN) & ACP (6" MIN) TO MATCH EXISTING SECTION PER REFERENCE DETAIL C/R-01.

∠42" SD OUT

N: 1979477.73

E: 6000835.66

┌24" DIVERSION

RETURN PIPE

└24" DIVERSION

19.15 INV-

ENLARGED SITE PLAN

OUTFLOW

SCALE: 1" = 2'

∟19.09 INV

└19.13 INV

►EX FLOWLINE

19.15 INV ¬

- . POTHOLE EXISTING UTILITY, PROTECT IN PLACE
- 3. INSTALL 8' ID DIVERSION MANHOLE PER 1/C-01 & A/C-02.
- 4. INSTALL 24" HDPE PIPE @ 0.4% PER DETAIL 1/C-01 & EACH END WITH ADAPTER BOOT AND GASKET AS SHOWN IN DETAIL D/C-02.
- 5. CONSTRUCT REINFORCED CONCRETE BERM PER DETAIL A/C-02 & B/C-02.
- 6. INSTALL 10' ID HYDRODYNAMIC SEPARATOR UNIT (E.G. CONTECH CDS UNIT CDS5653-10) PER DETAIL 1/C-01 & A/C-02.
- DEMO EX 42" RCP TO THE NEAREST JOINT OUTSIDE OF DIVERSION MANHOLE BASE. RECONSTRUCT IN KIND.

DEFERRED DESIGN SUBMITTALS

AND PERMITS BY CONTRACTOR:

- TRAFFIC CONTROL PLANS PREPARED BY A LICENSED ENGINEER AND PERMIT
- 2. SHORING SUBMITTAL PREPARED BY A LICENSED ENGINEER AND PERMIT
- 3. DEWATERING SUBMITTAL PREPARED BY A LICENSED ENGINEER AND ASSOCIATED PERMIT

0 1' 2' 4'

(31.37)FS

EX DRIVING — LANE STRIPING

N: 1979477.10

E: 6000850.69

PLACE EX CF

100% DESIGN

							
						DESIGNED BY	JA
						DRAWN BY	DLJ
						CHECKED BY	AB
						APPROVED BY	Y JA
REV	DATE	BY	СНК	APP	DESCRIPTION	DATE	5/13/2024







SANTA BARBARA COUNTY PUBLIC WORKS

> 123 EAST ANAPAMU STREET SANTA BARBARA, CA 93101


SANTA BARBARA COUNTY ISLA VISTA TRASH CAPTURE PROJECT

SITE PLAN AND DETAILS

JOB NO.	CWR0811
DRAWING NO.	C-01
SCALE	AS SHOWN
SHEET NO.	3 OF 5

DATE

BY CHK APP

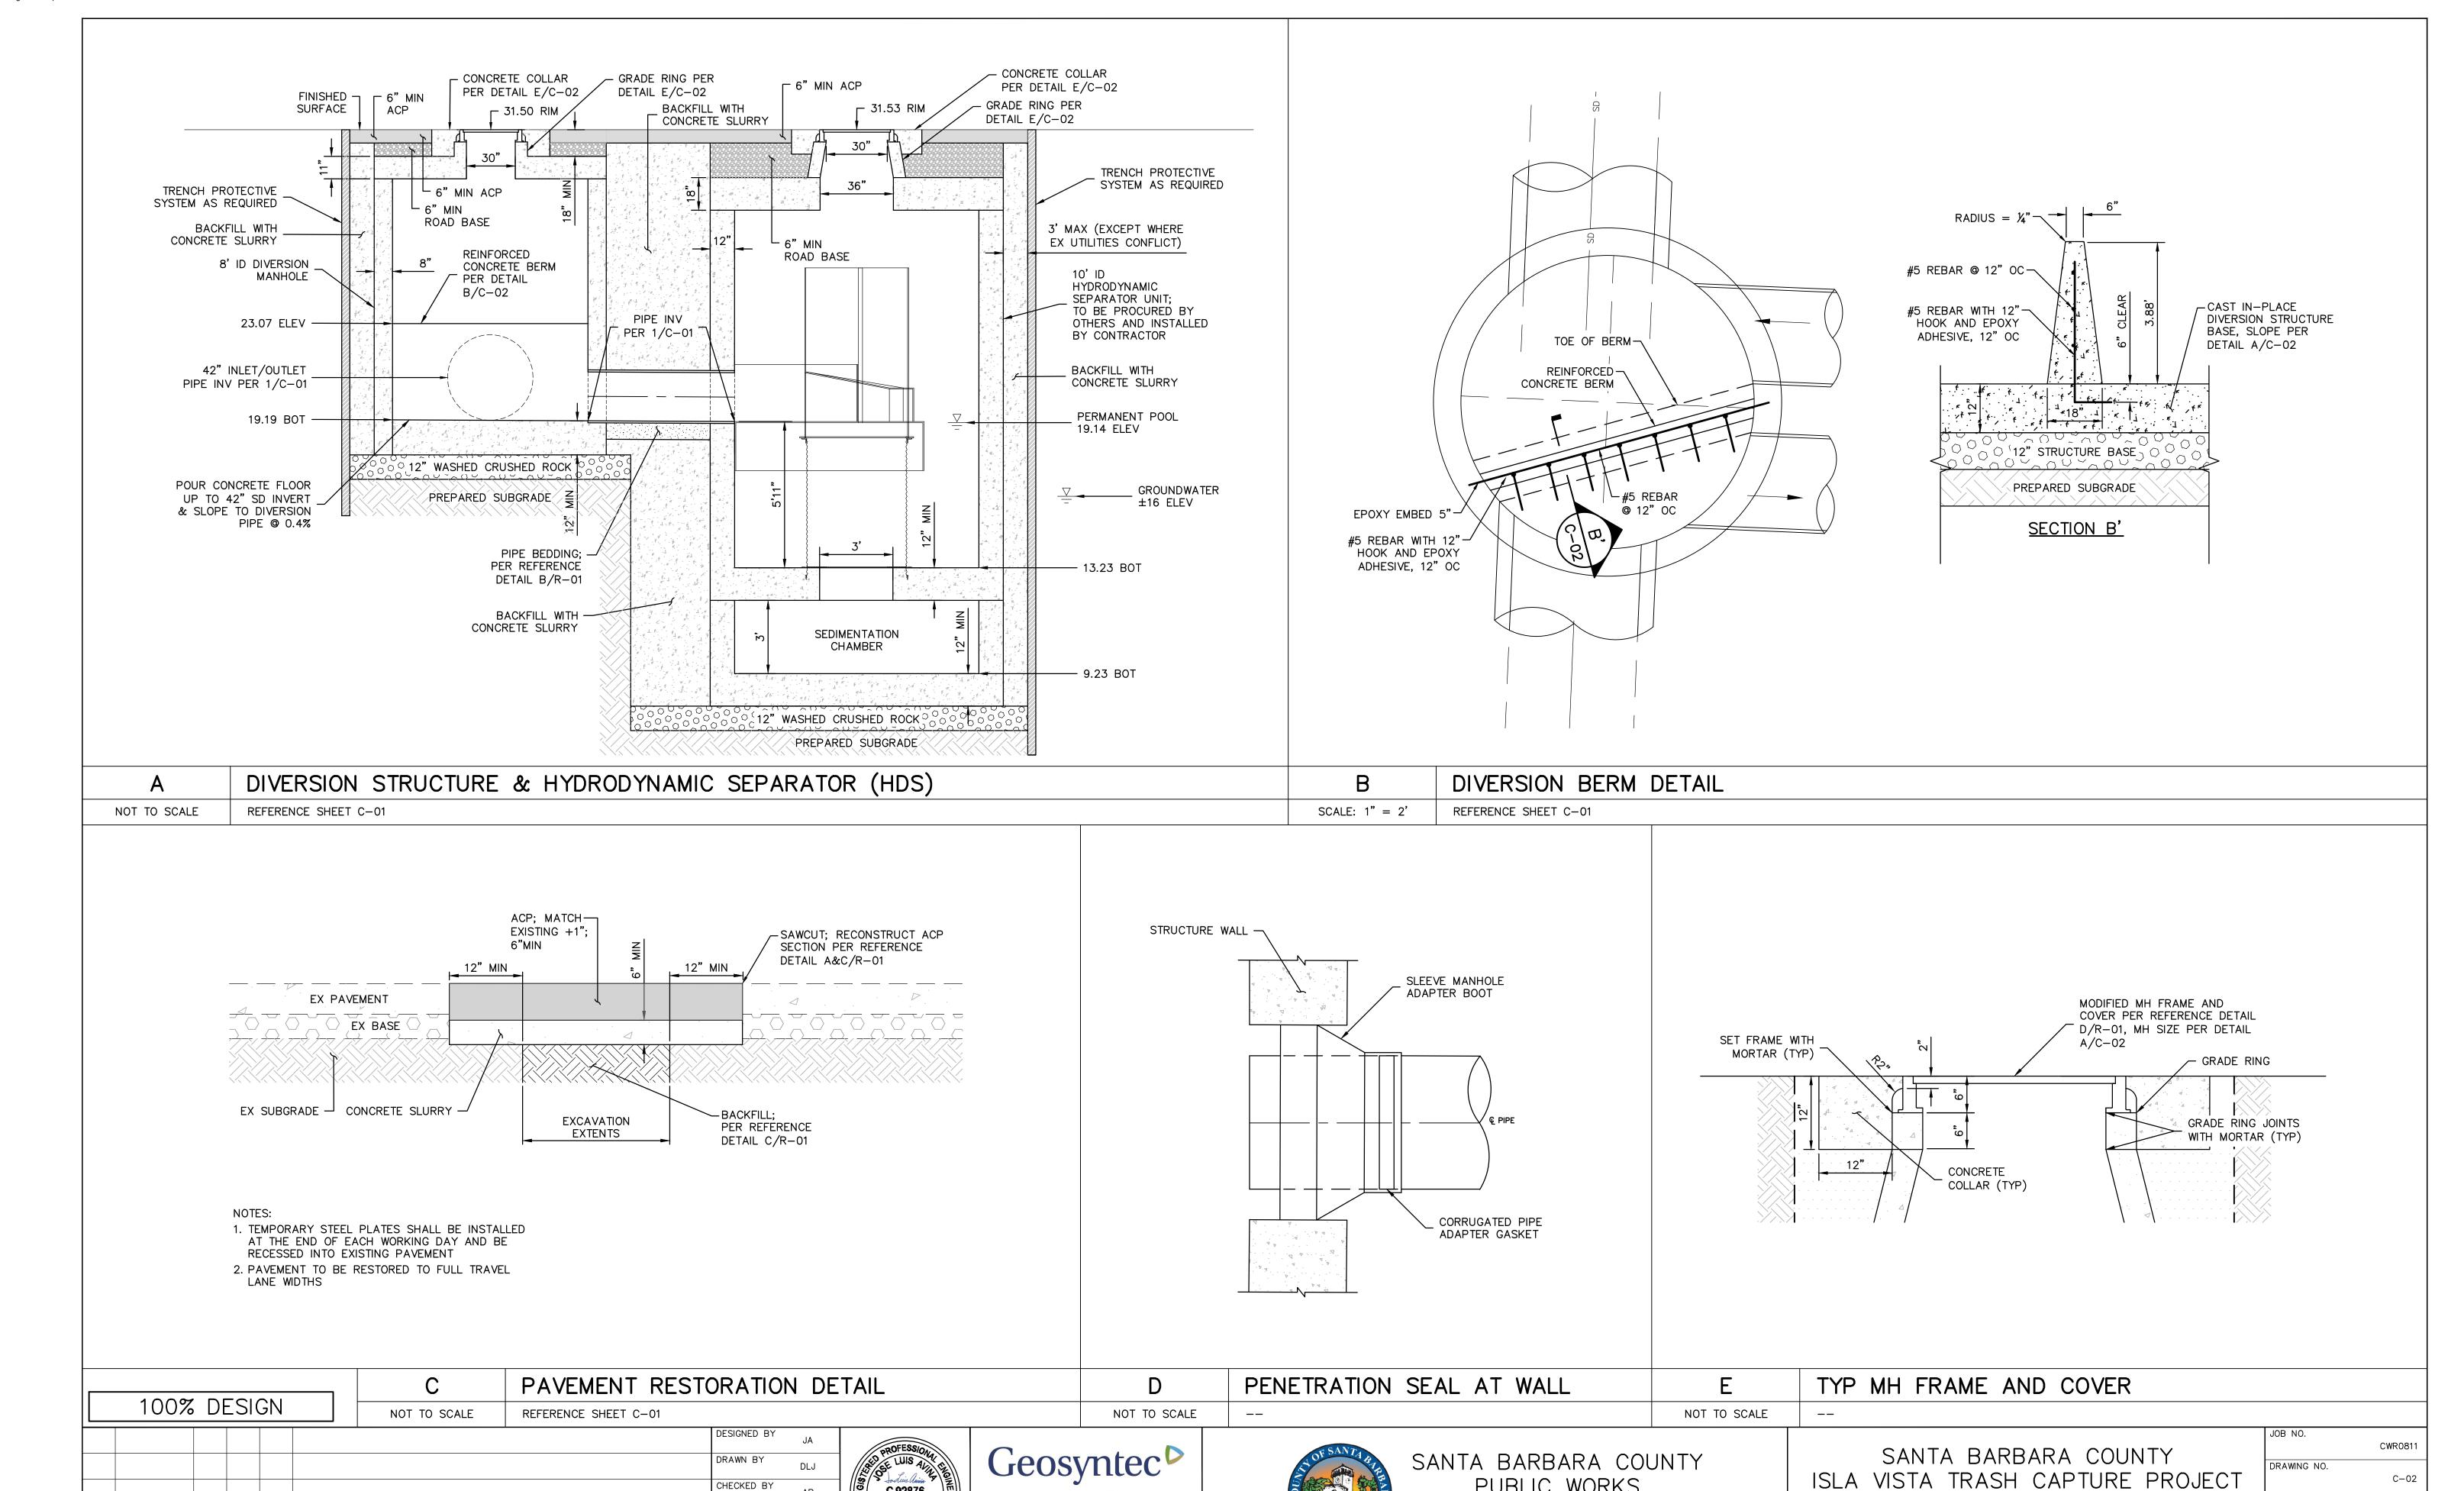

CHECKED BY

APPROVED BY

DATE

DESCRIPTION

AB

5/13/2024

C 92876

consultants

engineers | scientists | innovators

PUBLIC WORKS

123 EAST ANAPAMU STREET SANTA BARBARA, CA 93101

C-02

AS SHOWN

4 OF 5

SCALE

SHEET NO.

DETAILS

. COUNTY STANDARD PLANS AND SPECIFICATIONS SHALL INCLUDE THE CURRENT VERSIONS OF CALTRANS STANDARD PLANS AND SPECIFICATIONS AND APWA STANDARD PLANS AND SPECIFICATIONS FOR SOUTHERN CALIFORNIA, IF THERE IS A CONFLICT BETWEEN THESE STANDARD PLANS AND SPECIFICATIONS, THE COUNTY STANDARD DETAILS SHALL GOVERN ON COUNTY ROADS, CALTRANS PLANS SHALL HAVE PRECEDENCE OVER APWA PLANS UNLESS SPECIFICALLY STATED OTHERWISE,

2. CONSTRUCTION PLANS SHALL BE PREPARED IN ACCORDANCE WITH DEPARTMENT OF PUBLIC WORKS ENGINEERING DESIGN STANDARDS OR CURRENT CALTRANS STANDARD PLANS AND SPECIFICATIONS.

3. COMMENCEMENT OF CONSTRUCTION SHALL NOT BE AUTHORIZED UNTIL SUCH TIME THAT THE CONSTRUCTION PLANS HAVE BEEN REVIEWED BY THE DIRECTOR OF PUBLIC WORKS AND AN ENCRDACHMENT PERMIT HAS BEEN ISSUED. THE 'DIRECTOR OF PUBLIC WORKS' SHALL BE INTERPRETED TO MEAN THE DIRECTOR OR HIS DESIGNATED REPRESENTATIVE(S) REFERRED TO HERE AS THE COUNTY

4. INSPECTION BY THE COUNTY ENGINEER SHALL BE REQUESTED BY THE CONTRACTOR IMMEDIATELY PRIOR TO COMMENCING AND IMMEDIATELY AFTER COMPLETING EACH PHASE OF CONSTRUCTION.

5. UNLESS PRIOR AUTHORIZATION HAS BEEN GRANTED BY THE COUNTY ENGINEER, ALL VERTICAL DATUM SHALL BE BASED ON NAVD 88 DATUM, AND HORIZONTIAL COORDINATES BASED ON NAD 83 DATUM.

6. THE STANDARD TEST FOR MAXIMUM DENSITY AND OPTIMUM MOISTURE CONTENT SHALL BE ASTM D 1557 (CURRENT VERSION) METHOD 'A', 'B', OR 'C'. FIELD TEST FOR IN PLACE DENSITY AND MUISTURE CONTENT SHALL BE ASTM D 2922 AND D 3017 (CURRENT VERSIONS). TEST METHOD 'C' MAY BE MODIFIED TO ALLOW THE USE OF CALIFORNIA TEST METHOD 370 FOR DETERMINING MOISTURE CONTENT OF MINERAL AGGREGATE USING MICROWAVE OVENS.

SHT 1/2

NOT TO SCALE

DATE

BY CHK APP

COUNTY OF SANTA BARBARA, CA - DEPARTMENT OF PUBLIC WORKS - TRANSPORTATION

GENERAL STREET SPECIFICATIONS

REFERENCE SHEET C-01 & C-02

7. WATER FOR COMPACTION AND DUST CONTROL SHALL BE MADE AVAILABLE BY THE CONTRACTOR, DUST AND EROSION CONTROL ARE THE RESPONSIBILTY OF THE CONTRACTOR AND SHALL BE AS DIRECTED BY THE COUNTY ENGINEER.

8. AN EROSION & SEDIMENT CONTROL PLAN OR A STORM WATER POLUTION PREVENTION PLAN SHALL BE SUBMITTED FOR REVIEW AND APPROVAL BY THE COUNTY ENGINEER IN ACCORDANCE WITH THE COUNTY GRADING CODE (CHAPTER 14 SBCC) OR WITH THE STATE CONSTRUCTION GENERAL PERMIT FOR DISCHARGES OF STORM WATER AS APPLICABLE.

9. TRENCH BEDDING AND BACKFILL FOR ALL STORM DRAINS, CULVERTS, AND UTILITY TRENCHING SHALL COMPLY WITH THE DETAILS OF SECTION 2.

10, ALL DRAINAGE FACILITIES SHALL COMPLY WITH THE STANDARDS OF SECTION 3.

11. ALL CURBS AND DRIVEWAYS SHALL COMPLY WITH THE STANDARDS OF SECTION 4.

12. ALL SIDEWALKS & RAMPS SHALL COMPLY WITH THE STANDARDS OF SECTION 5,

13. ALL ROAD PROFILES AND STRUCTURAL SECTIONS SHALL COMPLY WITH THE STANDARDS OF SECTION 6.

14, STREET NAME SIGNS, BARRICADES, TRAFFIC CONTROL AND TRAFFIC WARNING SIGNS SHALL BE PLACED IN ACCORDANCE WITH SECTION 7 OF THESE STANDARD DETAILS AND THE CALIFORNIA MANUAL ON UNIFORM TRAFFIC CONTROL DEVICES, ALL OF CURRENT

APPROVED BY

MEANUN 47

	DUT TO THE P LINE, AND AT STREETS UNDE BACKFILLED, T AND INSPECTE COUNTY ENGINE PERMANENT SU 16. ASPHALTIC SHALL BE MAD AGGREGATE SO SECTION 39. T COUNTY ENGINE SPECIFICATION: COMPACTING SE 17. OVERLAY S AGGREGATE WI	CONSTRUCTED UNDERGRDUND SHALL BE STUBBED PROPERTY LINES AT EACH LOT, AT EACH TRACT THE END OF STUB STREETS OR THROUGH ER CONSTRUCTION. TRENCHES SHALL BE TESTED FOR COMPACTION, LEAK-TESTED, OBY THE UTILITY COMPANY AND THE EER BEFORE BASE, PAVING, AND OTHER SUFFACE CONSTRUCTION MAY COMMENCE. CONCRETE USED FOR PAVING AND A. C. DIKES DE WITH A PERFORMANCE-GRADE ASPHALT AND DETER OF COLORERS STANDARD SPECIFICATIONS, THE MIX DESIGN SHALL BE APPROVED BY THE MIX DESIGN SHALL BE APPROVED BY THE MIX DESIGN SHALL BE APPROVED BY THE MIX DESIGN HAULING, SPREADING, AND SHALL BE STRICTLY FOLLOWED. SECTIONS SHALL CONSIST OF 1/2' MAX OF THE MIX DESIGN ASPHALT EMULSION SHALL MAX ITH MEDIUM GRADING, ASPHALT EMULSION SHALL MER PAVEMENT REINFORCING FABRIC WHERE ECIFIED.		
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	COUNTY D	DF SANTA BARBARA, CA - DEPARTMENT DF PUBLIC WORKS - TRANSPORTATION APP	PROVED BY:	
	1-010 SHT 2/2	GENERAL STREET SPECIFICATIONS REVISION DATES DATES	RECTOR OF PUBLIC WORKS	1/1/2011
1	4144			

NOTES: (REFER TO 2-010 FOR ADDITIONAL NOTES)

1. TRENCH WIDTH SHALL BE SUFFICIENT TO FULLY ENCLOSE THE PIPE AND ALLOW COMPACTION TESTING AT THE SPRING

2. BEDDING MATERIAL FOR UTILITY TRENCHES SHALL MEET THE STANDARDS OF THE UTILITY COMPANY INVOLVED.

3. BEDDING MATERIAL FOR HDPE, RCP AND CMP SHALL FOLLOW THE MANUFACTURER'S RECOMMENDATIONS AND SHALL BE COMPACTED TO 95% RELATIVE COMPACTION, FILL MUST BE PLACED IN LIFTS NO LARGER THAN 8' TO FACILITATE COMPACTION, FOR CMP PIPE, THE BEDDING MATERIAL SHALL BE TESTED FOR A NEUTRAL pH.

4. THE THICKNESS OF THE LAYER OF BEDDING UNDER THE PIPE SHALL BE AT LEAST 4' OR 10% OF THE PIPE DIAMETER, WHICHEVER IS LARGER.

5. BEDDING MATERIAL SHALL COMPLETELY COVER THE PIPE TO A MINIMUM HEIGHT OF 6" AFTER COMPACTION.

COUNTY OF SANTA BARBARA, CA - DEPARTMENT OF PUBLIC WORKS - TRANSPORTATION

REFERENCE SHEET C-01 & C-02

6. CARE MUST BE TAKEN TO PLACE THE BEDDING EVENLY UNDER THE LENGTH OF THE PIPE TO ASSURE ADEQUATE SUPPORT, COMPACTION TESTING IS REQUIRED AT THE SPRINGLINE OF THE PIPE WHEN SAND IS USED AS BEDDING

7. BACKFILL MATERIAL SHALL MEET THE REQUIREMENTS OF SBCD STD 2-030 AND 2-040

PIPE BEDDING DETAILS

8. SEE NOTE 2 ON 2-010

-BACKFILL($_{7})$ 2 (3) BEDDING MATERIAL ZUNE (6) SPRINGLINE -8 (IF REQ'D) ELEVATION

APPROVED BY

					PIRECTOR OF PUBLIC YORKS	DATE	
		, 					
В	CSB PIPE BEDDING	DE	TAII	LS			

REVISION DATES

SECTION A NOTES: (REFER TO 2-010 FOR ADDITIONAL NOTES) 1. ALL TRENCH WORK ON EXISTING PAVED ROADS SHALL COMPLY WITH THIS STANDARD. 2. PAVEMENT SHALL BE SAW CUT 2' WIDER THAN THE WIDTH OF THE TRENCH PRIOR TO EXCAVATION, RECUT MAY BE NEEDED WHERE TRENCH EDGE IS NOT SOLID AS DETERMINED BY THE COUNTY ENGINEER. (4) BACKFILL 3. BEDDING DETAILS SHALL COMPLY WITH SBCO STD 2-020. CEMENT_ SLURRY 4. BACKFILL MATERIAL UNDER EXISTING ROADS SHALL BE SLURRY CEMENT MEETING CALTRANS STANDARD SPECIFICATIONS, SECTION 19, FOR MATERIALS AND SHALL BEDDING -BE MIXED WITH I SACK OF CEMENT PER CUBIC YARD. BEDDING ZONE 5. IF THE EDGE OF THE TRENCH IS WITHIN 4' OF THE EXISTING EDGE OF PAVEMENT (EP), THE SAWCUT SHALL BE MADE AT THE EP OR GUTTER AS SHOWN IN SECTION SECTION I PATCH LIP A. C. PATCH 6' THICK APPROVED BY COUNTY OF SANTA BARBARA, CA - DETARTMENT OF PUBLIC WORKS - TRANSPORTATION 5-030 TRENCHES FOR EXISTING PAVED ROADS 1/1/2011 REVISION BOX

CSB GENERAL STREET SPECIFICATIONS

NOTESI (REFER TO 3-010 FOR ADDITIONAL NOTES) 1. STRUCTURAL DETAILS SHALL FOLLOW APWA STANDARD PLANS, SECTION 3 AS APPROPRIATE FOR THE DEPTH AND LINE SIZES. CERTIFIED PRE-CAST ELEMENTS MAY BE USED WITH AN APPROVED SUBMITTAL, FOR ELEMENTS TO BE CAST IN PLACE, ALL CONCRETE SHALL BE CALTRANS CLASS 2 WITH 25% FLYASH. 2. TRENCH BACKFILL COMPACTED TO 95% OF MAXIMUM DENSITY MAY BE USED FOR FOUNDATIONS IN SHOULDER AREAS AND WHERE ALUMINUM STRUCTURES ARE PRESENT. WHERE SPACE WILL NOT ALLOW STANDARD COMPACTION EQUIPMENT TO OPERATE. THE TRENCH SHALL BE FILLED WITH A 1-SACK SLURRY CEMENT BACKFILL PER CALTRANS STANDARD SPECIFICATIONS, SECTION 19, 3. MANHULE FRAME AND COVER SHALL BE 24' AND SET 1/8' BELOW STREET GRADE OVER A SERIES OF RINGS FOR LATER ADJUSTMENT. 4. A CONCRETE COLLAR SHALL BE PROVIDED ALSO BELOW STREET GRADE TO ENCIRCLE THE MANHOLE FRAME, IT SHALL BE 1' DEEP AND EXTEND 1' BEYOND THE FRAME AND SET 1/8' BELOW STREET GRADE. 5. THE FOUNDATION SHALL BE 3/4' WASHED CRUSHED ROCK AND AT LEAST 1' THICK.

NOT TO SCALE

COUNTY OF SANTA BARBARA, CA - DEPARTMENT OF PUBLIC WORKS - TRANSPORTATION

STORM DRAIN MANHOLE

REFERENCE SHEET C-01 & C-02

6. FOR PIPE CONNECTIONS, REFER TO STANDARD 3-115.

3-080

NOT TO SCALE

ELEVATION

APPROVED BY

CSB TRENCHES FOR EXISTING PAVED ROADS 100% DESIGN NOT TO SCALE REFERENCE SHEET C-01 & C-02

5/13/2024

DATE

C 92876

Geosyntec consultants engineers | scientists | innovators



CSB STORM DRAIN MANHOLE

123 EAST ANAPAMU STREET SANTA BARBARA, CA 93101

SANTA BARBARA COUNTY ISLA VISTA TRASH CAPTURE PROJECT

REFERENCE STANDARD PLANS

JOB NO.	
	CWR0811
DRAWING NO.	
	R-01
SCALE	
	AS SHOWN
SHEET NO.	
	5 O F 5
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DESIGNED BY JA DRAWN BY DLJ CHECKED BY AB APPROVED BY

DESCRIPTION