SANTA BARBARA COUNTY FLOOD CONTROL AND WATER CONSERVATION DISTRICT

UNIT II CHANNEL DRAINAGE IMPROVEMENTS PROJECT

AREA OF SANTA MARIA SANTA BARBARA COUNTY, CALIFORNIA




DISTRICT BOARD OF DIRECTORS

FIRST DISTRICT
SECOND DISTRICT
THIRD DISTRICT
FOURTH DISTRICT
FIFTH DISTRICT, CHAIR

Salud Carbajal Janet Wolf Doreen Farr Peter Adam Steve Lavagnino

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UNAUTHORIZED CHANGES OR USES:
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Engine	rfield & Smith eering · Surveying · Planning struction Management ·
111 East Victoria Street, Phone: (805) 963-9532	Santa Barbara, CA 93101 Fax: (805) 966-9801
PROJECT MANAGER: PROJECT ENGINEER:	CRAIG STEWARD AUTUMN GLAESER

PROJECT

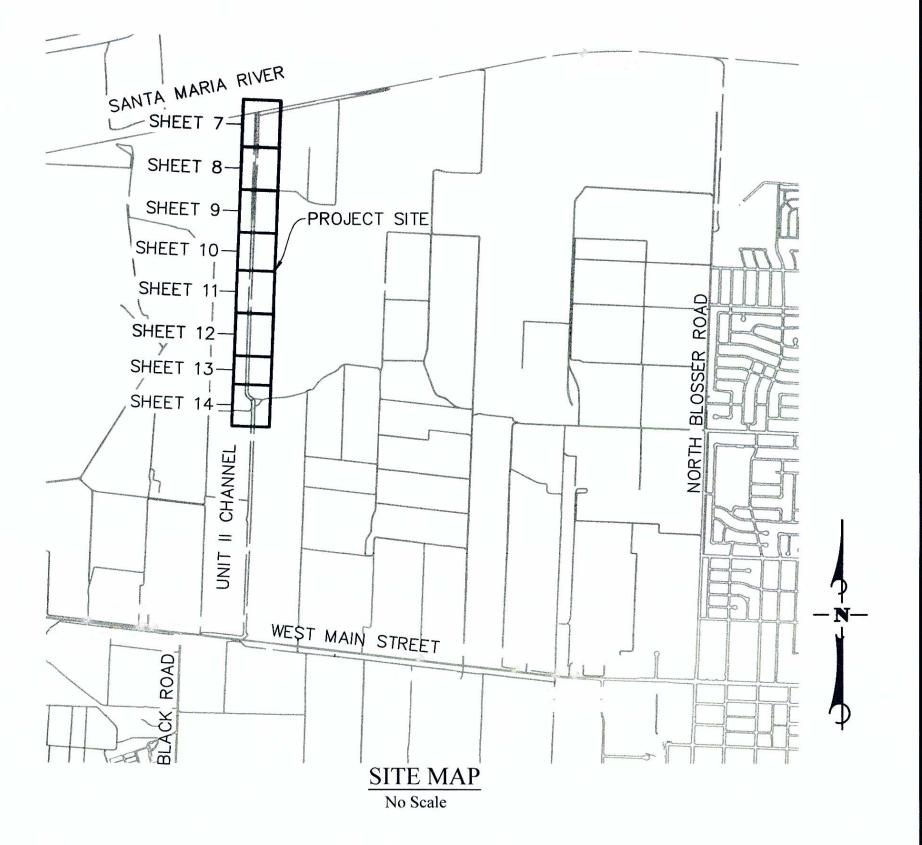LOCATION

	REVISIONS	***		DESIGNED BY:		REVIEWED BY:	
NO.	DESCRIPTION	DATE	APR	DESIGN ENGINEER	DATE	COUNTY SURVEYOR	
				REVIEWED BY:	_	REVIEWED BY	
				FLOOD CONTROL ENGINEERING MANAGER	5-8-17 R DATE	MAINTENANCE SUPERINTENDENT	-
				REVIEWED BY		REVIEWED BY	
_			_	Jan Jan	5-8-17	Maureen Dencer	_3.
				FLOOD CONTROL DEPUTY DIRECTOR	DATE	ENVIRONMENTAL SERVICES MANAGER	

VICINITY MAP

SANTA BARBARA COUNTY
FLOOD CONTROL AND
WATER CONSERVATION DISTRICT
130 E. VICTORIA STREET
SANTA BARBARA, CA 93101
(805) 568-3440



UNIT II CHANNEL DRAINAGE IMPROVEMENTS PROJECT

AREA OF SANTA MARIA SANTA BARBARA COUNTY, CALIFORNIA

TITLE SI	HEET
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DESIGNED BY: ALG DRAWN BY: OWP CHECKED BY: SHEET 1 OF 26	IMPLEMENTATION OF ANY SUCH	CHANGE OR USE.					
HEET OWP		DESIGNED BY:					
OMP OWP	HEET	ALG					
CUEET 4 OF OC							
CHECKED BY: SHEET 1 OF 26		OWP					
		CHECKED BY:	SHEET	1	OF	26	

Filename: 20643.01 Title Sheets.dwg

POINT#	NORTHING	EASTING	ELEVATION	<u>DESCRIPTION</u>	RECORD	POINT#	NORTHING	EASTING	ELEVATION	<u>DESCRIPTION</u>	RECORD
CP1		5816849.15		SET PIPE WITH 2" OUTSIDE DIAMETER BRASS CAP STAMPED "SANTA BARBARA COUNTY SURVEYOR STA CONTROL PT" NEAR INFORMATION BOARD	N/A	MON108*	2179563.38			FOUND 6"X6" CHC MON "36-103"	CalTrans ROW Map SB 166 PM 004.5 and Tentative Monumentation Map SB 166 PM 000.0
CP2	2179239.96	5817046.32	177.67	FOUND PK NAIL SET ON TOP OF CONCRETE STRUCTURE FOR CALIFORNIA STATE WATER. OLD POINT 100	S637, S691	MON109	2179236.92	5815777.35	172.24	FOUND 3 1/2" BRASS DISC ON TOP SOUTHERLY END CONCRETE HEADWALL, STAMPED "FOR MORE	SHT 17 Caltrans Control Databas
CP3		5817370.70 5817242.72		FOUND 5/8" REBAR SET 6' NORTHERLY OF POWER POLE. OLD POINT 101 SET MAG NAIL IN TOP OF CONCRETE	S458 N/A					INFORMATION OR TO REPORT DAMAGE WRITE THE DIRECTOR NATIONAL GEODETIC SURVEY WASHINGTON, D. C. VERTICAL CONTROL MARK T 1215 RESET 1994" AT PM 4.82	
CP5	2184226.62	5817420.56	170.08	SCTRUCTURE FOR CALIFORNIA STATE WATER SET 2" OUTSIDE DIAMETER IRON PIPE	NI /A	MON110	2179216.27	5816167.04	170.74	FOUND 1" IP WITH PLASTIC PLUG STAMPED "CALIF DOT" LOCATED AT PM 4.9	CalTrans Tentative Monumentation Map SB
CFJ	2104220.02	3617420.36	170.06	WITH 2" BRASS CAP STAMPED "SANTA BARBARA COUNTY SURVEYOR STA	N/A	MON111	2179065.92	5817376.31	174.63	FOUND 1" IP WITH PLASTIC PLUG STAMPED "CALIF	166 PM 000.0 SHT 19 Caltrans Control Databas
CP6	2184307.30	5817080.67	162.58	CONTROL PT" NEAR INFORMATION BOARD FOUND 1 1/2" IRON PIPE WITH CONE	S637, S691, 86/RS/33	MON112	2187781.71	5815910.89	156.92	DOT" LOCATED AT PM 5.12 FOUND 2" IP WITH 2" BRASS CAP STAMPED "RE 2928"	86/RS/33
CP7	2190239.77	5817333.88	167.41	AND NAIL SHANK. OLD POINT 511. SET MAG NAIL IN TOP OF WESTERLY	N/A	MON113	2185584.38	5816406.23	160.17	FOUND 2 1/2" IP WITH 2" BRASS DISC STAMPED "MON NO. 118 R.E. 2928"	N 86/RS/33
				CORNER OF CONCRETE PAD WITH SHUT OF VALVE RISER TO 10" CALIFORNIA STATE WATER LINE LATERAL		MON114 MON115	2184206.73		167.50	FOUND 1/2" IP WITH TAG STAMPED "LS 3166" FOUND REBAR WITH PLASTIC CAP STAMPED "LS 4597"	<u> </u>
CP8	2190173.47	5817379.26	170.68	SET MAG NAIL IN TOP OF CONCRETE STRUCTURE FOR CALIFORNIA STATE	N/A	MON116 MON117	2184205.65 2188913.48	5817216.60 5817257.02	169.08 159.49	FOUND 3/4" IP WITH TAG STAMPED "LS 3485" FOUND 3/4" IP WITH TAG STAMPED "RE 2928"	178/RS/28-29 NO RECORD
000	0100105	5047450 54	100.51	WATER AT SOUTHWEST CORNER OF OVERSPILL NEAR FLAPGATE TO LEVEE		MON118 MON119	2190275.29 2190173.97		161.38 165.17	DISTURBED, SHOT AT BASE FOUND REBAR WITH PLASTIC CAP STAMPED "LS 4597" FOUND REBAR WITH PLASTIC CAP STAMPED "LS 4597"	
CP9	2190125.85	5817459.54	166.51	SET MAG NAIL IN TOP OF CONCRETE STRUCTURE FOR CALIFORNIA STATE WATER VAULT AT THE EASTERLY	N/A	MON120 MON121	2188946.12 2188953.80	5817370.15 5817395.41	155.38 158.47	FOUND 1" IP WITH TAG STAMPED "LS 3485" FOUND 1 3/4" IP WITH TAG STAMPED "LS 3485"	178/RS/28-29 178/RS/28-29
		5817375.45	167.97	CORNER IN CLF ENCLOSURE NOTHING SET, NOTHING FOUND	N/A	MON122 MON123 MON124		5817187.27 5817326.80		FOUND REBAR WITH PLASTIC CAP STAMPED "LS 4597" FOUND REBAR WITH PLASTIC CAP STAMPED "LS 4597" FOUND REBAR WITH PLASTIC CAP MARKED "LS 4597"	· · - / · · - / — - — -
<u>ESECT9-7</u> MON100*		5824000.29	191.66	FOUND 6"X6" CHC MON, "38-112"	CalTrans ROW Map SB 166 PM 006.6 and Tentative Monumentation Map SB	MON125 MON126	2186817.76 2187335.21	5817277.39 5817311.25	161.15 158.61	FOUND REBAR WITH PLASTIC CAP MARKED "LS 4597" FOUND REBAR WITH PLASTIC CAP MARKED "LS 4597"	178/RS/28-29 178/RS/28-29
MON101*	2178440.01	5823586.77	190.96	FOUND 6"X6" CHC MON, "37-110"	166 PM 000.0 SHT 24 CalTrans ROW Map SB 166 PM 006.3	MON127 MON1003	2187335.65 2179264.68			FOUND REBAR WITH PLASTIC CAP MARKED "LS 4597" FOUND A 9/16" DIAMETER STAINLESS STEEL ROD WITH A 2 1/2" DIAMETER BRASS CAP STAMPED "S.B.	178/RS/28-29 147/RS/57-61
MON102*	2178441 27	5823575.67	191.06	FOUND 6"X6" CHC MON, "37-108"	and Tentative Monumentation Map SB 166 PM 000.0 SHT 23 CalTrans ROW Map SB 166 PM 006.3					CO. GPS CÓNTROL 1992 PLS 5470 STA. 1003" AND CENTER PUNCHED, INSIDE A 6" DIA. ALUMINUM MON.	
					and Tentative Monumentation Map SB 166 PM 000.0 SHT 23					WELL, MISSING COVER, FLUSH WITH THE ASPHALT ROAD SURFACE AT THE INTERSECTION OF THE CENTERLINE OF BLACK ROAD WITH THE SOUTHERLY	
MON103*	2178537.35	5822745.70	187.65	FOUND MAG NAIL AND WASHER STAMPED "LS4597" LOCATED IN SAME	CalTrans ROW Map SB 166 PM 006.3 and Tentative Monumentation Map SB	MON1106**	2173040.43	5824163.40	197.56	EDGE OF PAVEMENT OF HWY 166 FOUND A 1" DIAMETER IRON PIPE WITH 1 1/2"	147/RS/57-61
MON104*	2178765.13	5820754.68	182.78	POSITION AS "37-51" FOUND 2" IP WITH TAG STAMPED "LS3485"	166 PM 000.0 SHT 23 148/RS/1-2					DIAMETER BRASS CAP STAMPED "LS 3480" AND CENTER PUNCHED. THE STATION IS IN A STANDARD	, , , , , , , , , , , , , , , , , , ,
MON105*	2179404.40	5815192.48	167.56	FOUND 3/4" IP, OPEN, "36-33"	140/RS/30, CalTrans ROW Map SB 166 PM 004.8 and Tentative Monumentation Map SB 166 PM 000.0 SHT 18					12" DIAMETER, CAST IRON MONUMENT WILL FLUSH WITH THE ASPHALT ROAD SURFACE AT THE INTERSECTION OF HANSON WAY AND STOWELL ROAD.	
ION106*	2179418.82	5814994.36	168.44	FOUND 1" IP WITH PLASTIC PLUG STAMPED "CAL DOT" AT PM 4.64	Caltrans Control	MON1135*	2191514.48	5824159.91	192.50	THE STATION IS A 3 1/2" BRASS DISC SET IN THE TOP OF A TRIPLE CONCRETE RIVER INLET STRUCTURE ON THE SOUTHERLY SANTA MARIA RIVER LEVEE,	147/RS/57-61
ON107*		5814883.40		FOUND 3/4" IP WITH TAG, STAMPED "RE 2928" LOCATED AT SAME POSITION AS "36-29"	CalTrans ROW Map SB 166 PM 004.8 and Tentative Monumentation Map SB 166 PM 000.0 SHT 18					APPROX. 2900 WESTERLY OF THE NORTHERLY PROLONGATION OF BLOSSER ROAD AT LEVEE STATION 619+65. THE STATION IS A UNITED STATES ARMY	
	NO NWOHS NO NA PLAN	TITLE SHEET NS	SITE PLAN							CORPS OF ENGINEERS BRASS DISC STAMPED "2 SM-107 1971 LA DIST."	

SURVEYOR'S NOTES:

Horizontal positions of control points CP1 derived from static observation holding Santa Maria Valley Control Survey Stations 1003 and 1135 fixed to the coordinates shown on Record of Survey book 147 pages 57 through 61 based on California Coordinate System 1983 (CCS83) 1991.35 epoch.

Elevations of control points CP1 derived by static GPS observation and converted to the North American Vertical Datum 1988 (NAVD88) using the National Geodetic Survey's program GEOID99 holding Santa Maria Valley Control Survey Stations 1003 and 1135 fixed to the elevations shown on Record of Survey book 147 pages 57 through 61.

Horizontal Positions and Vertical Elevations for Control Points CP2, CP3, CP4, CP5, CP6, CP7, CP8, CP9 derived from FastStatic observation holding CP1, MON1003, and MON1135.

CP1003 N: 2179264.680USF E: 5815749.460USF Z: 171.400USF CP1135 N: 2191514.480USF E: 5824159.910USF Z: 192.500USF

All coordinate values shown are grid values. All distances are based on the U.S. Survey Foot. (one survey foot = 1200/3937 meters).

CONTOUR INTERVAL:

The contour interval is shown at 1 foot intervals with majors at every 5 feet

BASIS OF BEARINGS:

The Basis of Bearings was calculated in the project S458 Santa Maria Levee Flap Gate Modification and it is between Santa Maria Valley Control Survey Stations 1003 and 1135 as shown on Record of Survey book 147 pages 57 through 61, calculated as N 34°28'22" E, 14859.11' and measured as N 34°28'22" E, 14859.13'.


GROUND TO GRID FACTORS:


Convergence Factor: -01°19'48.81630" Scale Factor: 1.003935005 Combined Factor: 1.003933635 Factors Calculated for: CP1

BOUNDARY NOTE:

Parcel boundary calculated per RS 86/33, Subdivision Map BK 9/37, Grant Deeds: inst.1972—38193 O.R.bk2423pg0432, inst.1972—38194 O.R.bk2423pg0437, inst.173—48648 O.R.bk2494pg1236; fit to CP6 & MON112 for graphical purposes only. Right—Of—Way boundary for West Main St. calculated Per

CALTRANS Tentative Monumentation Map S.B. 166 Post Mile 0.0 to 6.87; fit to MON108 & MON100 for graphical purposes only.

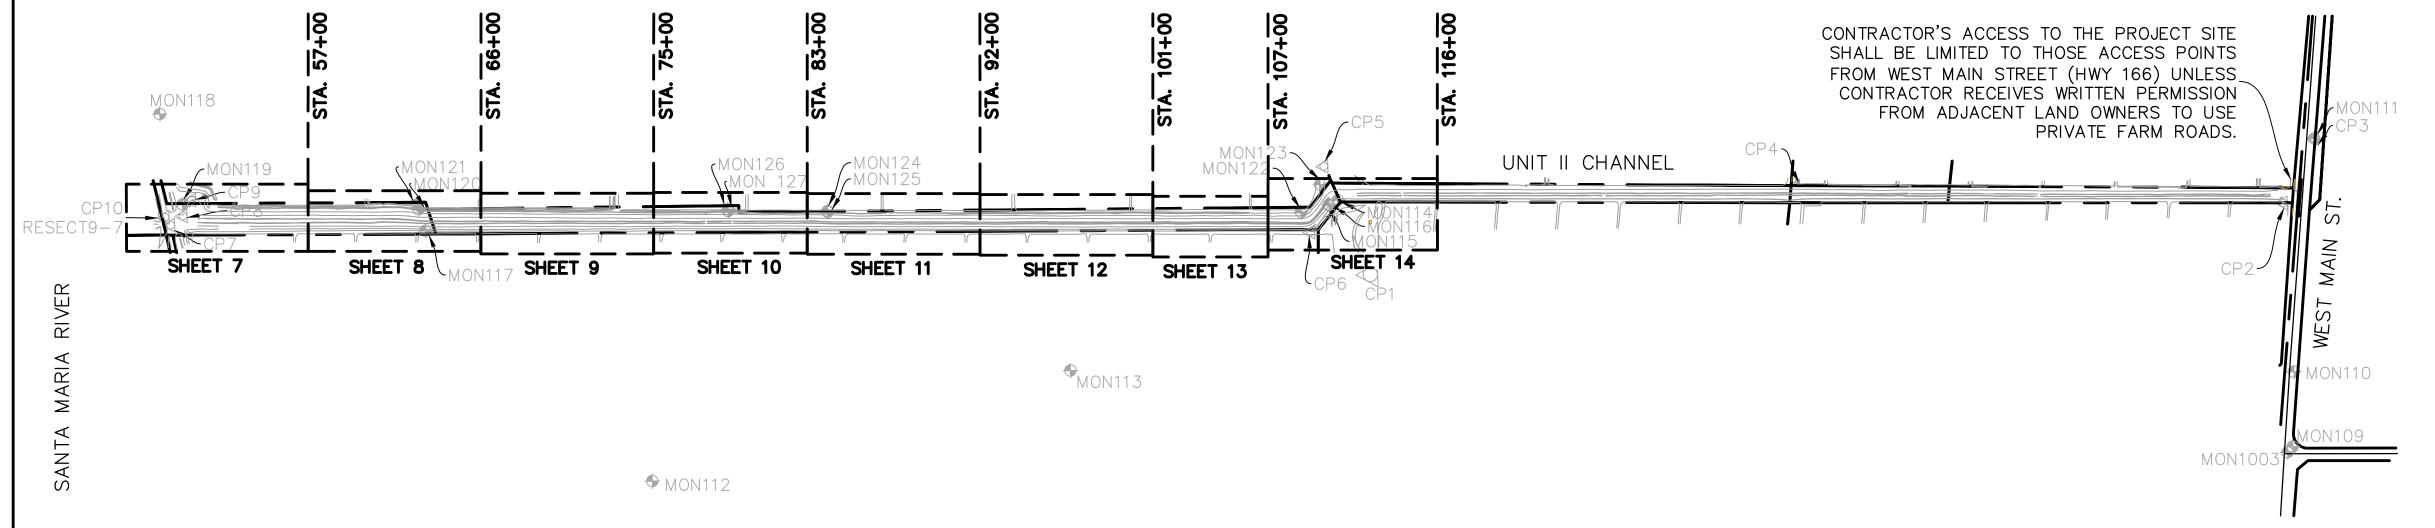

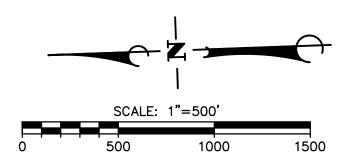



Filename: 20643.01 Title Sheets.dwg

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	REVISIONS		
NO.	DESCRIPTION	DATE	APR

DESIGNED BY:	
DESIGN ENGINEER	DATE



SANTA BARBARA COUNTY
FLOOD CONTROL AND
WATER CONSERVATION DISTRICT
130 E. VICTORIA STREET
SANTA BARBARA, CA 93101
(805) 568-3440



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AREA OF SANTA MARIA SANTA BARBARA COUNTY, CALIFORNIA

SURVEY	NOTES
& SHEET	INDEX

ΓES	DESIGNED BY: ALG					
EX	DRAWN BY:					
	UWP		_			
	CHECKED BY:	SHEET	2	OF	26	

SYMBOL LEGEND - BOUNDARY EASEMENT LINE EXISTING WATER LINE EXISTING FIBER OPTIC CABLE EXISTING MAJOR CONTOUR EXISTING MINOR CONTOUR EXISTING OVERHEAD WIRES EXISTING ROCK SLOPE PROTECTION _____ - SD - - - SD - -EXISTING STORM DRAIN EXISTING STRUCTURE CONCRETE EXISTING STRUCTURAL FOUNDATION EXISTING WATER LINE EXISTING WOOD FENCE EXISTING FLOW LINE EXISTING PROPERTY LINE PROPOSED PROPERTY LINE PROPOSED MAJOR CONTOUR PROPOSED MINOR CONTOUR PROPOSED SAWCUT PROPOSED STORM DRAIN TEMPORARY CONSTRUCTION EASEMENT (TCE) CONTROL POINT EXISTING BOLLARD EXISTING MONUMENT EXISTING SIGNAGE EXISTING UTILITY ELECTRIC BOX EXISTING UTILITY ELECTRIC GUY WIRE EXISTING UTILITY POWER POLE EXISTING UTILITY TELEPHONE POLE EXISTING UTILITY WATER AIR VACUUM VALVE EXISTING UTILITY WATER VALVE GEOTECHNICAL BORING APPROXIMATE LOCATION COUNTY OF SANTA BARBARA AIR POLLUTION CONTROL DISTRICT DUST CONTROL REQUIREMENTS 1. DURING CLEARING, GRUBBING, GRADING, EARTH MOVING OR EXCAVATION:

PREVENT DUST RAISED FROM LEAVING THE SITE. B. THE ENTIRE AREA OF DISTURBED SOIL SHALL BE WET DOWN, SUFFICIENT TO CREATE A CRUST, AFTER EACH DAY'S ACTIVITIES CEASE.

A. WATER TRUCKS OR SPRINKLER SYSTEMS SHALL BE USED IN SUFFICIENT QUANTITIES TO

2. AFTER CLEARING, GRADING, EARTH MOVING OR EXCAVATION IS COMPLETED: A. THE ENTIRE AREA OF DISTURBED SOIL SHALL BE TREATED TO PREVENT WIND PICK UP

OF SOIL. THIS MAY BE ACCOMPLISHED BY: SEEDING AND WATERING UNTIL GRASS COVER IS ESTABLISHED.

SPREADING SOIL BINDERS.

iii. WETTING THE AREA DOWN, SUFFICIENT TO FORM A CRUST ON THE SURFACE WITH REPEATED SOAKINGS AS NECESSARY TO MAINTAIN THE CRUST AND PREVENT DUST PICK UP BY THE WIND.

OTHER METHODS APPROVED IN ADVANCE BY THE AIR POLLUTION CONTROL DISTRICT.

DURING CONSTRUCTION:

A. WATER TRUCKS OR SPRINKLER SYSTEMS SHALL BE USED TO KEEP ALL AREAS OF VEHICLE MOVEMENT DAMP ENOUGH TO PREVENT DUST RAISED FROM LEAVING THE SITE. AS A MINIMUM, THIS WILL INCLUDE WETTING DOWN SUCH AREAS IN THE LATE MORNING AFTER WORK IS COMPLETED FOR THE DAY.

B. INCREASED WATERING FREQUENCY WILL BE REQUIRED WHENEVER THE WIND SPEED EXCEEDS 15 MPH.

4. ACTIVATION OF INCREASED DUST CONTROL MEASURES:

A. THE CONTRACTOR SHALL DESIGNATE A PERSON OR PERSONS TO MONITOR THE DUST CONTROL PROGRAM AND TO ORDER INCREASED WATERING, AS NECESSARY, TO PREVENT TRANSPORT OF DUST OFF SITE. THEIR DUTIES SHALL INCLUDE HOLIDAY AND WEEKEND PERIODS WHEN WORK MAY NOT BE IN PROGRESS. THE NAME AND TELEPHONE NUMBER OF SUCH PERSONS SHALL BE PROVIDED TO THE AIR POLLUTION CONTROL DISTRICT PRIOR TO ISSUANCE OF THE COASTAL DEVELOPMENT PERMIT.

TRUCKS HAULING GRADING MATERIALS SHALL BE COVERED.

SOIL STOCKPILED FOR MORE THAN TWO (2) DAYS SHALL BE COVERED, KEPT MOIST, OR TREATED WITH SOIL BINDERS TO PREVENT DUST GENERATION.

ABBREVIATION LEGEND

AGGREGATE BASE APN ASSESSORS PARCEL NUMBER BEGINNING **CCWA** CENTRAL COAST WATER AUTHORITY CUBIC FEET PER SECOND CENTER LINE **CLR** CLEARANCE CORRUGATED METAL PIPE CONTROL POINT DIAMETER ELECTRICAL BOX **ELEVATION** ELECTRICAL METER EXISTING FLOW LINE FEET

FIBER OPTIC CABLE GUY WIRE ELECTRIC INCH INV INVERT HIGH DENSITY POLYETHYLENE

HYDRAULIC GRADE LINE METER BOX MB MONUMENT POINT OF INTERSECTION PROPERTY LINE

POWER POLE PROPOSED POLYVINYL CHLORIDE DESIGN FLOW RATE REINFORCED CONCRETE PIPE RIGHT OF WAY ROW SLOPE

SD STORM DRAIN STORM DRAIN MANHOLE STA STATION

TEMPORARY CONSTRUCTION EASEMENT TELEPHONE POLE WATER WATER VALVE

TEMPORARY CONSTRUCTION LIMIT

GEOTECHNICAL BORING LOG NOTES

SOIL BORING INFORMATION WAS DERIVED FROM SEVERAL GEOTECHNICAL REPORTS AND ARE PROVIDED FOR GENERAL INFORMATION. LOCATION OF THE BORINGS WERE ESTIMATED FROM THE GEOTECHNICAL REPORT AND ARE APPROXIMATE. PLEASE REFER TO ORIGINAL REPORTS FOR COMPLETE SOIL BORING INFORMATION.

BORINGS: DH-113, DH-120 TO DH-129, CB-4672P. CPT-1. CPT-2 REPORT BY: FUGRO WEST INC. REPORT DATE: APRIL 1995 PROJECT #: 95-92-7111 PREPARED FOR: MONTGOMERY WATSON

BORINGS: B-7, B-101, B-102 REPORT BY: FUGRO WEST INC. REPORT DATE: APRIL 2003 PROJECT #: 3190.009 PREPARED FOR: SANTA BARBARA COUNTY FLOOD CONTROL DISTRICT

BORINGS: DH-01 TO DH-04 REPORT BY: FUGRO WEST INC. REPORT DATE: APRIL 2013-DRAFT PROJECT #: 04.6213.0006 PREPARED FOR: PENFIELD & SMITH ENGINEERS

SOIL TYPE ABBREVIATIONS AND SYMBOLOGY

SYMBOL	ABBREVIATION	DESCRIPTION
N/A	af	ARTIFICIAL FILL
N/A	Qal	ALLUVIUM
	CL	SILTY CLAY SANDY LEAN CLAY LEAN CLAY
	ML	CLAYEY SILT FINE SANDY SILT
	SC	CLAYEY SAND
	SM	SILTY FINE SAND SILTY SAND
	SP	FINE SAND MEDIUM SAND POORLY GRADED SAND
	SP/SW	SAND WITH GRAVEL
	SP-SC	SAND WITH CLAY
	SP-SM	POORLY GRADED SAND WITH SILT

PROPOSED CHANNEL CENTERLINE / LAYOUT LINE GEOMETRIC DATA

	LINE TABLE							
LINE	BEARING	DISTANCE						
L1	S11°37'10"E	153.45'						
L2	S11°24'01"E	34.54'						
L3	S14°57'14"E	12.02'						
L4	S1°24'24"W	126.97'						
L5	S4°14'47"W	73.03'						
L6	S2°05'52"W	882.80'						
L7	S5°27'12"W	222.00'						
L8	S2°05'51"W	2060.11						
L9	S4°31'42"W	117.89'						
L10	S2°05'51"W	2245.27						

CURVE TABLE						
CURVE	DELTA	RADIUS	LENGTH			
C1	22°46'38"	1000.00'	397.54			
C2	22°46'41"	1000.00'	397.55			

REFERENCED STANDARD PLANS

- 2010 CALTRANS STANDARD PLAN-REVISED STANDARD PLAN RSP A77P1: MIDWEST GUARDRAIL SYSTEM TYPICAL LAYOUT FOR EMBANKMENTS. METAL GUARD RAILING RECONSTRUCTION INSTALLATION.
- 2. 2010 CALTRANS STANDARD PLAN D97A: CORRUGATED METAL PIPE COUPLING DETAILS No. 1 ANNULAR COUPLING BAND BAR AND STRAP AND ANGULAR CONNECTIONS.
- 3. APWA STANDARD PLAN 380-4: CONCRETE COLLAR FOR RCB 12" THROUGH 72". PLAN 308-2: MONOLITHIC CATCH BASIN CONNECTION, USED FOR JOINING THE 72" RCP TO THE HEADWALLS AT THE LEVEE OUTFALL.
- 4. SANTA BARBARA COUNTY STANDARD DETAIL 2-020; PIPE BEDDING DETAILS

EARTHWORK AND BACKFILL NOTES

- ONCE TRENCH EXCAVATION HAS BEEN COMPLETED TO THE SPECIFIED DEPTHS AND THE TRENCH IS DEWATERED (IF REQUIRED) TO AT LEAST THE TRENCH BOTTOM, THE TRENCH BOTTOM SHALL BE MOISTURE CONDITIONED TO AT OR NEAR OPTIMUM AND COMPACTED TO AT LEAST NINETY PERCENT OF THE MAXIMUM ASTM D1557 DENSITY.
- APPROVED BEDDING SHALL BE PLACED AND COMPACTED TO A THICKNESS OF NOT LESS THAN SIX (6) INCHES. NO PIPE AND/OR BACKFILL SHALL BE PLACED UNLESS THE TRENCH HAS A FIRM, UNYIELDING BOTTOM.
- WHERE UNSTABLE. SPONGY OR OTHERWISE UNSUITABLE SOILS ARE ENCOUNTERED. THEY SHALL BE REMOVED TO FIRM SOILS AND REPLACED WITH COMPACTED BEDDING MATERIAL. IF UNSTABLE SOILS ARE SUCH THAT REMOVING TO FIRM SOILS IS NOT REASONABLE, THE FOLLOWING ALTERNATIVES WILL BE CONSIDERED BY THE ENGINEER:
 - A. PLACE ONE (1) FOOT OF CRUSHED ROCK IN SIX (6) INCH LAYERS ADEQUATELY PACKED ON THE EXCAVATION BOTTOM. GRANULOMETRY OF THE ROCK SHOULD INCLUDE NOT MORE THAN FIVE (5) PERCENT BY WEIGHT PASSING THE NO. 200 SIEVE.
 - B. PLACE A LAYER OF GEOTEXTILE FABRIC ON TOP OF THE ROCK LAYER AND EXTEND IT UPWARD ALONG THE TRENCH SIDES FOR A MINIMUM OF ONE (1) FOOT. THE GEOTEXTILE WILL SERVE AS A SEPARATOR BETWEEN THE ROCK AND BEDDING AND MAY BE EITHER A WOVEN OR NON-WOVEN FABRIC.
- C. APPLY A LAYER OF BEDDING OVER THE GEOTEXTILE FABRIC. THERE SHOULD BE A THICKNESS OF AT LEAST SIX (6) INCHES OF BEDDING MATERIAL UNDER THE BOTTOM OF THE PIPE.
- D. OVEREXCAVATE TO FOUR (4) FEET BELOW THE BOTTOM OF THE PROPOSED PIPE. PLACE A LAYER OF TENSAR SS-2 GEOGRID ON THE EXCAVATION BOTTOM AND TO TWO (2) FEET UP ON THE TRENCH SIDES. COARSE BEDDING MATERIAL SHALL THEN BE PLACED ON TOP OF THE GEOGRID IN A SINGLE TWO-FOOT (2') THICK LAYER. THE ROCK SHALL BE COMPACTED TO NINETY (90) PERCENT MAXIMUM DRY DENSITY OR GREATER. PLACE A SECOND LAYER OF TENSAR SS-2 GEOGRID ON THE COMPACTED ROCK LAYER AND EXTENDING TWO (2) FEET UP THE TRENCH SIDES. COARSE BEDDING MATERIAL SHALL BE PLACED ON THE GEOGRID IN A MINIMUM OF TWO (2) LIFTS, EACH LIFT BEING COMPACTED TO NINETY (90) PERCENT RELATIVE COMPACTION. FILTER FABRIC AND BEDDING SHALL THEN BE PLACED ON THE COMPACTED ROCK AS DIRECTED BY THE ENGINEER.
- PLACE FILL SOIL IN LIFTS WITH A LOOSE THICKNESS NOT GREATER THAN EIGHT (8) INCHES. MOISTURE CONDITION THE SOIL TO NEAR OPTIMUM AND COMPACT TO AT LEAST NINETY (90) PERCENT OF THE MAXIMUM ASTM D1557 DENSITY. FOR PAVED AREAS COMPACT TO AT LEAST NINETY-FIVE (95) PERCENT OF THE MAXIMUM ASTM D1557 DENSITY FOR THE TOP 3-FEET BELOW PAVEMENT FINISHED SURFACE.
- 5. FOR TRENCHES OUTSIDE PUBLIC RIGHT-OF-WAY, EXCAVATED ON-SITE CUT SOILS MAY BE USED FOR TRENCH BACKFILL WHEN CLEANED OF ROCK PIECES LARGER THAN THREE (3) INCHES IN MAXIMUM DIMENSION, PLACED IN LOOSE LIFTS WITH A THICKNESS NOT GREATER THAN EIGHT (8) INCHES AND MECHANICALLY COMPACTED. A COMMERCIAL QUALITY GRANULAR IMPORT SOIL MAY BE USED FOR FILL. SEE SPECIFICATIONS.
- 6. A SHRINKAGE FACTOR DUE TO COMPACTION IS EXPECTED. LOSS DUE TO REMOVAL OF NONCOMPLYING FILL, STRIPPING AND RECOMPACTION OPERATIONS MAY AFFECT QUANTITY CALCULATIONS AND SHOULD BE TAKEN INTO ACCOUNT.
- 7. FINAL SITE GRADE SHALL BE SUCH THAT ALL WATER IS DIVERTED AWAY FROM AND IS NOT ALLOWED TO POND ON OR NEAR PAVEMENT SECTIONS.
- CONTRACTOR SHALL PROVIDE DETAILS OR PLANS FOR CONFINED SPACES ENTRY, TRENCH SHORING, TRAFFIC CONTROL, AND STORM WATER POLLUTION PREVENTION.





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REVISIONS				
NO.	DESCRIPTION	DATE	APR	

Phone: (805) 963-9532

Penfield & Smith ngineering • Surveying • Planning Construction Management •

Fax: (805) 966-9801

111 East Victoria Street, Santa Barbara, CA 93101

SANTA BARBARA COUNTY FLOOD CONTROL AND WATER CONSERVATION DISTRICT 130 E. VICTORIA STREET SANTA BARBARA, CA 93101 (805) 568-3440


Market A

UNIT II CHANNEL DRAINAGE IMPROVEMENTS PROJECT

AREA OF SANTA MARIA SANTA BARBARA COUNTY, CALIFORNIA LEGEND & NOTES

DESIGNED BY:					
ALG					
DRAWN BY:					
OWP					
0111	011557	_	^ _		
CHECKED BY:	SHEET	3	OF	26	

Filename: 20643.01 Title Sheets.dwg

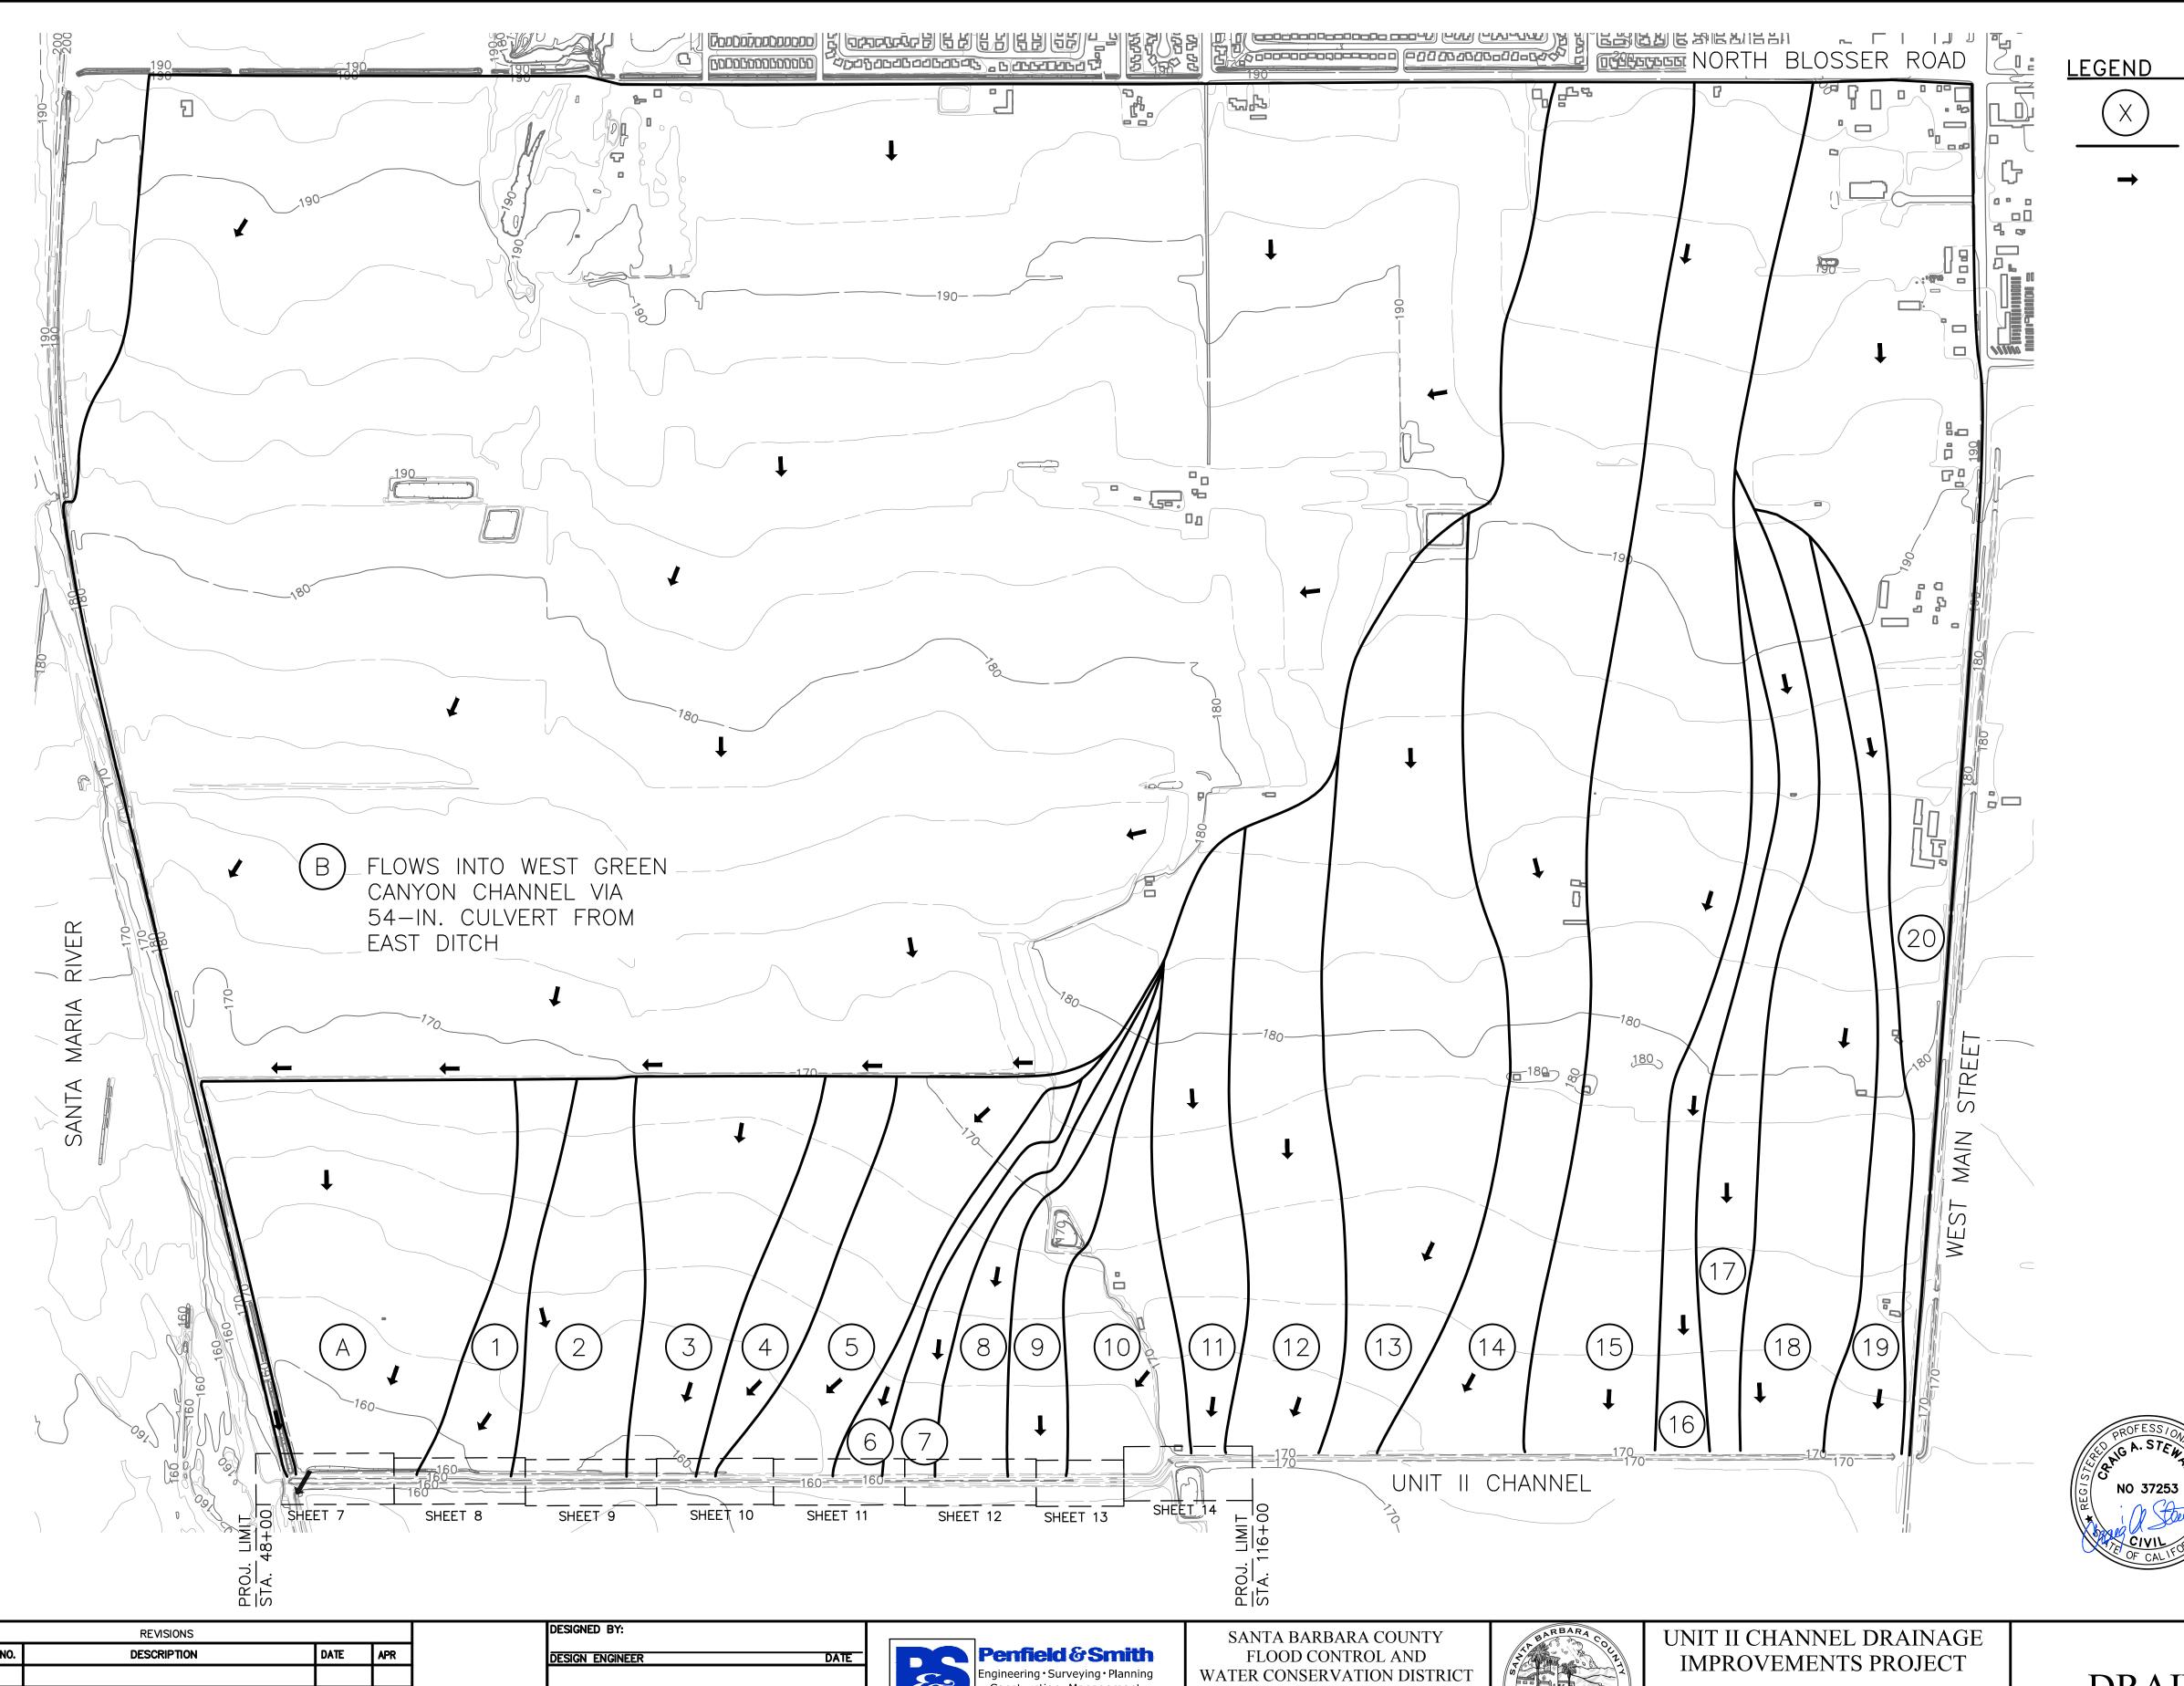


DRAINAGE AREA LABEL DRAINAGE AREA BOUNDARY

FLOW DIRECTION

DRAINAGE AREA	AREA, AC	Qdes, CFS			
Α	101	21			
Does not enter Unit II					

Channel

DRAINAGE	AREA,	0400 CEC		
AREA	AC	Qdes, CFS		
В	1356	287		
1	23	5		
2	42	9		
3	52	11		
4	28	6		
5	48	10		
6	11	2		
7	15	3		
8	20	4		
9	22	5		
10	36	8		
11	45	15		
12	67	22		
13	127	42		
14	178	59		
15	173	58		
16	27	9		
17	45	15		
18	80	27		
19	36	12		
20	152	51		
TOTAL	2583	660		
Drains into Unit II Channel				

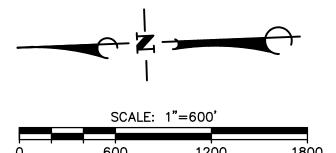

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NO.	DESCRIPTION	DATE	APR




Phone: (805) 963-9532 Fax: (805) 966-9801

130 E. VICTORIA STREET SANTA BARBARA, CA 93101 (805) 568-3440



AREA OF SANTA MARIA SANTA BARBARA COUNTY, CALIFORNIA DRAINAGE MAP

DESIGNED BY:						\neg
ALG						-
DRAWN BY:						(
OWP			_			\Box
CHECKED BY:	SHEE	<u> </u>	4	OF	26	
CAS	Filename:	206	43.01	Drainage	Map.dwg	

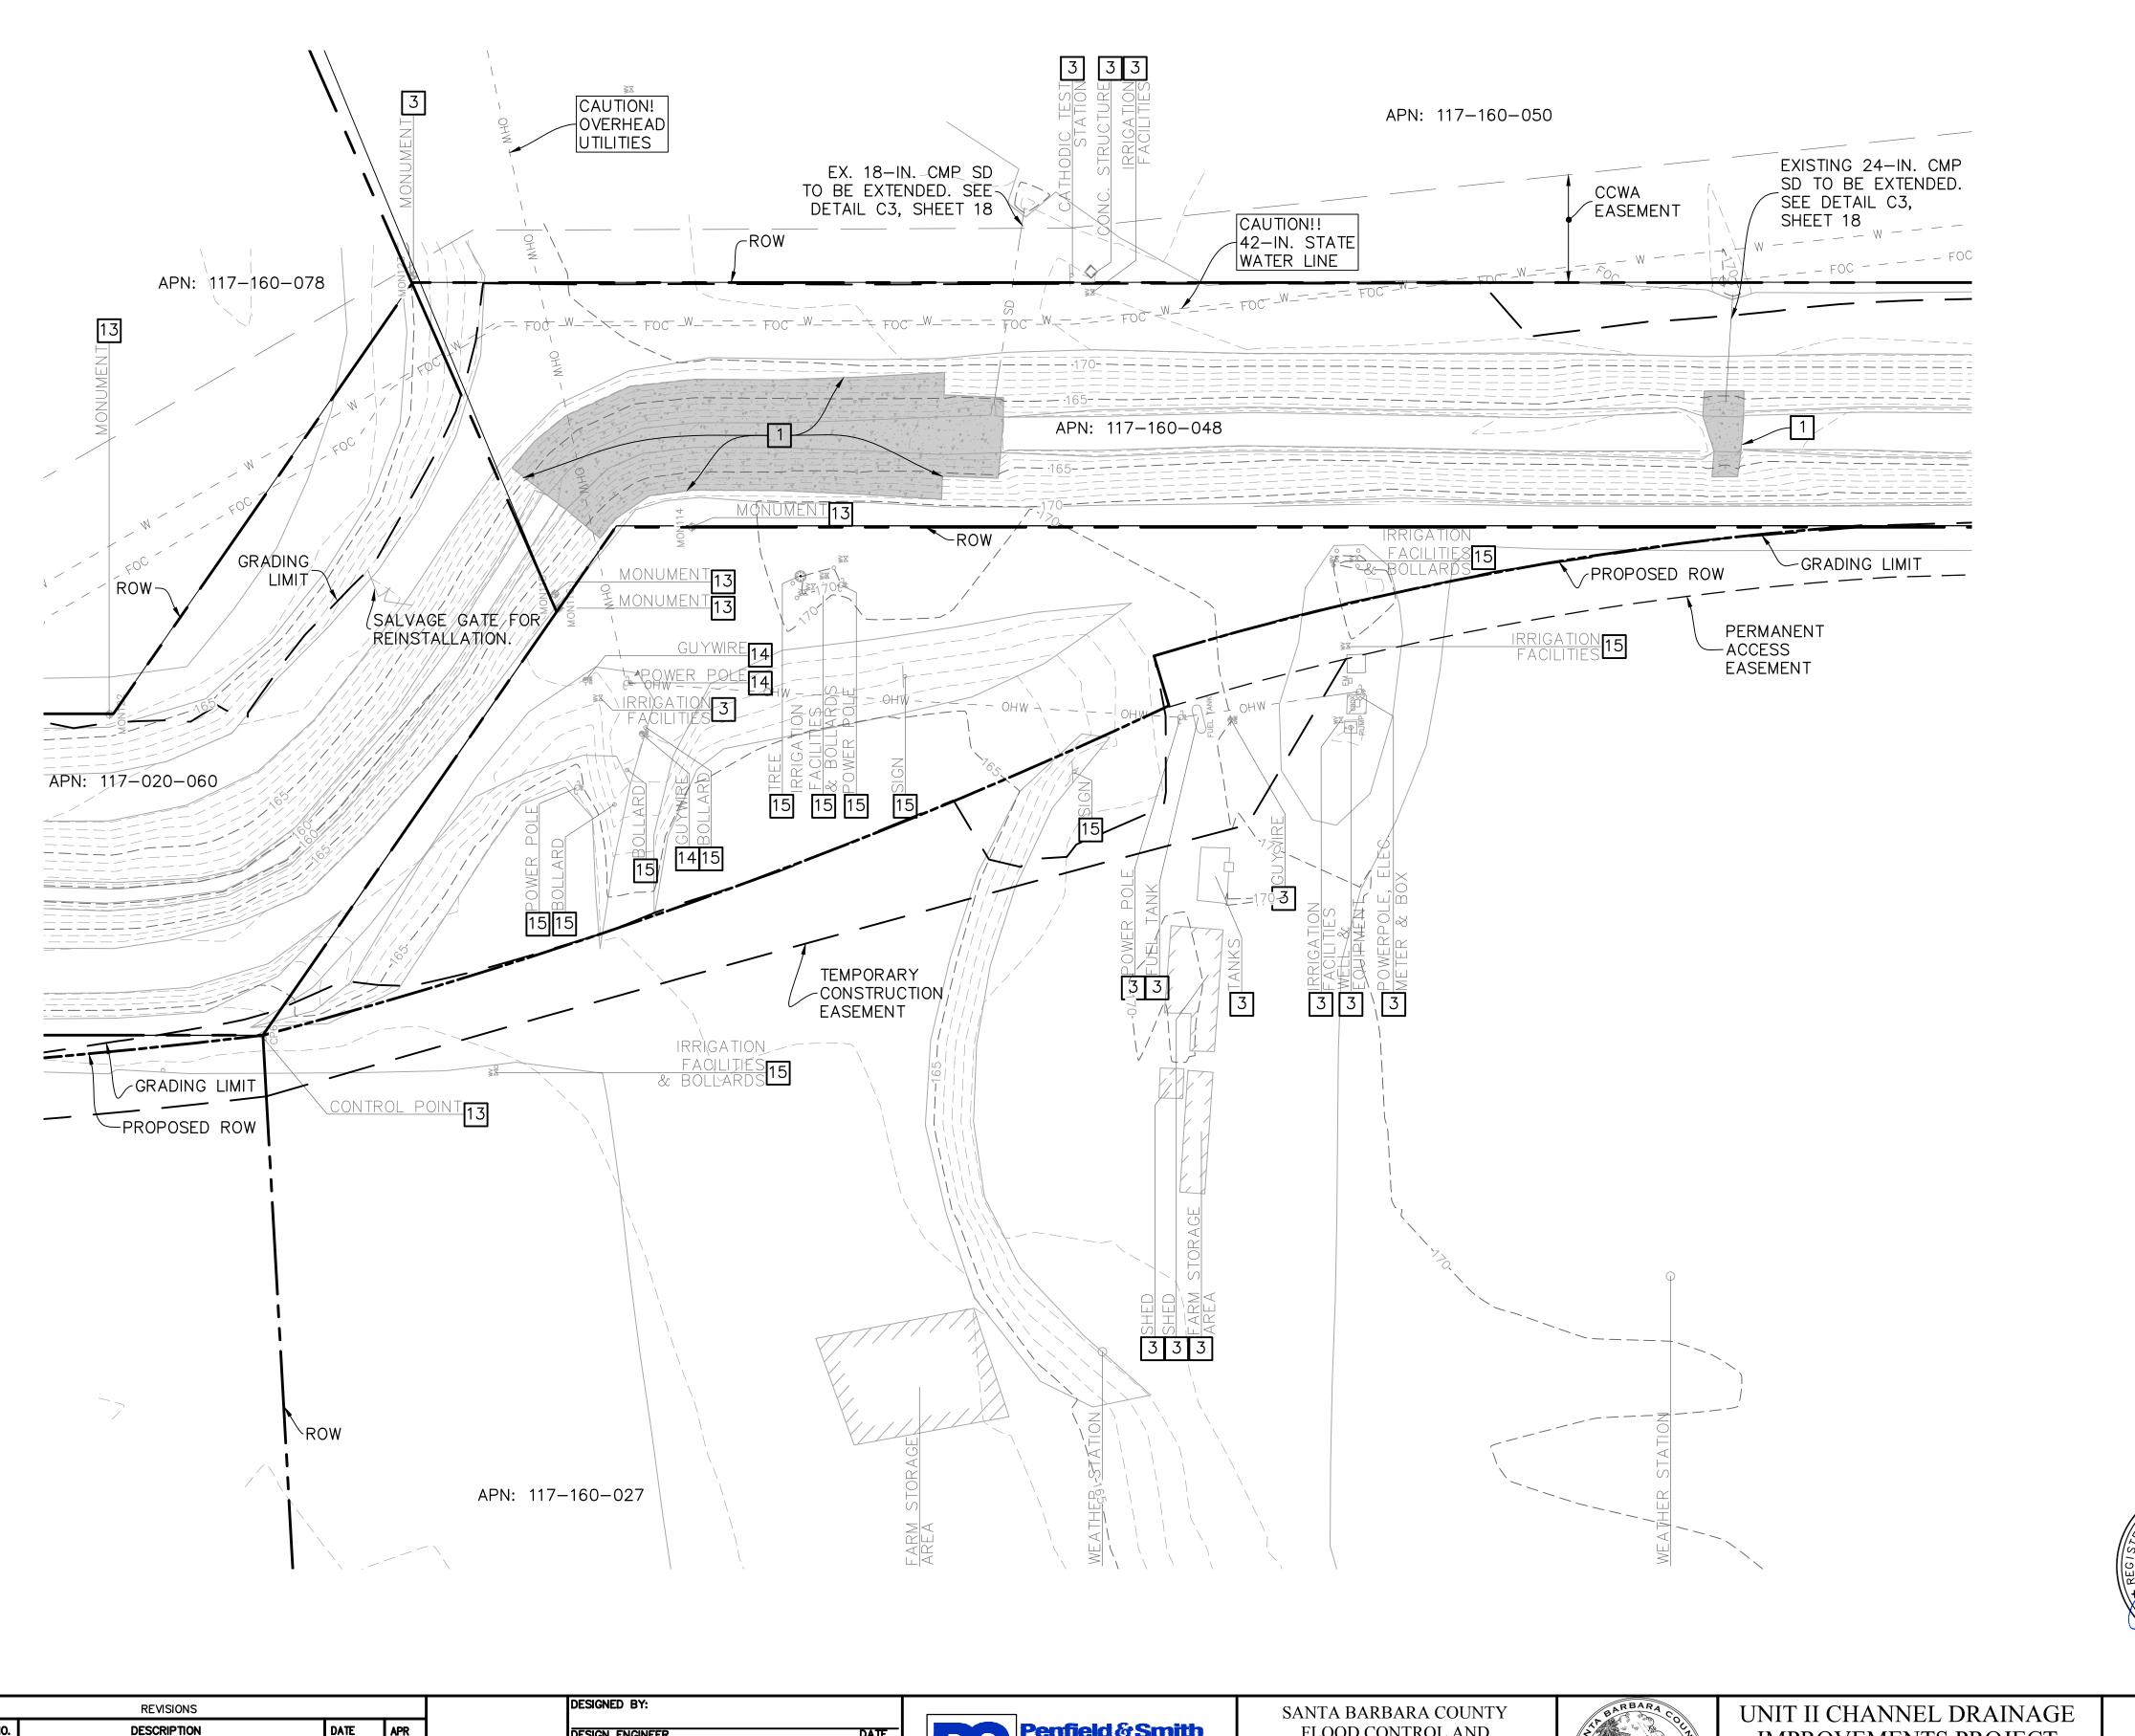

DEMOLITION NOTES


1 REMOVE, AND LEGALLY DISPOSE OF EXISTING REINFORCED CONCRETE CHANNEL LINING.

3 PROTECT EXISTING FACILITY.

13 CONTACT THE RESIDENT ENGINEER A MINIMUM OF 48 HOURS PRIOR TO CONSTRUCTION TO CONFIRM SURVEY MONUMENTS AND CONTROL POINTS ARE TIED-OUT.

14 TO BE RELOCATED BY PGE.

15 TO BE RELOCATED BY OTHERS.

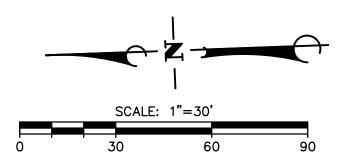

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NO.	DESCRIPTION	DATE APR		

SIGNED BT:	
SIGN ENGINEER DATE	
JON ENGINEER	
	6
	111 East Victoria



FLOOD CONTROL AND WATER CONSERVATION DISTRIC 130 E. VICTORIA STREET SANTA BARBARA, CA 93101 (805) 568-3440




IMPROVEMENTS PROJECT


AREA OF SANTA MARIA SANTA BARBARA COUNTY, CALIFORNIA


DEN	MOLITION PLAN
STA.	108+50 TO 115+00


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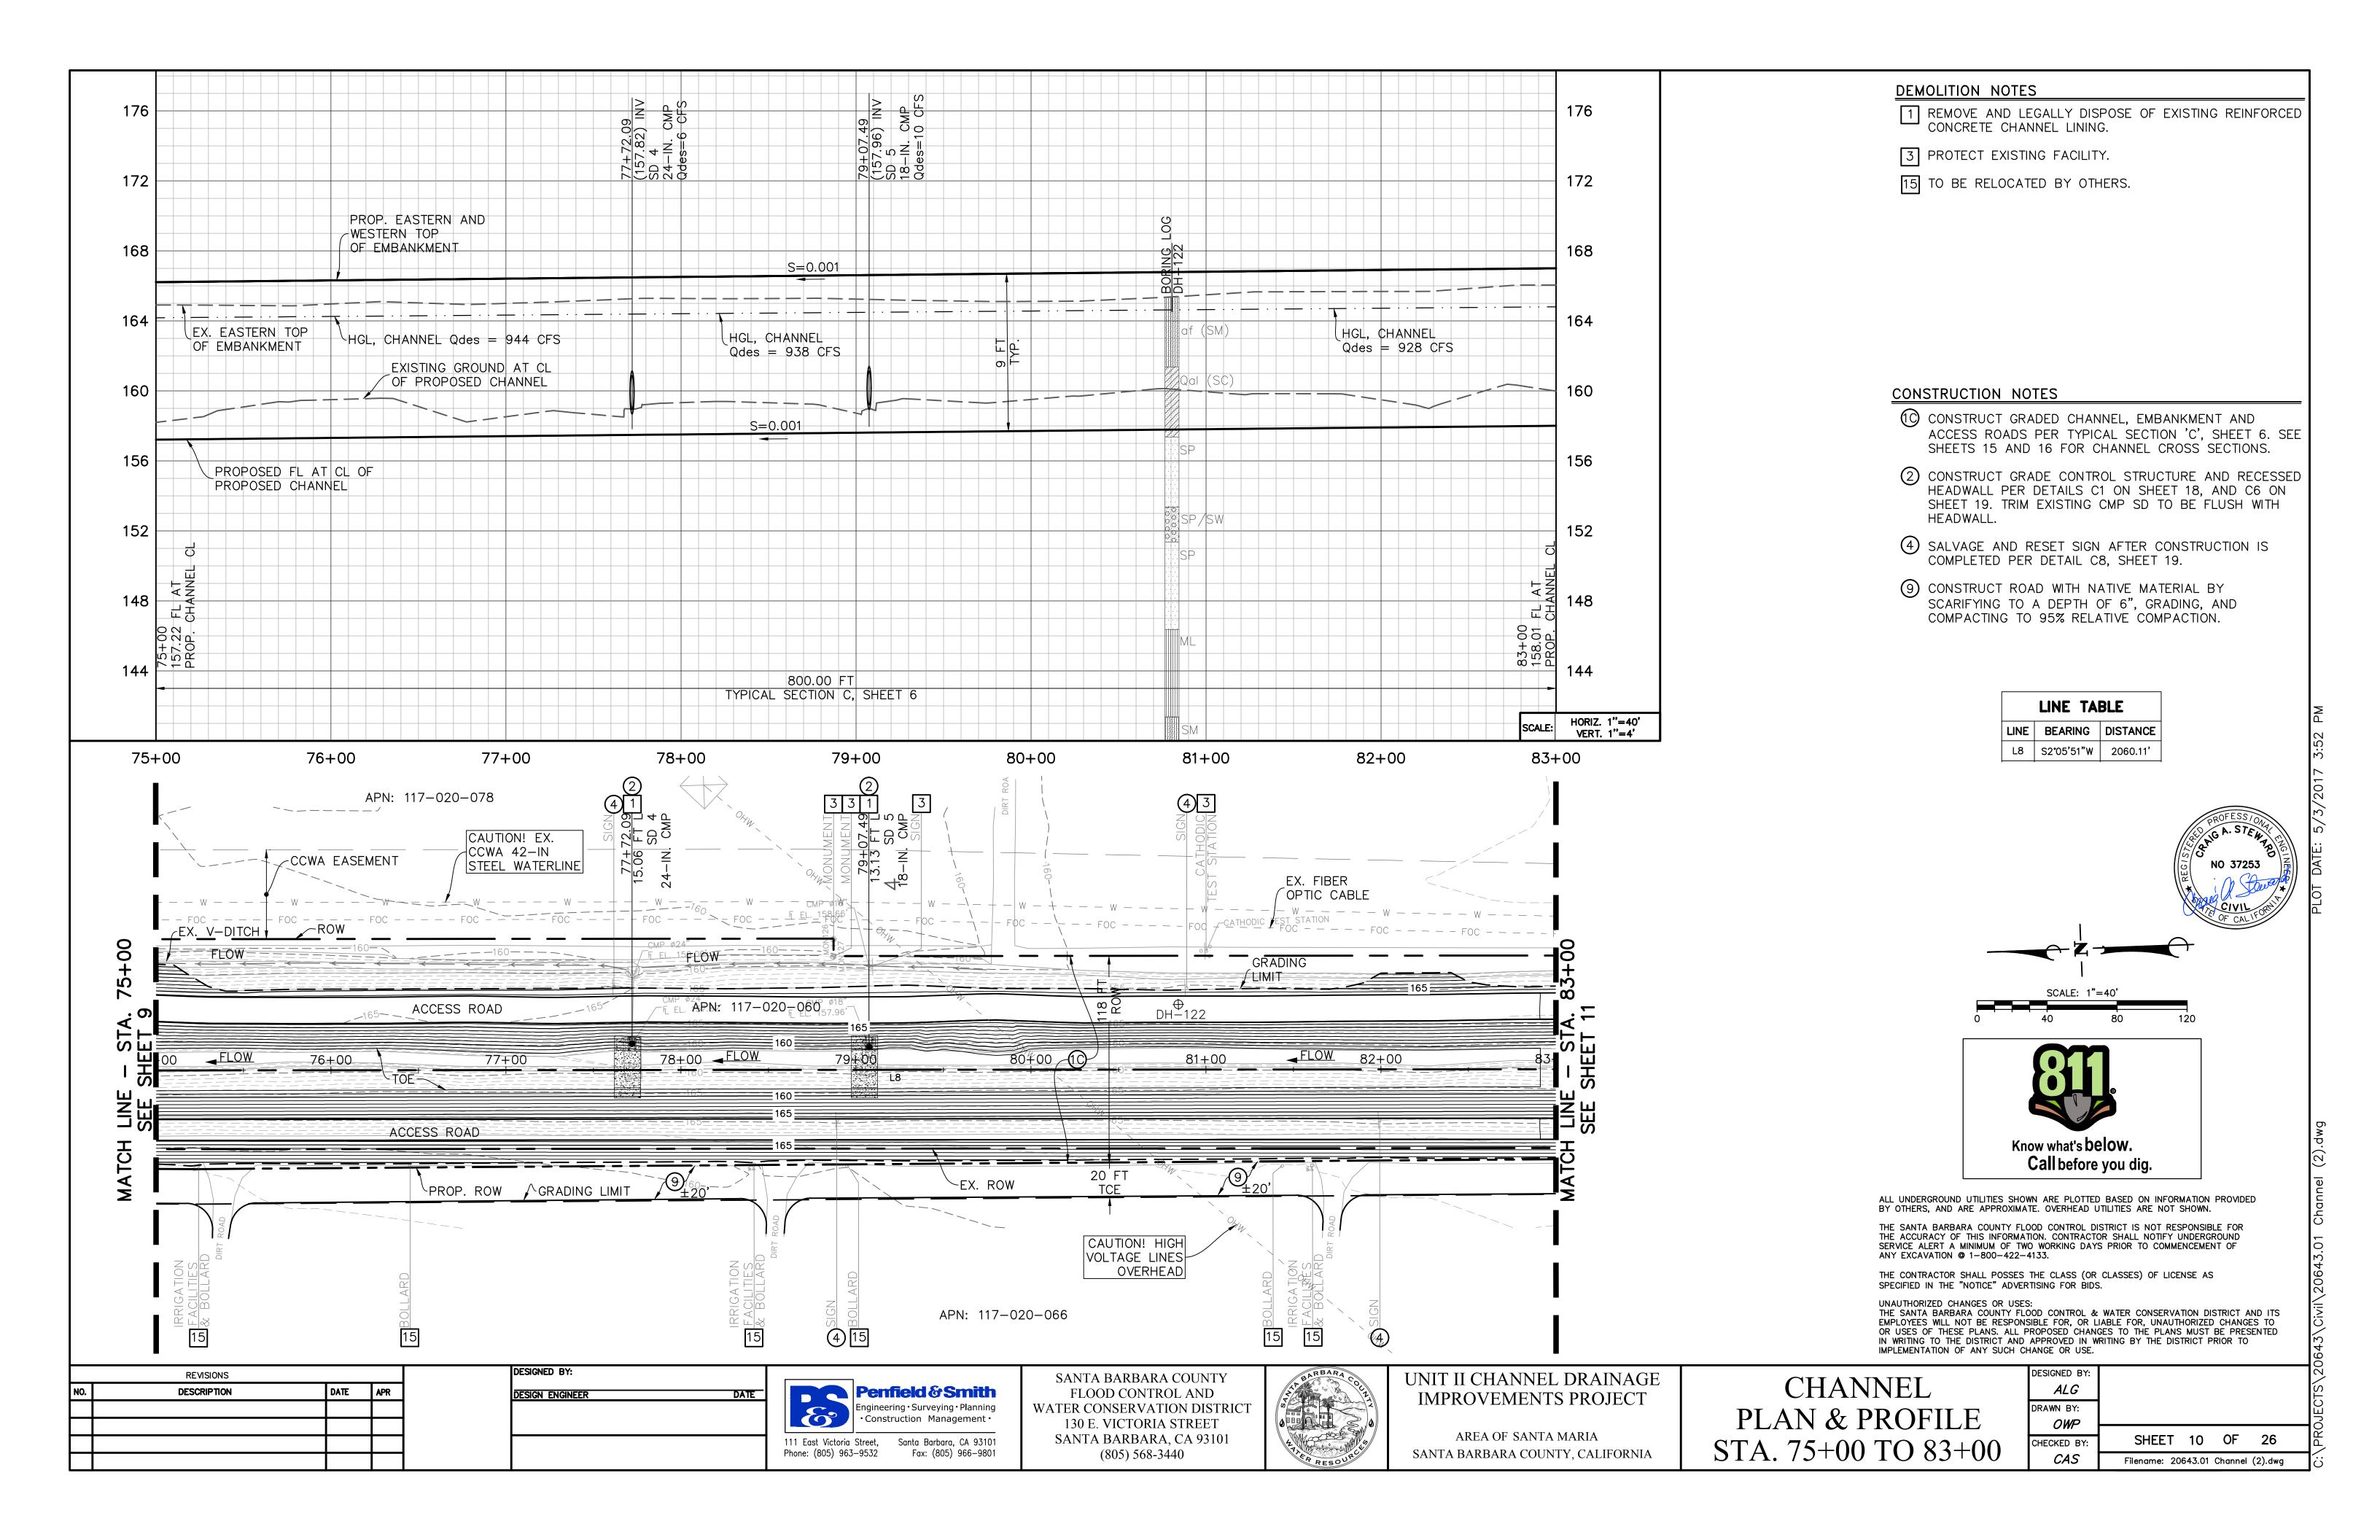
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1	DRAWN BY:		
•	CHECKED BY:	SHEET 5 OF 26	•
	CAS	Filename: 20643.01 Demolition Plans.dwg	•




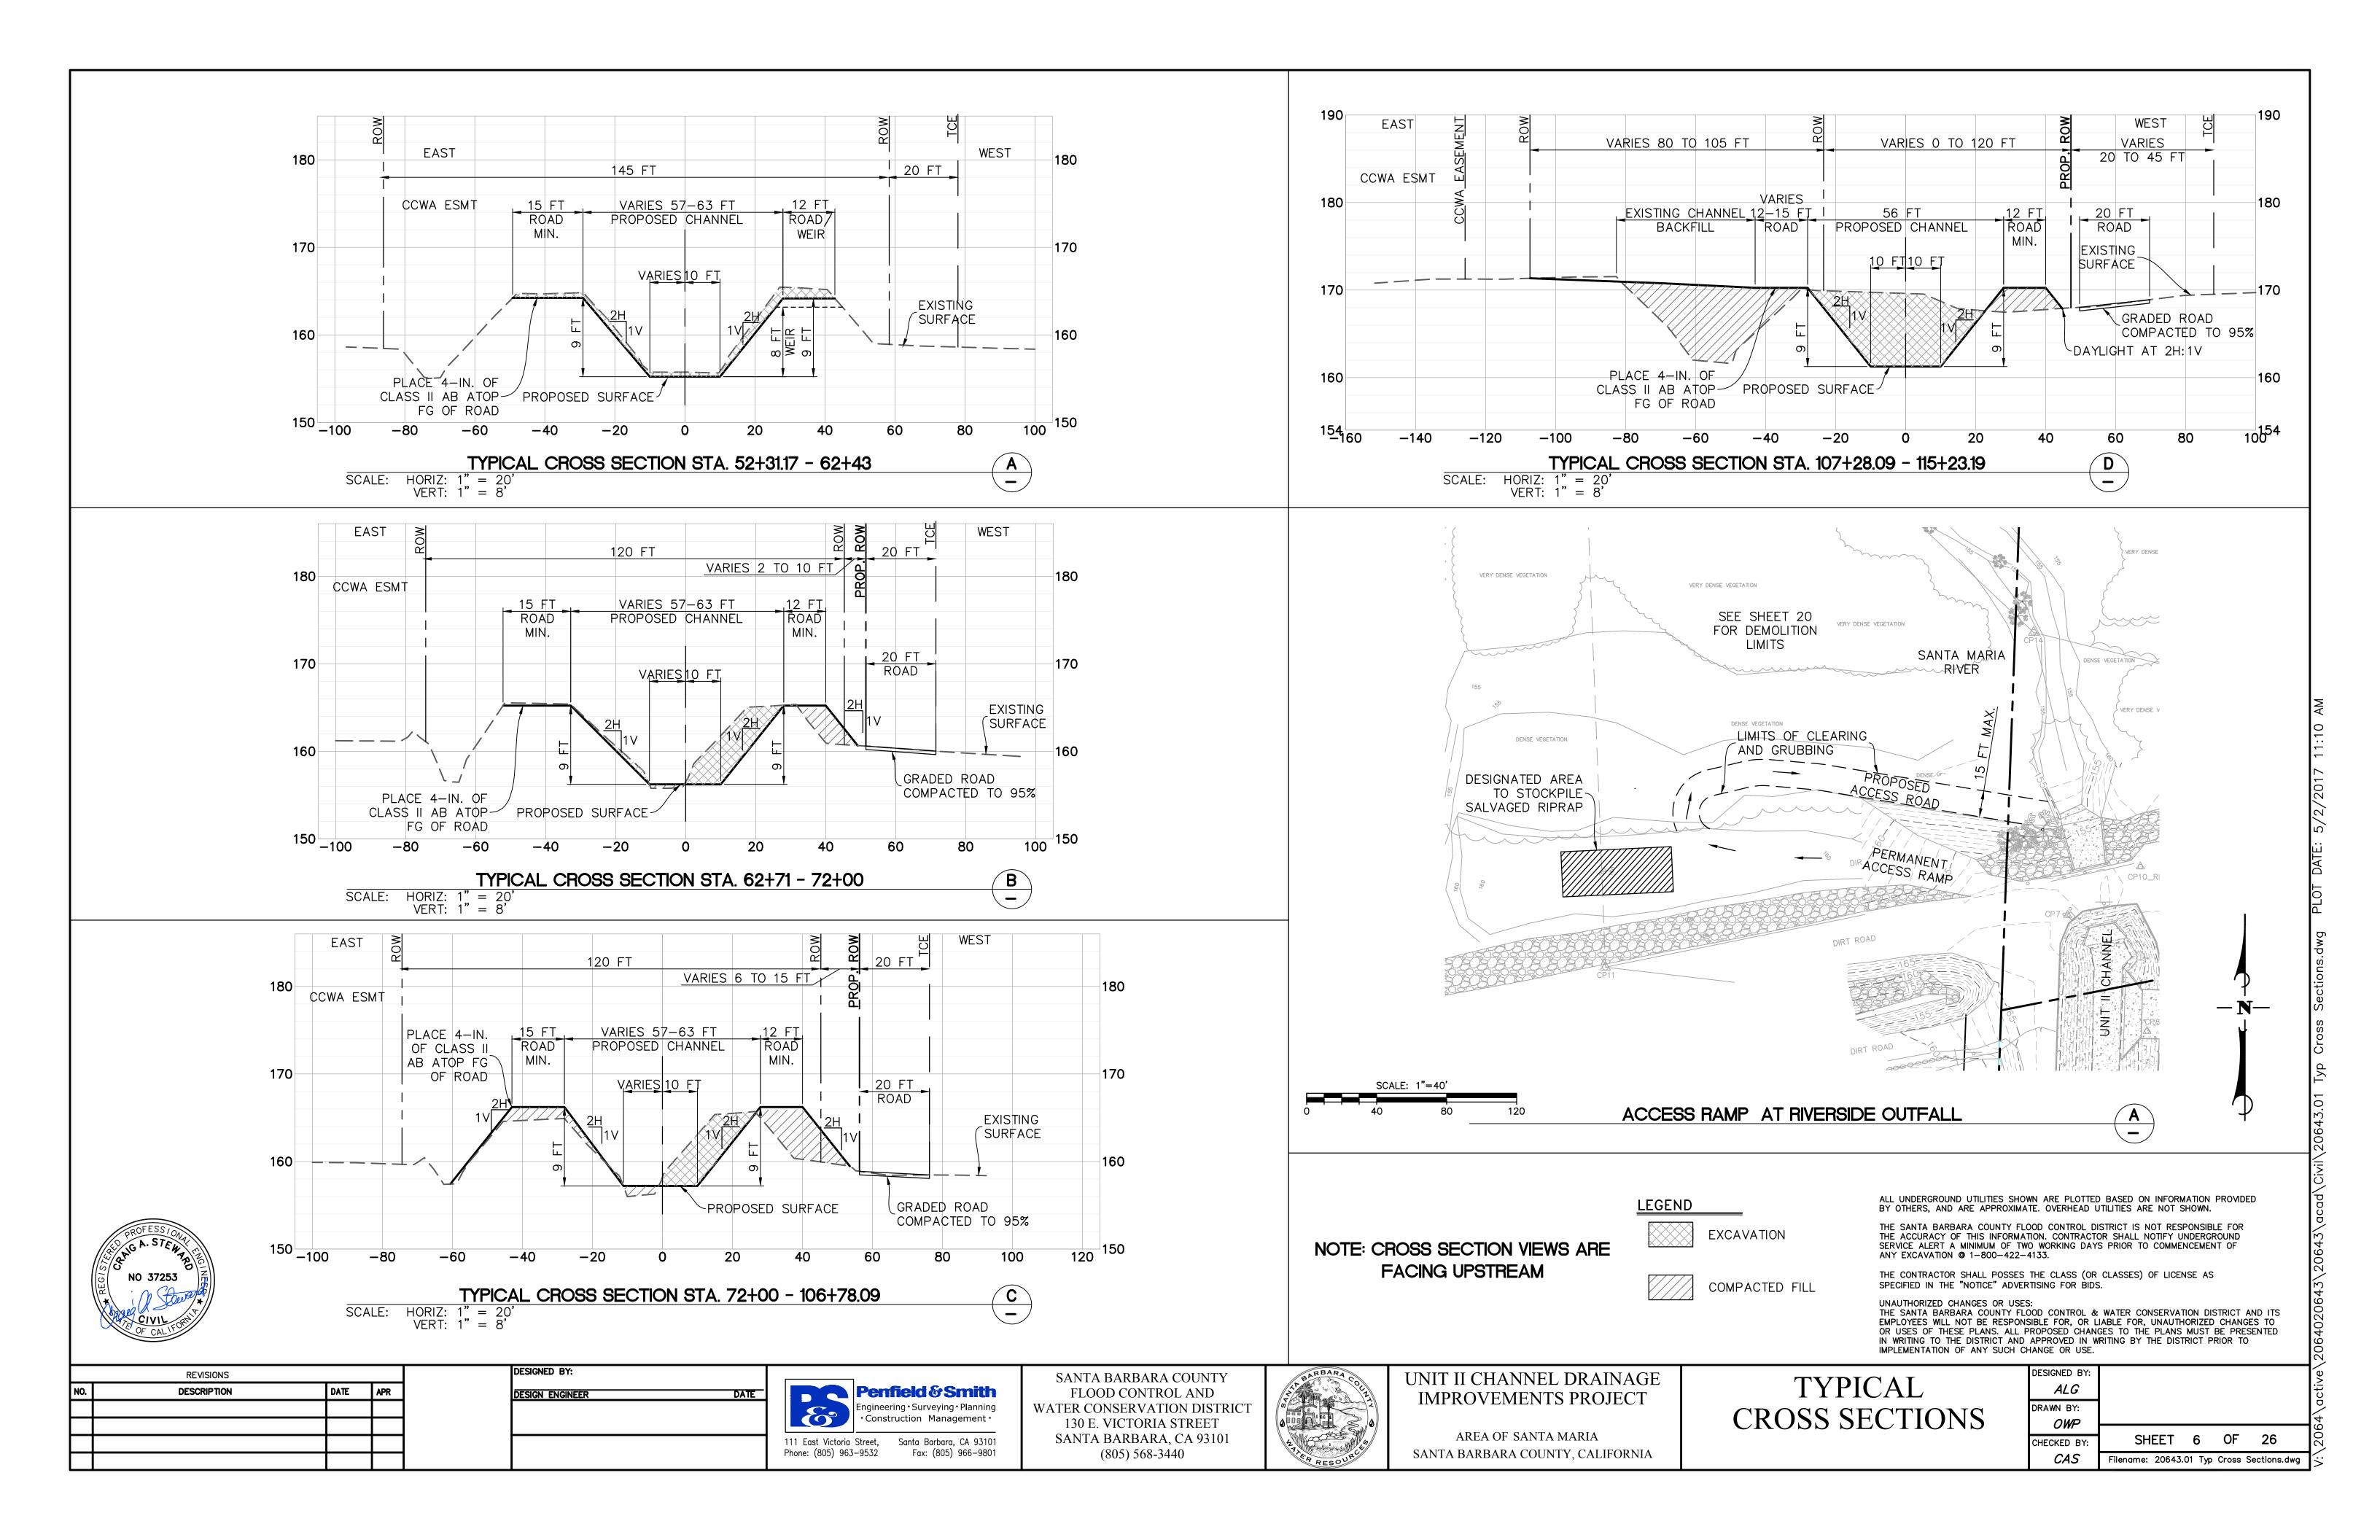


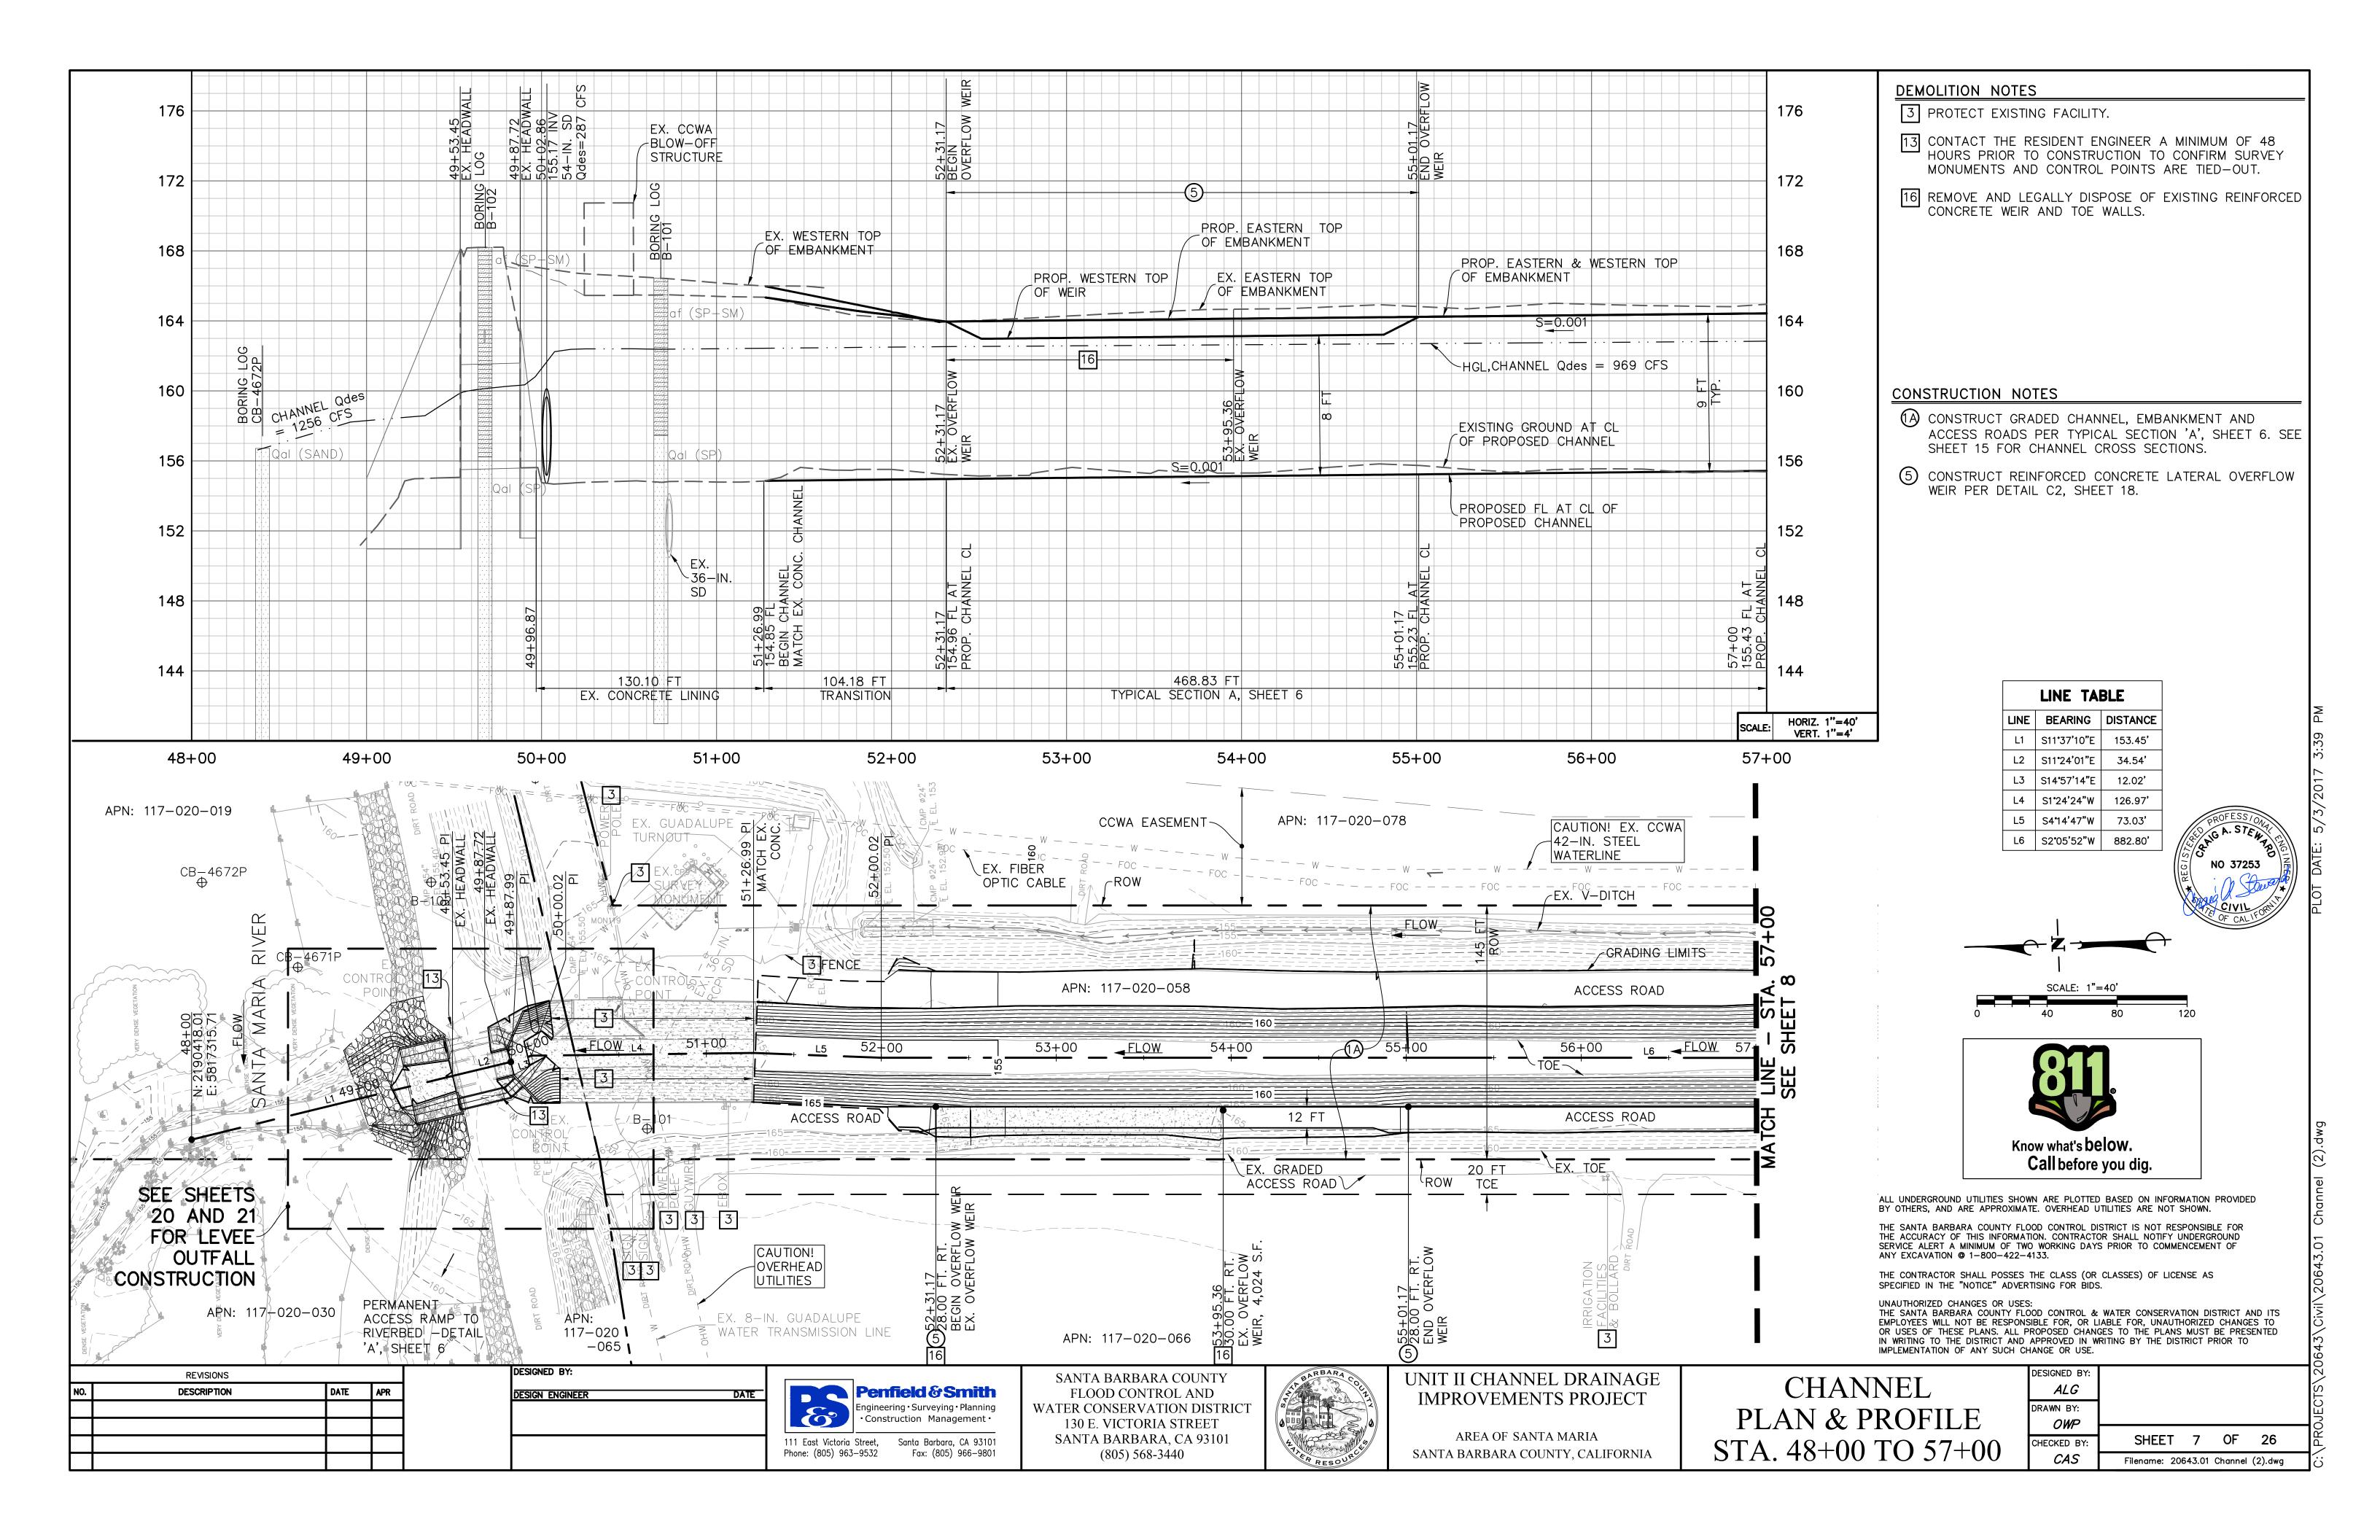


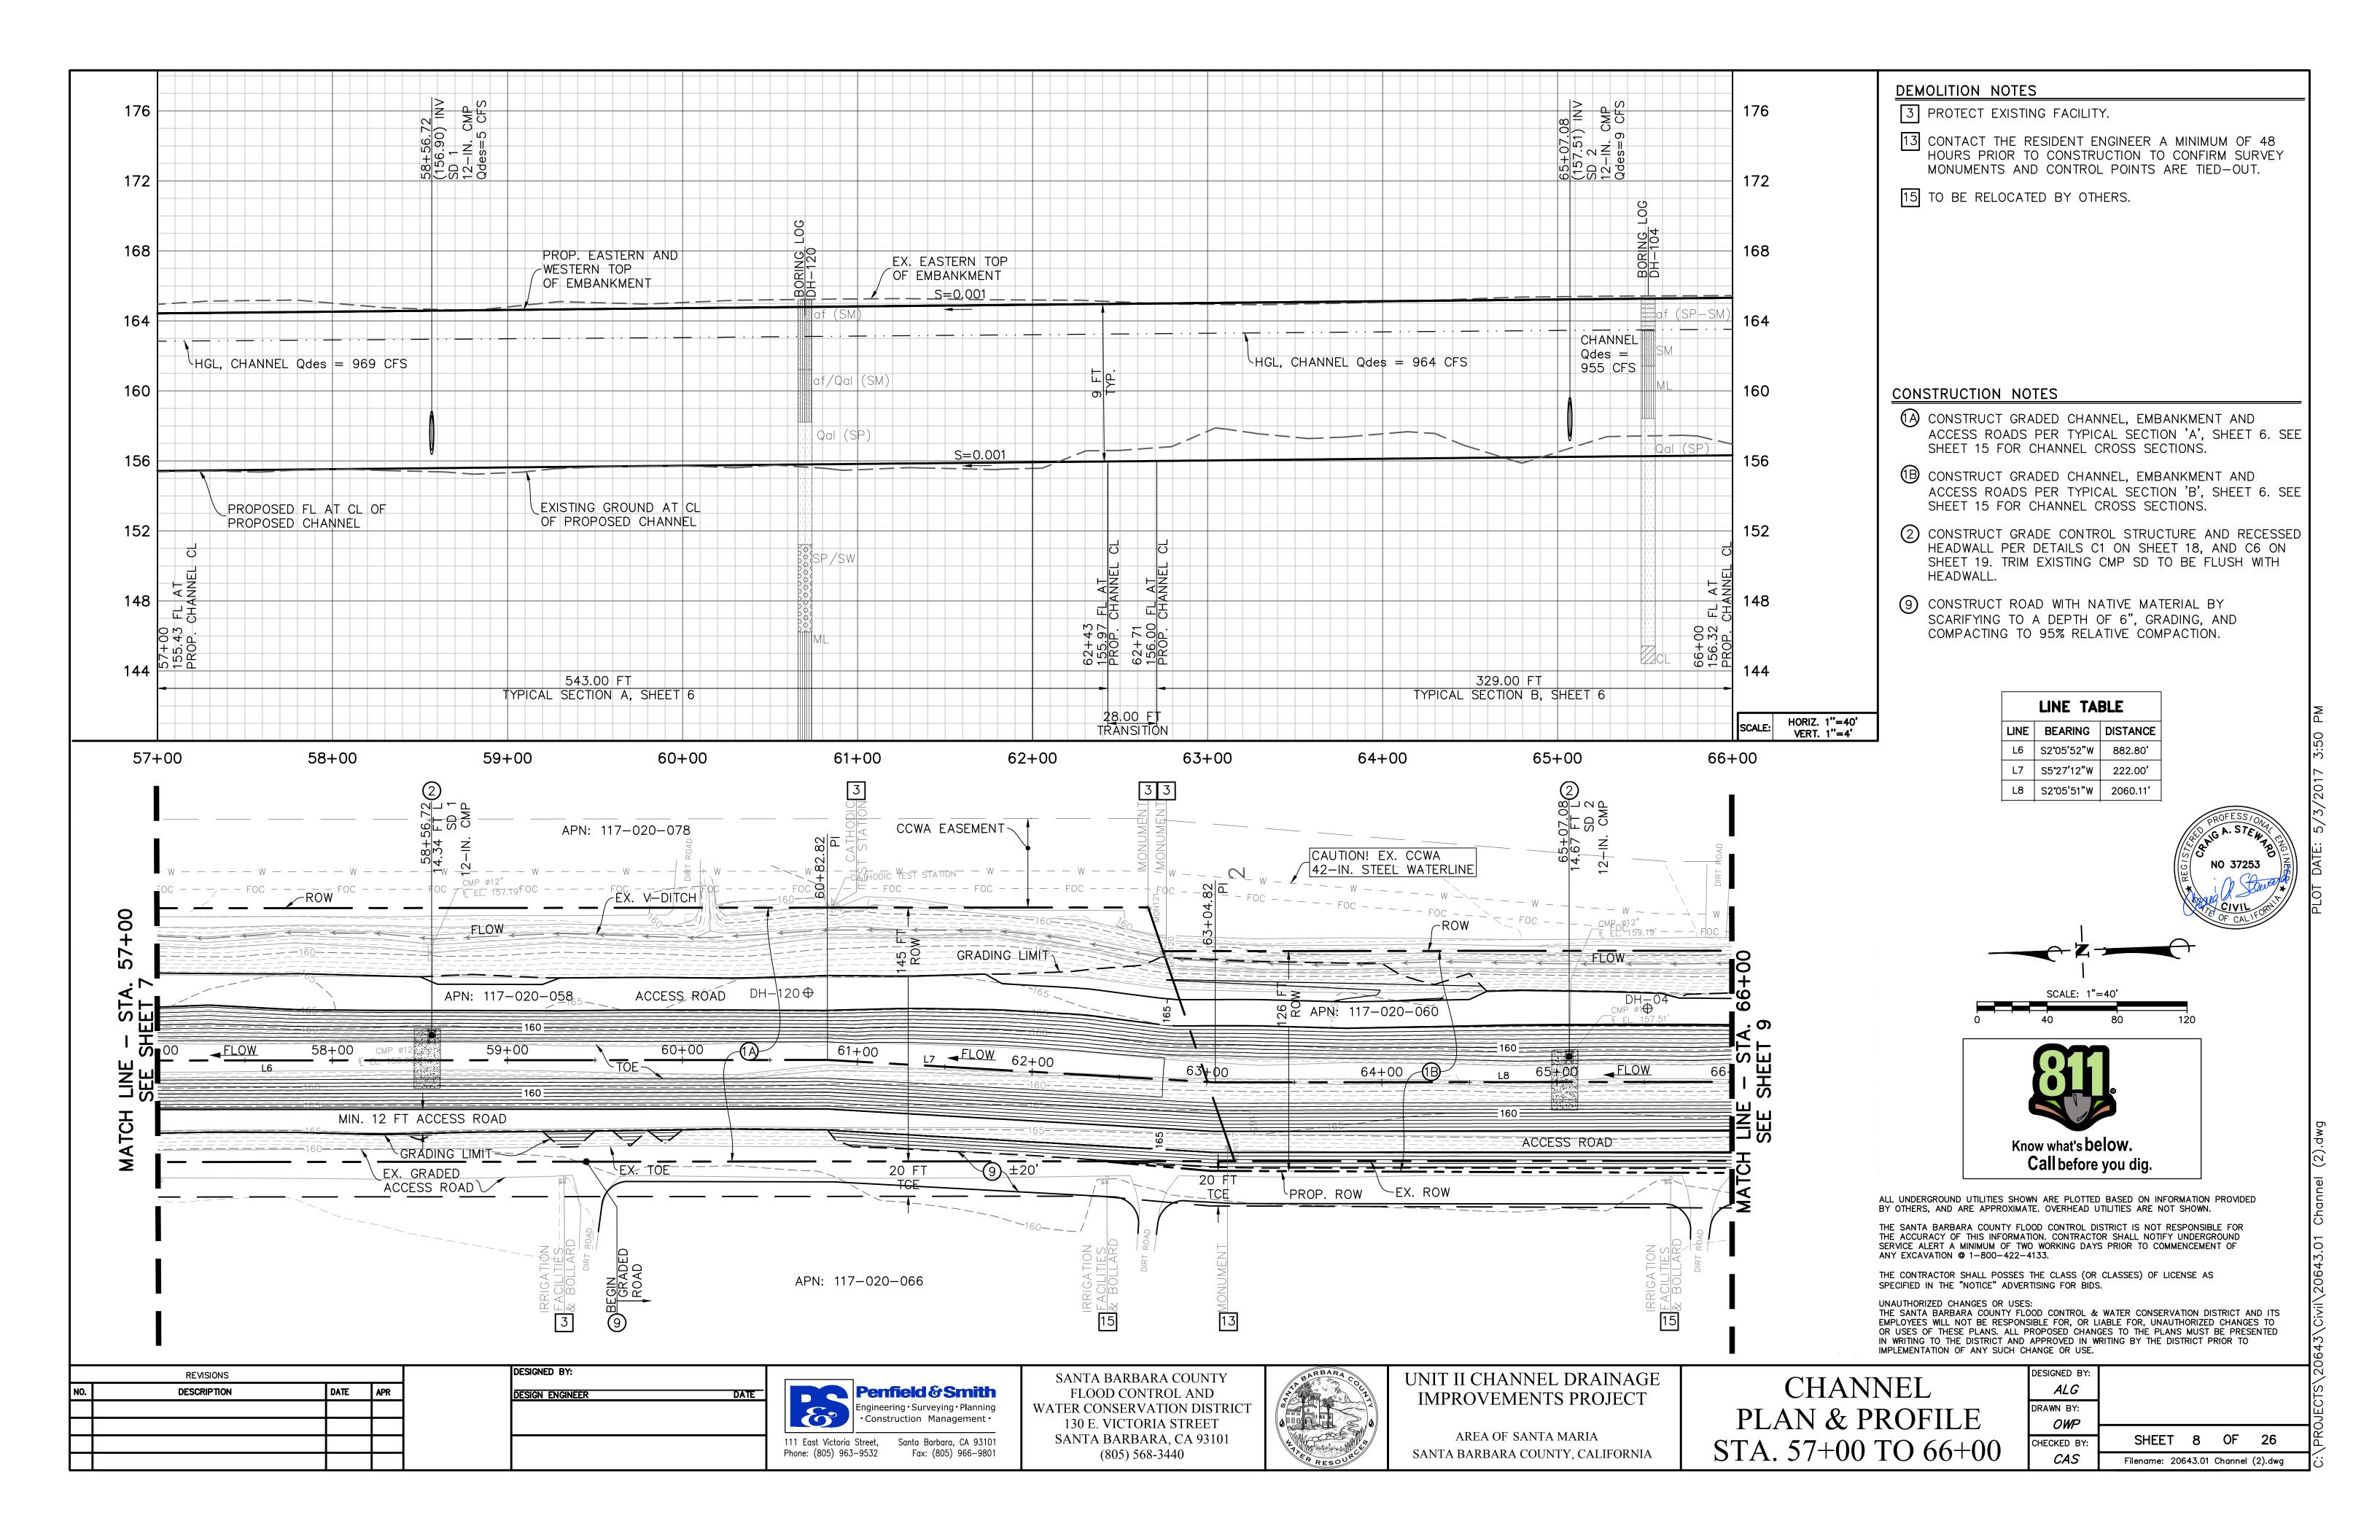


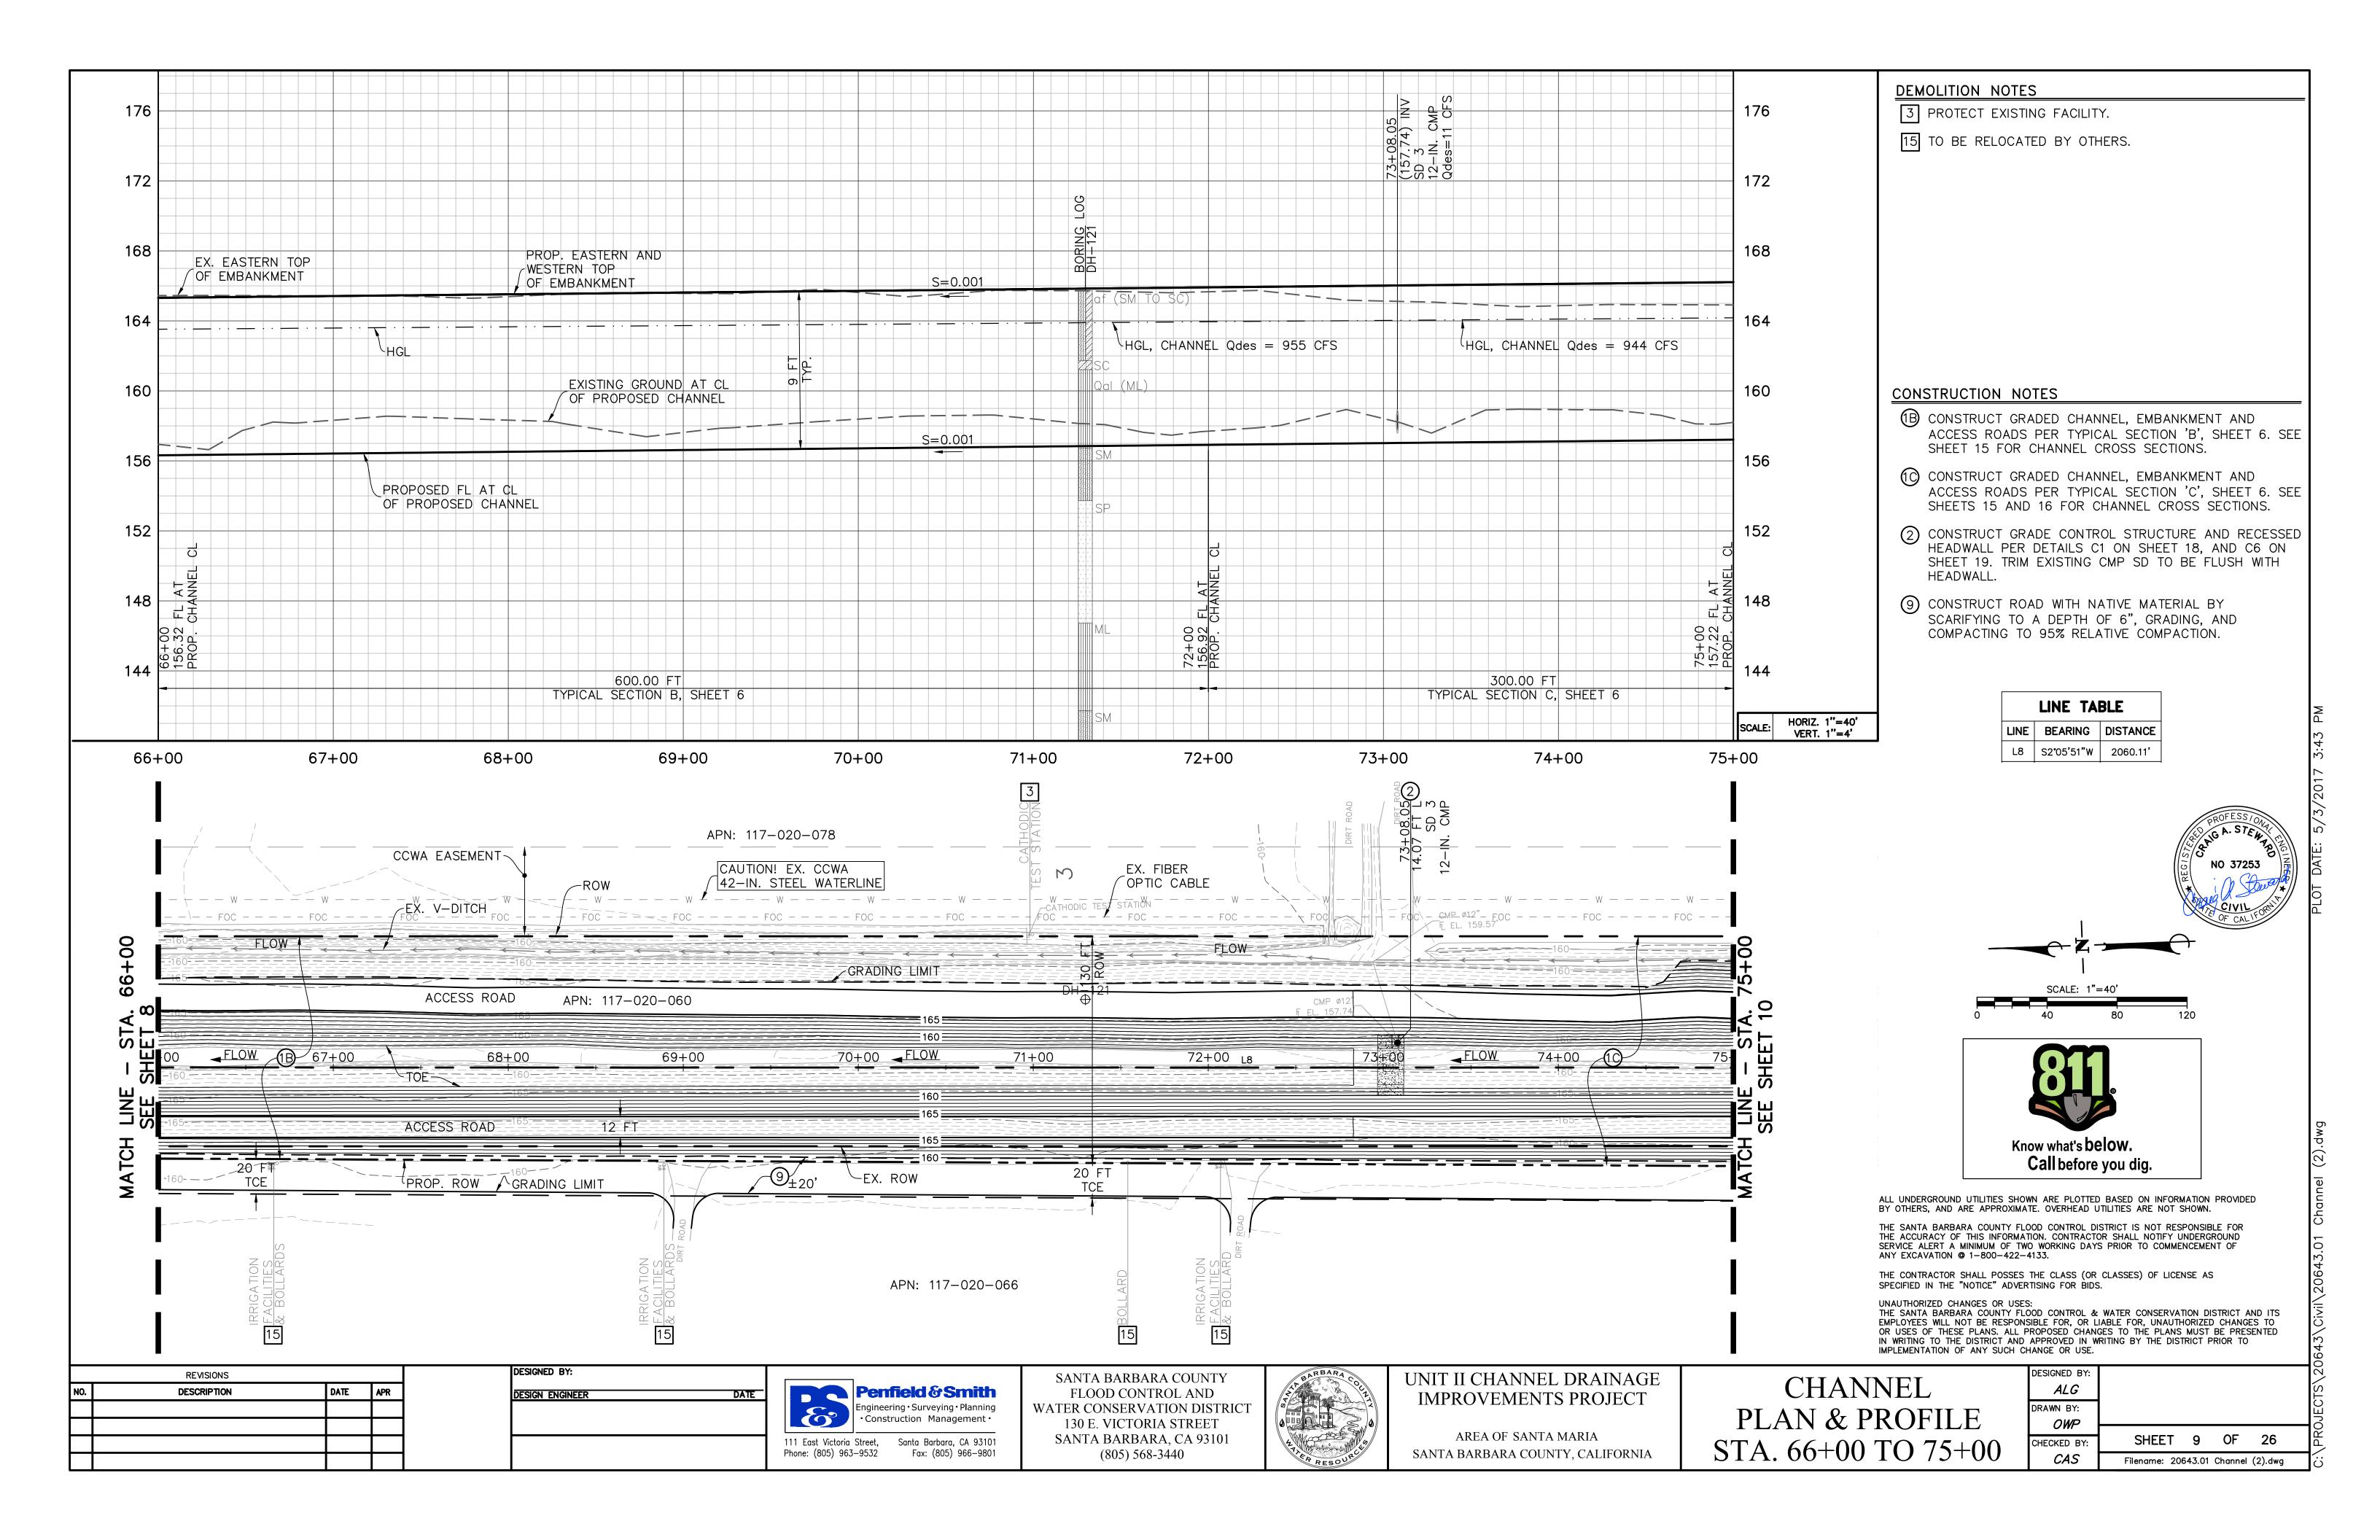


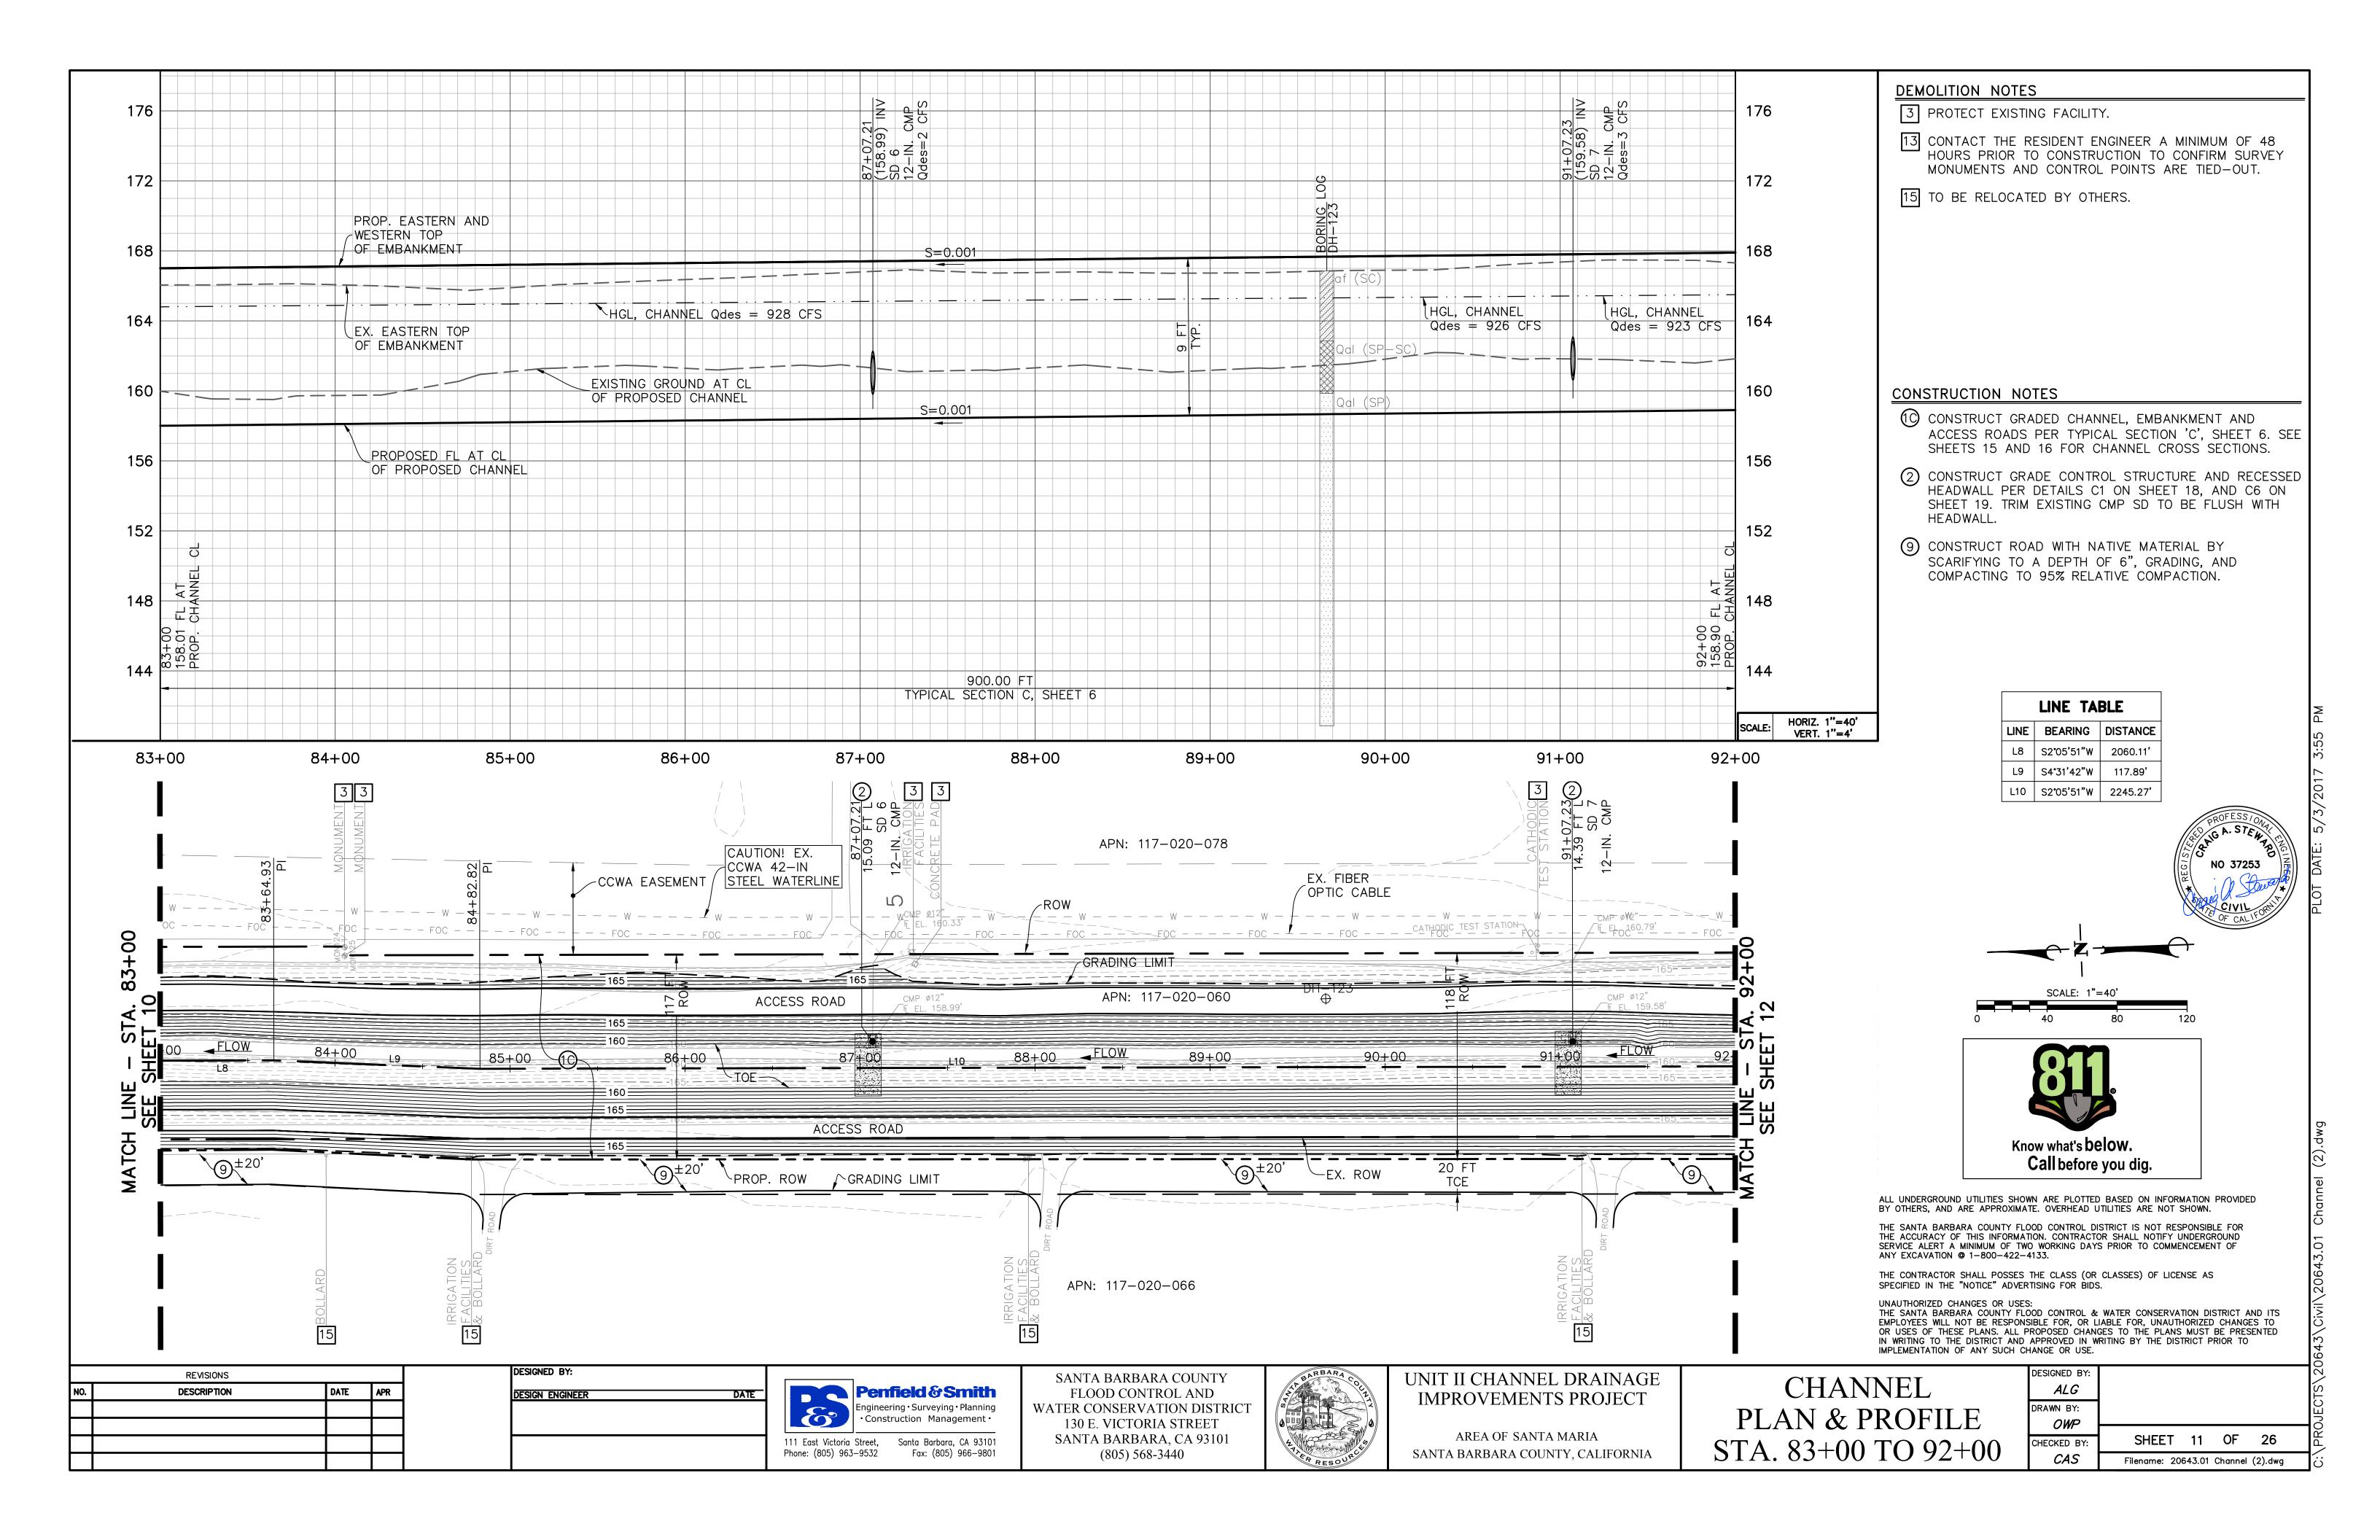


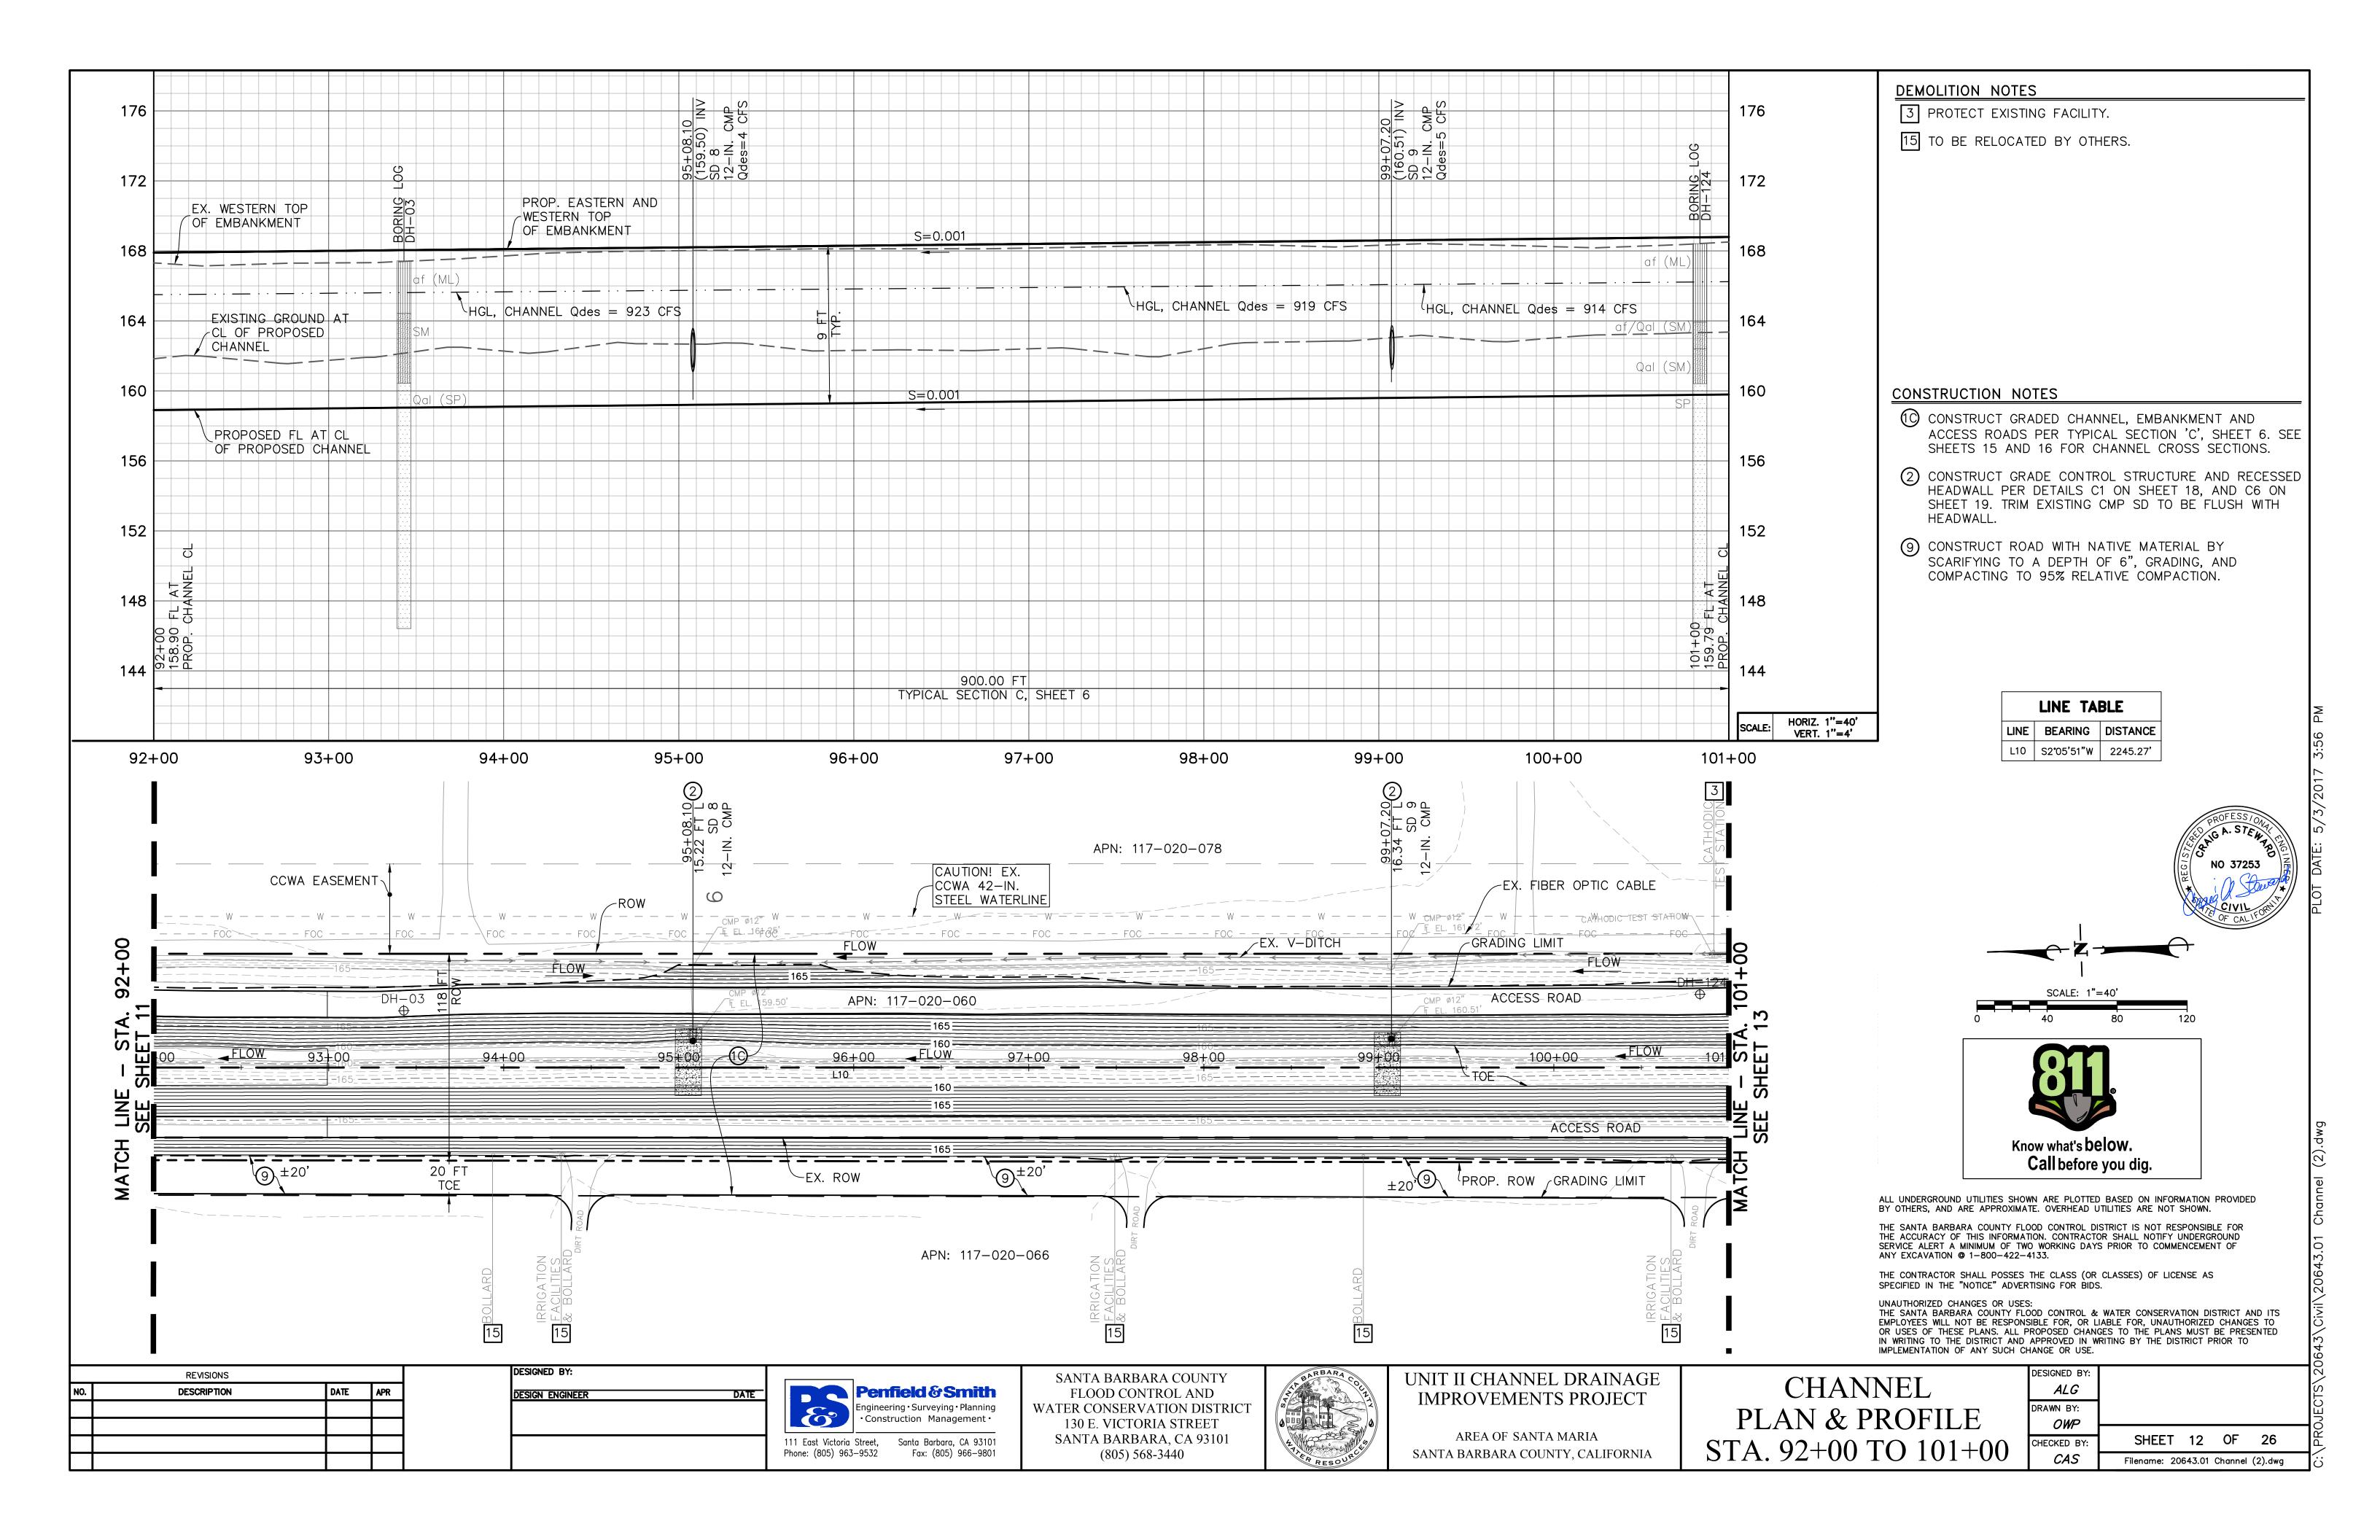


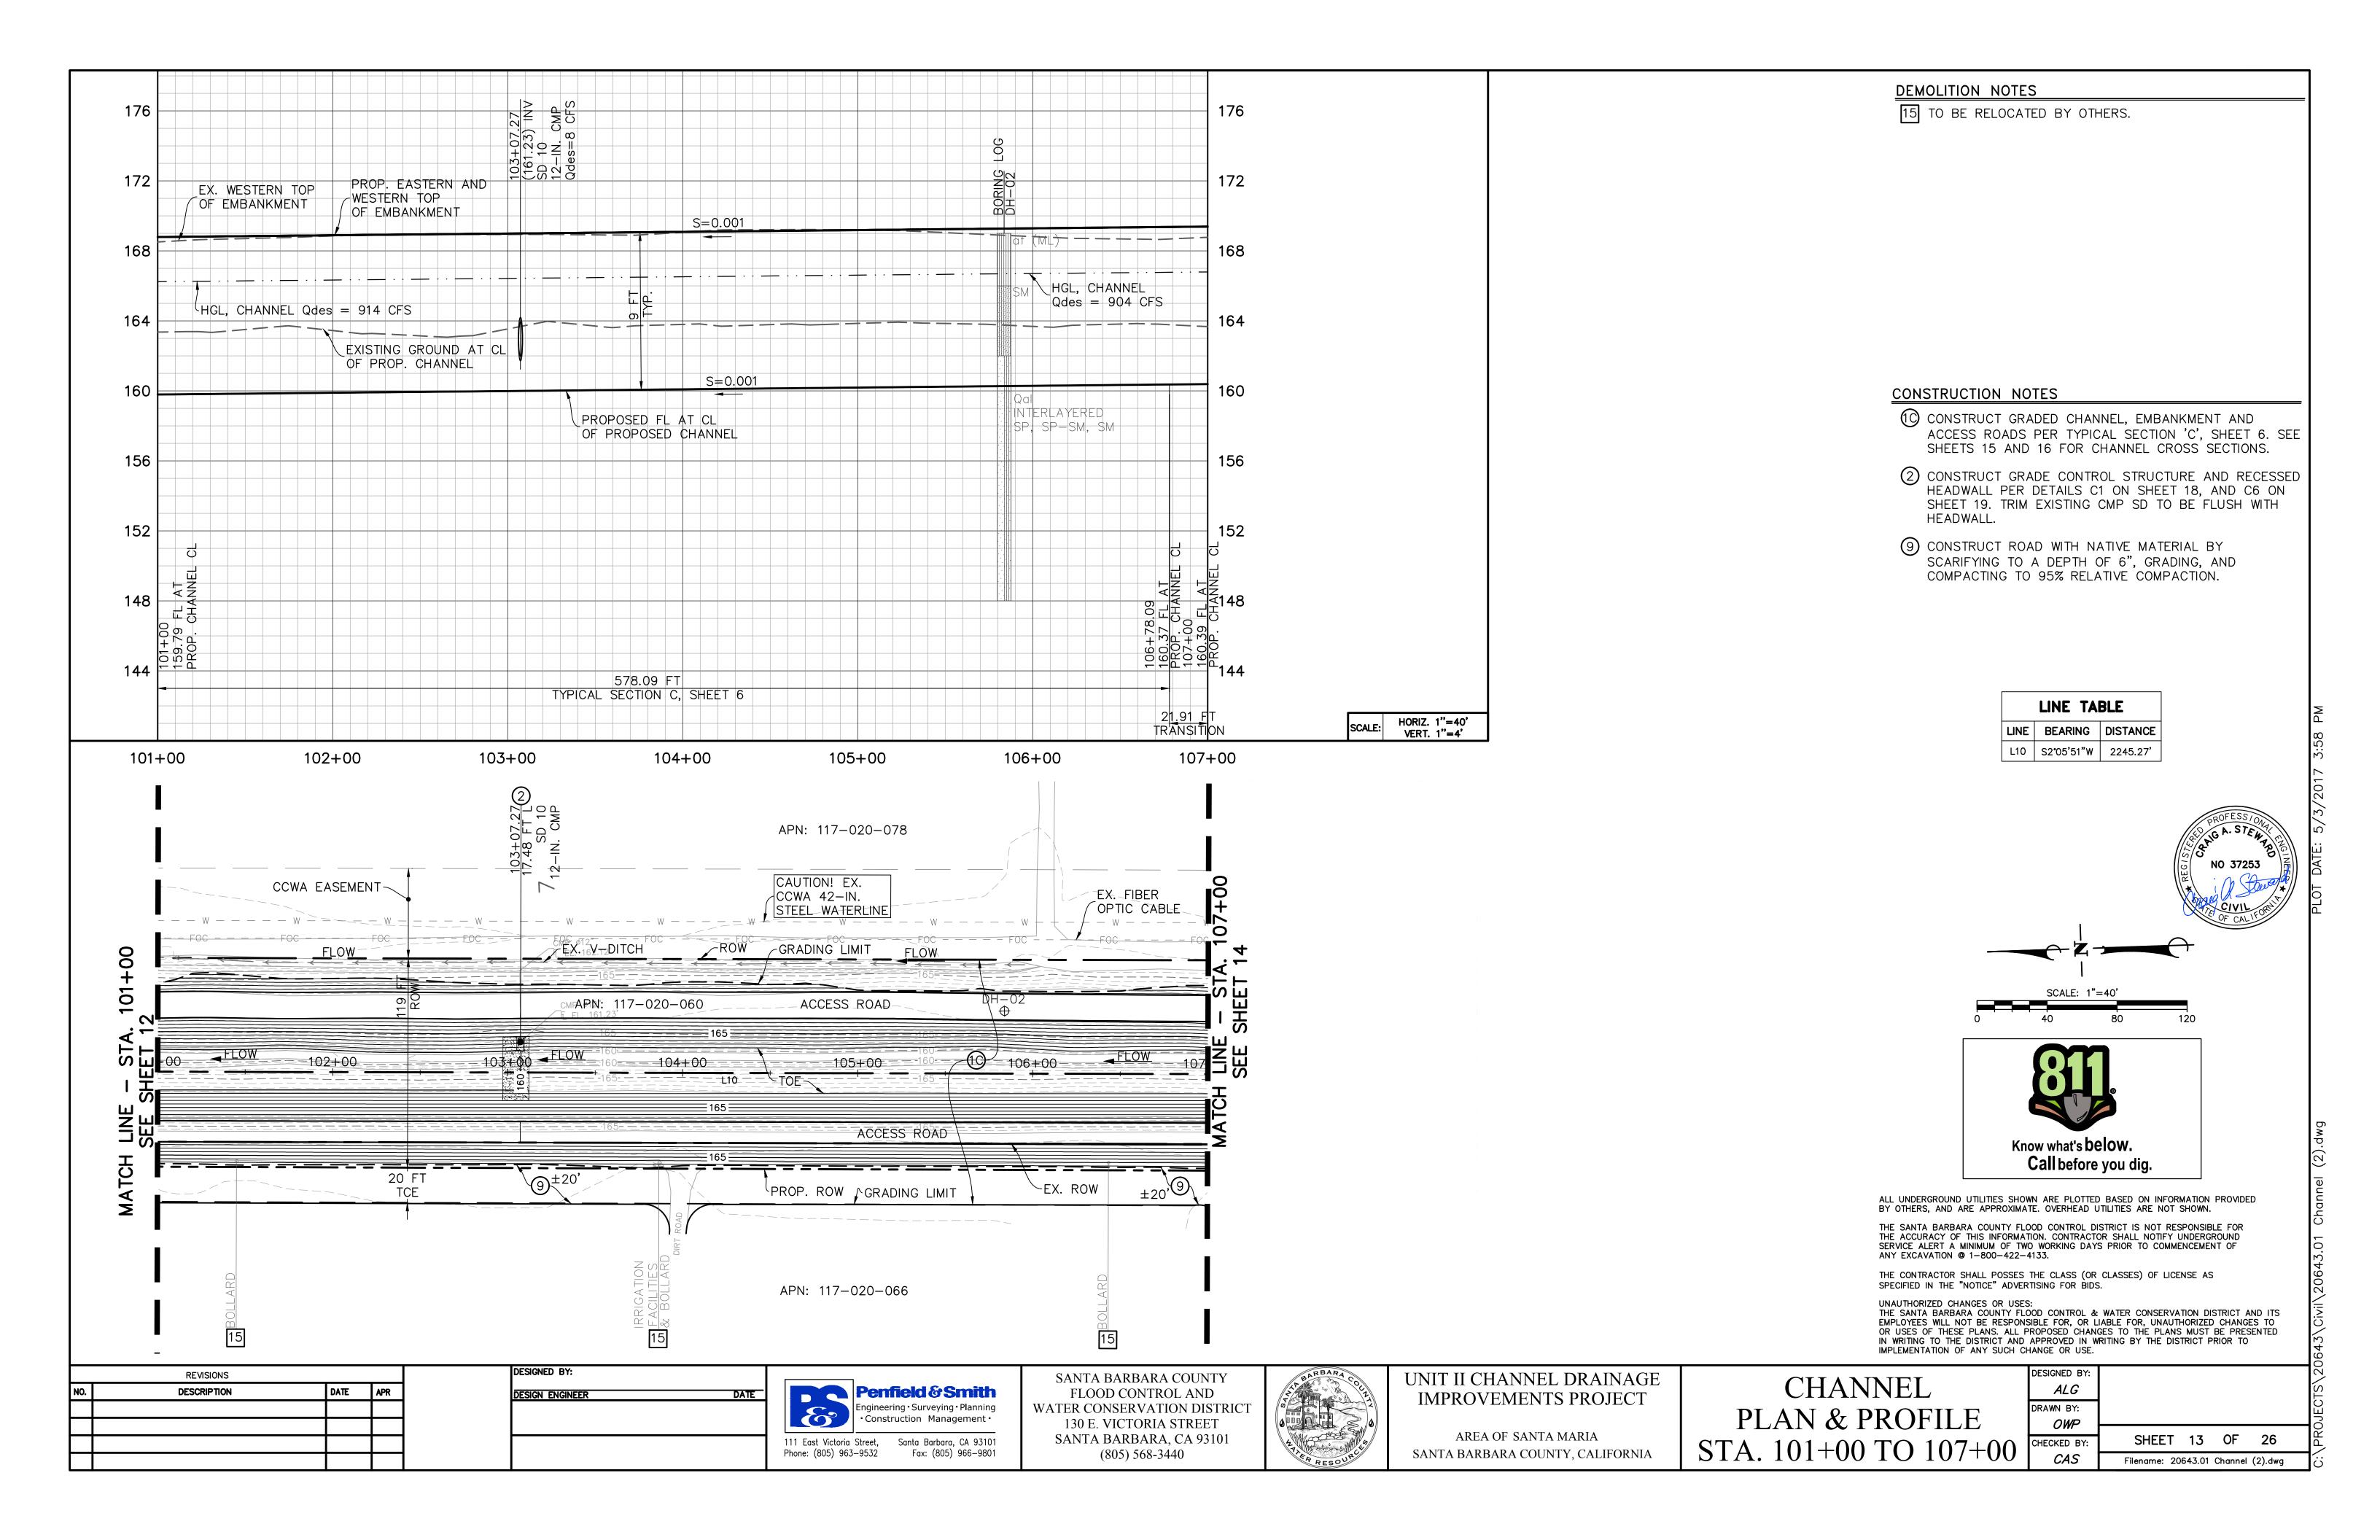

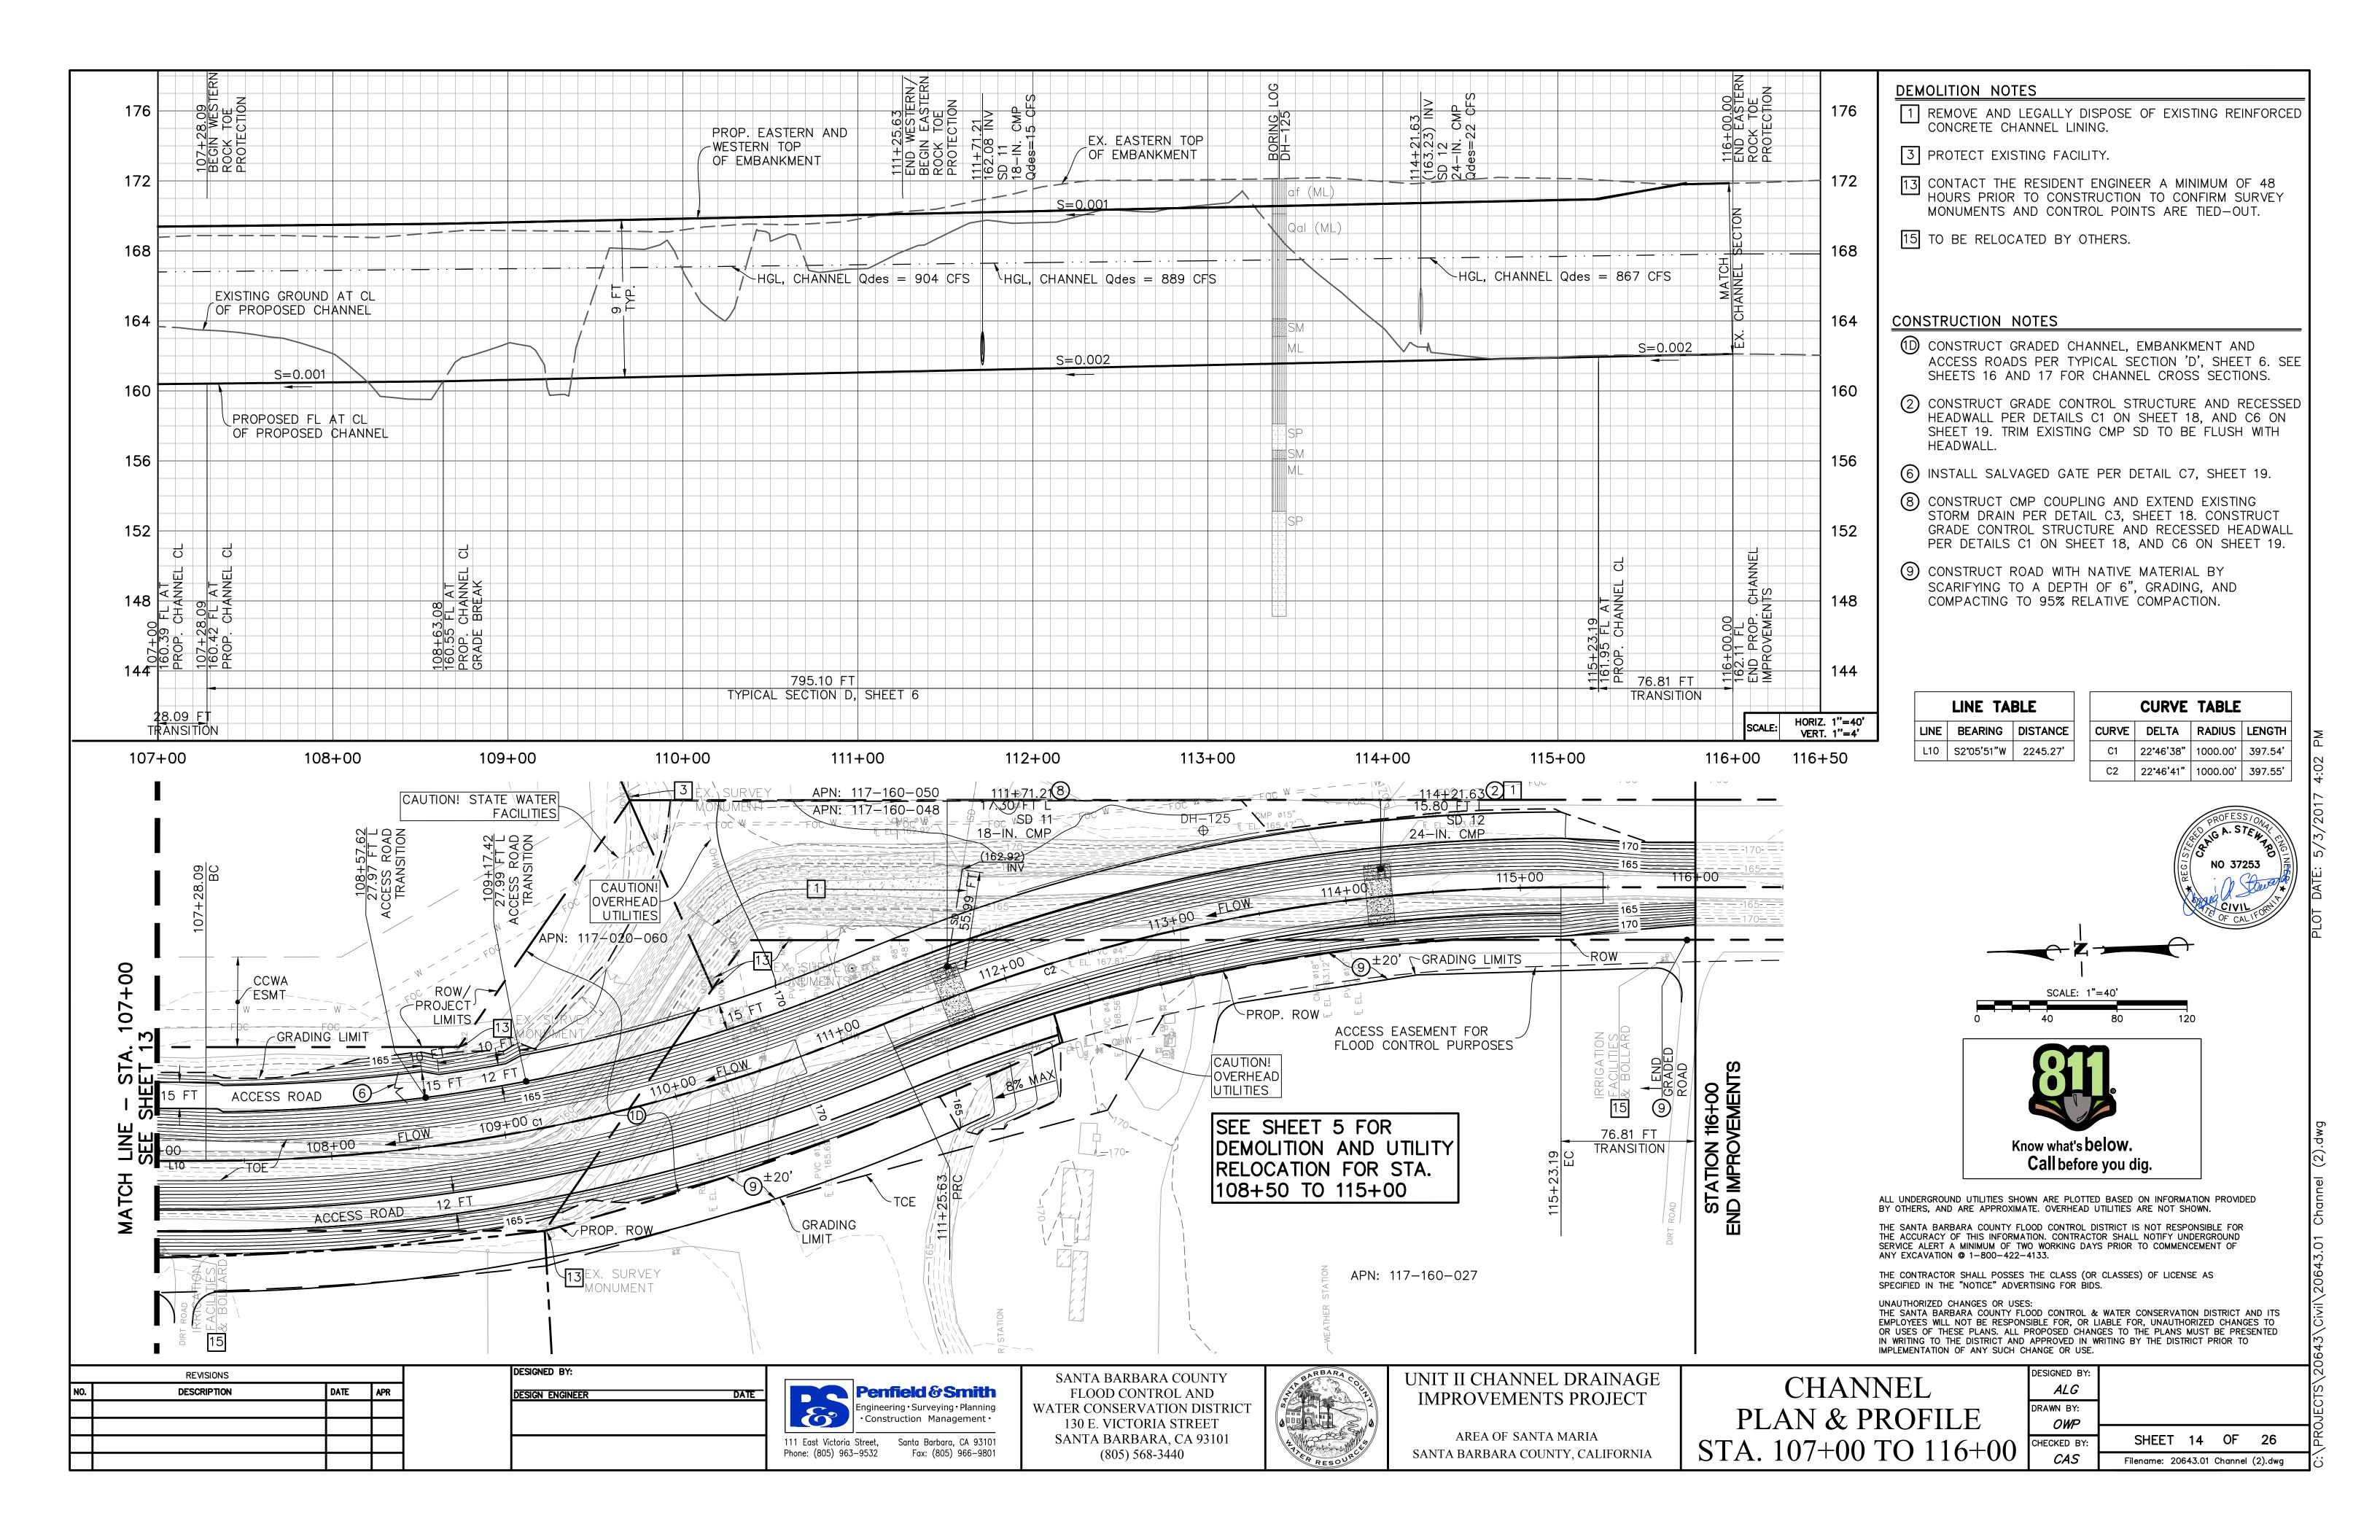

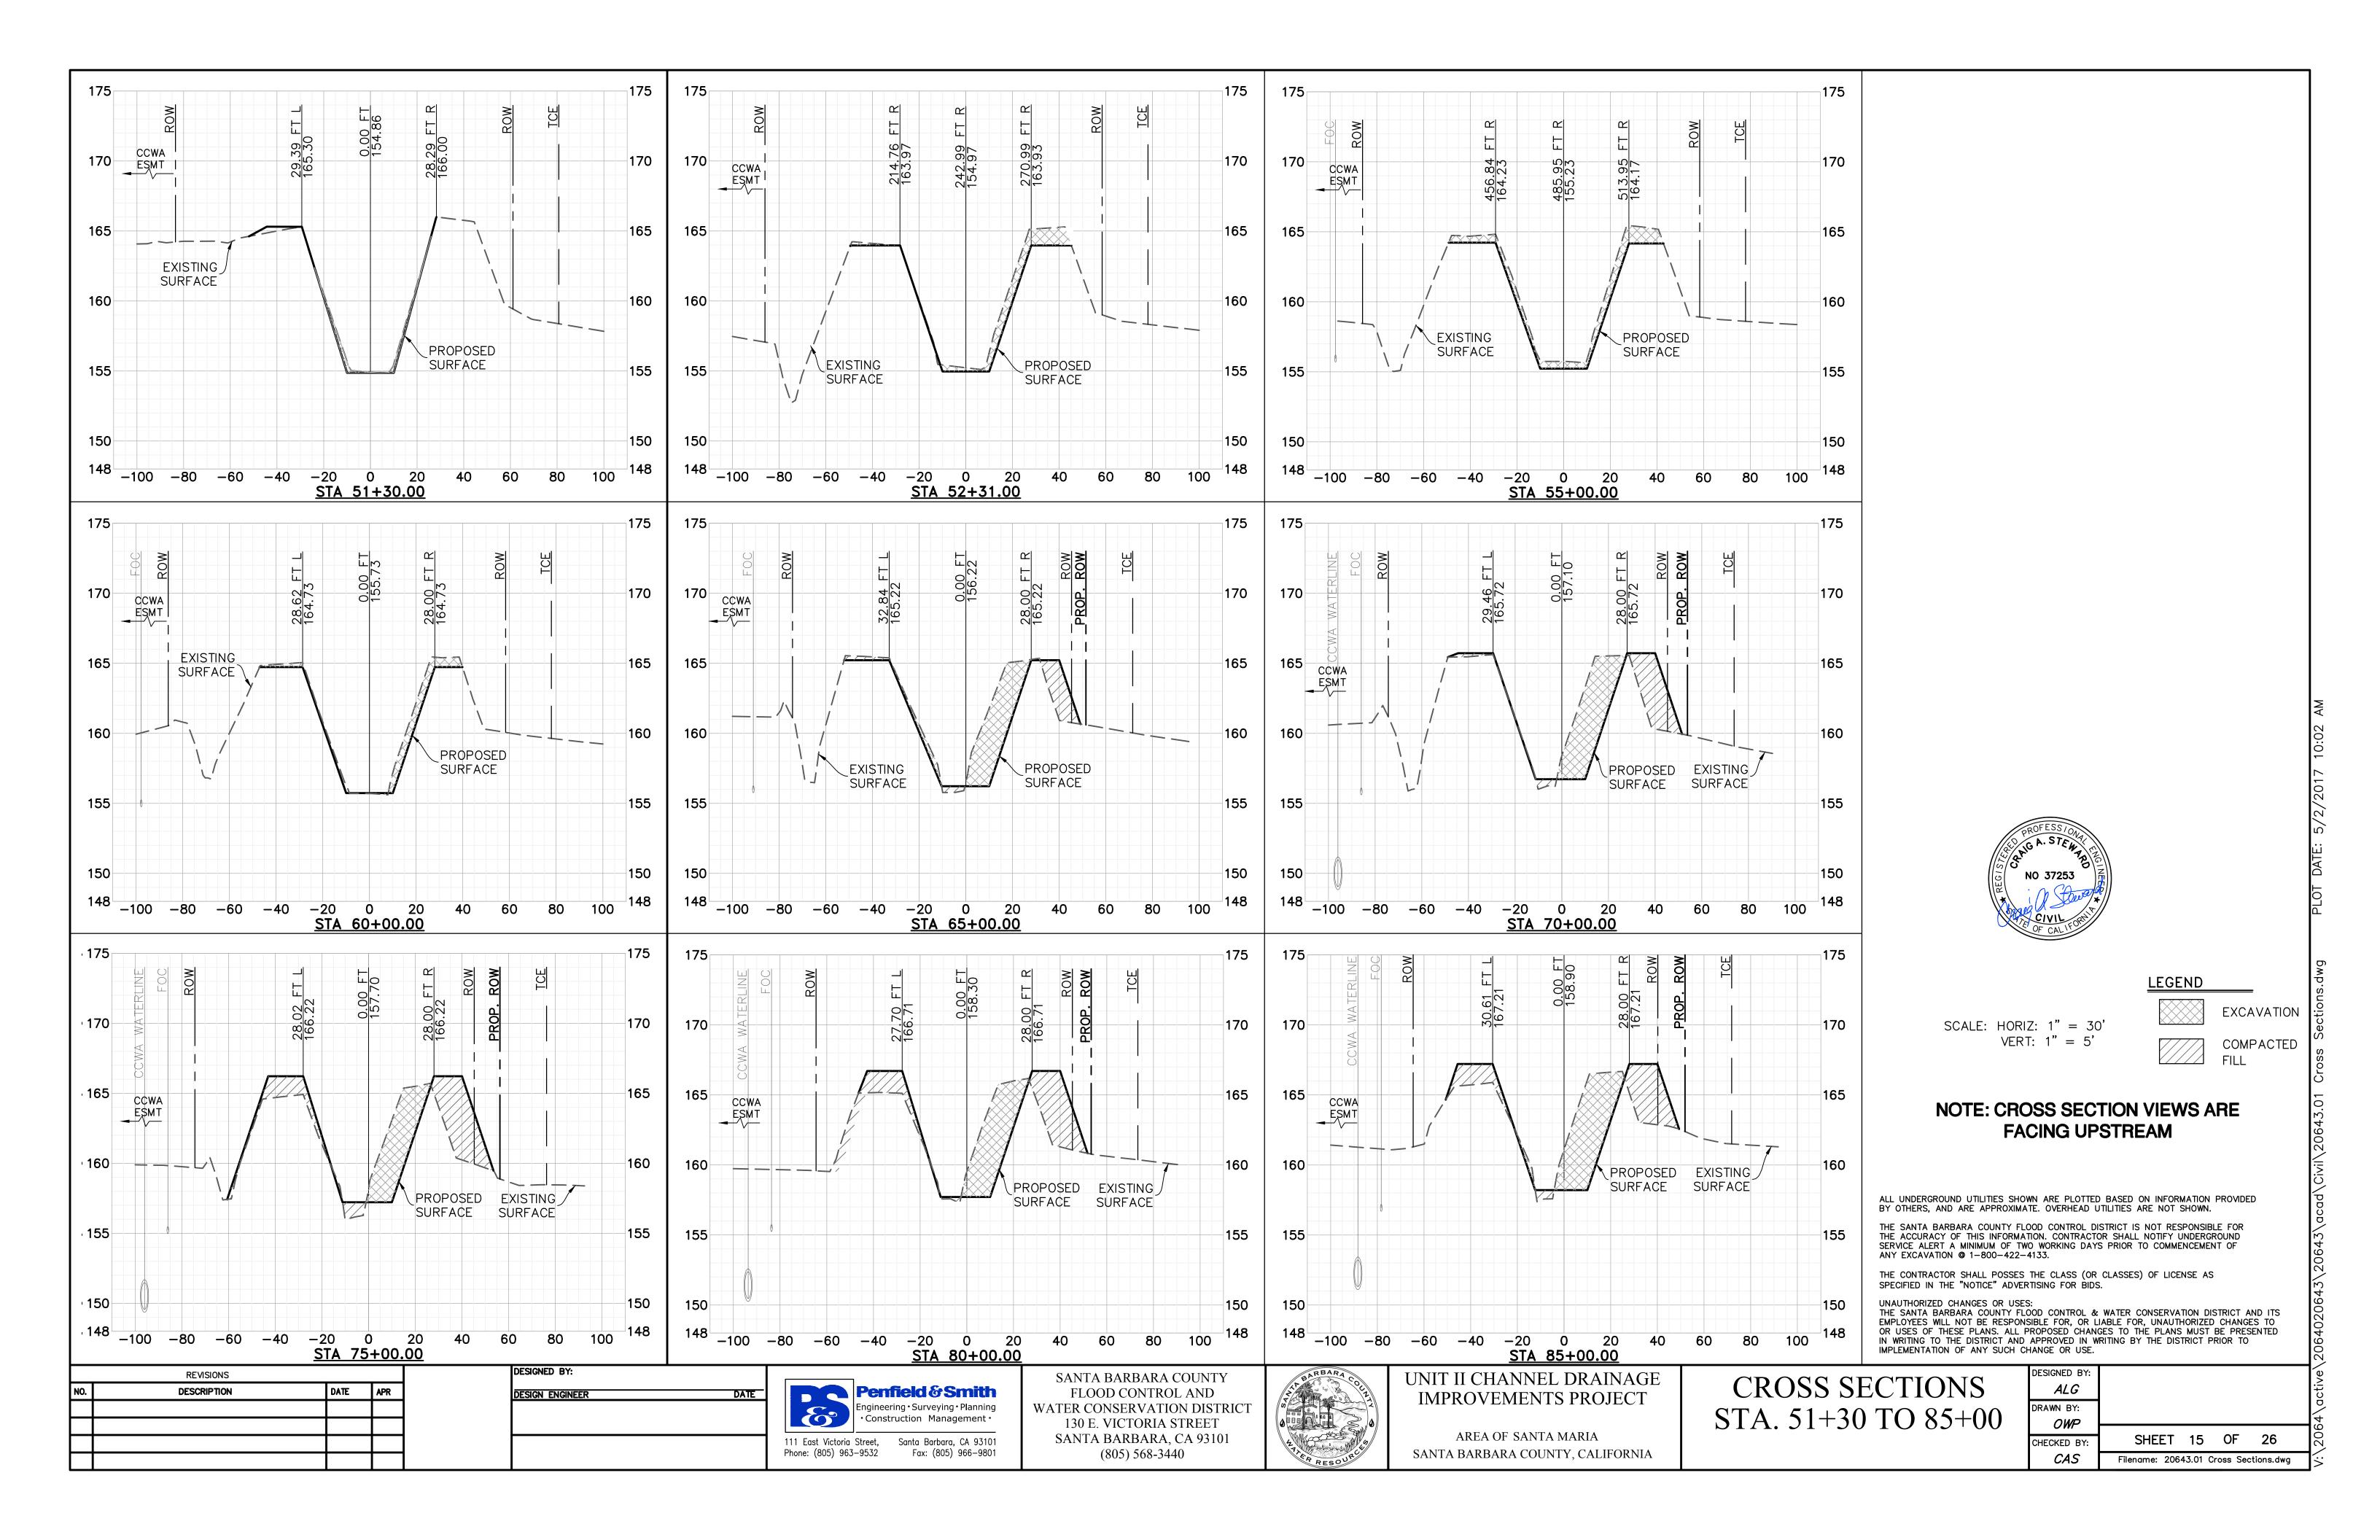

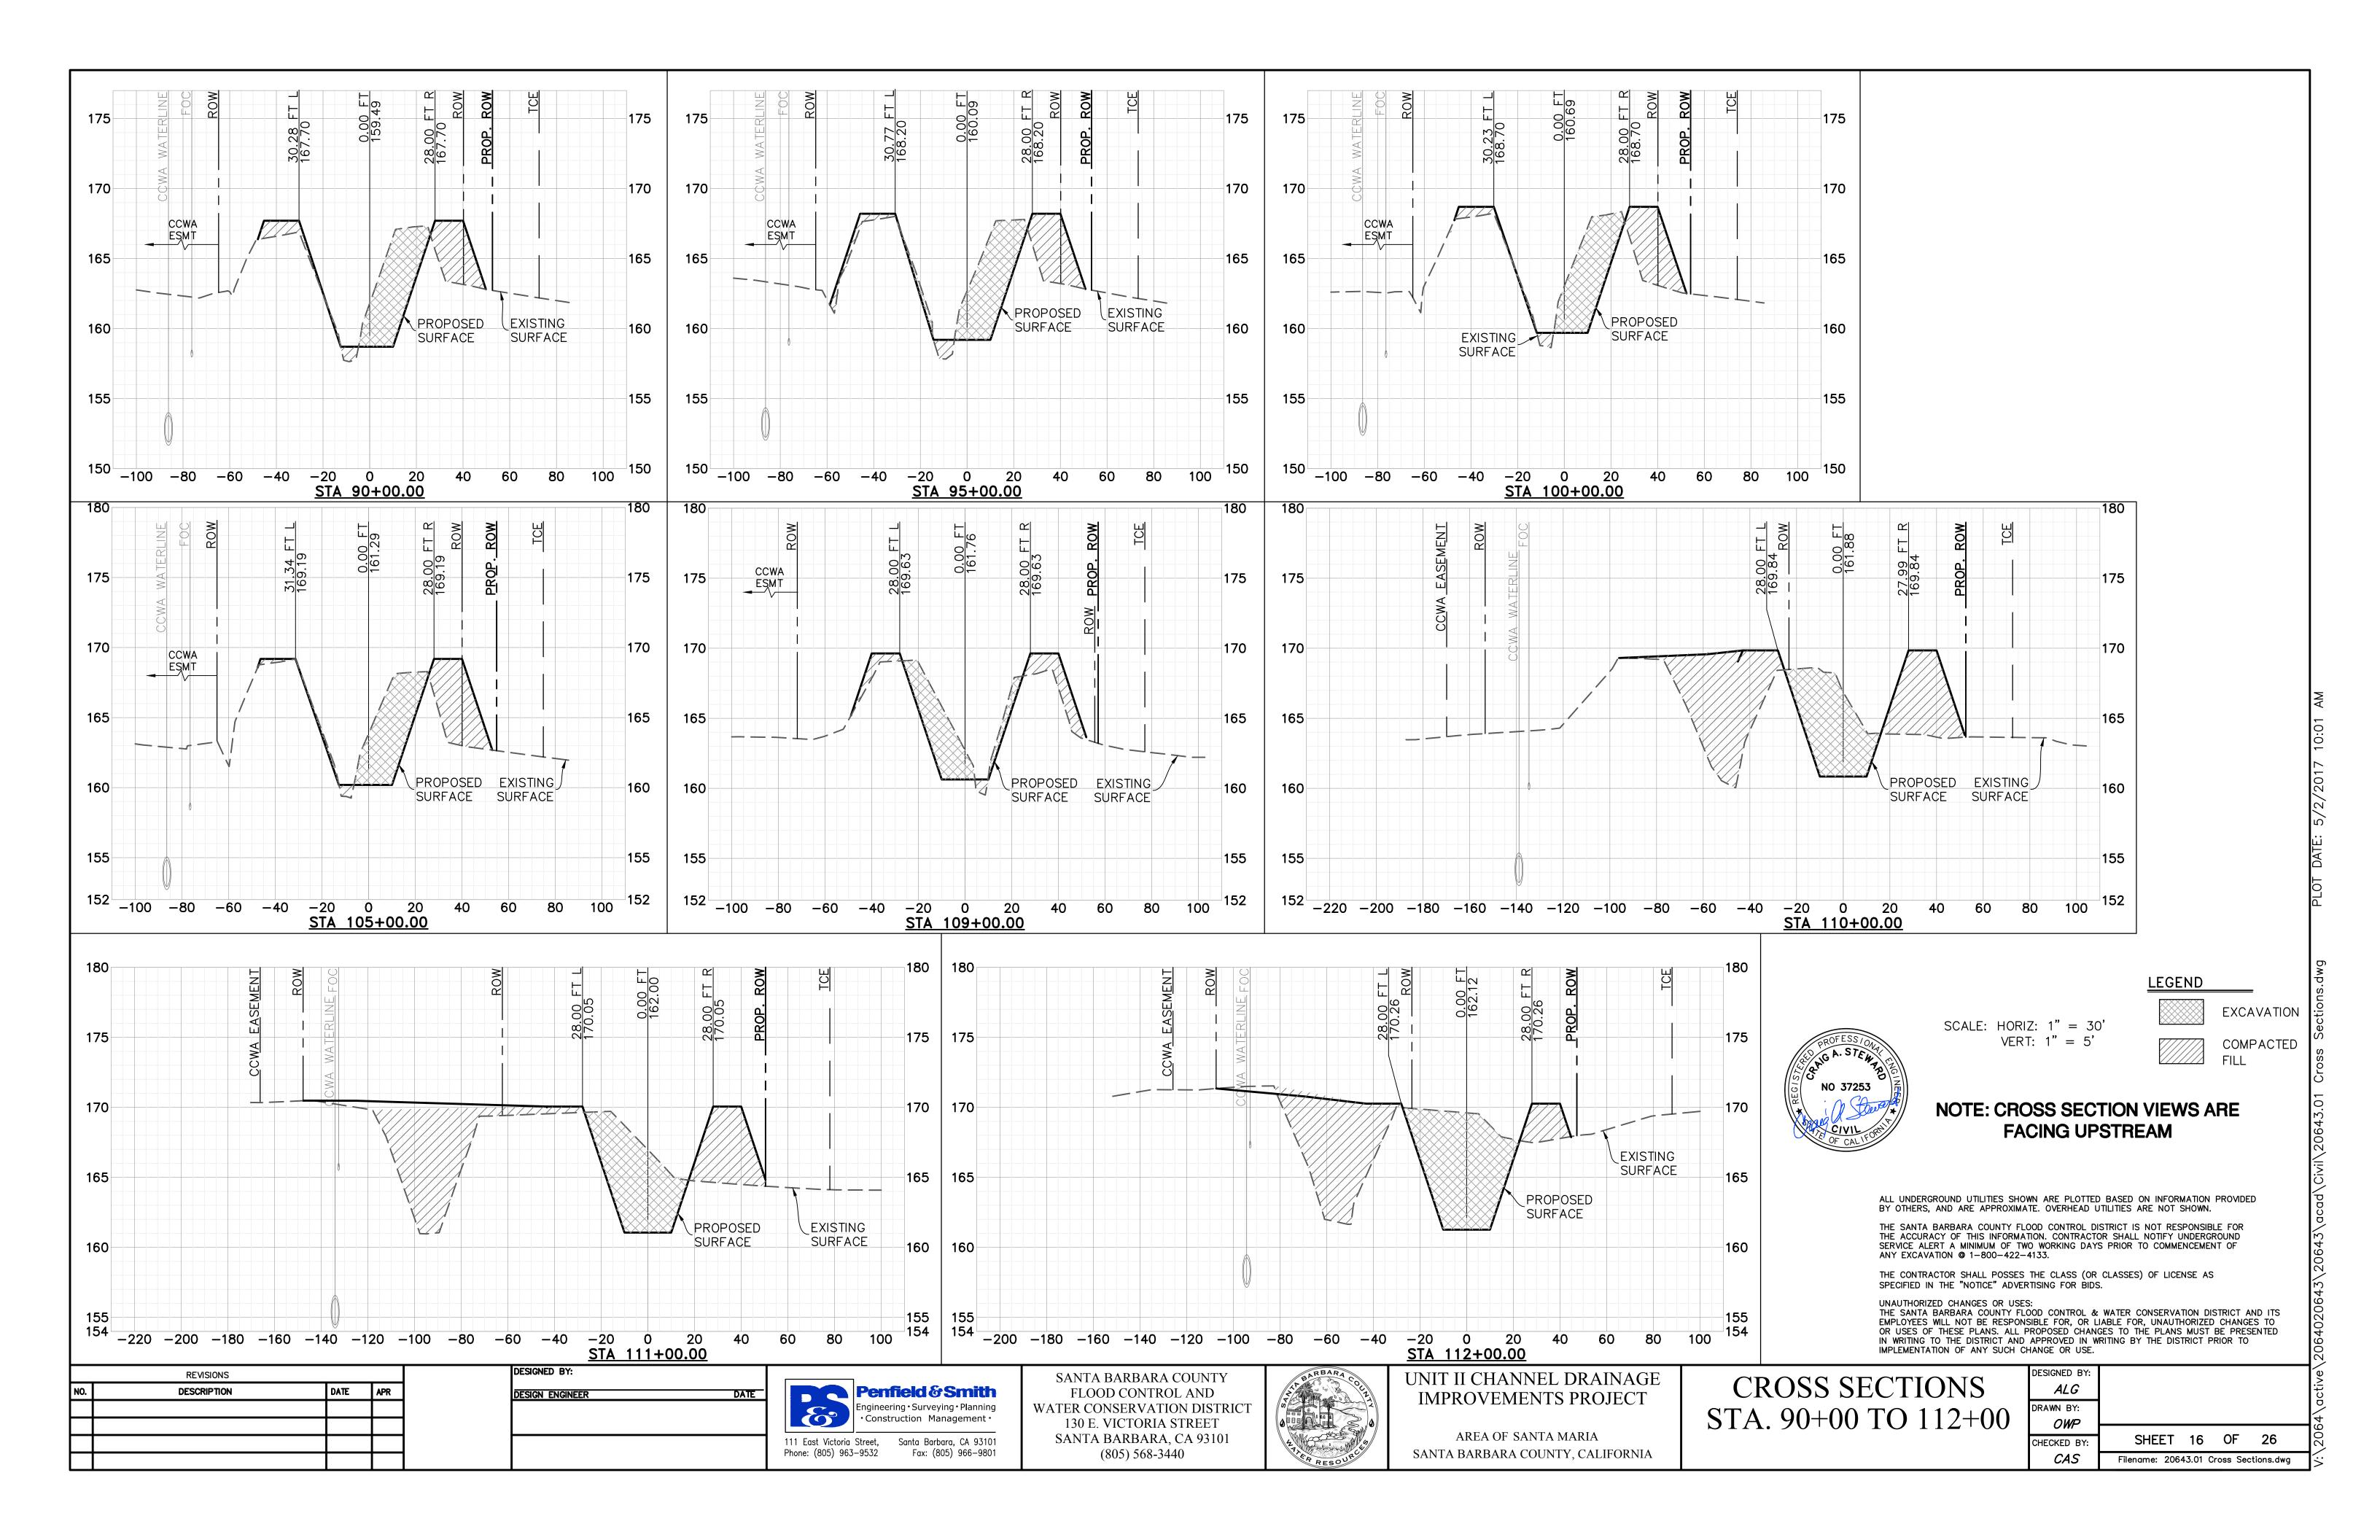

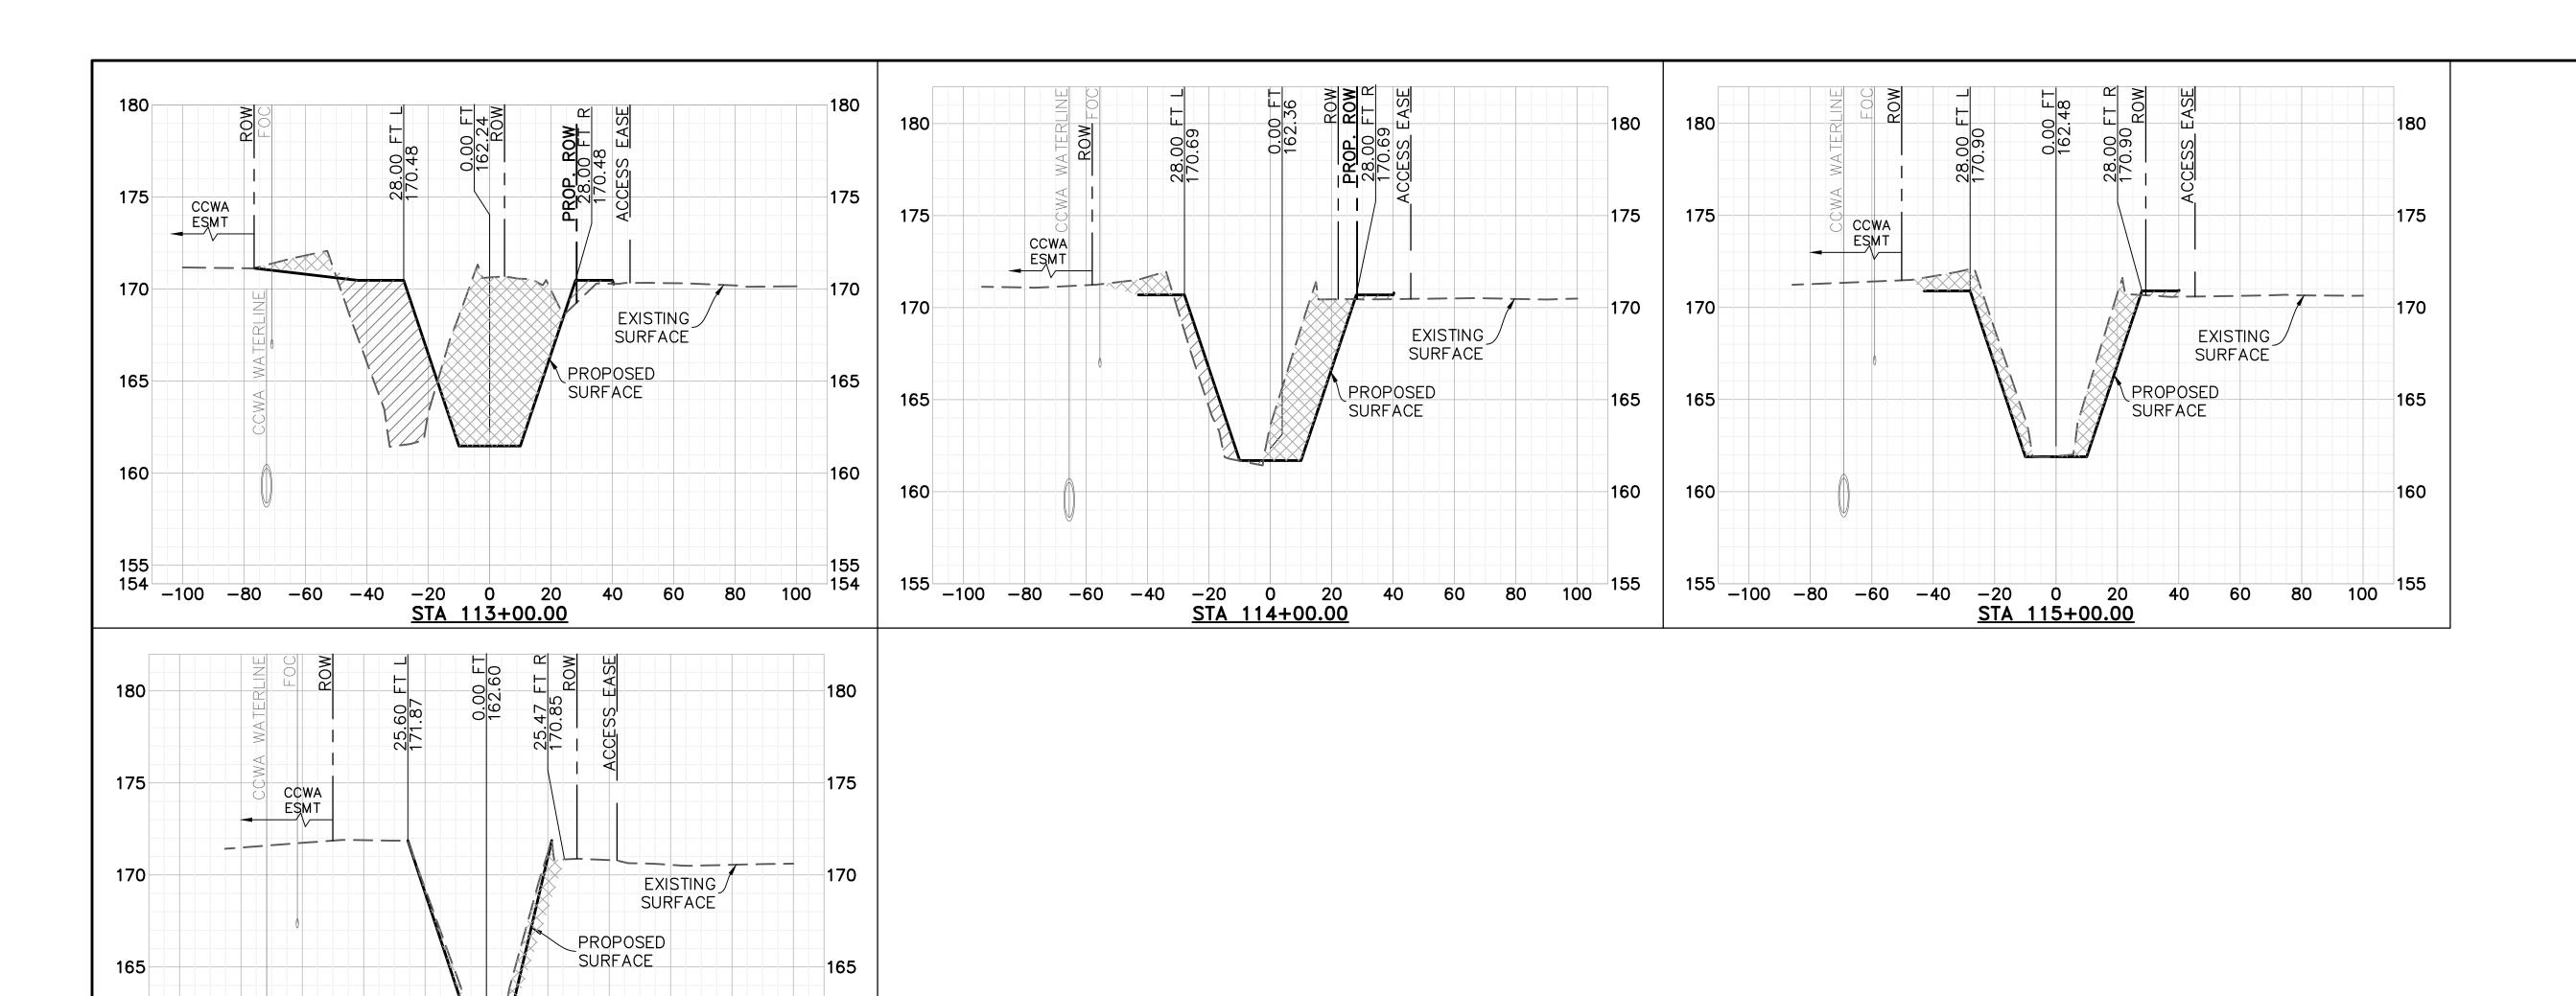

LEGEND

SCALE: HORIZ: 1" = 30'VERT: 1" = 5'

EXCAVATION

COMPACTED

NOTE: CROSS SECTION VIEWS ARE **FACING UPSTREAM**

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REVISIONS DATE APR DESCRIPTION

155 -100 -80 -60 -40 -20 0 20 40 60

STA 116+00.00

160

DESIGNED BY: DESIGN ENGINEER

160



SANTA BARBARA COUNTY FLOOD CONTROL AND WATER CONSERVATION DISTRIC 130 E. VICTORIA STREET SANTA BARBARA, CA 93101 (805) 568-3440




UNIT II CHANNEL DRAINAGE IMPROVEMENTS PROJECT


AREA OF SANTA MARIA SANTA BARBARA COUNTY, CALIFORNIA

CROSS SECTIONS
STA. 113+00 TO 116+00

NO 37253


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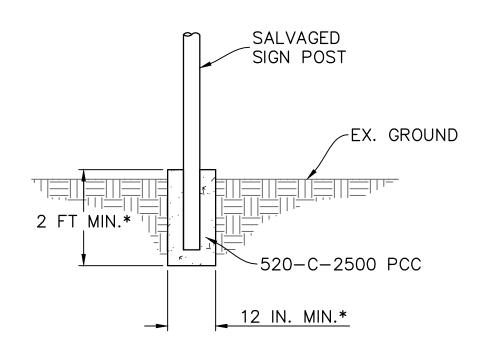


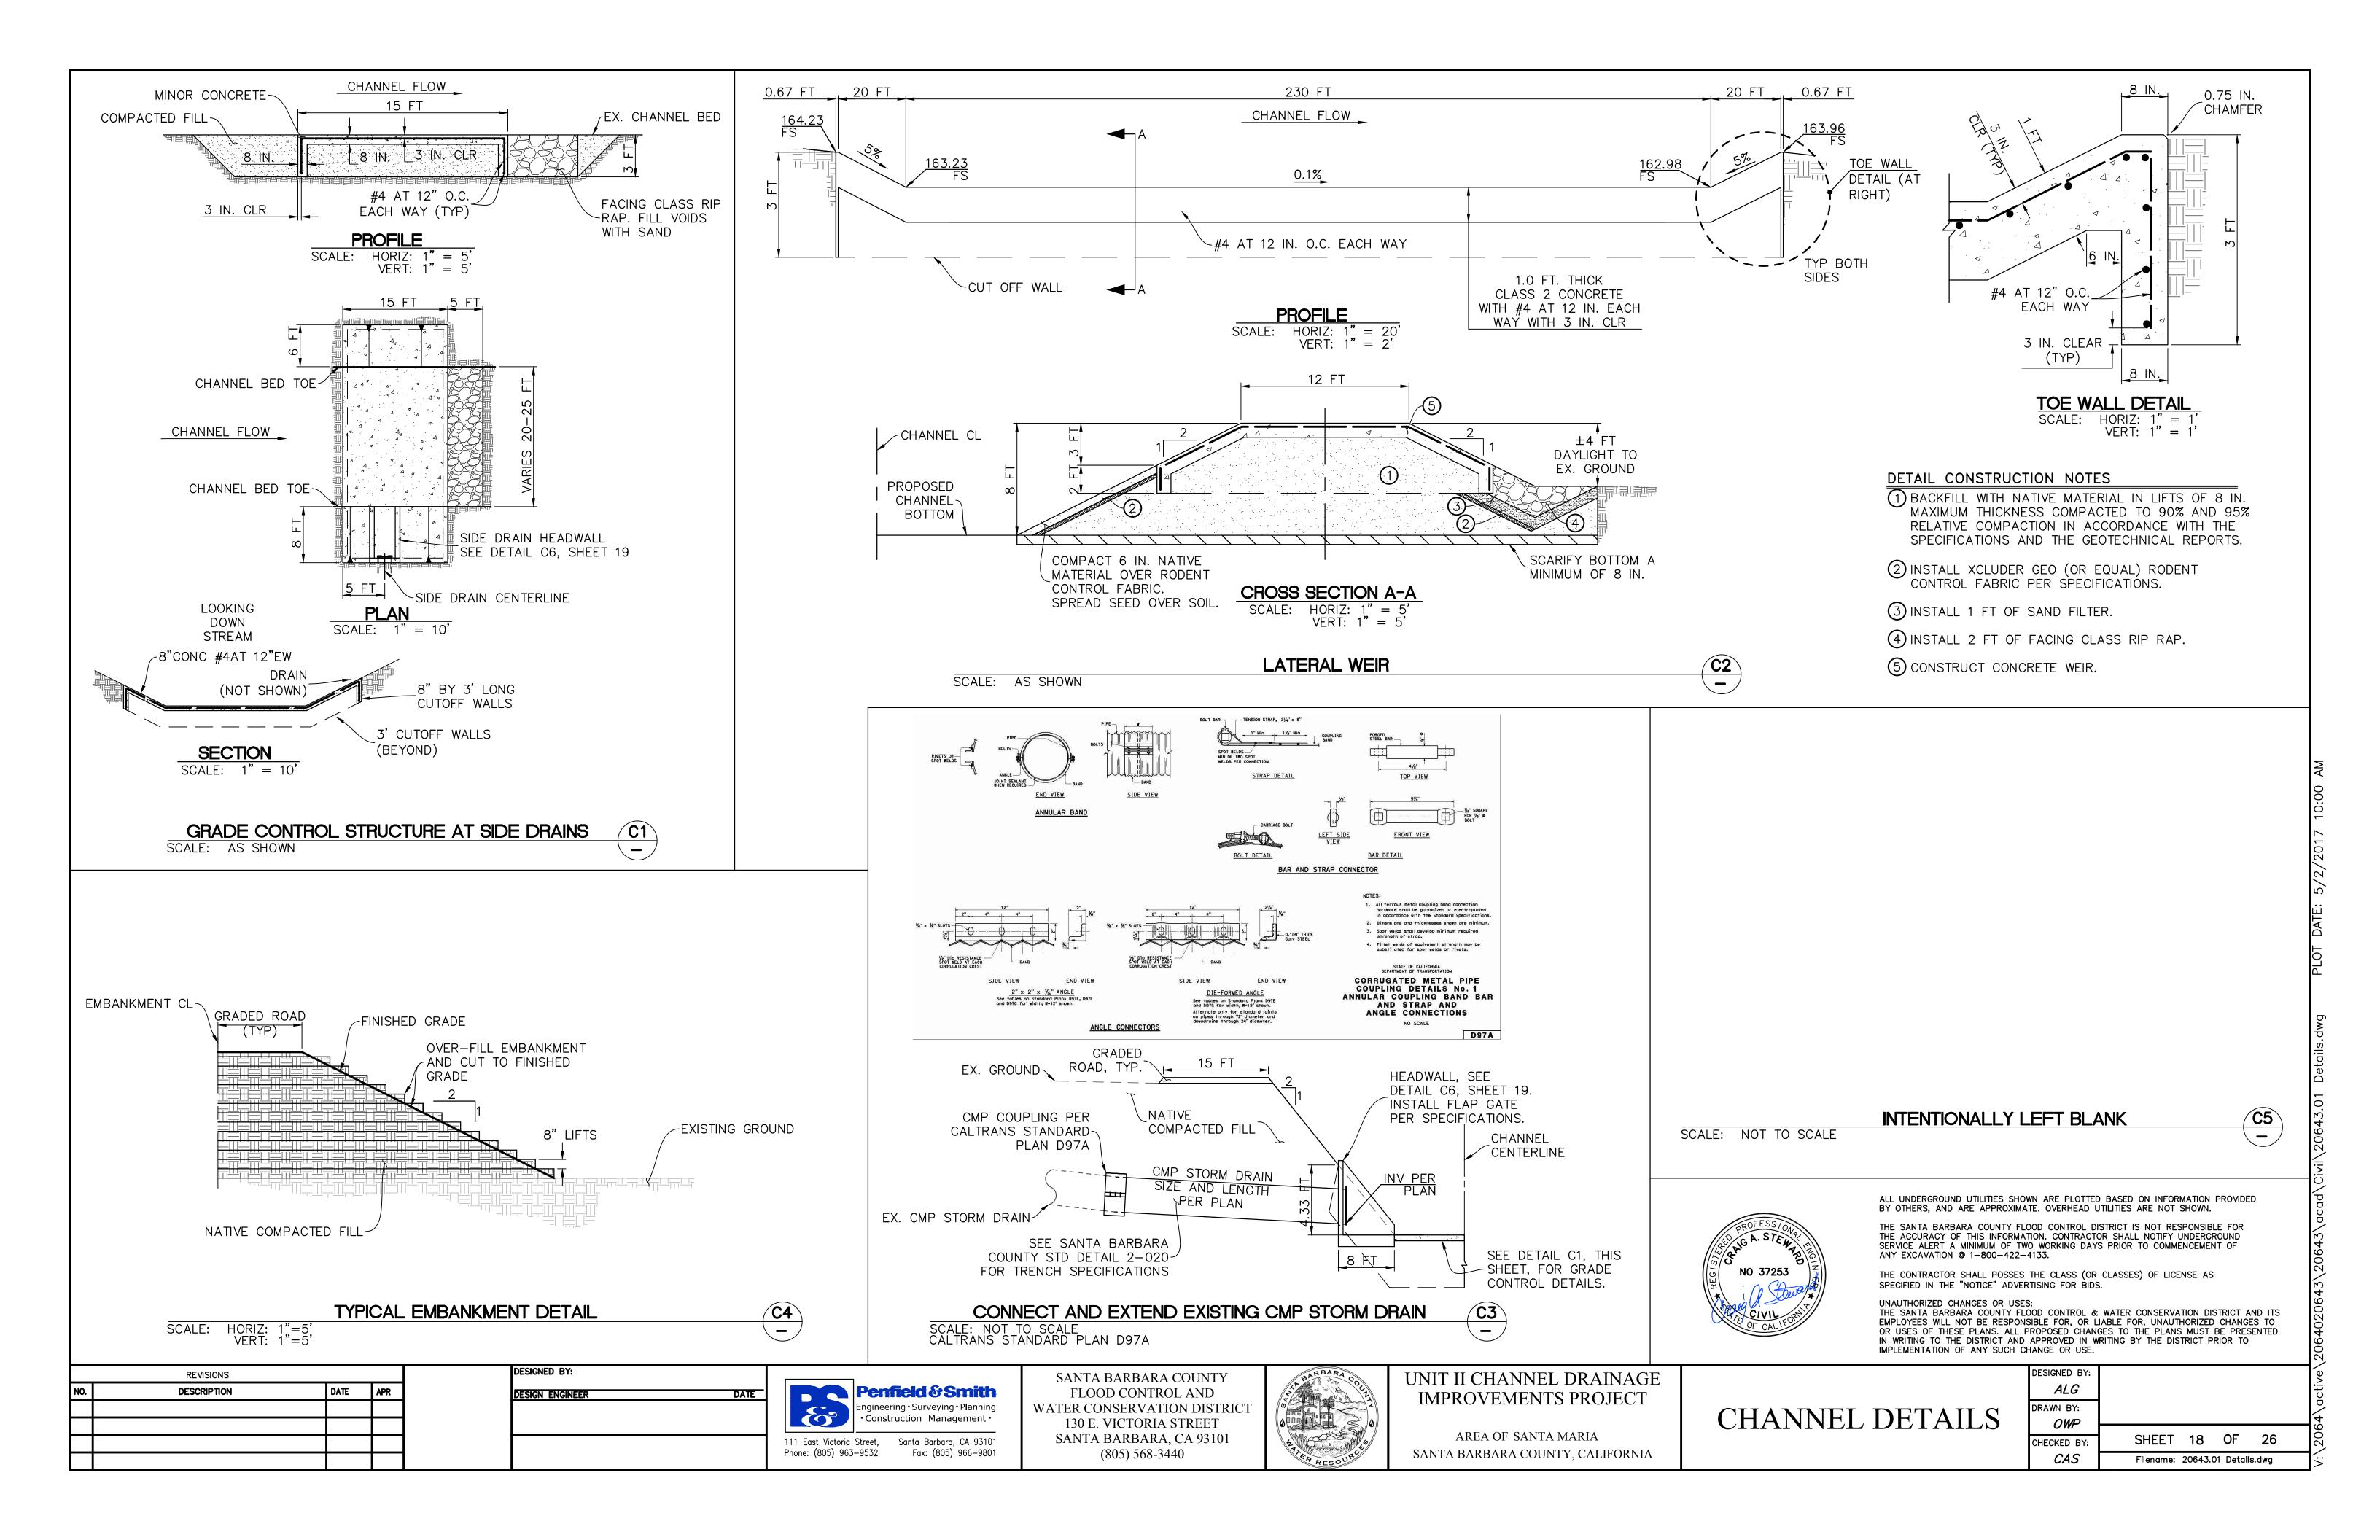
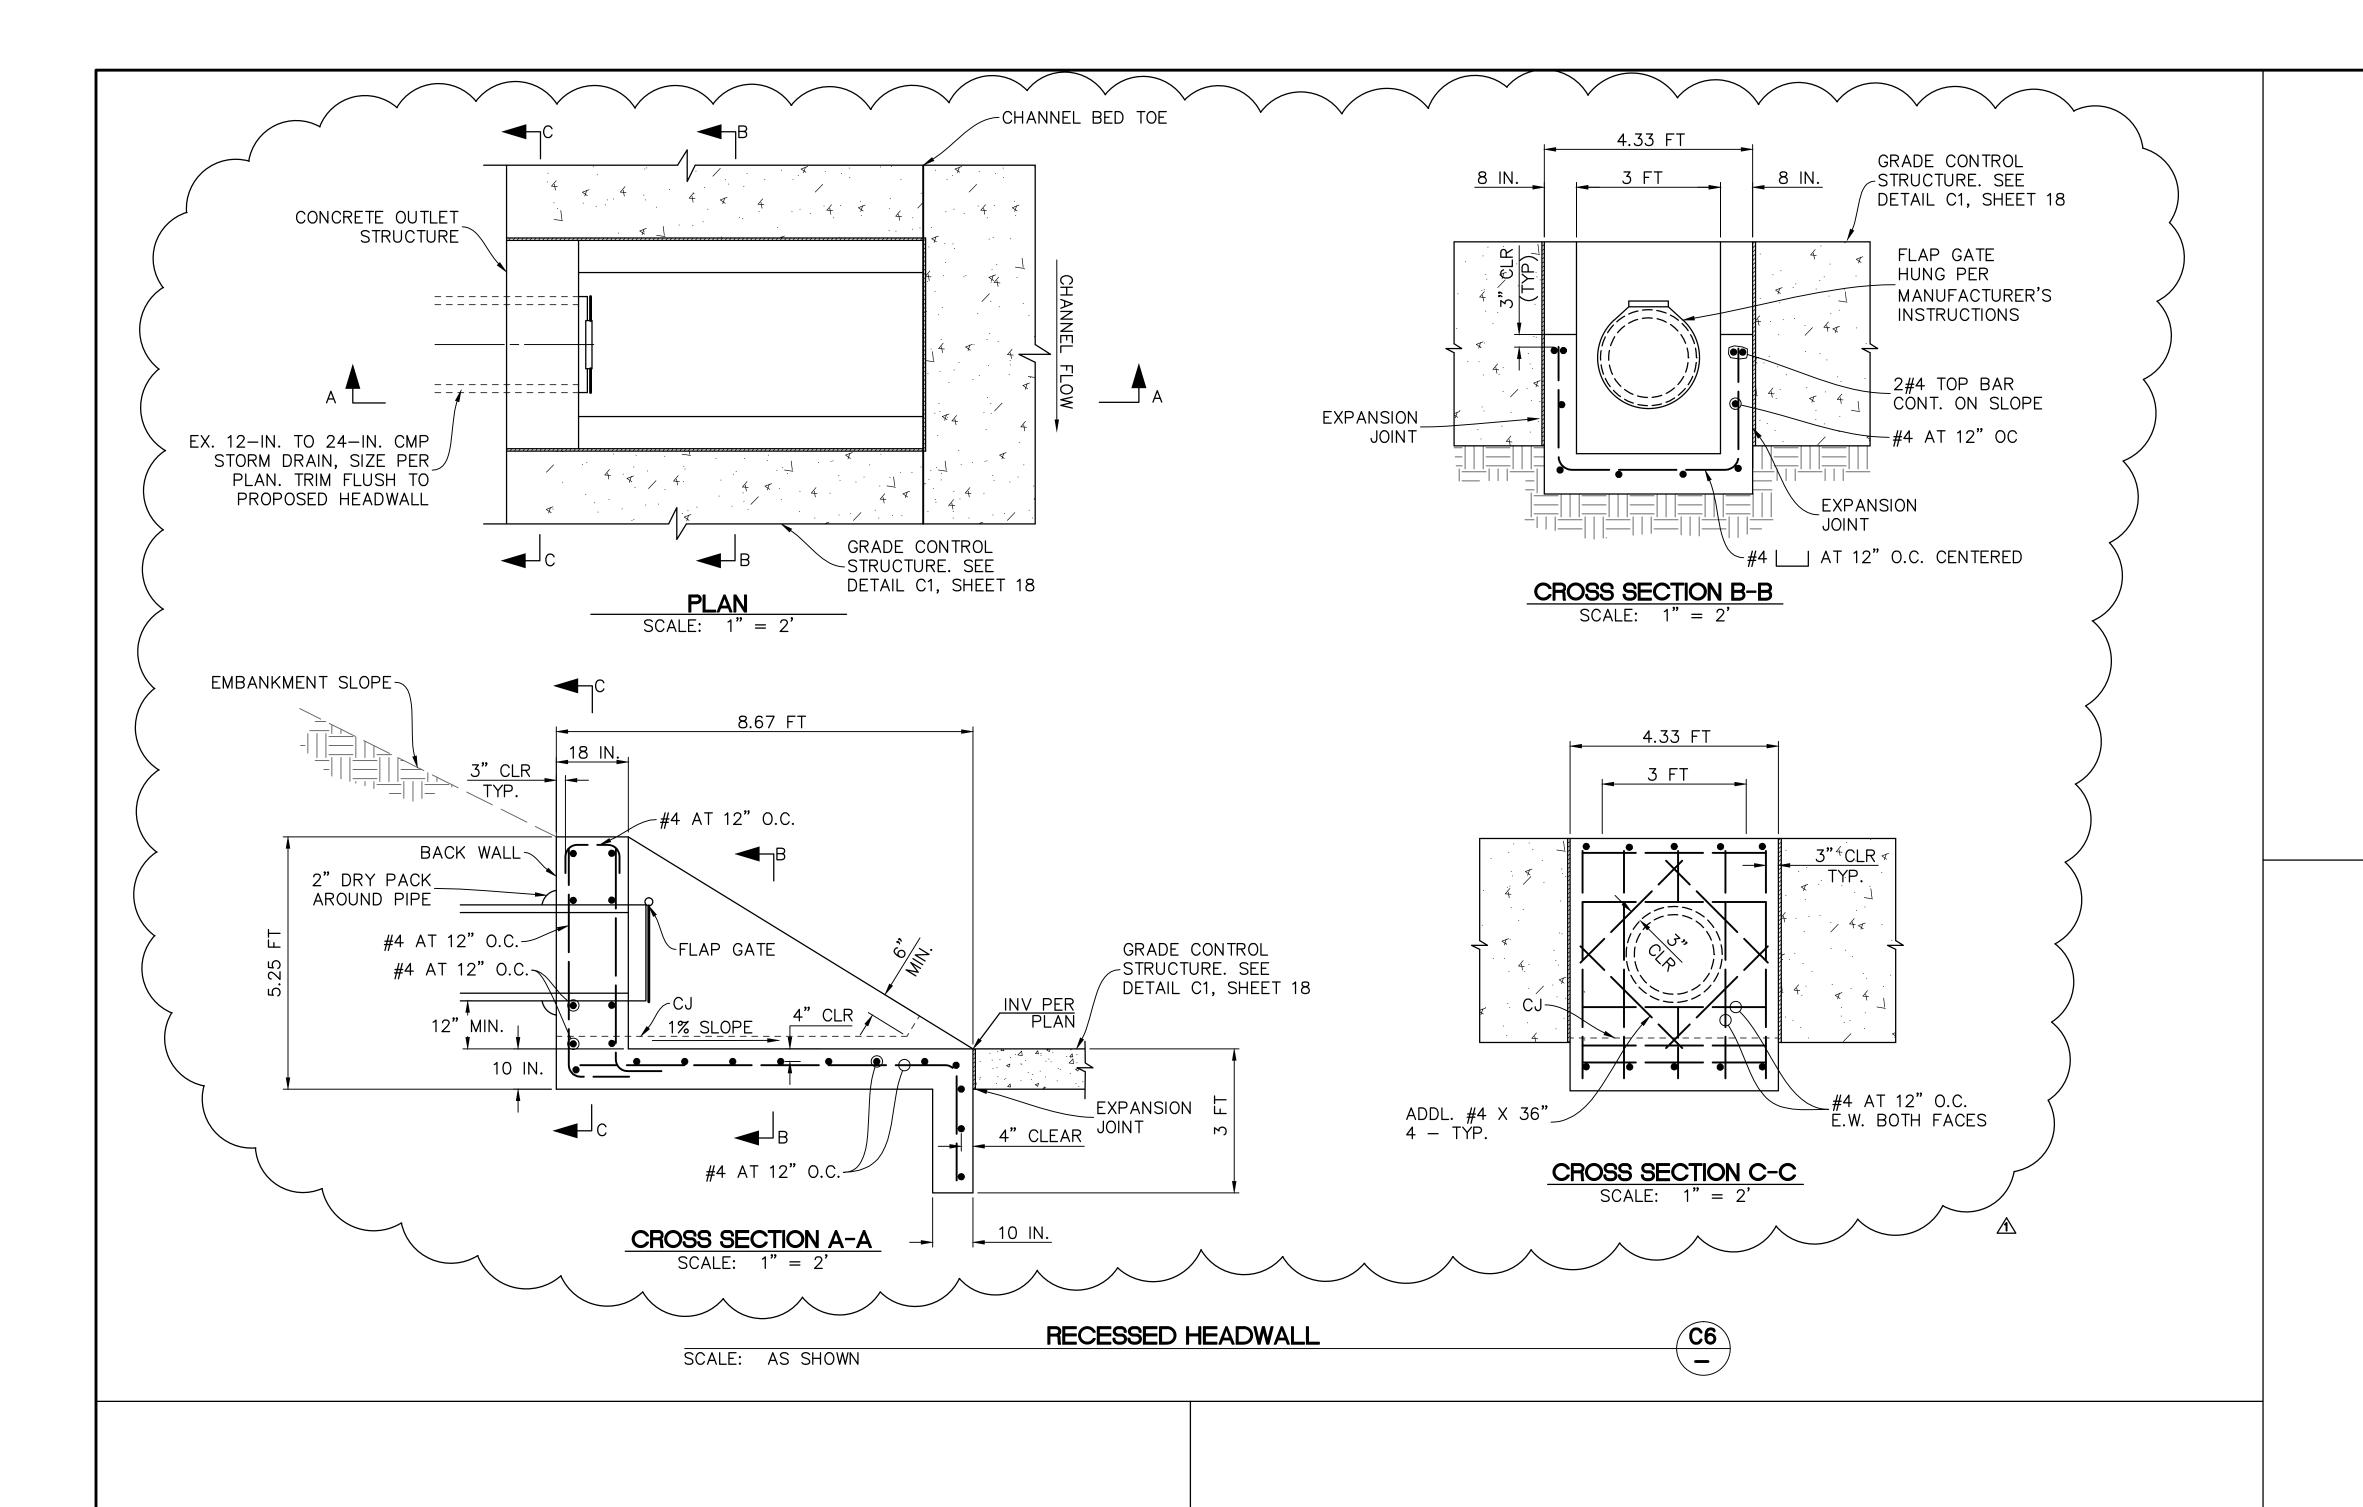
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* OR MATCH EXISTING, WHICHEVER IS GREATER



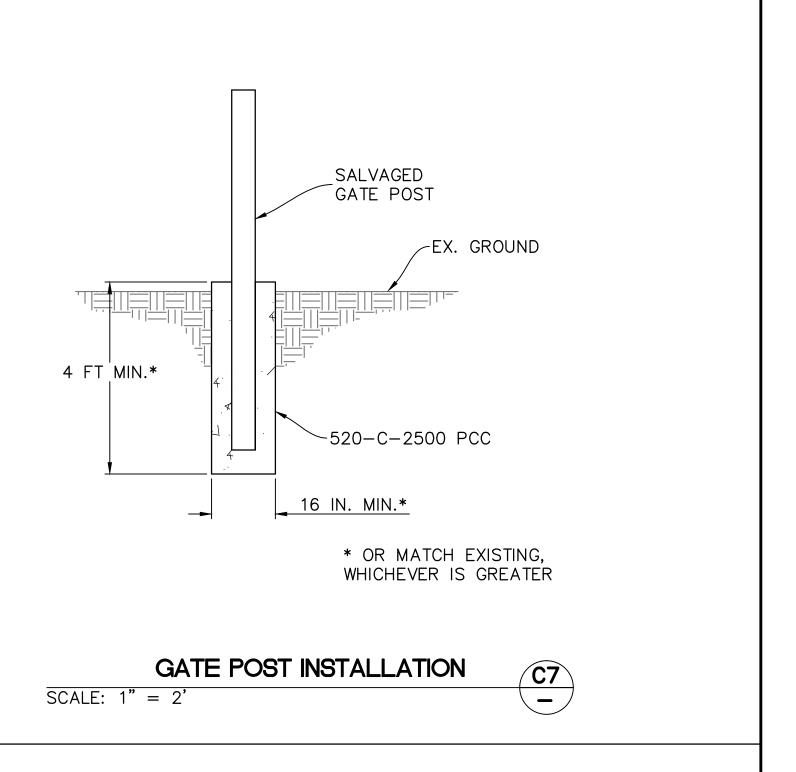

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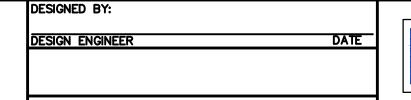
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Filename: 20643.01 Details.dwg

HANNEL DETAILS	DESIGNED BY: ALG					
	DRAWN BY:					
	OWP CHECKED BY:	SHEET	19	OF	26	

REVISIONS		
DESCRIPTION	DATE	APR
ED RECESSED HEADWALL DETAIL	09/12/2016	MJM






Phone: (805) 963-9532 Fax: (805) 966-9801


SANTA BARBARA COUNTY FLOOD CONTROL AND WATER CONSERVATION DISTRIC 130 E. VICTORIA STREET SANTA BARBARA, CA 93101 (805) 568-3440



UNIT II CHANNEL DRAINAGE IMPROVEMENTS PROJECT

AREA OF SANTA MARIA SANTA BARBARA COUNTY, CALIFORNIA

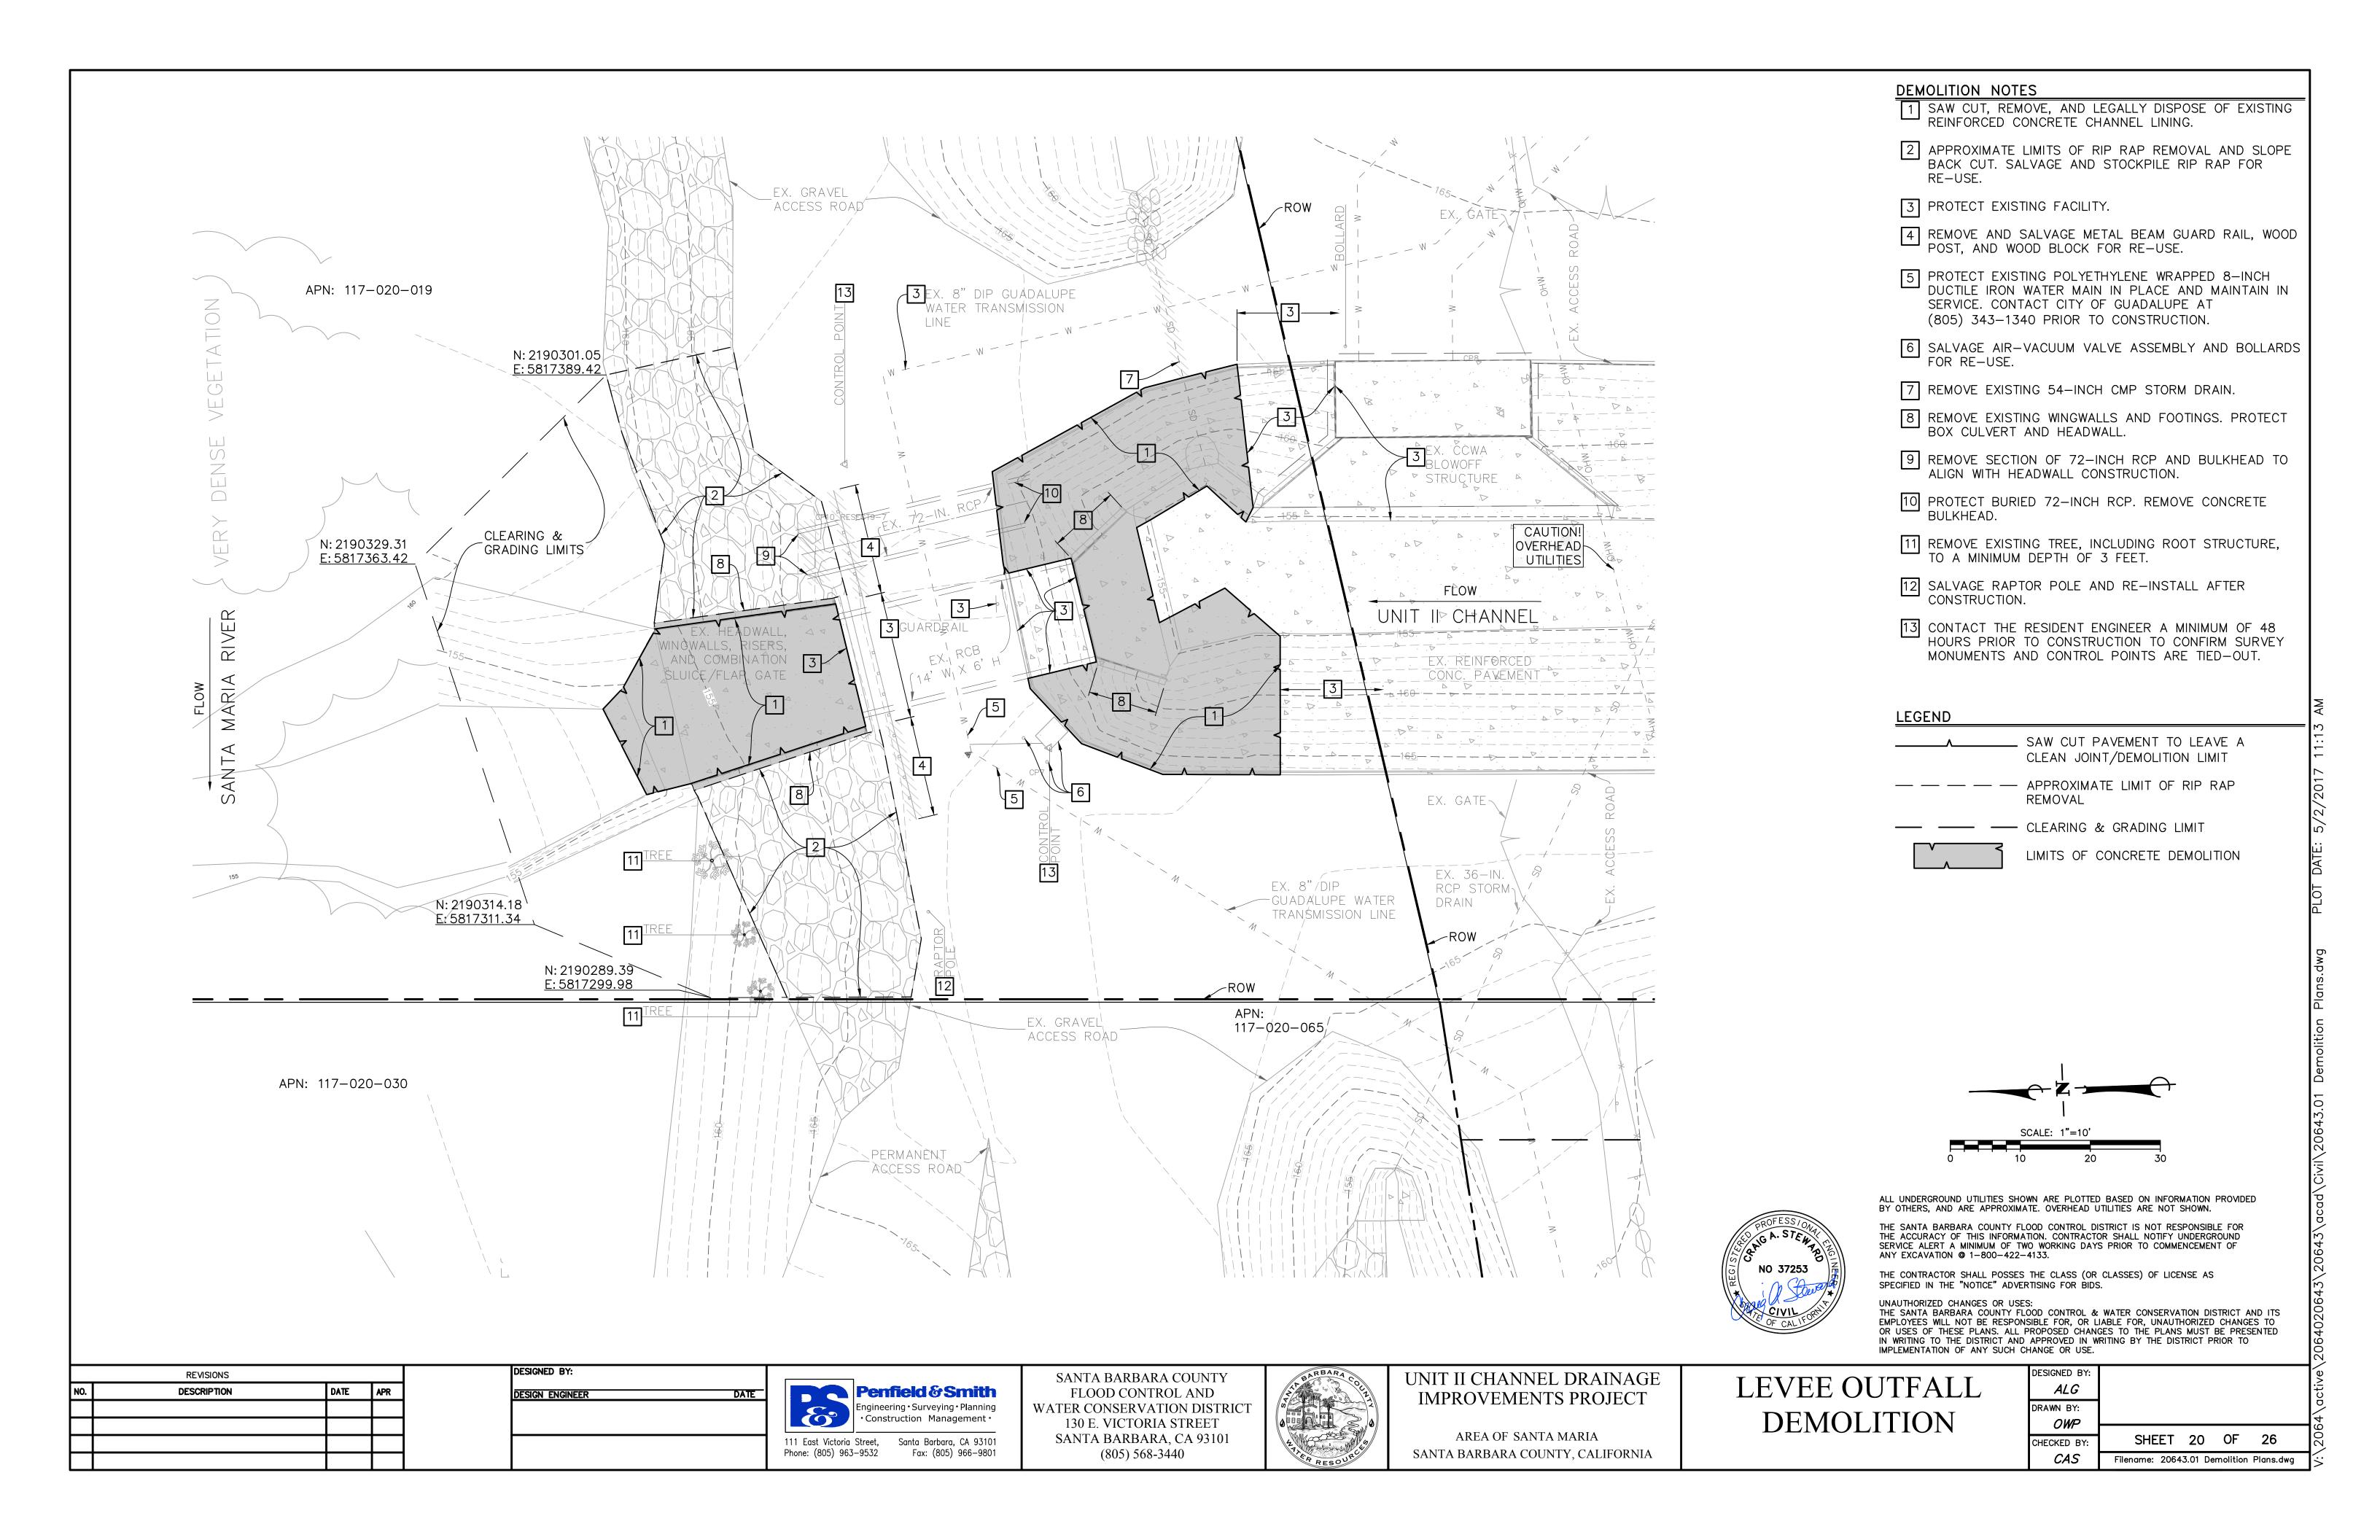

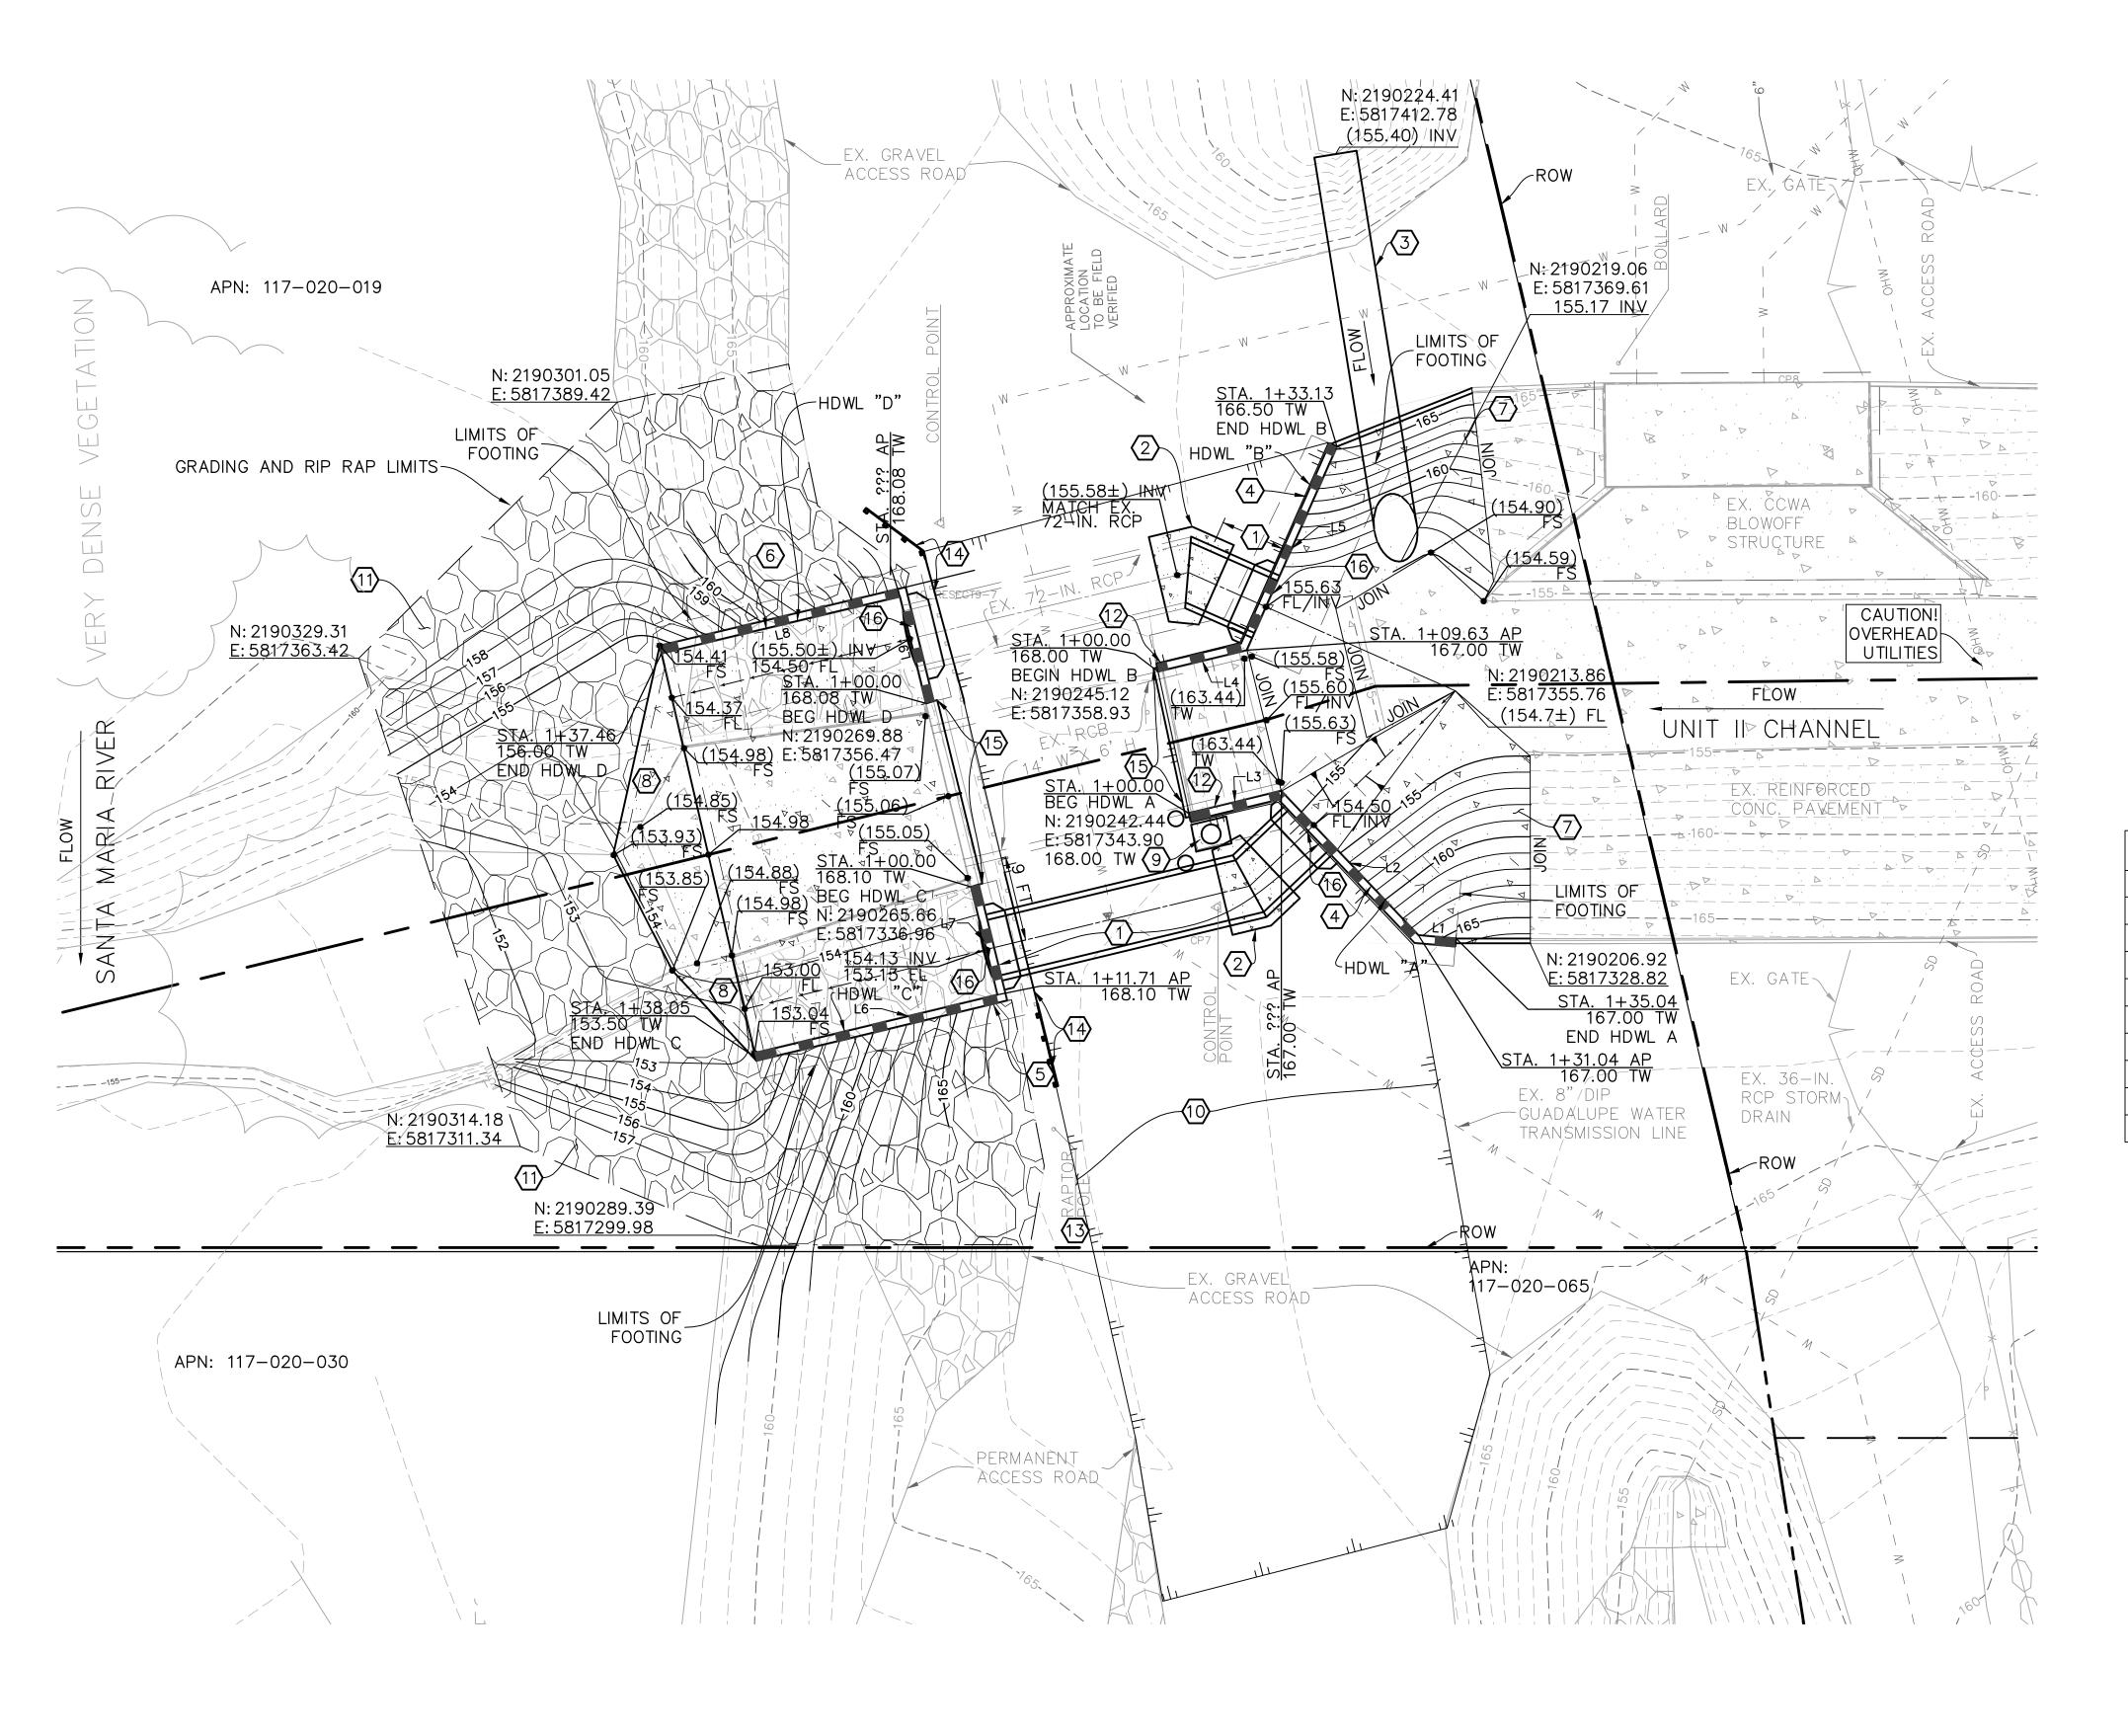


LINE TABLE					
LINE	BEARING	DISTANCE			
L1	S7*09'41"W	4.00'			
L2	S48°34'18"W	21.00'			
L3	S11°25'42"E	10.04'			
L4	S11°25'42"E	9.63'			
L5	S64°00'18"E	23.50'			
L6	N11*24'01"W	26.34'			
L7	S78°21'30"W	11.71'			
L8	N11°17'58"W	25.86'			
L9	N78°20'27"E	11.60'			

NO 37253

CONSTRUCTION NOTES

- (1) CONSTRUCT 72-INCH CLASS III RCP WITH RUBBER GASKET JOINTS PER TRENCH DETAIL L8, SHEET 23, AND PROFILES L1 & L2 ON SHEET 22. BEVEL END TO ACHIEVE A MAXIMUM GAP OF 6 IN. BETWEEN PIPES.
- (2) CONSTRUCT CONCRETE COLLAR FOR RCP PER APWA STANDARD PLAN 380-4. SEE DETAIL L12, SHEET 24.
- (3) CONSTRUCT 54-INCH CMP CULVERT PER TRENCH DETAIL L8, SHEET 23, AND PROFILE L15 ON SHEET 25.
- 4 CONSTRUCT REINFORCED CONCRETE HEADWALL PER DETAIL L20 ON SHEET 25. SEE SECTION L5 ON SHEET
- 5 CONSTRUCT REINFORCED CONCRETE HEADWALL PER DETAIL L21 ON SHEET 25 WITH 72-INCH FLAPGATE. SEE PROFILE L2 ON SHEET 22.
- 6 CONSTRUCT REINFORCED CONCRETE HEADWALL PER DETAIL L21 ON SHEET 25 WITH 72-INCH FLAPGATE. SEE PROFILE L1 ON SHEET 22.
- (7) CONSTRUCT 6-INCH THICK REINFORCED CONCRETE SLOPE PAVING PER DETAIL L16, SHEET 25.
- 8 CONSTRUCT REINFORCED CONCRETE SLOPE PAVING WITH TOEWALLS PER DETAIL L10, SHEET 24.
- 9 CONSTRUCT SALVAGED AIR-VACUUM VALVE ASSEMBLY PER DETAIL L7, SHEET 23.
- (10) CONSTRUCT 4-INCH THICK CLASS II AGGREGATE BASE COMPACTED TO 95% RELATIVE DENSITY FROM HEADWAL TO HEADWALL AND ALL DISTURBED AREAS ON TOP OF LEVEE.
- GRADE RIVERSIDE LEVEE OUTFALL AREA TO LIMITS SHOWN AND INSTALL SALVAGED RIP RAP AND IMPORTED 1/2 TON RIP RAP PER DETAIL L9, SHEET 23.
- (12) CONSTRUCT REINFORCED CONCRETE RETAINING WALL PER DETAIL L19, SHEET 25.
- (13) INSTALL SALVAGED RAPTOR POLE PER DETAIL L11, SHEET 24.
- 14 INSTALL SALVAGED METAL BEAM GUARDRAIL PER CALTRANS STANDARD DETAIL A77A2, DETAIL L14, SHEET 24. ADD NEW GUARDRAIL TO EXTEND MINIMUM 10' PAST HEADWALLS.
- (15) CONSTRUCT HANDRAIL PER DETAIL L13, SHEET 24.
- (16) CONSTRUCT ADDITIONAL REINFORCING AT PIPE PENETRATION AT HEADWALL PER DETAIL L18, SHEET 25. CONSTRUCT RCP CONNECTION TO HEADWALL SIMILAR TO DETAIL APWA STANDARD PLAN 308-1 MONOLITHIC CATCH BASIN CONNECTION WITH ANGLE 'A'=90°. REFERENCES TO CATCH BASIN SHALL MEAN HEADWALL. SEE DETAILS L22 & L23, SHEET 26.

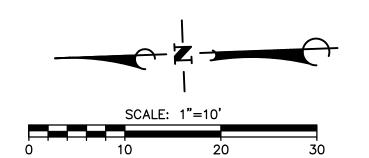

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	REVISIONS		
NO.	DESCRIPTION	DATE	APR

DESIGNED BY: DESIGN ENGINEER



Phone: (805) 963-9532 Fax: (805) 966-9801


SANTA BARBARA COUNTY FLOOD CONTROL AND WATER CONSERVATION DISTRIC 130 E. VICTORIA STREET SANTA BARBARA, CA 93101 (805) 568-3440





UNIT II CHANNEL DRAINAGE IMPROVEMENTS PROJECT


AREA OF SANTA MARIA SANTA BARBARA COUNTY, CALIFORNIA LEVEE OUTFALI **PLAN**


_	DESIGNED BY:	
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	CAS	Filename: 20643.01 Levee Plans.dwg

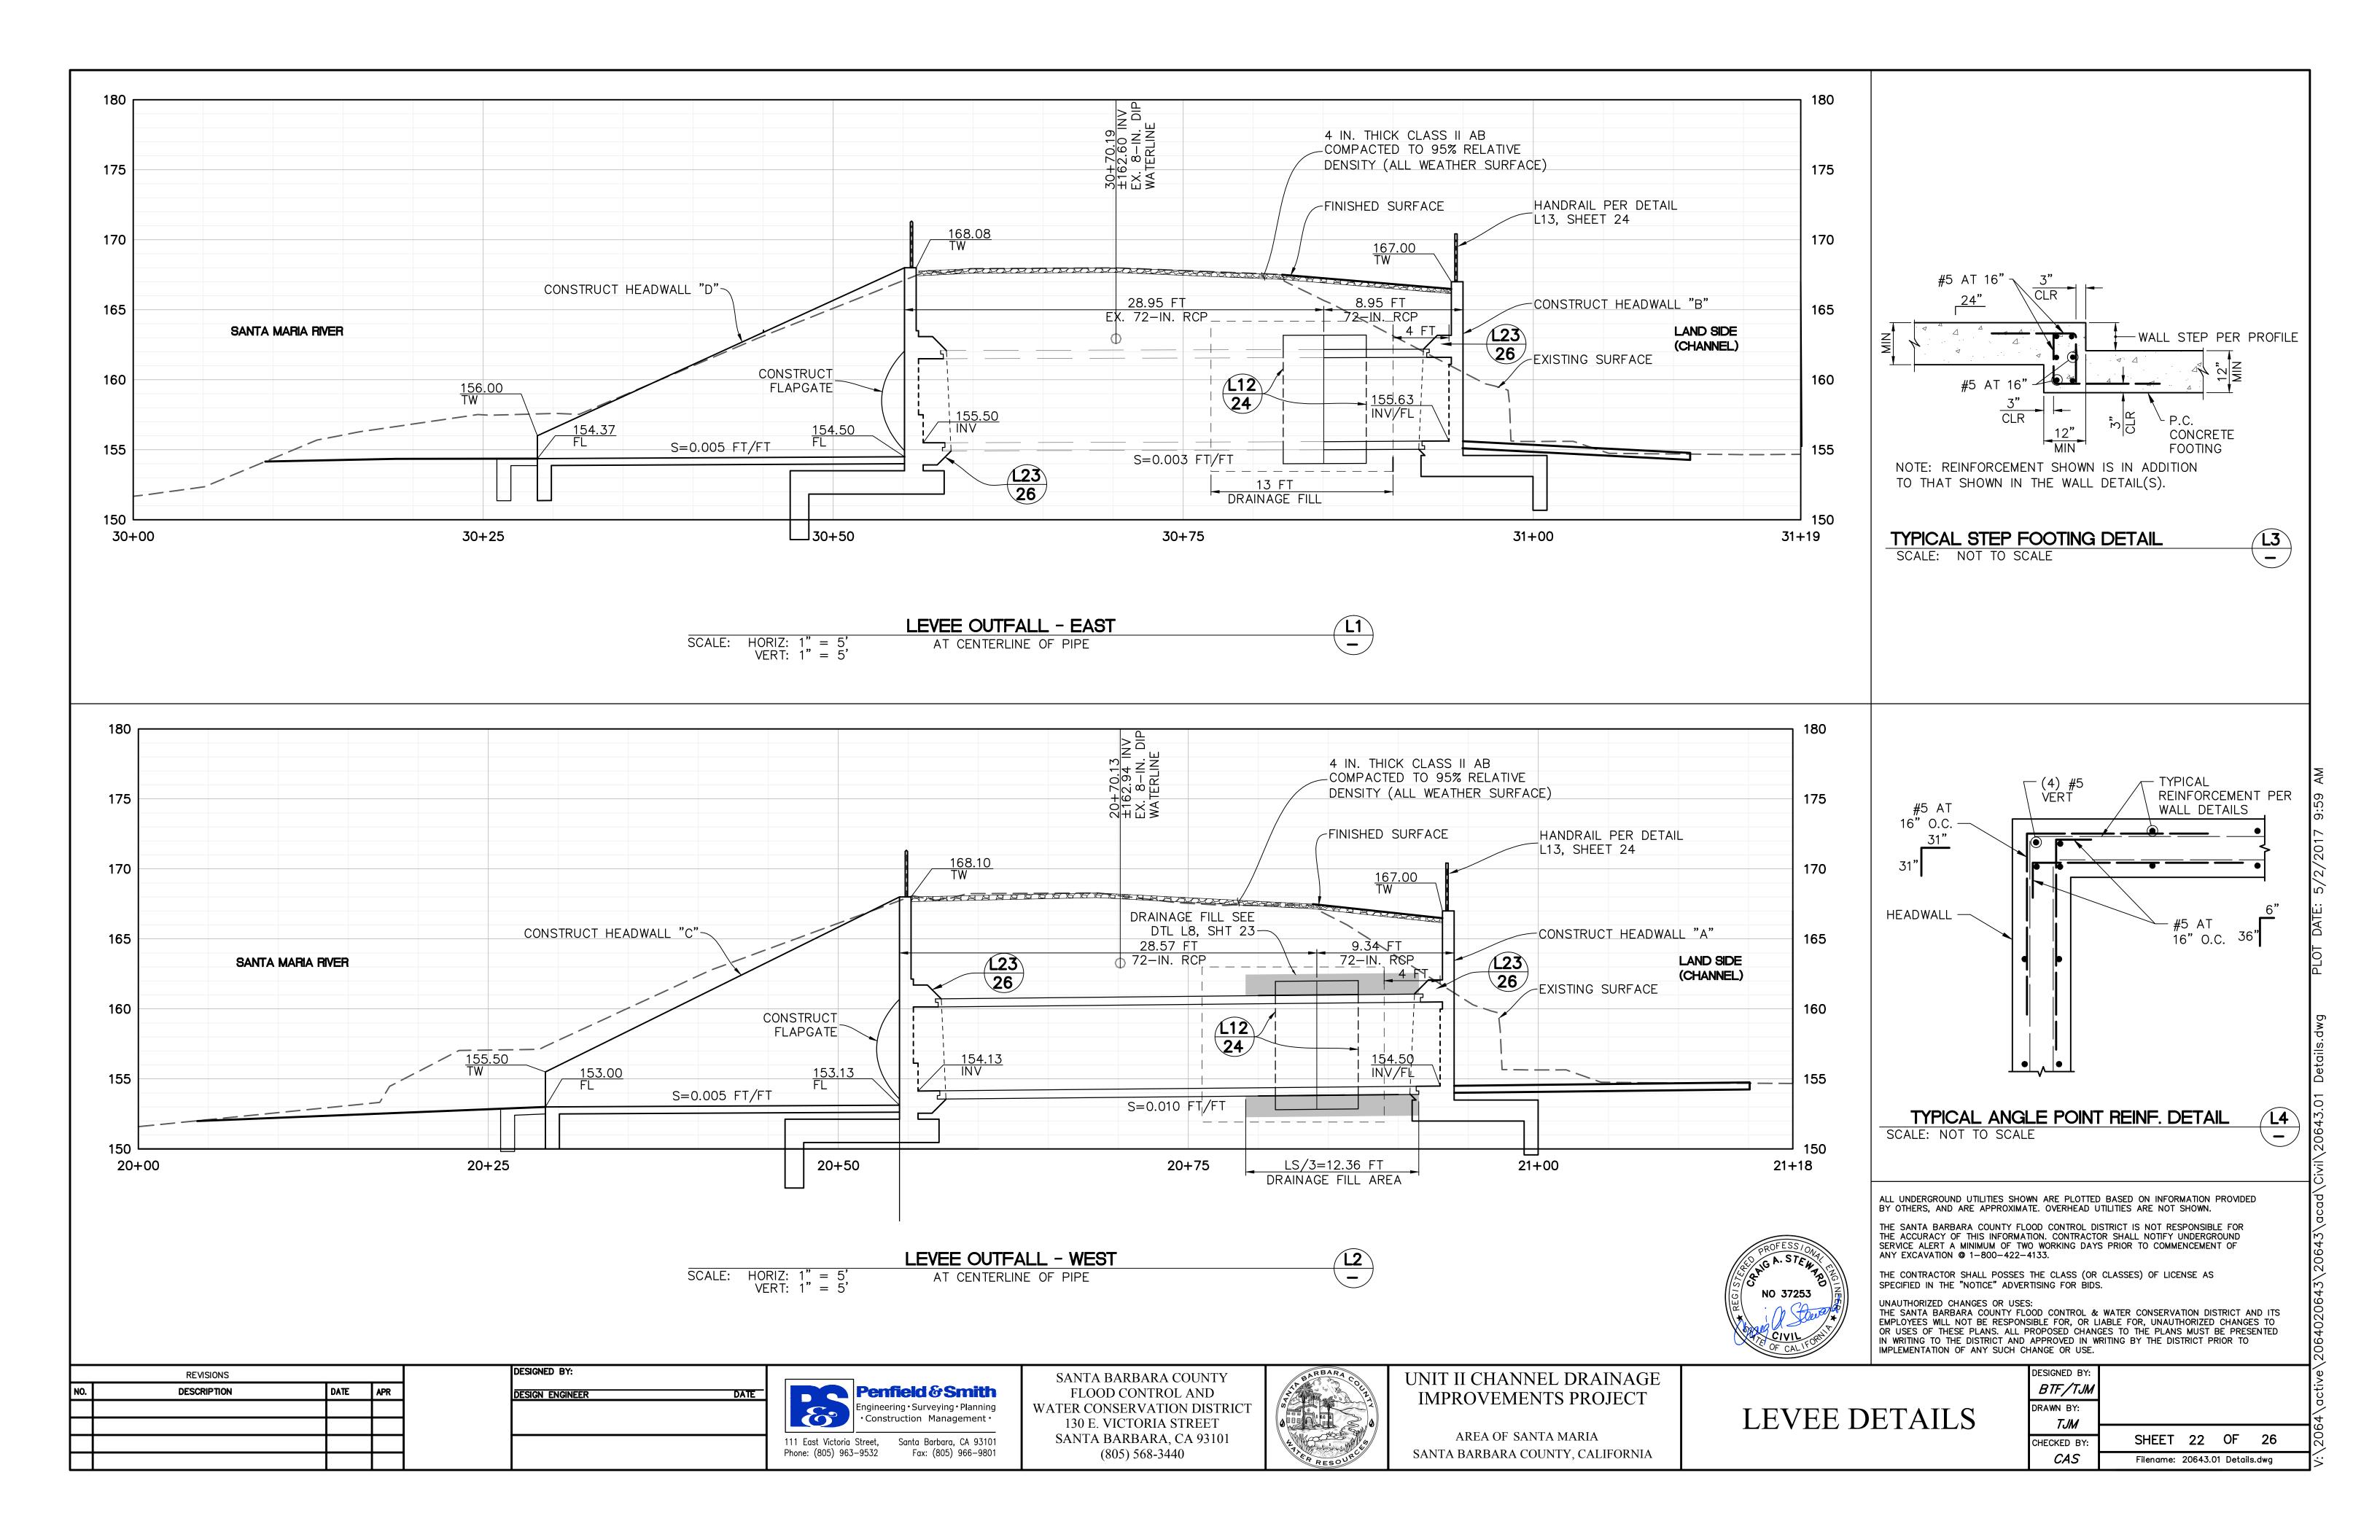

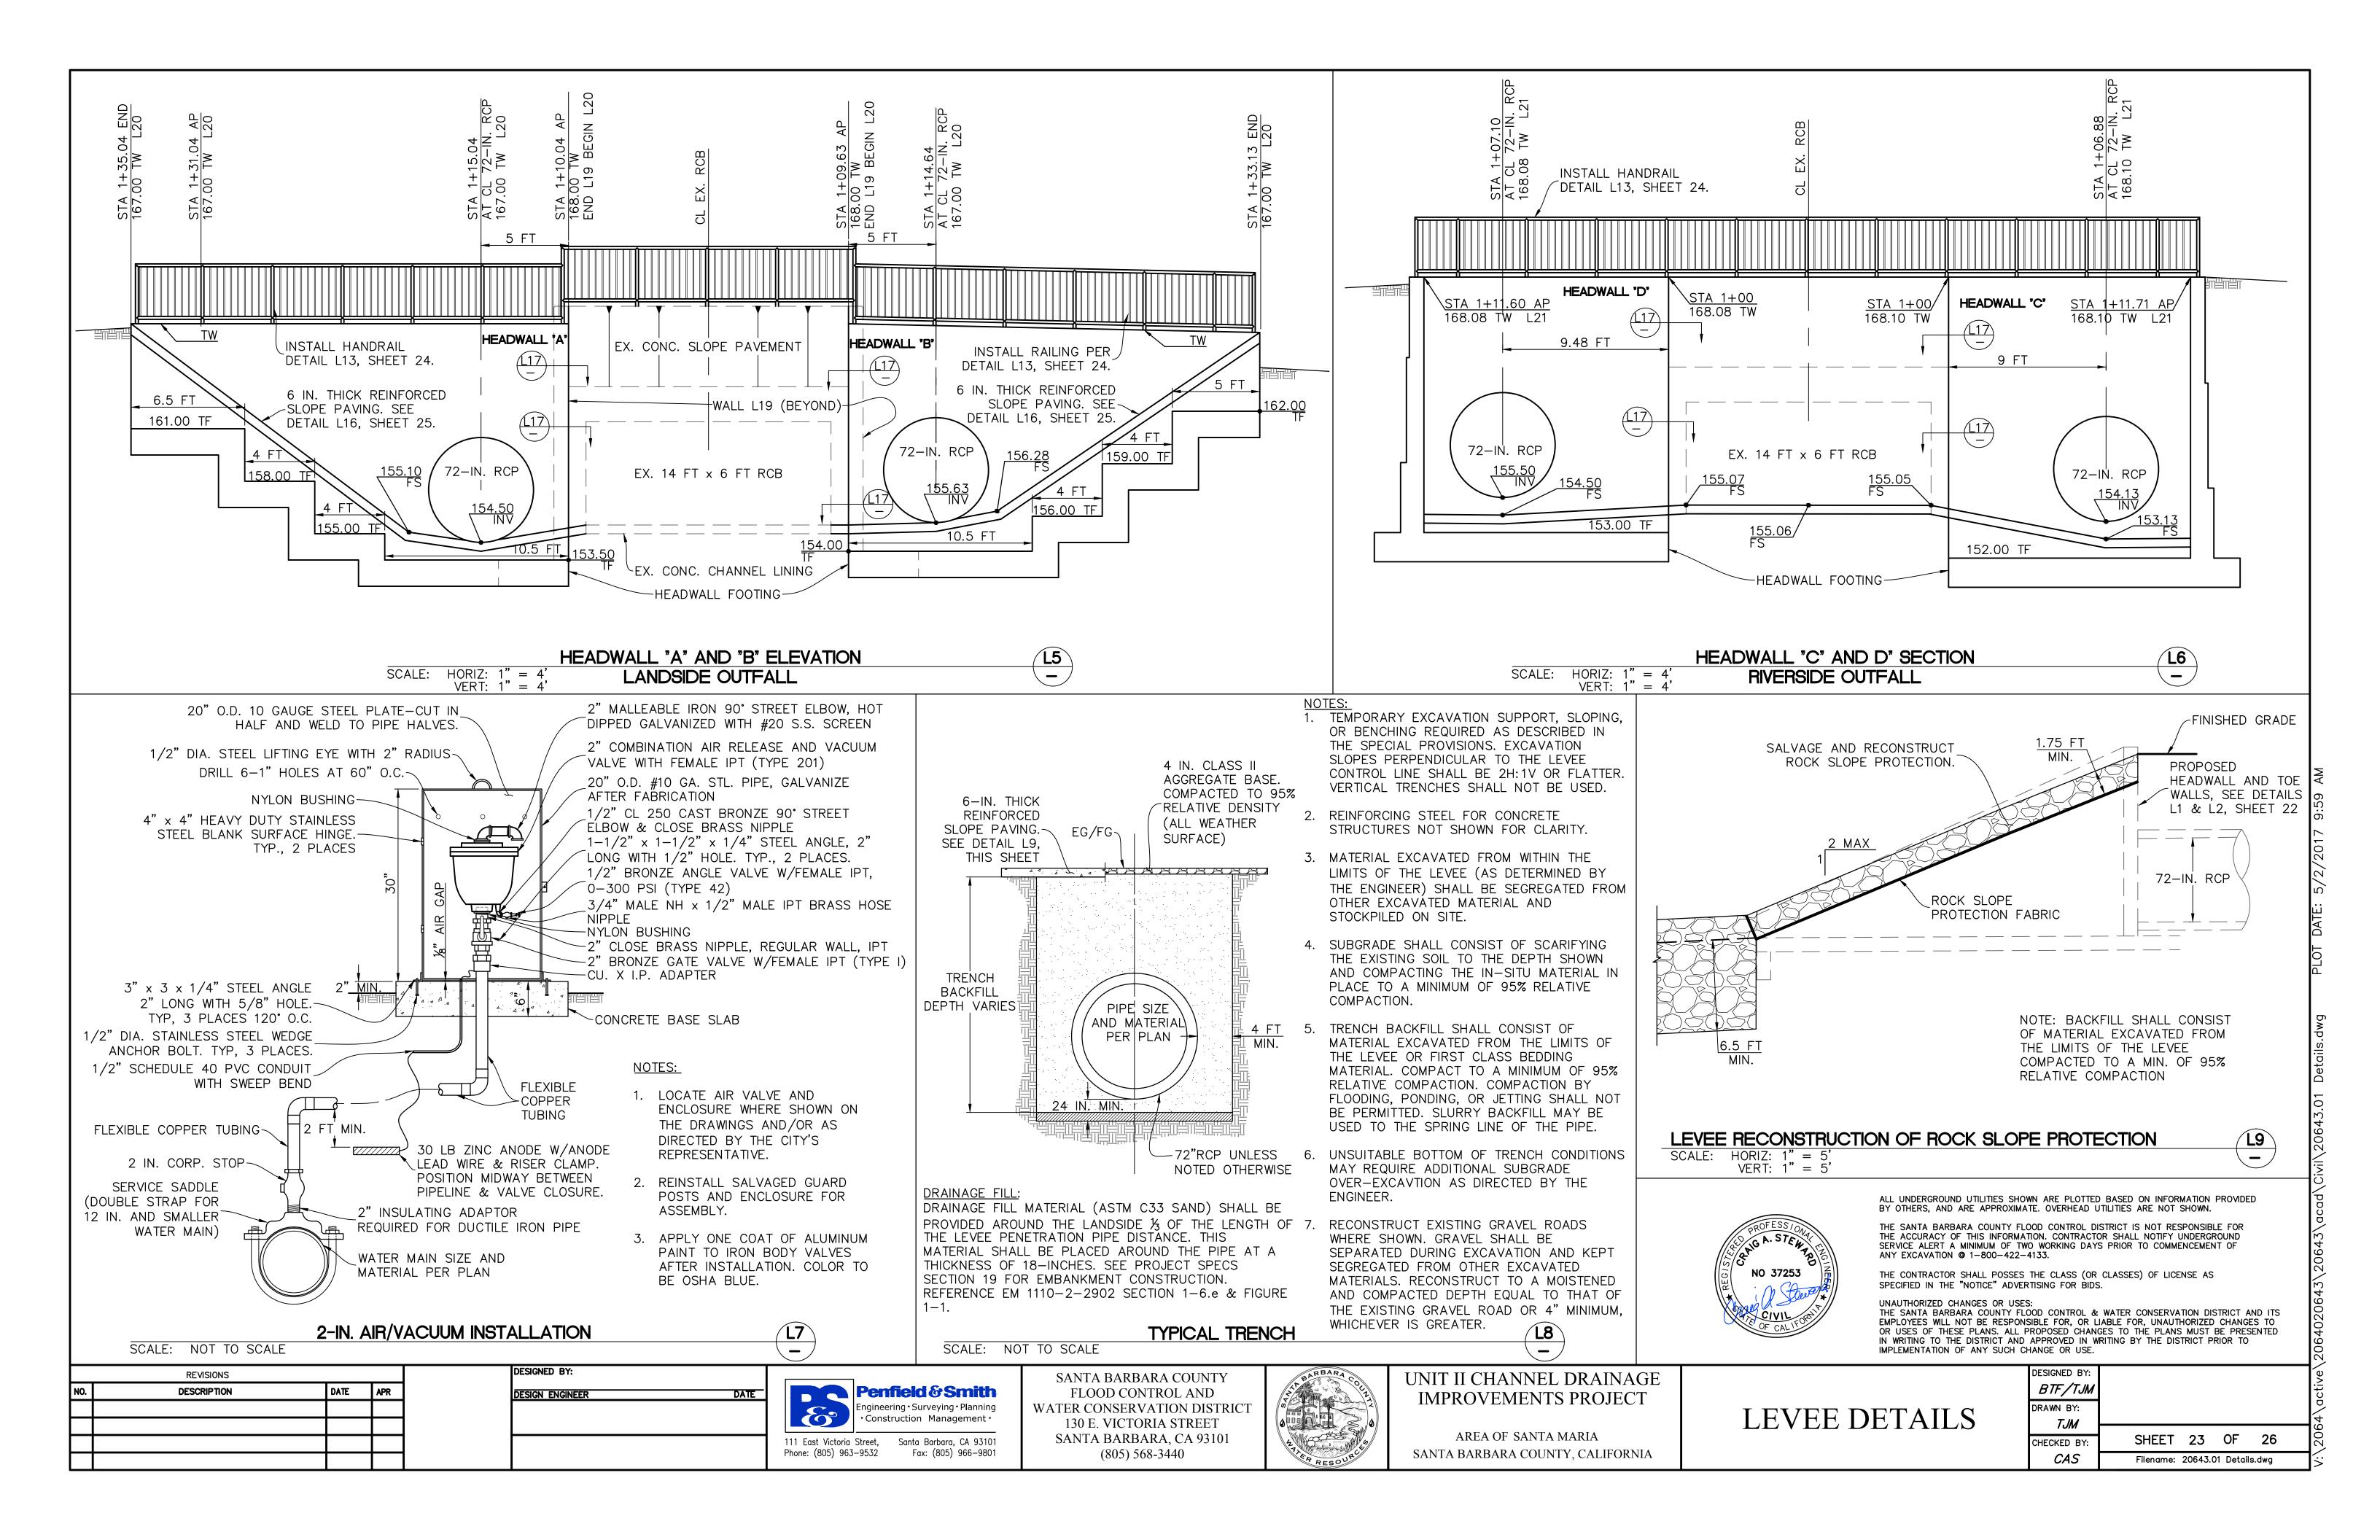


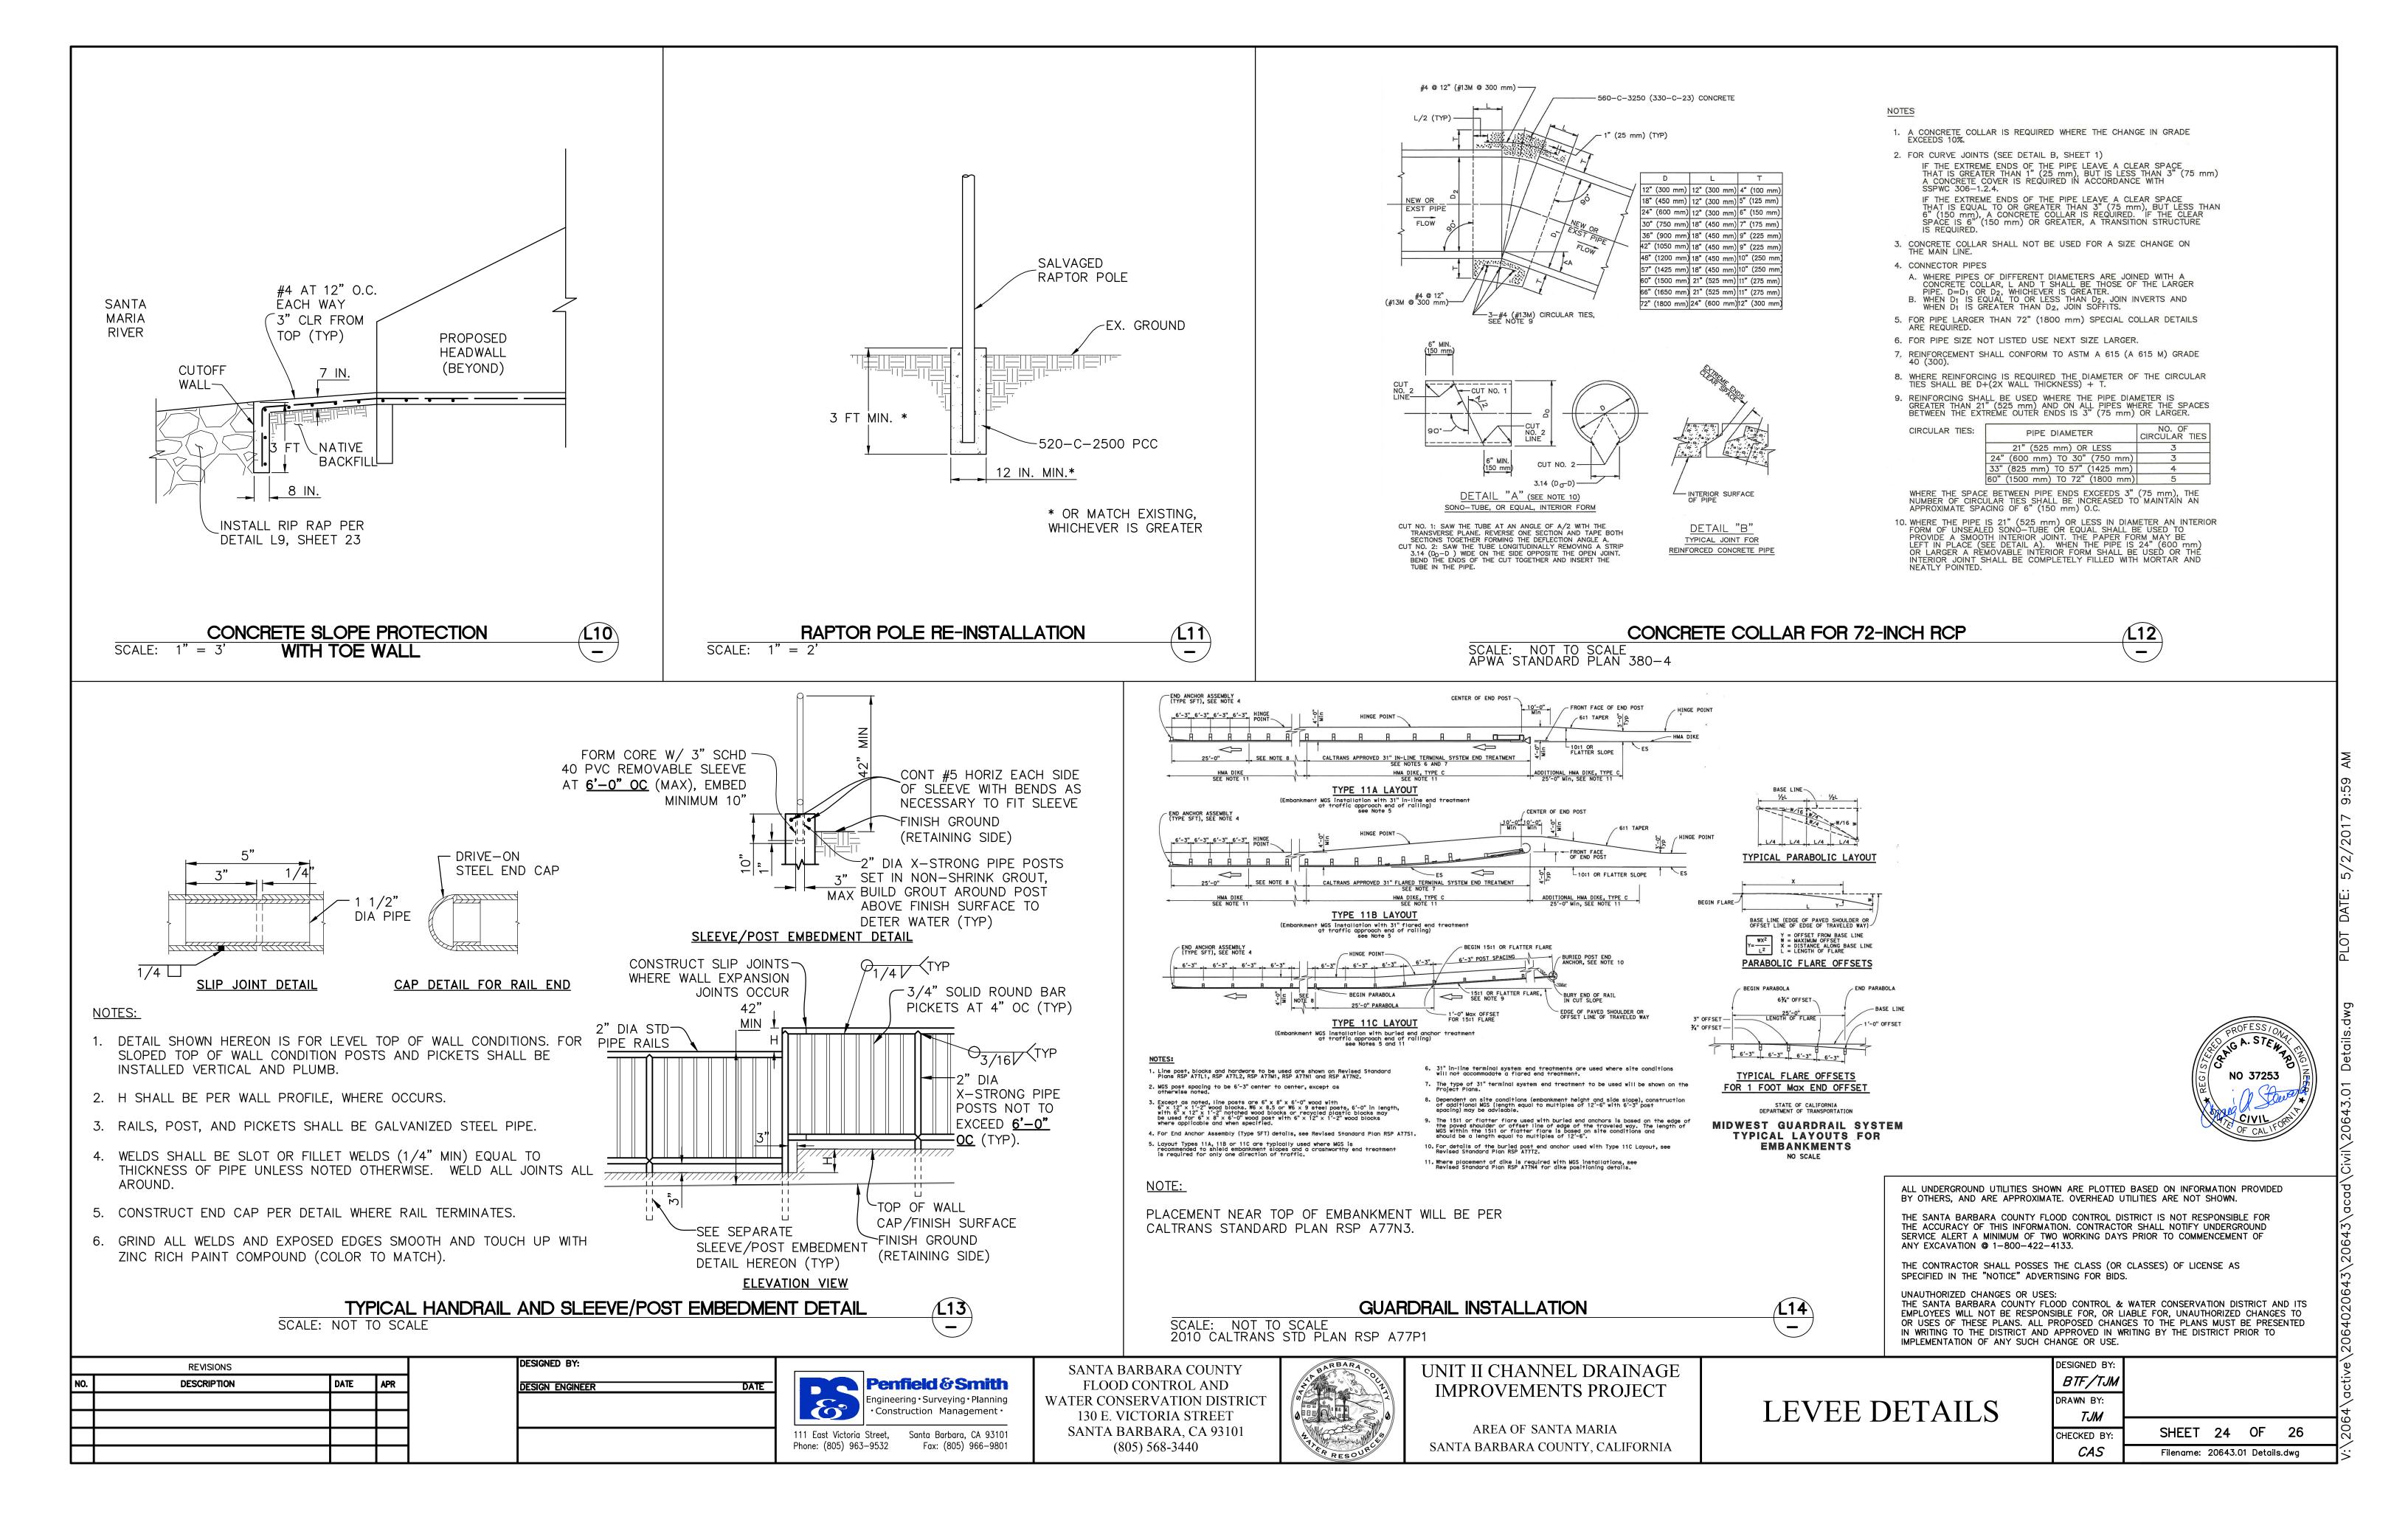


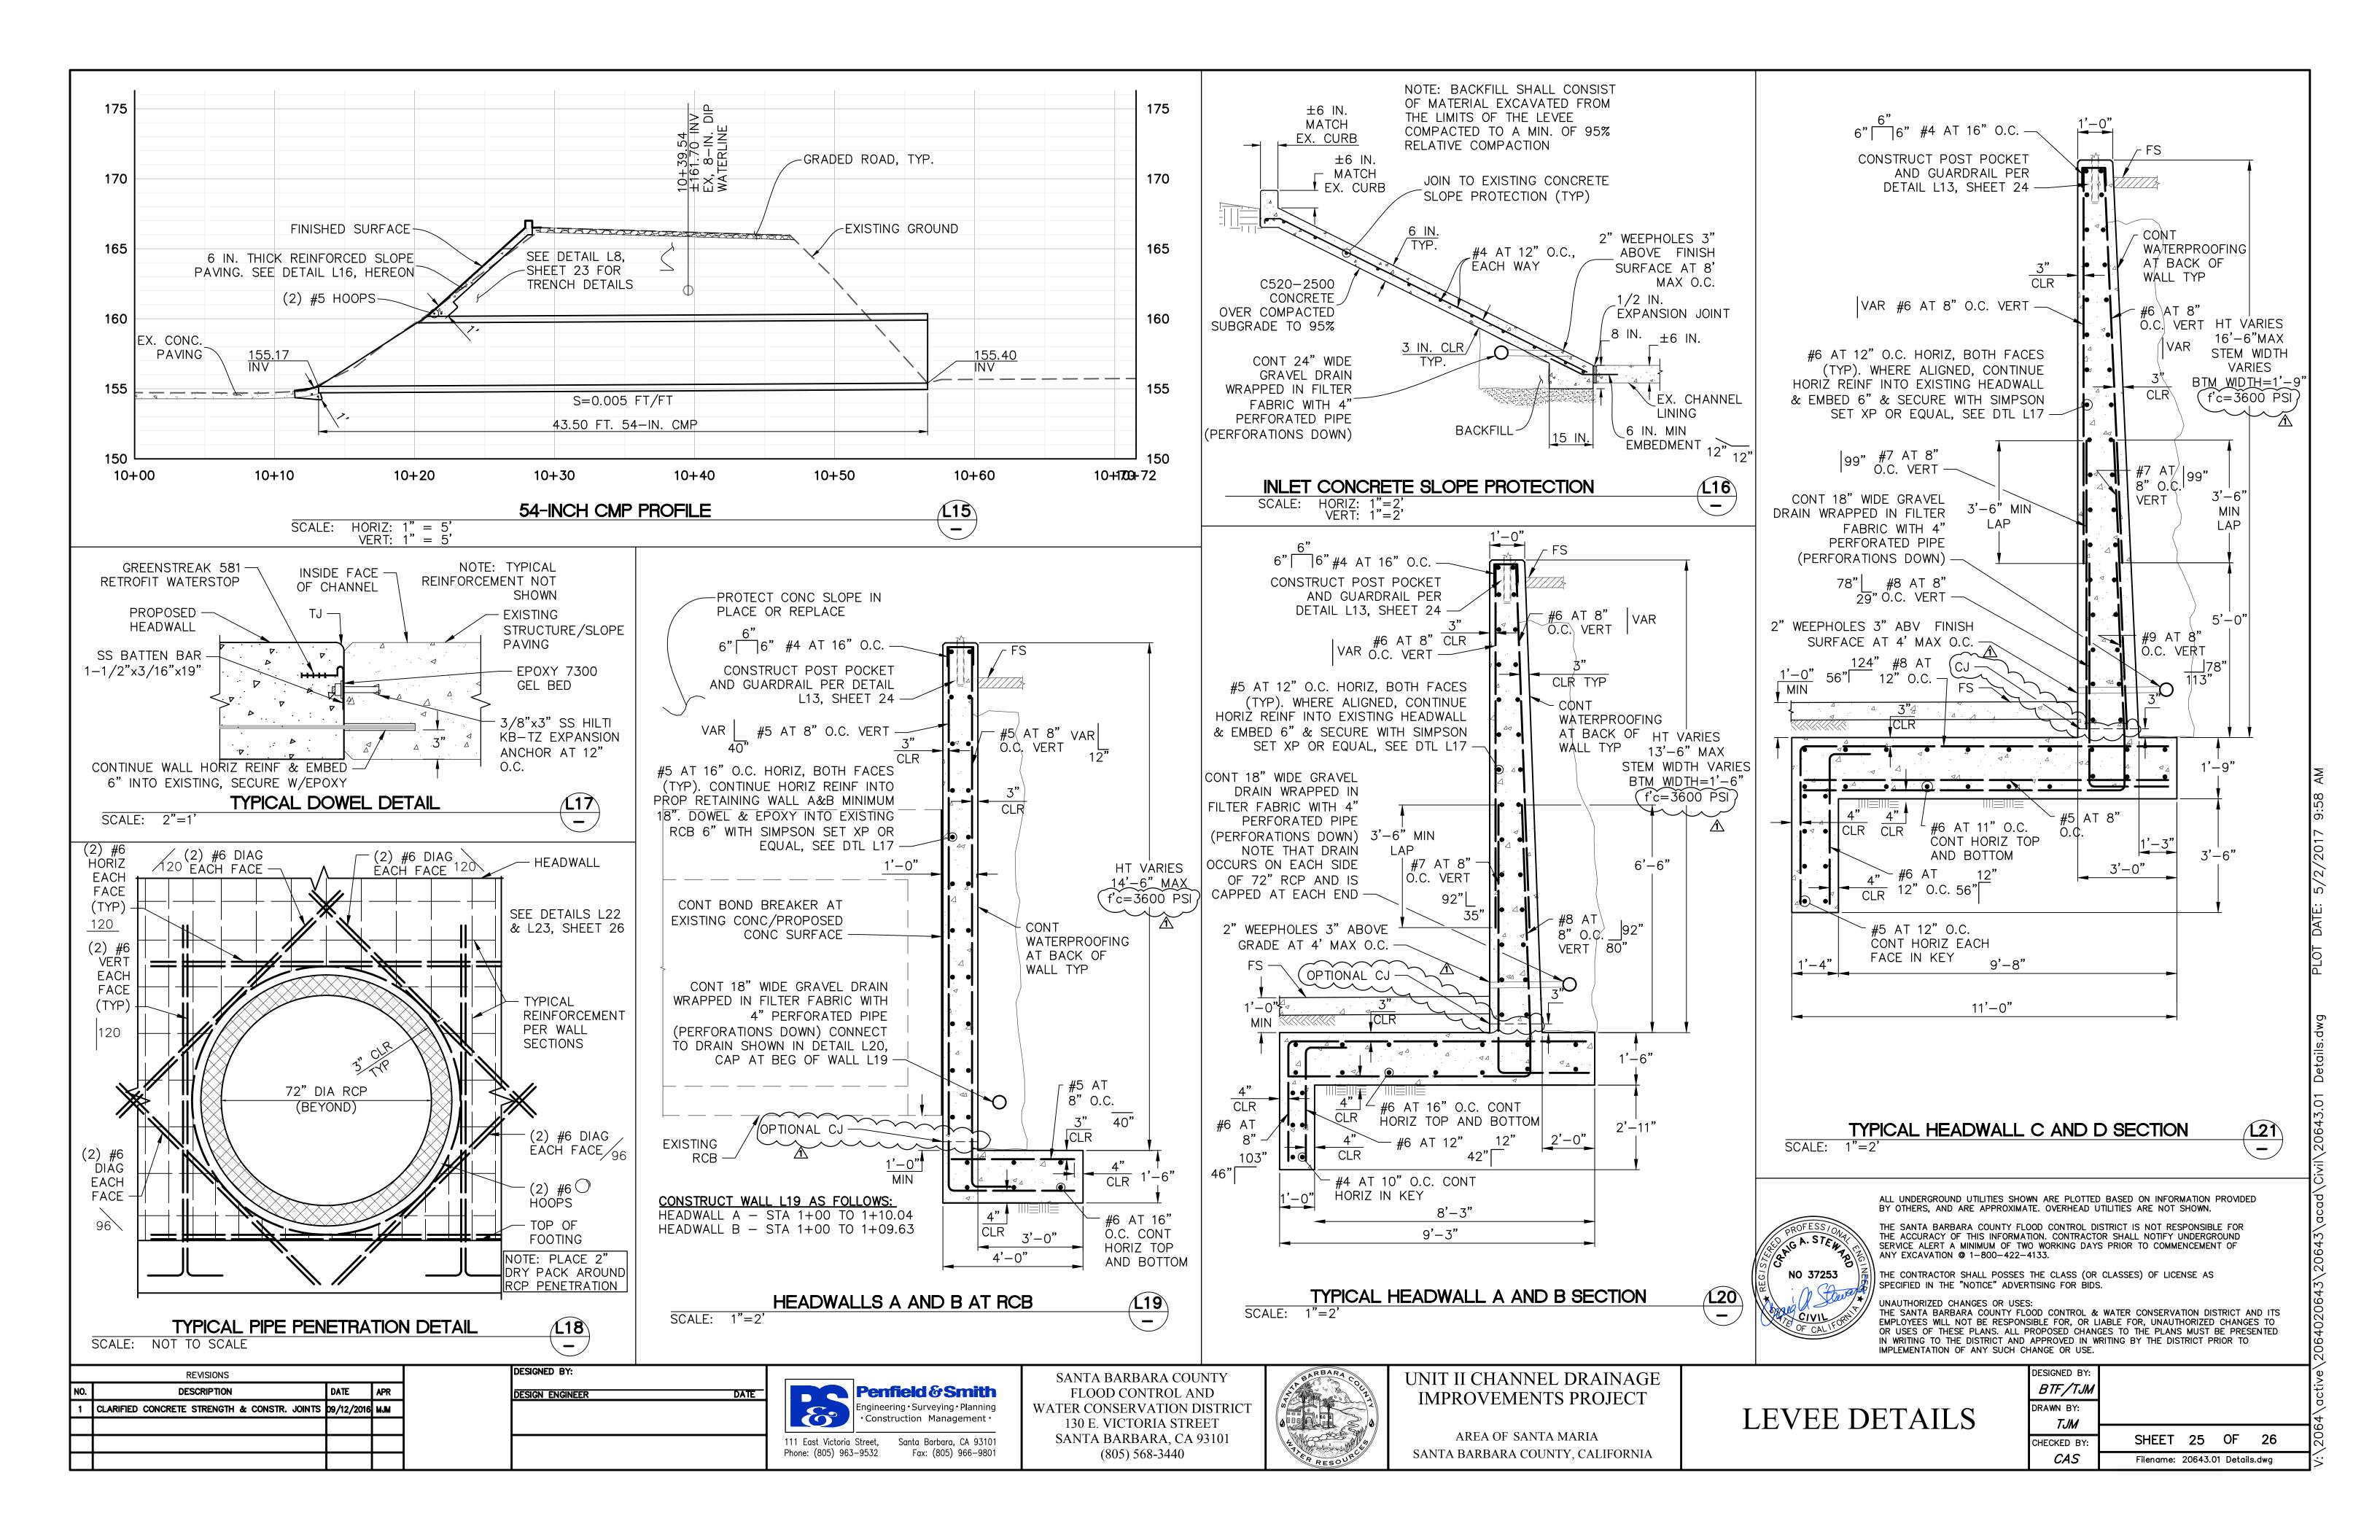

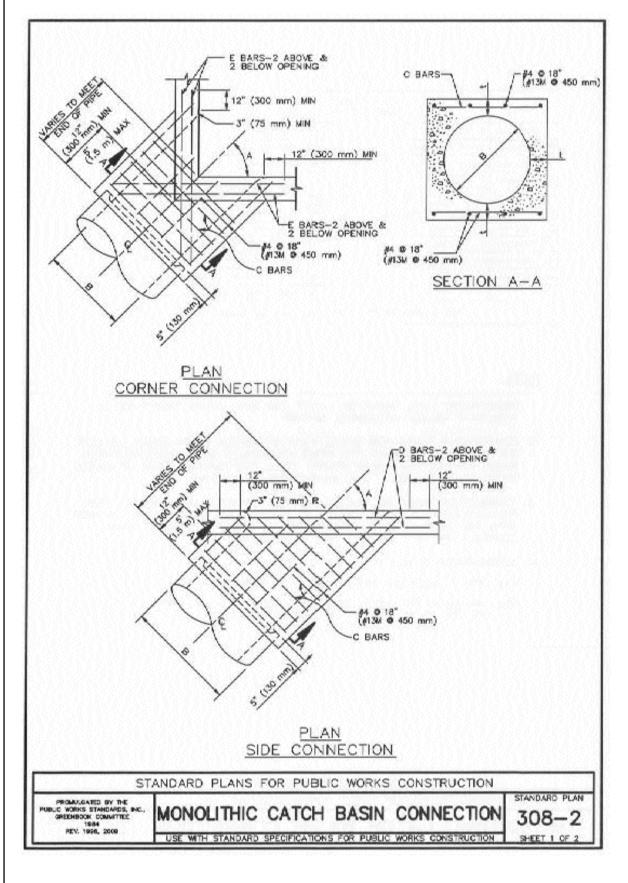

SCALE: NOT TO SCALE APWA STANDARD PLAN 308-2

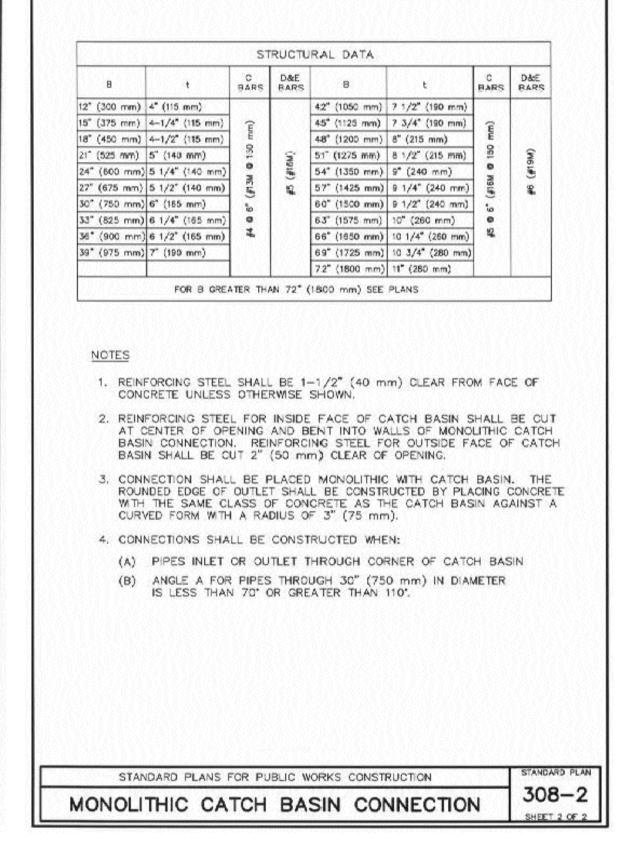

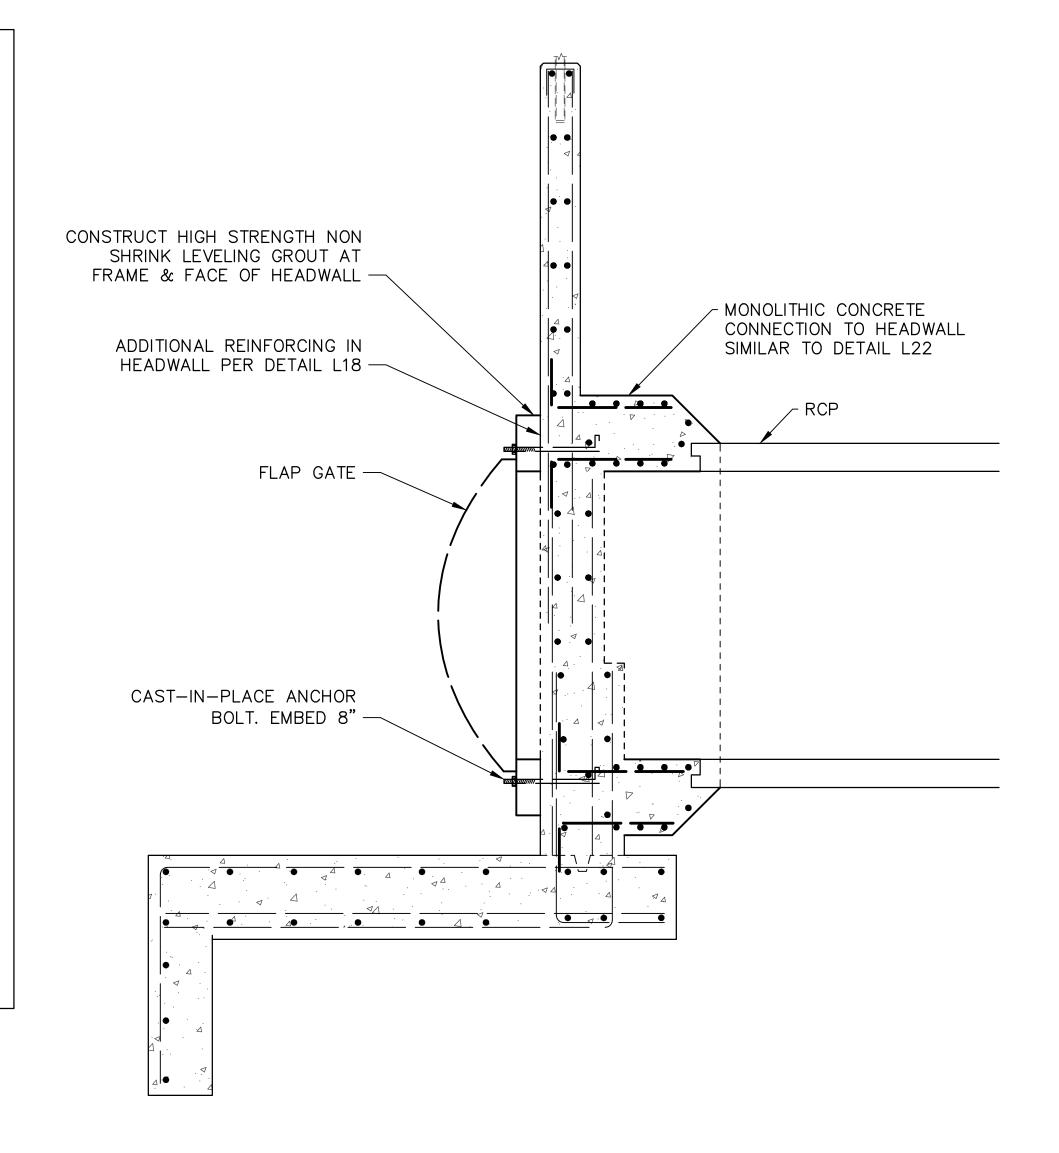

TYPICAL CONNECTION - RCP AT HEADWALL

SCALE: 1"=2"



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CIFIED IN THE NOTICE ADVENTISING FOR E

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NO. DESCRIPTION DATE APR

DESIGNED BY:

DESIGN ENGINEER


DATE

RCP CONNECTION TO HEADWALL



Phone: (805) 963-9532 Fax: (805) 966-9801

SANTA BARBARA COUNTY
FLOOD CONTROL AND
WATER CONSERVATION DISTRICT
130 E. VICTORIA STREET
SANTA BARBARA, CA 93101
(805) 568-3440

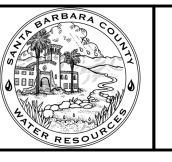

UNIT II CHANNEL DRAINAGE IMPROVEMENTS PROJECT

AREA OF SANTA MARIA SANTA BARBARA COUNTY, CALIFORNIA

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	DLI	AILS)

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DESIGNED BY:					
BTF/TJM					
DRAWN BY:					
TJM					
CHECKED BY:	SHEET	26	OF	26	
CAS	Filename:	20643.0	1 Detai	ls.dwg	

Details.dwq PLOT DATE: 5/2/2017

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