SLO CULTIVATION - CARPINTERIA

3861 FOOTHILL ROAD, CARPINTERIA, CA APN: 005-310-024

WILDLIFE MOVEMENT PLAN

Prepared for:

SLO Cultivation, Inc. 3861 Foothill Road Carpinteria, CA 93103

SCS Engineers 2370 Skyway Drive, Suite #101 Santa Maria, CA 93455

October 8, 2021



Central Coast Office

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1.0 INTRODUCTION AND PURPOSE

SLO Cultivation, Inc. (Applicant), dba as Cresco California, requests approval of a Coastal Development Permit- With Hearing (CDH), Minor Conditional Use Permit, and a Revision to an existing Development Plan (10DVP-00000-00010) to authorize the development and operation of a cannabis cultivation facility (project) in an unincorporated portion of Santa Barbara County near the city of Carpinteria, California. The subject property (project site) is located at 3861 Foothill Road (APN: 005-310-024). This revised BRA has been prepared in response to the County's peer review comment letter dated July 20, 2020.

The purpose of this Wildlife Movement Plan (WMP) is to document existing conditions of the project site and to evaluate the potential for any direct or indirect significant impacts to the movement of wildlife through the region. This report is intended to document satisfactory compliance with the *Santa Barbara County Article II Coastal Zoning Ordinance* land use permit process, and environmental review factors detailed in the *Cannabis Land Use Ordinance and Licensing Program, Final Environmental Impact Report (PEIR)*, Section 3.4 Biological Resources.

1.1 Project Location and Existing Conditions

The Project Site is located at 3861 Foothill Road (APN 005-310-024) in an unincorporated region of Santa Barbara County (County) approximately one (1) mile west of the City of Carpinteria and approximately seven (7) miles east of the City of Santa Barbara. The project site is located within the Agricultural I (AGI-10) zone district within the First Supervisorial District. The project site is approximately 13.66 acres in size and is primarily accessed via a private driveway from Foothill Road. The Project Site is primarily level land (elevations ranging from approximately 55 to 75 feet above mean sea level). Surrounding land uses are predominantly agricultural operations including greenhouses, hoop houses, orchards, and annually cultivated fields. Low density residential development is interspersed mostly north of Foothill Road in this predominately agricultural area.

Arroyo Paredon Creek crosses the northern fringe of the parcel from east to west. The National Hydrography Dataset designates Arroyo Paredon Creek as a perennial stream less than 0.75 miles upstream of the site, and in the project area it is designated as intermittent. Based on field observations in July 2020, the reach of Arroyo Paredon Creek within the study area likely maintains minimal perennial flow in most years through the dry season. In dry / drought years, it is possible that flows would dissipate in the dry season.

The project site and associated existing greenhouses have been historically used to cultivate non-cannabis products such as cut flowers (gerbera daisies) and avocados. Since on or about October 2015 the project site has been used to cultivate cannabis. Primary access to the project site is provided via a shared access agreement with the adjacent property known as APN 005-310-021. The private access road is approximately 400 linear feet in length, 20 feet wide, and paved with asphalt.

The project site is composed of approximately 10.79 acres of developed uses including four (4) existing greenhouse structures and twelve (12) prefabricated) supporting structures (containers used for agricultural storage and other supporting uses. The existing greenhouse structural development and associated agricultural uses were approved by the County via 10DVP-00000-00010 and 11CDP-00000-00009. The remainder of the project site is occupied by approximately 1.16 acres of fallow avocado orchard and agricultural materials stockpile. Outside the fenced project site but within the parcel is a



private road and 7-foot tall chain link security fence that separates approximately 0.48 acres of riparian canopy and channel associated with Arroyo Paredon Creek from the rest of the developed site.

The Exhibit 3 (Habitat Map) includes detailed mapping of all native trees south of the centerline of Arroyo Paredon Creek. Native trees within this area included coast live oak (*Quercus agrifolia*), California walnut (*Juglands hindsii*), and Western sycamore (*Platanus racemosa*). One native coast live oak tree is rooted south of the existing access road that separates the existing riparian corridor from proposed project activities.

A series of existing linear-shaped stormwater detention basins are located along the southeast and western property boundaries (See Exhibit 3). These basins are vegetated primarily by non-native weedy herbaceous forbs and grasses but do support some widely scattered mulefat and willow. Based on July 2020 field observations and discussions with onsite operations staff, these basins were designed for prior agricultural uses and do not ever support ponding.

Due to intensive agricultural, greenhouse, and residential development surrounding the proposed Project Site, wildlife movement proximal to the Project is restricted to the Arroyo Paredon watershed and its remaining native riparian corridor. As reflected in Figure 1 below, this movement corridor includes the northern fringes of the Project parcel.

Figure 1- Arroyo Paredon Wildlife Movement Corridor





1.2 PROJECT DESCRIPTION

The proposed Project would allow for:

- 1. Utilization of existing **Greenhouse 1 (GH1)**, approximately 264,500 square feet in size, for mature mixed-light cannabis cultivation.
- 2. Demolition of three (3) existing greenhouses, known as **Greenhouse 2 (GH2)**, **Greenhouse (GH3)**, and **Greenhouse 4 (GH4)**, which are approximately 40,700 square foot each.
- 3. Development and operation of a 61,840 square foot addition to **GH1** for nursery/juvenile mixed-light cannabis cultivation.
- 4. Development of a new 24,751 square foot pack house which will be utilized for cannabis processing (bucking, drying, and packaging).
- 5. The development of sixty-five (65) onsite parking spaces.
- 6. Expansion of the Project Site's stormwater detention basin system.
- 7. Minor ancillary improvements to the Project Site including installation of security cameras and lighting, installation and use of irrigation recycling and fertigation equipment, septic waste disposal systems, and placement of cannabis waste storage containers.
- 8. Removal of twelve (12) pre-fabricated containers, totaling 1,920 square feet, historically used for agricultural and cannabis support activities.

Site disturbance of non-developed areas and the corresponding potential for wildlife movement impacts is restricted to the proposed physical expansion of the site's existing storm water detention system and proposed landscape plan (Appendix C). All other proposed project elements consist of using existing structures, demolishing old structures and developing new structures in their previously disturbed footprint, or installing mechanical equipment in previously developed areas, thus no biological impacts are anticipated. In order to provide superior visual screening of the Project Site the existing avocado trees will be removed and the northern fence line will be planted with appropriate native riparian and transitional upland vegetation.

The timing of clearing the existing avocado orchard is proposed for a window between September 1st to February 1st that is outside the nesting season for birds. No work is proposed beyond the existing fence line and access road on the northern edge of the parcel. No disturbance or project related activities will occur in the Arroyo Paredon Creek riparian corridor and removal or pruning of native trees will not be required. Proposed maintenance within the basin area will be minimal and is anticipated to occur every 5 to 10 years, depending on annual rainfall and surface runoff amounts. These maintenance activities will include minor / as-needed sediment removal and vegetation trimming to ensure proper function of the basin(s).



2.0 WILDLIFE MOVEMENT FACTORS

2.1 NATIVE VEGETATION & STREAMBED

The Arroyo Paredon watershed and adjacent riparian vegetation encompass the northern 0.48 acres of the Project Parcel. The native area is bounded on the southern edge by an existing, paved access road which traverses the Project site from east to west. No Project related disturbance is proposed north of this access road. No grading disturbance will occur in proximity to or within the top-of-bank. No native trees will be removed or trimmed as part of the proposed scope of work. As a result, no wildlife movement impacts will occur as a result of impacts to the watershed or native vegetation as all such resources will remain intact and undisturbed. Movement though the existing riparian corridor may actually improve as the proposed Project would reduce noise and human activity in the existing avocado orchard immediately to the south. Native oaks within or in close proximity to construction activity will be protected in-place as further detailed in the project's Tree Protection Plan (TPP).

2.2 Partial Restoration of Orchard Area

The proposed Project includes the removal of approximately 1.41 acres of avocado orchard, and the installation of a native plant pallet along the existing northern fence line including: coast live oak (quercus agrifolia), creeping wild rye (elymus triticoides), mulefat (baccharis salicifolia), coffee berry (frangula californica), toyon (heteromeles arbutifolia), and California field sedge (carex praegracius). This would result in a net benefit to the potential for wildlife movement in the area as avocado orchard and its associated human activity will be displaced by the native plant species.

3.0 RECOMMENDED AVOIDANCE AND MINIMIZATION MEASURES

- Landscape Restoration: Implement the proposed landscape improvements, including use of native species restoration, in conformance with the proposed Landscape Plans as included in Exhibit 5 of this Report.
- 2) Tailgate Education Training: To ensure all onsite workers are aware of potential special-status species associated with Arroyo Paredon Creek, a County-approved biologist shall provide a tailgate education training session for all onsite workers. The purpose of this training shall be to familiarize all workers with the potential biological resources occurring onsite and required avoidance and minimization measures. Penalties and procedures for non-compliance will also be reviewed. All training recipients will be required to sign-in documenting they have attended the training, and a copy of the sigh-in sheet will be provided to the County.
- 3) **Construction Monitoring:** All ground disturbance and vegetation clearing activities shall be conducted under the direct supervision of the County-approved biologist. The monitoring biologist will work with construction crews to slowly remove any debris piles or potential upland refuge habitat (by hand or gentle excavation) for special-status wildlife species.
- 4) Post-construction Monitoring Report: A post-construction monitoring report will be provided to the County detailing any unintended impacts to native trees or other biological resources during construction and any additional mitigation measures implemented at the direction of the authorized biologist.



- 5) Special-status Wildlife Pre-construction Surveys: Within 48 hours of initial disturbance activities, the authorized biologist shall conduct a pre-construction survey in all upland areas of the site and within Arroyo Paredon Creek for the purposes of identifying any CRLF, two-striped garter snake, steelhead, or other special-status species that may be present within or adjacent to project activities. Special focus shall be taken in potential upland refuges such as debris piles. The County-approved monitoring biologist shall move out of harm's way any non-listed wildlife species encountered during initial ground disturbing activities to the extent feasible.
- 6) **Detention Basin Maintenance:** The timing of detention basin maintenance shall be limited to between September 1st to February 1st to ensure activities occur outside the nesting season for birds. If deemed to be required by the County, the applicant shall submit a Habitat Protection Plan for county review and approval at a minimum of 60 days prior to initiating any maintenance activity.

4.0 CONCLUSIONS

In conclusion, based on the findings described above establishing the existing conditions of biological resources within the Project parcel and applicant proposed site modifications for native plant restoration and fencing modifications; the implementation of the Project should positively benefit wildlife movement in the region. As such, direct and indirect project impacts on biological resources would be at a less than significant level as follows:

- The small project site of 1.16-acres of fallow orchard habitat only impacts avocado trees and ruderal species in an historical agricultural setting from pre-existing man-made disturbance.
- Avoidance and minimization measures have been proposed to ensure no direct impacts occur to special-status species or natural communities of special concern.
- Project timing avoids impacts on nesting/breeding behaviors of resident and migratory birds.



5.0 REFERENCES

- 1) Baldwin, B. G., D. H. Goldman, D. J. Keil, R. Patterson, T.J. Rosatti, Ed. 2012. *The Jepson Manual, Vascular Plants of California, Second Edition Thoroughly Revised and Expanded*. University of California Press.
- 2) Calflora: Information on California plants for education, research and conservation. [web 8 application]. 2012. Berkeley, California: The Calflora Database (a non-profit 9 organization). Available: http://www.calflora.org/. Accessed: November 2018.
- 3) Cal-IPC. 2006. California Invasive Plant Inventory. Cal-IPC Publication 2006-02. California Invasive Plant Council: Berkeley, CA. Available: www.cal-ipc.org
- 4) Mayer, W. and W. Laudenslayer, Editors. 1988. *A Guide to Wildlife Habitats of California*. California Department of Forestry and Fire Protection.
- 5) Santa Barbara County Planning and Development. 2008. *Environmental Thresholds and Guidelines Manual*. Revised September 2008, Published October 2008.
- 6) Santa Barbara County. 2017. Cannabis Land Use Ordinance and licensing Program, Final Environmental Impact Report. Section 3.4 Biological Resources. December 2017.
- 7) Santa Barbara County. 2019. Santa Barbra Count Article II Coastal Zoning Ordinance. Updated June 2019
- 8) Sawyer, J. O., T. Keeler-Wolf, and J.M. Evens. 2009. *A Manual of California Vegetation, 2nd Edition*. California Native Plant Society, Sacramento, CA.
- 9) Sawyer, J. & T. Keeler-Wolf. 1995. *A Manual of California Vegetation*. Web version provided by the California Native Plant Society.





APPENDIX A


Exhibit 1: Regional Location and CNDDB Occurrences Map

Exhibit 2: Aerial Overview

Exhibit 3: Revised Habitat Map (July 2020)

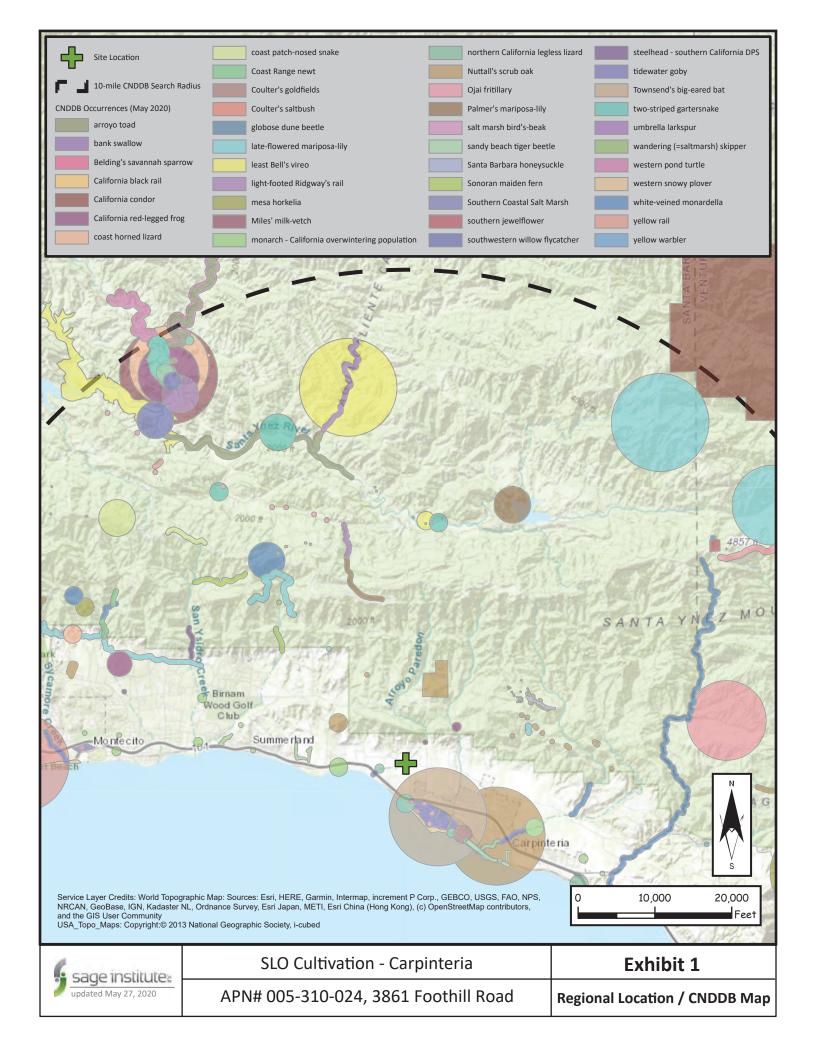

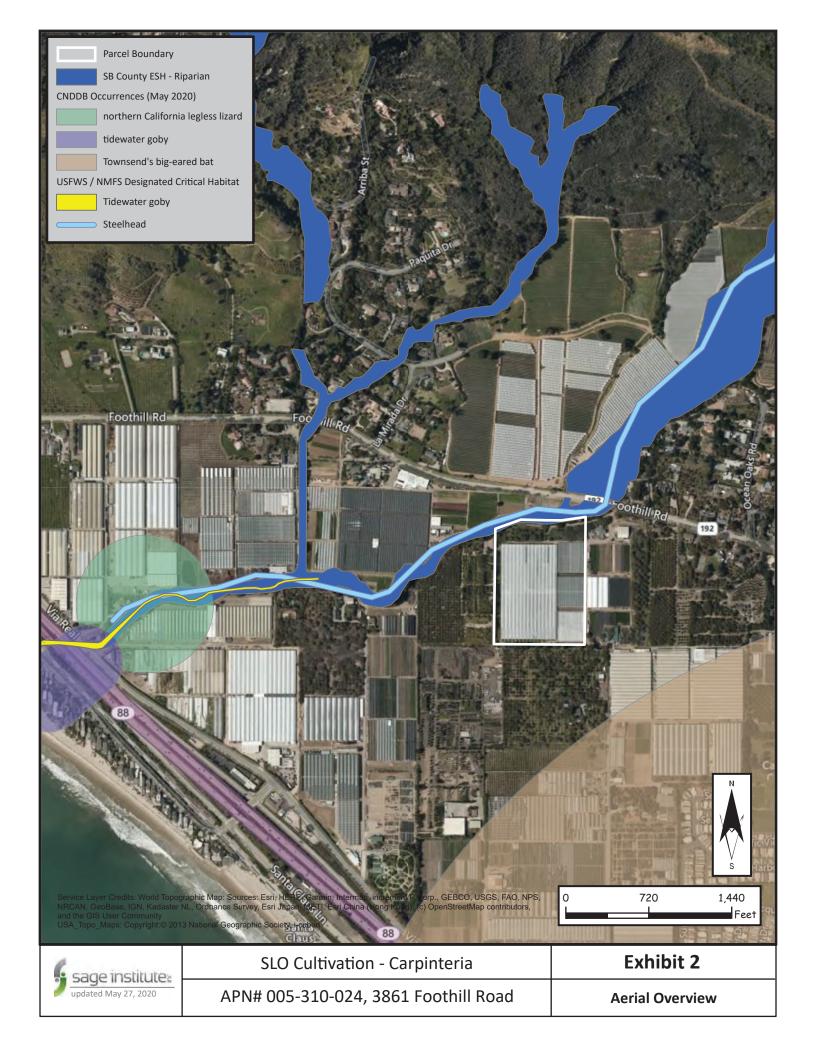

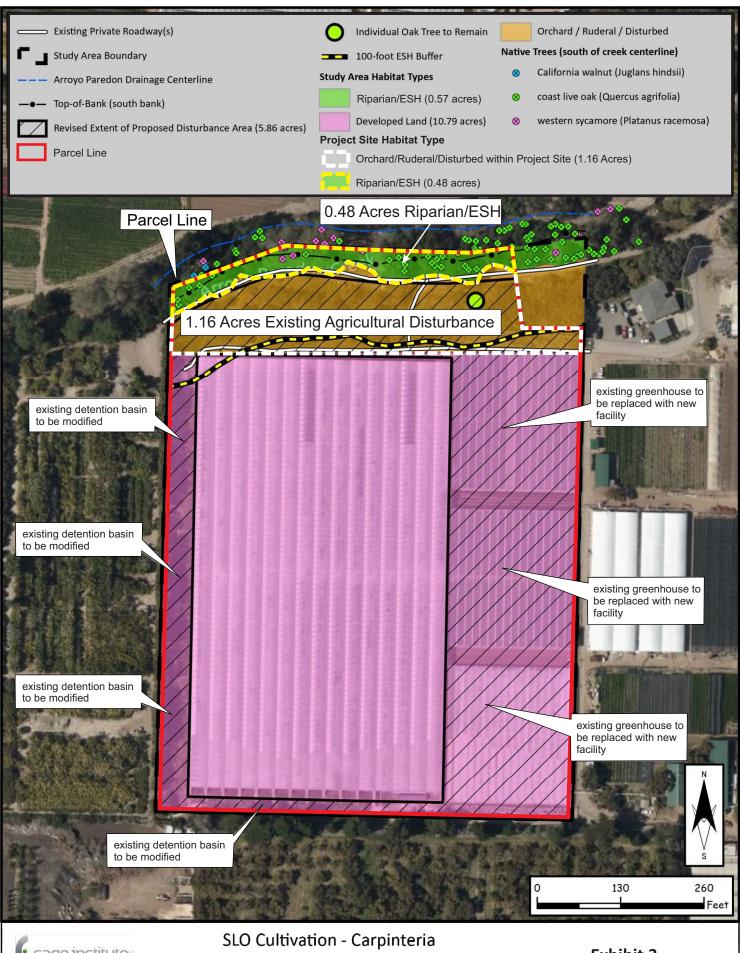



SLO Cultivation - Carpinteria
APN# 005-310-024, 3861 Foothill Road

Exhibit 3
Habitat Map



APPENDIX B

Exhibit 5: Design Documents/Landscape Plans

SITE PLAN GENERAL NOTES:

- This plan is for architectural reference. See civil plans for specific grading and drainage information.

 Positive drainage shall be provided away from the structure at a minimum slope of 5% for 10 feet.
- Contractor shall verify location of all underground utilities prior to excavation.
 Rain gutters and downspouts shall collect and discharge roof rain water run-off through an approved storm drain system. See civil plans for additional information.
- Verify depth & separation of utilities within trenches w/ governing jurisdiction and comply w/ all applicable codes. Architect to be notified of any conflicts.



ARCHITECTURE

924 anacapa st suite: 2-U santa barbara, ca 93101 805.564.6074



sheet description

SITE PLAN

8-20-2020 8-28-2020 9-3-2020 9-9-2020 9-17-2020 12-9-2020 12-18-2020 12-29-2020 1-13-2021 2-3-2021 2-9-2021 2-10-2021 2-18-2021 4-27-2021 6-1-2021 7-6-2021

sheet no:

9-15-2021 10-1-2021

1"=50'

PLEINAIRE

DESIGN GROUP

THE DRAWING, DESIGN IDEAS, AND FEATURES OF CONSTRUCTION, DEPICTED WITHIN THE DRAWINGS ARE THE EXCLUSIVE PROPERTY OF KEVIN J. SMALL LANDSCAPE ARCHITECT. THEY ARE NOT TO BE REUSED, REPRODUCED, COPIED, SOLD, OR USED FOR ANY OTHER PURPOSE WITHOUT THE EXPRESSED WRITTEN CONSENT OF KEVIN J. SMALL; RLA 2929. @ 2018 KEVIN J. SMALL

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SLO CULTI

SHEET TITLE

FENCING & SECURITY PLAN

OWNER Cresco California
P.O. Box 183
Carpinteria, California 93014

DATE 2021.10.12

DATE

SHEET NO.

L-1.0

21839


Cheffit. 31	LO Cultivation				Date: 15-Aug-19 [4] Dead Rev. Date 1: 21-Apr-20 [5] Replace Rev. Date 2: 14-Jan-21
Tree #	Species	Common Name	Canopy	Disposition	Notes
1	Persea Americana	Avocado Tree	Grid	2	Remove for new detention basin
2	Persea Americana	Avocado Tree	Grid	2	Remove for new detention basin
3	Persea Americana	Avocado Tree	Grid	2	Remove for new detention basin
4	Persea Americana	Avocado Tree	Grid	2	Remove for new detention basin
5	Persea Americana	Avocado Tree	Grid	2	Remove for new detention basin
6	Persea Americana	Avocado Tree	Grid	2	Remove for new detention basin
7	Persea Americana	Avocado Tree	Grid	2	Remove for new detention basin
8	Persea Americana	Avocado Tree	Grid	2	Remove for new detention basin
9	Persea Americana	Avocado Tree	Grid	2	Remove for new detention basin
10	Persea Americana	Avocado Tree	Grid	2	Remove for new detention basin
11	Persea Americana	Avocado Tree	Grid	2	Remove for new detention basin
12	Persea Americana	Avocado Tree	Grid	2	Remove for new detention basin
13	Persea Americana	Avocado Tree	Grid	2	Remove for new detention basin
14	Persea Americana	Avocado Tree	Grid	2	Remove for new detention basin
15	Persea Americana	Avocado Tree	Grid	2	Remove for new detention basin
16	Persea Americana	Avocado Tree	Grid	2	Remove for new detention basin
17	Persea Americana	Avocado Tree	Grid	2	Remove for new detention basin
18	Persea Americana	Avocado Tree	Grid	2	Remove for new detention basin
19	Persea Americana	Avocado Tree	Grid	2	Remove for new detention basin
20	Persea Americana	Avocado Tree	Grid	2	Remove for new detention basin
21	Persea Americana	Avocado Tree	Grid	2	Remove for new detention basin
22	Persea Americana	Avocado Tree	Grid	2	Remove for new detention basin
23	Persea Americana	Avocado Tree	Grid	2	Remove for new detention basin
24	Persea Americana	Avocado Tree	Grid	2	Remove for new detention basin
25	Persea Americana	Avocado Tree	Grid	2	Remove for new detention basin
26	Persea Americana	Avocado Tree	Grid	2	Remove for new detention basin
27	Persea Americana	Avocado Tree	Grid	2	Remove for new detention basin
28	Persea Americana	Avocado Tree	Grid	2	Remove for new detention basin
29	Persea Americana	Avocado Tree	Grid	2	Remove for new detention basin
30	Persea Americana	Avocado Tree Avocado Tree	Grid	2	Remove for new detention basin
31	Persea Americana		Grid	2	Remove for new detention basin
32 33	Persea Americana	Avocado Tree	Grid OF! Dis		Remove for new detention basin
34	Quercus agrifolia Persea Americana	Coast Live Oak Avocado Tree	25' Dia. Grid	1 2	DBH = 6.5" Remove for new detention basin
35	Persea Americana	Avocado Tree Avocado Tree	Grid	2	Remove for new detention basin
36	Persea Americana	Avocado Tree Avocado Tree	Grid	2	Remove for new detention basin
37	Persea Americana	Avocado Tree Avocado Tree	Grid	2	Remove for new detention basin
38	Persea Americana	Avocado Tree Avocado Tree	Grid	2	Remove for new detention basin
39	Persea Americana	Avocado Tree Avocado Tree	Grid	2	Remove for new detention basin
40	Persea Americana	Avocado Tree Avocado Tree	Grid	2	Remove for new detention basin
41	Persea Americana	Avocado Tree	Grid	2	Remove for new detention basin
42	Persea Americana	Avocado Tree Avocado Tree	Grid	1	In adjacent parcel
43	Persea Americana	Avocado Tree	Grid	1	In adjacent parcel
44	Persea Americana	Avocado Tree Avocado Tree	Grid	1	In adjacent parcel
45	Persea Americana	Avocado Tree	Grid	1	In adjacent parcel
46	Persea Americana	Avocado Tree	Grid	1	In adjacent parcel
47	Persea Americana	Avocado Tree	Grid	1	In adjacent parcel
48	Persea Americana	Avocado Tree	Grid	1	In adjacent parcel
49	Persea Americana	Avocado Tree	Grid	1	In adjacent parcel
50	Persea Americana	Avocado Tree	Grid	1	In adjacent parcel
51	Persea Americana	Avocado Tree	Grid	1	In adjacent parcel
52	Persea Americana	Avocado Tree	Grid	1	In adjacent parcel
53	Persea Americana	Avocado Tree	Grid	1	In adjacent parcel
54	Persea Americana	Avocado Tree	Grid	1	In adjacent parcel
55	Persea Americana	Avocado Tree	Grid	1	In adjacent parcel
56	Persea Americana	Avocado Tree	Grid	1	In adjacent parcel

TREE SURVEY

Persea Americana

58 Persea Americana

☐ TREE INVENTORY PLAN

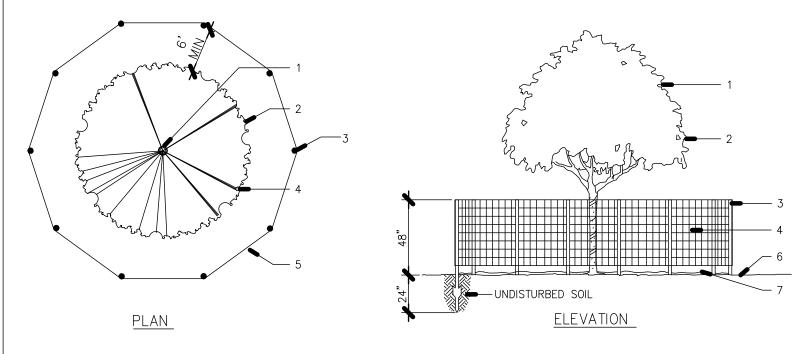

LEGEND

- 1. EXISTING TREE TO REMAIN, AS DESIGNATED ON PLANS. 2. TREE DRIP LINE.
- 3. HEAVY DUTY STEEL T-POST 6' O.C. MAX. DRIVE POST INTO UNDISTURBED SOIL, AVOIDING MAJOR ROOTS AS MUCH AS POSSIBLE.
- 4. ORANGE "HI-VIS" BARRIER FENCING, 48" TALL ATTACHED WITH ZIP TIES, MINIMUM 4
- PER STAKE EQUALLY SPACED.
- 5. SIGNAGE STATING "TREE PROTECTION AREA" SHALL BE PLACED ON FENCING AT 15'
- 6. EXTEND FENCING 6' BEYOND DRIPLINE OF PROTECTED TREES WHERE POSSIBLE, OR
- AS OTHERWISE SHOWN ON PLANS. 7. ALL FENCING AND SIGNS SHALL REMAIN IN PLACE DURING ALL GRADING AND
- CONSTRUCTION ACTIVITIES
- 8. EXISTING GRADE. 9. UNDISTURBED LEAF LITTER.
- NOTE: ALL EXCEPTIONS SHALL BE APPROVED IN THE FIELD BY THE PROJECT ARBORIST PRIOR TO START OF WORK.

TREE PROTECTION NOTES

PRIOR TO PRE-CONSTRUCTION MEETING, BEGINNING OF GRADING, AND DURING ALL GROUND DISTURBANCE AND CONSTRUCTION ACTIVITIES, TEMPORARY ORANGE PLASTIC FENCING SHALL BE INSTALLED AT THE DRIP LINE OF ALL TREES IN ORDER TO CONTROL ACCESS AND DELINEATE AREAS OF NON-DISTURBANCE. FINAL LOCATION OF FENCING TO BE DETERMINED IN FIELD BY LANDSCAPE ARCHITECT.

SCALE: 1" = 40'-0"

- 2. ANY NECESSARY PRUNING SHALL BE IN ACCORDANCE TO THE MOST CURRENT INTERNATIONAL SOCIETY OF ARBORICULTURE PRUNING STANDARDS UNDER THE SUPERVISION OF A CERTIFIED ARBORIST.
- PRIOR TO BEGINNING WORK OR ANY EXCAVATION, THE CONTRACTOR SHALL CONTACT UNDERGROUND SERVICE ALERT AT (800) 442-4133. REMOVAL OF WEEDS WITHIN THE DRIP LINE OF THE TREES SHALL BE DONE BY HAND OR BY USE OF A CONTACT HERBICIDE ONLY.
- NO CONSTRUCTION, STORAGE OF MATERIALS, AND/OR PARKING OF VEHICLES SHALL BE PERMITTED WITHIN THE DRIP LINE OF EXISTING TREES.
- NO GRADING SHALL OCCUR WITHIN THE DRIP LINE OF EXISTING TREES EXCEPT AS REQUIRED WITHIN DESIGNATED AREA OF ENCROACHMENT AND UNDER THE SUPERVISION OF THE PROJECT ARBORIST
- 7. IF UTILITY INSTALLATION MUST OCCUR WITHIN THE DRIP LINE OF ANY OF EXISTING TREES, THEN THE FOLLOWING PRECAUTIONS MUST BE OBSERVE AND PERFORMED UNDER THE SUPERVISION OF THE PROJECT ARBORIST
 - A. WHERE IT IS NECESSARY TO EXCAVATE ADJACENT TO EXISTING TREES, THE CONTRACTOR SHALL USE ALL POSSIBLE CARE TO AVOID INJURY TO TREES AND
 - B. EXCAVATION IN THESE AREAS WHERE TWO (2) INCH AND LARGER ROOTS OCCUR SHALL BE DONE BY HAND.
 - C. ALL ROOTS LESS THAN TWO (2) INCHES IN DIAMETER, DIRECTLY IN THE PATH OF THE PIPE OR CONDUIT, SHALL BE CLEANLY CUT UNDER THE DIRECTION OF AN APPROVED ARBORIST.
 - D. ALL ROOTS TWO (2) INCHES AND LARGER IN DIAMETER, EXCEPT DIRECTLY IN THE PATH OF PIPE OR CONDUIT, SHALL BE TUNNELED UNDER AND SHALL BE HEAVILY WRAPPED WITH BURLAP TO PREVENT SCARRING OR EXCESSIVE DRYING.
 - E. ROOTS ONE (1) INCH AND LARGER IN DIAMETER REQUIRING CUTTING SHALL BE PAINTED WITH TWO COATS OF TREE SEAL OR EQUAL.
 - F. WHERE A DITCHING MACHINE IS RUN CLOSE TO TREES HAVING ROOTS SMALLER THAN TWO (2) INCHES IN DIAMETER, THE WALL OF THE TRENCH ADJACENT TO TREES SHALL BE HAND TRIMMED, MAKING CLEAN CUTS THROUGH.
 - G. TRENCHES ADJACENT TO TREES SHOULD BE CLOSED WITHIN TWENTY FOUR (24) HOURS AND WHERE NOT POSSIBLE, THE SIDE OF THE TRENCH ADJACENT TO THE TREES SHALL BE KEPT SHADED WITH BURLAP OR CANVAS.
- 8. ANY DISCREPANCIES AND/ OR QUESTIONS THAT MAY ARISE ON SITE REGARDING EXISTING TREES SHALL BE REFEREED TO THE PROJECT ARBORIST. 9. ALL EXISTING SHRUBBERY AND GROUNDCOVER SHALL BE REMOVED WHERE NECESSARY FOR CONSTRUCTION PURPOSES UNLESS OTHERWISE NOTED TO REMAIN.
- 10. ALL DOWNED WOOD AND UPROOTED STUMPS SHALL BE REMOVED AS PART OF THE SITE CLEAN UP. CONTRACTOR SHALL LEAVE EXISTING LEAF MULCH IN PLACE AS MUCH AS POSSIBLE.
- 11. TREES SHALL BE PROTECTED IN PLACE TO THE GREATEST EXTENT POSSIBLE. ALL TREES LOCATED WITHIN TWENTY FIVE (25) FEET OF PROPOSED BUILDINGS SHALL BE PROTECTED FROM STUCCO OR PAINT DURING CONSTRUCTION.
- 12. ANY PRUNING TO BE SUPERVISED BY PROJECT ARBORIST.

TREE INVENTORY LEGEND

n adjacent parcel


In adjacent parcel

SYMBOL	NAME
	EXISTING TREE CANOPY
	EXISTING TREE CANOPY TO BE REMOVED
	TREE TRUNK

NOTE:

Avocado Tree

GRADING AND SITE DISTURBANCE SHALL REMAIN AT LEAST 6 FEET OUTSIDE OF THE EXISTING OAK'S DRIPLINE WHENEVER FEASIBLE. IF GRADING MUST ENCROACH WITHIN THAT PROTECTED AREA, ALL SUCH WORK SHALL BE CONDUCTED UNDER THE SUPERVISION OF THE LANDSCAPE ARCHITECT/ARBORIST

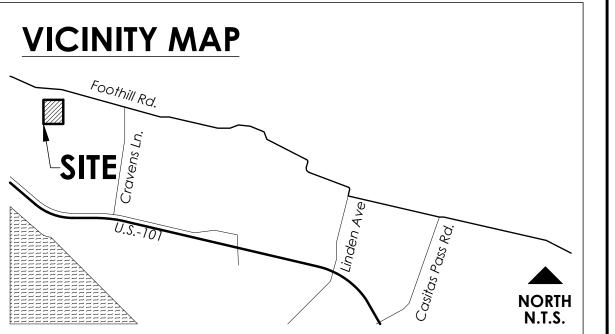

DESIGN GROUP

[1] Remain [2] Remove

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SHEET TITLE

TREE **INVENTORY PLAN**

OWNER Cresco California P.O. Box 183 Carpinteria, California 93014

2021.10.12

21839

DATE SHEET NO.

L-1.1

A TREE PROTECTION DETAIL

PLANT LEGEND

TREES


SYMBOL	NAME	COMMENTS	SIZE	WUCOLS	QTY.	
	QUERCUS AGRIFOLIA COAST LIVE OAK	PLANT PER DETAIL A	48" BOX	V. LOW	15	
	MAGNOLIA GRANDIFLORA 'ST. MARY' ST. MARY MAGNOLIA	PLANT PER DETAIL A	24" BOX	MED	5	
	LOPHOSTEMON CONFERTUS BRISBANE BOX	PLANT PER DETAIL A	36" BOX	MED	7	
	QUERCUS VIRGINIANA SOUTHERN LIVE OAK	PLANT PER DETAIL A	36" BOX	MED	3	
	PLATANUS RACEMOSA WESTERN SYCAMORE	PLANT PER DETAIL A REFER TO PLANT LEGEND NOTE #9	36" BOX	MED	6	

SHRUBS

SYMBOL	NAME	COMMENTS	SIZE	WUCOLS	QTY.
<u>S1</u>	SI ELYMUS TRITICOIDES CREEPING WILD RYE	PLANT PER DETAIL B	1 GAL.	LOW	38
<u>S2</u>	S2 BACCHARIS SALICIFOLIA MULEFAT	PLANT PER DETAIL B	1 GAL.	LOW	15
<u>S3</u>	FRANGULA CALIFORNICA COFFEE BERRY	PLANT PER DETAIL B	5 GAL.	V. LOW	26
<u>S4</u>	HETEROMELES ARBUTIFOLIA TOYON	PLANT PER DETAIL B	5 GAL.	V. LOW	14
<u>\$5</u>	MUHLENBERGIA RIGENS DEER GRASS	PLANT PER DETAIL B	5 GAL.	LOW	46
<u>S6</u>	S6 ARCTOSTAPHYLOS 'SUNSET' SUNSET MANZANITA	PLANT PER DETAIL B	5 GAL.	LOW	23
<u>\$7</u>	ROSA CALIFORNICA CALIFORNIA WILDROSE	PLANT PER DETAIL B REFER TO PLANT LEGEND NOTE #9	5 GAL.	LOW	23
<u>S8</u>	SAMBUCUS NIGRA SSP. CAERULEA BLUE ELDERBERRY	PLANT PER DETAIL B REFER TO PLANT LEGEND NOTE #9	5 GAL.	LOW	13


GROUNDCOVERS

SYMBOL	NAME	COMMENTS	SIZE	WUCOLS	QTY.
	GI CAREX PRAEGRACILIS CALIFORNIA FIELD SEDGE	PLANT PER DETAIL B 36" O.C.	4" POTS	LOW	19
	G2 CEANOTHUS GLORIOSUS 'ANCHOR BAY' ANCHOR BAY CEANOTHUS	PLANT PER DETAIL B 72" O.C.	5 GAL.	LOW	92
	G3 ACHILLEA MILLEFOLIUM COMMON YARROW	PLANT PER DETAIL B 24" O.C.	1 GAL.	LOW	43
	MOIYO GRAVEL GRAVEL BORDER	2 FOOT WIDE BORDER SURROUNDING THE BUILDING	2"-4"	N/A	423 SQ. FT.

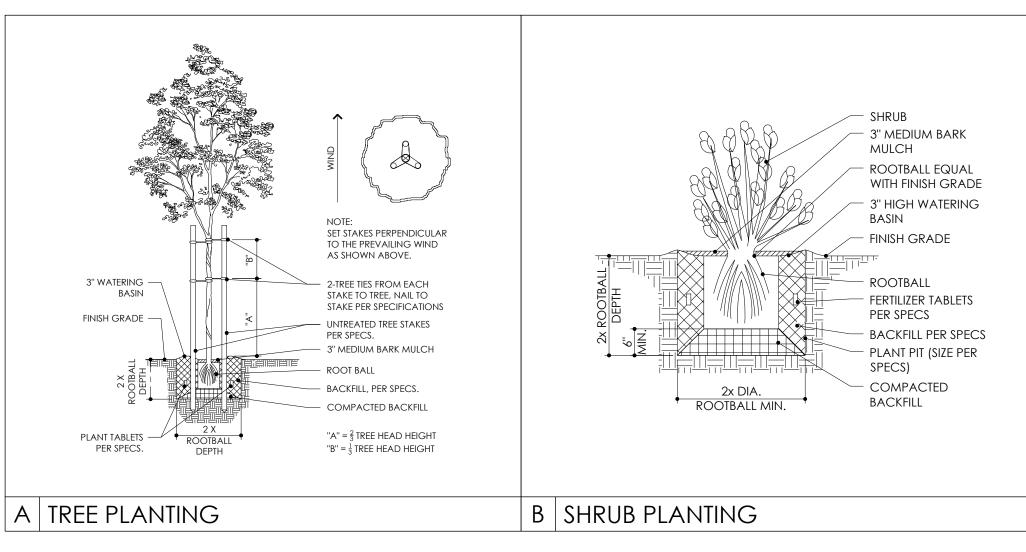

NOTE:

GRADING AND SITE DISTURBANCE SHALL REMAIN AT LEAST 6 FEET OUTSIDE OF THE EXISTING OAK'S DRIPLINE WHENEVER FEASIBLE. IF GRADING MUST ENCROACH WITHIN THAT PROTECTED AREA, ALL SUCH WORK SHALL BE CONDUCTED UNDER THE SUPERVISION OF THE LANDSCAPE ARCHITECT/ARBORIST

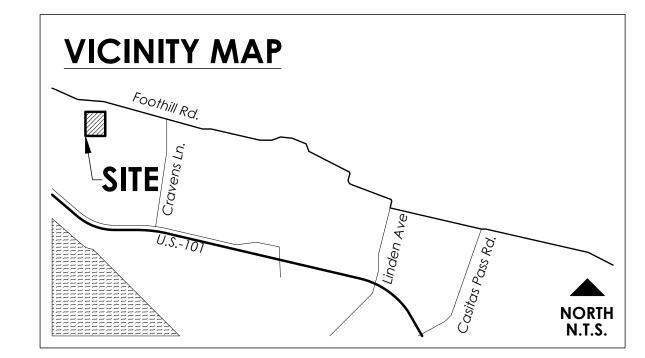

PLEINAIRE DESIGN GROUP

3203 Lightning St., Ste. 201 // Santa Maria, CA 93455

805.349.9695 // www.pleinairedg.com

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CULTIVATION

SHEET TITLE

LANDSCAPE SCREENING PLAN

OWNER Cresco California
P.O. Box 183
Carpinteria, California 93014

SHEET NO.

NO.

L-1.2

2021.10.12

21839

PLEINAIRE DESIGN GROUP

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CULTIVATIO

SHEET TITLE

EXISTING RENDERED SITE PLAN

Cresco California
P.O. Box 183
Carpinteria, California 93014

DATE
2021.10.12
21839

SHEET NO.

L-1.3

DESIGN GROUP

3203 Lightning St., Ste. 201 // Santa Maria, CA 93455 805.349.9695 // www.pleinairedg.com

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SHEET TITLE

PROPOSED RENDERED SITE PLAN

OWNER Cresco California P.O. Box 183 Carpinteria, California 93014

DATE

2021.10.12 SHEET NO.

L-1.4