

LAKE CACHUMA PSL # 276864

2680 HWY 154 SANTA BARBARA CA, 93105

SPECIAL INSPECTIONS - 2013 CBC CHAP. 17A							
ITEM	MATERIAL	REQUIRED	2013 CBC	STANDARDS			
GENERATOR	HILTI KWIK BOLT TZ STAINLESS STEEL	PERIODIC BASIS	1705A.3 ITEM 4	ICC ESR-1917 SECTION 4.4			
CONCRETE	CONCRETE	PERIODIC BASIS	1705A.3				
50' TALL MONOEUCALYPTUS TOWER	REFER TO TOWE	R DRAWINGS / CALCS	3				

PROJECT TEAM

VERIZON WIRELESS SIGNATURE BLOCK

By Michael nichols at 11:10 am, Jul 02, 2015

SIGNATURE

APPROVED

REVIEWED

SITE ACQUISITION

SAC WIRELESS, LLC. 211 EAST CARILLO STREET SUITE 201 SANTA BARBARA, CA 93101 CONTACT: JAY HIGGINS JAY.HIGGINS@SACW.COM

ARCHITECT:

SAC WIRELESS LLC NESTOR POPOWYCH AIA NESTOR POPOWYCH, AIA 5865 AVENIDA ENCINAS SUITE 142-B CARLSBAD, CA 92008 CONTACT: CARLOS CASTELLANOS TELEPHONE: (760) 795-5211 FAX: (760) 931-0908

UTILITY COORDINATOR:

SAC WIRELESS, LLC. 450 DEER CANYON ROAD

DISCIPLINE:

SITE ACQUISITION

CONSTRUCTION:

RADIO:

TELCO:

MICROWAVE:

EQUIPMENT:

PROJECT ADMINISTRATOR

WO ADMINISTRATOR:

PLANNING

SAC WIRELESS, LLC. 211 EAST CARILLO STREET SUITE 201 SANTA BARBARA, CA 93101 CONTACT: JAY HIGGINS JAY.HIGGINS@SACW.COM

SURVEYOR:

SMITHCO SURVEYING ENGINEERING P.O. BOX 81626

BUELLTON, CA 93427 CONTACT: KELLY MCCURNIN TELEPHONE: (805) 686-4039

BAKERSFIELD, CA 93380 CONTACT: GREG SMITH TELEPHONE: (661) 393-1217

DRIVING DIRECTIONS

FROM: 2785 MITCHELL DRIVE, BLDG 9

TO: 2680 HWY 154 SANTA BARBARA CA, 93105

LAKE CACHUMA

1. HEAD NORTHEAST ON MITCHELL DR TOWARD OAK GROVE RD

2. TAKE THE 1ST LEFT ONTO OAK GROVE RD

3. TURN LEFT ONTO TREAT BLVD

4. TURN RIGHT ONTO N MAIN ST

5. TURN RIGHT ONTO THE INTERSTATE 680 S RAMP TO OAKLAND/SAN JOSE 6. MERGE ONTO I-680 S

7. TAKE THE EXIT ONTO US-101 S TOWARD LOS ANGELES

8. TAKE THE CA-154 EXIT TOWARD LOS OLIVOS/LAKE CACHUMA 9 TURN LEFT ONTO CA-154 E/SAN MARCOS PASS RD

10. TURN RIGHT ONTO FOREST RTF 6N04

PROJECT DESCRIPTION

VICINITY MAP

154

- THIS PROJECT IS A VERIZON UNMANNED TELECOMMUNICATION WIRELESS
 FACILITY. IT WILL CONSIST OF THE FOLLOWING:
 NEW VERIZON WIRELESS OUTDOOR EQUIPMENT CABINET ON NEW 4-0" X 14-0" CONCRETE SLAE
- (12) NEW VERIZON WIRELESS 6' TALL PANEL ANTENNAS (1) NEW VERIZON WIRELESS 2.5' Ø MICROWAVE ANTENNA
- (9) NEW VERIZON WIRELESS RRUS
- (3) NEW VERIZON WIRELESS AND ATTENNAS
 (1) NEW VERIZON WIRELESS 50°-0" TALL MONOEUCALYPTUS
 (1) NEW VERIZON WIRELESS 50°-0" TALL MONOEUCALYPTUS
 (1) NEW VERIZON WIRELESS 30KW / 132 GALLON (UL 142) DIESEL STANDBY GENERATOR ON NEW
- 6'-0"X12'-0" CONCRETE PAD (4) NEW VERIZON WIRELESS RAYCAPS
- (1) NEW VERIZON WIRELESS ELECTRICAL METER W/ FUSED DISCONNECT ON NEW H-FRAME
- NEW VERIZON WIRELESS 8"-0" TALL CHAIN-LINK FENCE

 (1) NEW VERIZON WIRELESS 8"-0" TALL CHAIN-LINK FENCE

 (1) NEW VERIZON WIRELESS TRANSFORMER ON NEW 3"-0" X 3"-0" CONCRETE PAD

PROJECT SUMMARY



veri<u>zon</u> 2785 MITCHELL DRIVE, BLDG 9 WALNUT CREEK, CA 94598 OFFICE: (925) 279-6000

APPLICANT'S REPRESENTATIVE

BUELLTON, CA 93427 CONTACT: KELLY MCCURNIN TELEPHONE: (805) 686-4039

PROPERTY OWNER:

LOS PADRES COUNCIL

PROPERTY INFORMATION:

SITE NAME: LAKE CACHUMA SITE NUMBER: 276864 SITE ADDRESS: 270004
2680 HWY 154
SANTA BARBARA CA, 93105
JURISDICTION: SANTA BARBARA COUNTY

CONSTRUCTION INFORMATION

AREA OF CONSTRUCTION: 22'-6" x 39'-5" = 882 SQ FT

OCCUPANCY: TYPE OF CONSTRUCTION:

CURRENT ZONING: HANDICAP REQUIREMENTS:

FACILITY IS UNMANNED AND NOT FOR HUMAN HABITATION, HANDICAPPED ACCESS NOT REQUIRED.

GENERAL CONTRACTOR NOTES

DO NOT SCALE DRAWINGS IF NOT FULL SIZE (24 X 36)

CONTRACTOR SHALL VERIFY ALL PLANS AND EXISTING DIMENSIONS AND CONDITIONS ON THE JOB SITE AND SHALL IMMEDIATELY NOTIFY THE ARCHITECT IN WRITING OF ANY DISCREPANCIES BEFORE PROCEEDING WITH THE WORK OR BE RESPONSIBLE FOR THE

CODE COMPLIANCE

- 2013 CALIFORNIA ENERGY CODE

- 2013 CALIFORNIA GREEN BUILDING CODE
- 2013 CALIFORNIA MECHANICAL CODE 2013 CALIFORNIA PLUMBING CODE

ASSESSOR'S PARCEL NUMBER



SHEET	DESCRIPTION	REV
T-1	TITLE SHEET	2
T-2	NOTES, LEGEND & ABBREVIATIONS	2
T-3	GENERAL NOTES & SPECIFICATIONS	2
C-1	SITE SURVEY	4
C-2	SITE SURVEY	4
A-1	SITE PLAN & ENLARGED SITE PLAN	2
A-2	EQUIPMENT & ANTENNA LAYOUT	2
A-3	SOUTHWEST & NORTHWEST ELEVATIONS	2
A-4	NORTHEAST & SOUTHEAST ELEVATIONS	2
A-5	EQUIPMENT SCHEMATIC	2
A-6	DETAILS	2
A-7	DETAILS	2
A-8	STANDBY GENERATOR SPECS & ANCHORAGE DETAILS	2
E-1	1-LINE DIAGRAM, PANEL SCHEDULE & UTILITY NOTES	2
E-2	PG&E CONSTRUCTION SKETCH & 1-LINE DIAGRAM	2
G-1	GROUNDING PLAN & NOTES	2
G - 2	GROUNDING DETAILS	2
	50'-0" TALL MONOEUCALYPTUS BY CELL TREES INC.	
T-1	TITLE SHEET	0
S-1	ELEVATION VIEW AND NOTES	0
S-2	DETAILS	0
S-3	ANTENNA MOUNT DETAILS	0
S-4	FOUNDATION	0
S - 5	SPECIAL INSPECTION AND BRANCH TABLES	0

CONSTRUCTION DRAWINGS

SAC WIRELESS SIGNATURE BLOCK					
DISCIPLINE:	SIGNATURE:	DATE:			
SITE ACQUISITION:					
PLANNER:					
CONSTRUCTION:		6/30/15			
LANDLORD:					

www.sacw.com 760,795,5200 PROPRIETARY INFORMATION

THE INFORMATION CONTAINED IN THIS SET OF DRAWINGS IS PROPRIETARY & CONFIDENTIAL TO VERIZON WIRELESS

ISSUE STATUS

DESCRIPTION 90% CONSTRUCTION

95% CONSTRUCTION SR

OUTDOOR EQUIPMENT | EC

DATE

1 02/26/15

2 03/16/15

Y USE OR DISCLOSURE OTHER THAN AS IT RELATE TO VERIZON WIRELESS IS STRICTLY PROHIBITED



2680 HWY 154 SANTA BARBARA CA, 93105 276864 CHUMA ഗ

SHEET TITLE:

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TITLE SHEET

T-1

GENERAL FIRE NOTES: (SFM)

- BUILDINGS UNDERGOING CONSTRUCTION, ALTERATION, OR DEMOLITION SHALL BE IN ACCORDANCE WITH 2013 CFC SECTION 1401.
- IN A POSITION AS TO BE PLAINLY VISIBLE AND LEGIBLE FROM THE STREET OR ROAD FRONTING THE PROPERTY. [2013 CFC SECTION 505.1]
- 3. DECORATIVE MATERIALS SHALL BE MAINTAINED IN A FLAME-RETARDANT
- 4. PORTABLE FIRE EXTINGUISHERS: FURTABLE FIRE EXTINGUISHERS WITH A MINIMUM RATING OF 2-A-10B:C SHALL BE PROVIDED WITHIN 75 FEET MAXIMUM TRAVEL DISTANCE FOR EACH 6,000 SQUARE FEET OR PORTION THEREOF ON EACH FLOOR.

STORM WATER QUALITY NOTES CONSTRUCTION BMP'S:

NOTES 1-5 BELOW REPRESENT KEY MINIMUM REQUIREMENTS FOR CONSTRUCTION BMP'S

- 1. SUFFICIENT BMP'S MUST BE INSTALLED TO PREVENT SILT, MUD OR OTHER CONSTRUCTION DEBRIS FROM BEING TRACKED INTO THE ADJACENT STREET(S) OR STORM WATER CONVEYANCE SYSTEM DUE TO CONSTRUCTION VEHICLES OR ANY OTHER CONSTRUCTION ACTIVITY. THE CONTRACTOR SHALL BE RESPONSIBLE FOR CLEANING ANY SUCH DEBRISTHAT MAY BE IN THE STREET ATTHE END OF EACH WORK DAY OR AFTER A STORM EVENT THAT CAUSES A BREECH IN THE INSTALLED CONSTRUCTION BMP'S.
- 2. A CONCRETE WASHOUT SHALL BE PROVIDED ON ALL PROJECTS WHICH PROPOSE THE CONSTRUCTION OF ANY CONCRETE IMPROVEMENTS THAT ARE TO BE POURED INTO PLACE ON THE SITE.
- 3. ALL EROSION/SEDIMENT CONTROL DEVICES SHALL BE MAINTAINED IN WORKING ORDER AT ALL TIMES.
- ALL SLOPES THAT ARE CREATED OR DISTURBED BY CONSTRUCTION ACTIVITY MUST BE PROTECTED AGAINST EROSION AND SEDIMENT TRANSPORT AT ALL TIMES.
- 5. THE STORAGE OF ALL CONSTRUCTION MATERIALS AND EQUIPMENT MUST BE PROTECTED AGAINST ANY POTENTIAL RELEASE OF POLLUTANTS INTO THE ENVIRONMENT.

5865 AVENIDA ENCINAS CARLSBAD, CA 92008

2

DATE

0 02/17/15

2 03/16/15

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www.sacw.com 760,795,5200

ISSUE STATUS

1 02/26/15 95% CONSTRUCTION SR

DESCRIPTION BY

90% CONSTRUCTION | SR

OUTDOOR EQUIPMENT | EC



NEW ANTENNA PROPERTY/LEASE LINE (E) MASONRY E ELECTRICAL CONDUIT (POWER) EXISTING ANTENNA — — CENTERLINE CONCRETE \otimes GROUND ROD ---- OH/E ---- OVERHEAD ELECTRICAL GROUND BUS BAR MATCH LINE —— UG/E —— UNDERGROUND ELECTRICAL MECHANICAL GRND, CONN. GRAVEL — T — TELEPHONE CONDUIT \otimes GROUND ACCESS WELL GROUND CONDUCTOR GROUT OR PLASTER ---- OH/T ---- OVERHEAD TELCO Е ELECTRIC BOX (x)GRID REFERENCE ---- UG/T ---- UNDERGROUND TELCO PLYWOOD Т TELEPHONE BOX DETAIL REFERENCE — E/T — ELECTRICAL / TELCO CONDUIT ⇔ SAND LIGHT POLE (POWER & FIBER) 0 FND, MONUMENT ----- OH/ET ----- OVERHEAD POWER & TELCO ELEVATION REFERENCE SPOT ELEVATION ---- UG/ET ---- UNDERGROUND POWER & TELCO EXISTING CHAIN-LINK SET POINT \triangle FENCING SECTION REFERENCE — CC — COAXIAL CABLE ■■■ NEW CHAIN-LINK FENCING Δ REVISION - FIBER / HYBRID O WROUGHT IRON FENCING WOOD CONT. $\overline{}$ ────── WOOD FENCING WOOD BLOCKING

LEGEND

ABBREVIATION

NOTES

DEFINITION **ABBREVIATION** DEFINITION ANCHOR BOLT FABRICATION(OR) FINISH FLOOR FINISH GRADE FINISH(ED)

ABV.
ACCA
ADD'IL
AF.F.
AF.G.
AF.G.
AF.G.
AF.G.
AF.G.
BLDG.
BLDG.
BLDG.
BLDG.
BLDG.
BLDG.
CANT.
C.I.P.
CANT.
CONC.
CONST.

DEPT.
DIA.
DIA.
DIM.
DWG.
DWG.
DWG.
DWG.
DWG.
DWG.
DWG.
EA. ANTENNA CABLE COVER ASSEMBLY ANTERNA CABLE COVER A
ADDITIONAL
ABOVE FINISHED FLOOR
ABOVE FINISHED GRADE
ALUMINUM
ALTERNATE
ANTENNA
APPROXIMATE(LY) ARCHITECTURA AMERICAN WIRE GAUGE BUILDING BLOCK BLOCKING BEAM
BOUNDARY NAILING
BOUNDARY NAILING
BARE TINNED COPPER WIRE
BOTTOM OF FOOTING
BACK-UP CABINET
CABINET
CASTINE VER(ED)
CAST IN PLACE
CELLING
CLEAR
COLLAN
COMCPETE COLUMN
CONCRETE
CONNECTION(OR)
CONSTRUCTION
CONTINUOUS
PENNY (NAILS)
DOUBLE
DEPARTMENT
DOUGLAS FIR
DIAMETER
DIAMETER
DIAMETER
DIAMETER DIMENSION DRAWING(S DOWEL(S) EA.
ELEC.
ELEV.
EMT.
E.N.
ENG.
EQ.
EXP.
EXST.(E) ELEVATION

ELECTRICAL

ELECTRICAL
ELEVATOR
ELECTRICAL METALLIC TUBING
EDGE NAIL
ENGINEER
EQUAL
EXPANSION
EXISTING
EXISTING
EXTERIOR

F.F. F.G. FIN. FLR. F.O.C. F.O.M. F.O.S. F.O.W. F.S. FT.(') FTG. FTG.
G.
GA.
GI.
G.F.I.
GLB.(GLU-LAM)
GPS
GRND.
HDR.
HGR.
HT.
ICGB. IN.(") INT. LB.(#) L.B. L.F. MAS.
MAX.
M.B.
MECH.
MFR.
MIN.
MISC.
MTL.
(N)
NO. (#)
N.T.S. O.C. OPNG. P/C PCS PLY. P.O.C. PPC PRC P.S.F.

INCH(ES) INTERIOR POUND(S)

NEW NUMBER

NOT TO SCALE
ON CENTER
OPENING
PRECAST CONCRETE
PERSONAL COMMUNICATION SERVICES

PLYWOOD
POINT OF CONNECTION
POWER PROTECTION CABINET
PRIMARY RADIO CABINET
POUNDS PER SQUARE FOOT

P.T.
PWR.
QTY.
RAD.(R)
REF.
REINF.
REQ'D.
RGS.
SCH.
SHT.
SIM.
SPEC.
SQ.
S.S. FINISH(ED)
FLOOR
FOUNDATION
FACE OF CONCRETE
FACE OF MASONRY
FACE OF STUD
FACE OF WALL
FINISH SURFACE
FOOTIGETS FOOTING GROWTH (CABINET) GROWITH (CABINET)
GAUGE
GALVANIZE(D)
GROUND FAULT CIRCUIT INTERRUPTER
GLUE LAMINATED BEAM
GLOBAL POSITIONING SYSTEM
GROUND
HEADER
HANGER
HANGER STD.
STRUC
TEMP.
THK.
T.N.
T.O.A.
T.O.C.
T.O.F.
T.O.P.
T.O.S.
T.O.W.
TYP.
U.G.
U.N.O.
V.I.F. ISOLATED COPPER GROUND BUS LINEAR FEET (FOOT) LONG(ITUDINAL) MASONRY
MASONRY
MASHMUM
MACHINE BOLT
MECHANICAL
MANUFACTURER
MINIMUM
MISCELLANEOUS
METAL

ABBREVIATION

PRESSURE TREATED POWER (CABINET) QUANTITY GUANTITY
RADIUS
REFERENCE
REINFORCEMENT(ING)
REQUIRED
RIGID GALVANIZED STEEL
SCHEDULE
SHEET SIMILAR SPECIFICATION(S) SQUARE STAINLESS STEEL STANDARD
STEEL
STRUCTURAL
TEMPORARY
THICK(NESS)
TOE NAIL
TOP OF ANTENNA
TOP OF FOUNDATION
TOP OF FUNDATION
TOP OF FUNDATION
TOP OF STEEL
TOP OF WALL
TYPICAL
UNDER GROUND
UNDERWRITERS LABORATORY
UNLESS NOTED OTHERWISE
VERIFY IN FIELD STANDARD VERIFY IN FIELD WIDE(WIDTH) WITH WITH WOOD WEATHERPROOF WEIGHT CENTERLINE

DEFINITION

POUNDS PER SQUARE INCH

1

3

T-2

2680 HWY 154 SANTA BARBARA CA, SHEET TITLE: **NOTES, LEGEND & ABBREVIATIONS**

7686

N.

#

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CHUMA

93105

NOT USED

ABBREVIATIONS

1

4

GENERAL

- THIS FACILITY IS AN UNMANNED CELLULAR TELEPHONE EQUIPMENT FACILITY. THE OCCUPANCY CLASSIFICATION IS U [2013 CBC, TITLE 24, PART 2, VOLUME 1, SECTION 312, AND SECTION 307.1 EXCEPTION #9].
- 2. THIS FACILITY IS EXEMPT FROM HANDICAP REQUIREMENTS PER 2013 CBC SECTION 11B-203.5 EXCEPTION #1 THIS FACILITY IS NON-OCCUPIABLE SPACE AND ENTERED ONLY BY SERVICE PERSONNEL. THIS SPACE IS NOT FOR HUMAN OCCUPANCY.
- 3. THE CONTRACTOR SHALL VERIFY ALL EXISTING CONDITIONS AND DIMENSIONS PRIOR TO SUBMITTING HIS BID. ANY DISCREPANCIES, CONFLICTS OR OMISSIONS SHALL BE REPORTED TO THE ENGINEER PRIOR TO SUBMITTING BIDS, AND PROCEEDING WITH ANY
- 4. THE CONTRACTOR SHALL NOTIFY ENGINEER OF ANY ERRORS, OMISSIONS, OR DISCREPANCIES AS THEY MAY BE DISCOVERED IN THE PLANS, SPECIFICATIONS, & NOTES PRIOR TO STARTING CONSTRUCTION, INCLUDING BUT NOT LIMITED BY DEMOLITION, THE CONTRACTOR SHALL BE RESPONSIBLE FOR CORRECTING ANY ERRORS, OMISSION, OS INCONSISTENCY, AFTER THE START OF CONSTRUCTION WHICH HAS NOT BEEN BROUGHT TO THE ATTENTION OF THE ARCHITECT/ENGINEER AND SHALL INCUR ANY EXPENSES TO RECTIFY THE SITUATION. THE METHOD OF CORRECTION SHALL BE APPROVED BY THE ARCHITECT OR THE ENGINEER RESPONSIBLE OF THE PROJECT.
- 5. PRIOR TO STARTING CONSTRUCTION, THE CONTRACTOR HAS THE RESPONSIBILITY TO LOCATE ALL EXISTING UTILITIES, WHETHER OR NOT SHOWN ON THE PLANS, AND TO PROTECT THEM FROM DAMAGE, THE CONTRACTOR OR SUBCONTRACTOR SHALL BEAR THE EXPENSE OF REPAIRING OR REPLACING ANY DAMAGE TO THE UTILITIES CAUSED DURING THE EXECUTION OF THE WORK, CONTACT USE A LET J. 69, 027, 2600.
- 6. PRIOR TO STARTING CONSTRUCTION, THE CONTRACTOR SHALL PROTECT ALL AREAS FROM DAMAGE WHICH MAY OCCUR DURING CONSTRUCTION. ANY DAMAGE TO NEW OR EXISTING SURFACES, STRUCTURES OR EQUIPMENT SHALL BE IMMEDIATELY REPAIRED OR REPLACED TO THE SATISFACTION OF THE PROPERTY OWNER. THE CONTRACTOR SHALL BEAR THE EXPENSE OF REPAIRING OF REPLACING ANY DAMAGED AREAS.
- 7. A COPY OF THE APPROVED PLANS SHALL BE KEPT IN A PLACE SPECIFIED BY THE GOVERNING AGENCY, AND BY LAW SHALL BE AVAILABLE FOR INSPECTION AT ALL TIMES. IT IS THE CONTRACTOR'S RESPONSIBILITY TO ENSURE ALL CONSTRUCTION SETS REFLECT THE SAME INFORMATION AS THE APPROVED PLANS. THE CONTRACTOR SHALL ALSO MAINTAIN ONE SET OF PLANS AT THE SITE FOR THE PURPOSE OF DOCUMENTING ALL AS-BUILT CHANGES, REVISIONS, ADDENDA, OR CHANGE ORDERS, THE CONTRACTOR SHALL FORWARD THE AS-BUILT CHANGES TO THE ARCHITECT OR THE ENGINEER RESPONSIBLE OF THE PROJECT AT THE CONCLUSION OF THE PROJECT.
- 8. THE CONTRACTOR SHALL BE RESPONSIBLE FOR THE COMPLETE SECURITY OF THE SITE WHILE THE WORK IS IN PROGRESS UNTIL THE JOB IS COMPLETE.
- 9. THE CONTRACTOR IS RESPONSIBLE TO PROVIDE TEMPORARY POWER, WATER, AND TOILET FACILITIES AS REQUIRED BY THE PROPERTY OWNER OR GOVERNING AGENCY.
- ALL CONSTRUCTION THROUGH THE PROJECT SHALL CONFORM TO THE LATEST C.B.C. AND ALL OTHER GOVERNING CODES, INCLUDING THE CALIFORNIA ADMINISTRATIVE CODES TITLE 8, 19, AND 24. THE MOST RESTRICTIVE CODE SHALL GOVERN.
- 11. THE CONTRACTOR AND SUBCONTRACTOR SHALL COMPLY WITH ALL LOCAL AND STATE REGULATIONS INCLUDING ALL OSHA
- 12. WHEN REQUIRED STORAGE OF MATERIALS OCCURS, THEY SHALL BE EVENLY DISTRIBUTED OVER THE FLOOR OR ROOF SO AS NOT TO EXCEED THE DESIGNED LIVE LOADS FOR THE STRUCTURE. TEMPORARY SHORING OR BRACING SHALL BE PROVIDED WHERE THE STRUCTURE OR SOIL HAS NOT ATTAINED THE DESIGN STRENGTH FOR THE CONDITIONS PRESENT.
- 13. THE CONTRACTOR SHALL SUPERVISE AND COORDINATE ALL WORK, USING HIS PROFESSIONAL KNOWLEDGE AND SKILLS. HE IS SOLELY RESPONSIBLE FOR ALL CONSTRUCTION MEANS, METHODS, TECHNIQUES, PROCEDURES AND SEQUENCING AND COORDINATING ALL PORTIONS OF THE WORK UNDER THE PROJECT.
- 14. THE CONTRACTOR SHALL BE RESPONSIBLE TO OBTAIN AND PAY FOR ALL PERMITS, LICENSES AND INSPECTIONS WITH RESPECT TO THE WORK TO COMPLETE THE PROJECT. BUILDING PERMIT APPLICATIONS SHALL BE FILED BY THE OWNER OR AUTHORIZED AGENT. CONTRACTOR SHALL OBTAIN THE PERMIT AND MAKE FINAL PAYMENT OF SAID DOCUMENT.
- 15. ALL DIMENSIONS TAKE PRECEDENCE OVER SCALE, DRAWINGS ARE NOT TO BE SCALED UNDER ANY CIRCUMSTANCES.
- 16. THE CONTRACTOR SHALL PROVIDE ALL NECESSARY BLOCKING, BACKING, FRAMING, HANGERS OR SUPPORTS FOR INSTALLATION OF ITEMS INDICATED ON THE DRAWINGS.
- 17. THE CONTRACTOR SHALL PROVIDE THE FIRE MARSHALL OR U.L APPROVED MATERIALS TO FILL/SEAL PENETRATIONS THROUGH FIRE RATED ASSEMBLIES.
- 18. NEW CONSTRUCTION ADDED TO EXISTING CONSTRUCTION SHALL BE MATCHED IN FORM, TEXTURE, MATERIAL AND PAINT COLOR EXCEPT AS NOTED IN THE PLANS.
- THE CONTRACTOR IS TO PROVIDE PORTABLE FIRE EXTINGUISHERS HAVING A MINIMUM 2A:10-B:C RATING WITHIN 75FT. OF TRAVEL
 TO ALL PORTIONS OF THE CONSTRUCTION AREA. [2013 CFC SECTION 906-1-1 AND SECTION 906.3.1]
- 20. MATERIALS TESTING SHALL BE TO THE LATEST STANDARDS AVAILABLE AS REQUIRED BY THE LOCAL GOVERNING AGENCY RESPONSIBLE FOR APPROVING THE RESULTS.
- 21. ALL GENERAL NOTES AND STANDARD DETAILS ARE THE MINIMUM REQUIREMENTS TO BE USED IN CONDITIONS WHICH ARE NOT SPECIFICALLY SHOWN OTHERWISE.
- 22. ALL DEBRIS AND REFUSE IS TO BE REMOVED FROM THE PROJECT, PREMISES SHALL BE LEFT IN A CLEAN BROOM FINISHED CONDITION AT ALL TIMES.
- 23. BUILDING INSPECTORS AND/OR OTHER BUILDING OFFICIALS ARE TO BE NOTIFIED PRIOR TO ANY GRADING AND CONSTRUCTION EFFORT AS MANDATED BY THE GOVERNING AGENCY.
- 24. ALL SYMBOLS AND ABBREVIATIONS ARE CONSIDERED CONSTRUCTION INDUSTRY STANDARDS, IF A CONTRACTOR HAS A QUESTION REGARDING THEIR EXACT MEANING THE ARCHITECT OR THE ENGINEER RESPONSIBLE OF THE PROJECT SHALL BE NOTIFIED FOR

SPECIFICATIONS

SITEWORK

- 1. THE PREPARATION OF THE SITE FOR CONSTRUCTION SHALL INCLUDE THE REMOVAL OF ALL BROKEN CONCRETE, TREE TRUNKS AND ANY OTHER DEBRIS THAT WOULD BE DAMAGING TO THE FOOTINGS OF THE NEW STRUCTURE.
- 2. BACKFILLING AT NEW TRENCHES SHALL BE OF CLEAN, STERILE SOIL HAVING A SAND EQUIVALENT OF 30 OR GREATER. BACKFILLING SHALL BE DONE IN 8 INCH LAYERS, MOISTURE CONDITIONED AND PROPERLY COMPACTED TO SPECIFIED COMPACTION PERCENTAGE PER ASTM D1557 (90% MIN.). ADEQUATE DRAINAGE SHALL BE PROVIDED SUCH THAT NO PONDING OCCURS AFTER THESE RECOMMENDATIONS ARE APPROVED BY THE PROJECT MANAGER AND ARCHITECT OR THE ENGINEER RESPONSIBLE OF THE PROJECT.
- 3. ALL FOUNDATION FOOTINGS SHALL EXTEND INTO AND BEAR AGAINST NATURAL UNDISTURBED SOIL OR APPROVED COMPACTED FILL. FOOTINGS SHALL EXTEND INTO SOIL DEPTH INDICATED ON DETAILS.
- 4. SHOULD ANY LOOSE FILL, EXPANSIVE SOIL, GROUND WATER OR ANY OTHER DANGEROUS CONDITIONS BE ENCOUNTERED DURING THE EXCAVATION FOR THE NEW FOUNDATION, THE CONTRACTOR SHALL NOTIFY THE PROJECT MANAGER OR OWNER'S REPRESENTATIVE AND ALL FOUNDATION WORK SHALL CEASE IMMEDIATELY.
- REFER TO GEOTECHNICAL REPORT PREPARED BY: SALEM ENGINEERING GROUP INC., DATED ON OCTOBER 3, 2014 FOR ANY ADDITIONAL RECOMMENDATIONS AND SITE PREPARATIONS.

CONCRETE

REINFORCEMENT

- REINFORCING STEEL SHALL CONFORM TO ASTM A 615, GRADE 40, DEFORMED UNLESS OTHERWISE NOTED. WELDED WIRE FABRIC SHALL CONFORM TO ASTM A 185 WELDED STEEL WIRE FABRIC UNLESS NOTED OTHERWISE, SPLICES CLASS "B" AND ALL HOOKS SHALL BE STANDARD LINA.
- 2. LOW HYDROGEN WELDING RODS SHALL BE USED FOR ALL WELDING OF REINFORCING BARS.
- BARS NOTED "CONT.", TYPICAL WALL REINFORCING, AND VERTICAL COLUMN REINFORCING SHALL HAVE A MINIMUM SPLICE EQUAL 40 BAR DIAMETERS LAP, OR 24" WHICHEVER IS GREATER.
- 4. REINFORCING SHALL BE SPLICED ONLY AS SHOWN OR NOTED, SPLICE AT OTHER LOCATIONS SHALL BE APPROVED BY THE ENGINEER.
- 5. SPLICES IN ADJACENT HORIZONTAL WALL REINFORCING BARS SHALL BE STAGGERED 4"-0" MINIMUM UNLESS OTHERWISE NOTED.
- ALL REINFORCING, ANCHOR BOLTS AND OTHER INSERTS SHALL BE SECURED IN PLACE PRIOR TO PLACING CONCRETE OR GROUTING MASONRY.
- 7. #5 OR LARGER REINFORCING BARS SHALL NOT BE RE-BENT WITHOUT APPROVAL OF THE ENGINEER.

BELO	W GRADE (UNFORMED)	3"	CLEAR
BELO	W GRADE (FORMED)	2"	CLEAR
WALL	.S	1"	CLEAR
COLL	JMNS	1 1/3	2" CLEAR
BEAM	IS AND GIRDERS	1 1/3	2" CLEAR
STRU	ICTURAL SLAB (ABOVE GRADE)	3/-	4" CLEAR

CONCRETE (GENERAL)

- STRUCTURAL FILL AND BACKFILL SHOULD CONSIST OF A NON-EXPANSIVE GRANULAR MATERIAL APPROVED BY THE GEOTECHNICAL ENGINEER AND PLACED IN UNIFORM 6" LIFTS.
- STRUCTURAL FILL PLACED FOR SUPPORT OF FOUNDATION SHALL BE COMPACTED TO AT LEAST 95% OF MAXIMUM DENSITY FROM ASTM D698 (STANDARD PROCTOR).
- 3. STRUCTURAL FILL UNDERNEATH FOUNDATIONS AND SLABS SHALL BE COMPACTED WITH A SMOOTH VIBRATORY COMPACTION DEVICE PRIOR TO CONCRETE PLACEMENT.
- 4. ALL CONCRETE WORK SHALL BE IN ACCORDANCE WITH ACI 31
- 5. ALL CONCRETE SHALL HAVE A MINIMUM 28-DAY COMPRESSIVE STRENGTH OF 2500 PSI. UNLESS OTHERWISE SPECIFIED. WATER CEMENTITIOUS MATERIAL/RATIO AND AIR CONTENT SHALL COMPLY WITH ACI 318 SECTION 4.1 & 4.2.
- 6. CEMENT FOR CONCRETE OR MASONRY MORTAR SHALL BE TYPE V "PORTLAND CEMENT" AND CONFORM TO ASTM C-150 STANDARDS. UNLESS OTHERWISE SPECIFIED IN GEOTECH REPORT OR IN THE DRAWINGS.
- 7. AGGREGATE FOR CONCRETE SHALL CONFORM TO ASTM C-33 STANDARDS.
- 8. CONCRETE SHALL BE DEPOSITED IN ACCORDANCE WITH 318 SECTION 5.10 RECOMMENDED PRACTICE FOR CONSOLIDATION OF CONCRETE.
- COLD WEATHER AND HOT WEATHER CONCRETE PLACEMENT SHALL BE IN ACCORDANCE WITH ACI 318 SECTION 4-2, AND SECTIONS 5-12 & 5-13.
- AFTER PLACEMENT, THE CONCRETE SHALL BE COVERED WITH A PLASTIC VAPOR BARRIER FOR A 4 TO 7 DAY INITIAL CURING PERIOD.
- 11. A MINIMUM OF THREE CONCRETE TEST CYLINDERS SHALL BE TAKEN. ONE SHALL BE TESTED AT 7 DAYS, ONE AT 28 DAYS, AND ONE HOLD CYLINDER. UNLESS OTHERWISE SPECIFIED BY GOVERNING AGENCY.
- 12. FLOOR SLABS SHALL CONFORM TO ASTM C-38 STANDARDS AND SHALL BE 3 1/2 INCHES MINIMUM THICK SEE FOUNDATION PLANS FOR REINFORCEMENT, BASE, UNDERLAYMENT, VAPOR BARRIER OR OTHER SPECIFIC REQUIREMENTS.
- 13. FLOOR SLABS SHALL BE LEVEL OR TRUE SLOPES AS SHOWN ON DRAWINGS. TOLERANCE: 1/8 INCH IN 10 FEET.
- 14. TOP OF CONCRETE SLAB TO BE 6" MINIMUM ABOVE FINISH GRADE, UNLESS OTHERWISE SPECIFIED IN THE DRAWINGS
- 15. ALL EXPOSED EDGES OF CONCRETE SHALL HAVE A 3/4" CHAMFER.
- 16. ALL EXTERIOR CONCRETE WALLS, PORCHES AND PLATFORMS ON SITE TO HAVE A ROCK SALT FINISH. (U.O.N.)
- 17. CONTRACTOR SHALL BE RESPONSIBLE FOR ACCURATE PLACEMENT OF ALL ROUGH HARDWARE AND ALL ITEMS OF OTHER TRADES REQUIRED TO BE EMBEDDED IN CONCRETE WORK.

METALS

STRUCTURAL FRAMING SYSTEM AND EQUIPMENT

- 1. CABLE LADDERS AT INTERIOR SPACES WHERE INDICATED SHALL BE 1-1/2" SOLID BAR STRINGERS TYPE
- ALL UNISTRUT SHALL BE P1000 (1-5/8").
- 3. MICROFLECT SHALL BE B 1 1 1 8 (U.N.O.) TO MATCH CABLE TRAY.
- 4. CABLE RUNS ON ROOF TOP AND OUTDOOR APPLICATIONS, SHALL BE HOT DIPPED GALVANIZED AFTER FABRICATION.
- 5. ALL ANTENNA SPECS, PER RF DATA SHEET

STRUCTURAL META

- 1. ALL STRUCTURAL STEEL SHALL COMPLY WITH MOST RECENT ASTM A-36 STANDARDS.
- 2. ALL CONNECTIONS AND FABRICATIONS SHALL COMPLY WITH MOST RECENT A.I.S.C. SPECIFICATIONS.
- 3. ALL WELDING SHALL BE PERFORMED BY OPERATORS WHO HAVE BEEN RECENTLY QUALIFIED AS PRESCRIBED IN MOST RECENT "QUALIFICATION PROCEDURE" OF THE AMERICAN WELDING SOCIETY.
- 4. USE ALL MEANS NECESSARY TO PROTECT STRUCTURAL STEEL BEFORE, DURING AND AFTER INSTALLATION AND TO PROTECT THE INSTALLED WORK AND MATERIALS OF ALL OTHER TRADES.
- IN THE EVENT OF DAMAGE IMMEDIATELY MAKE ALL REPAIRS AND REPLACEMENTS NECESSARY TO THE APPROVAL OF AND AT NO ADDITIONAL COST TO THE OWNER.
- : HIGH-STRENGTH BOLTS SHALL COMPLY WITH ASTM A-325 N. BEARING TYPE CONNECTION WITH THREADS INCLUDED IN SHEAR PLANE.
- 7. OTHER MACHINE BOLTS AND ANCHOR BOLTS SHALL MEET THE REQUIREMENTS OF ASTM A-3077, WELDS SHALL BE MADE WITH ASTM-233, E-70 SERIES ELECTRODES FOR STEEL TO STEEL CONNECTIONS. WELDING OF REINFORCING BARS SHALL BE DONE WITH ELECTRODES AS APPROVED BY A CERTIFIED TESTING LABORATORY.
- ALL FRAMING CONNECTORS SUCH AS CONCRETE ANCHORS, HOLD-DOWNS, POST BASES, FRAMING CAP, HANGER AND OTHER
 MISCELLANEOUS STRUCTURAL METALS SHALL BE AS MANUFACTURED BY SIMPSON STRONG TIE CO, OR APPROVED
 FOILURAL FAT
- ALL EXTERIOR STRUCTURAL STEEL PERMANENTLY EXPOSED TO THE WEATHER SHALL BE HOT-DIP GALVANIZING AFTER FABRICATION.
- 10. ALL WELDING DONE AFTER GALVANIZING SHALL BE PROTECTED WITH TWO (2) COATS OF "GALVANIZED" OR "GALVALOY"

MECHANICAL

- 1. REFER TO DRAWINGS FOR SITE SPECIFIC INFORMATION.
- 2. ALL MECHANICAL EQUIPMENT AND INSTALLATION TO COMPLY TO LATEST EDITION OF THE CALIFORNIA MECHANICAL CODE. (REFER TO THE COVER SHEET)
- 3. ALL PLUMBING TO COMPLY WITH THE LATEST EDITION OF THE CALIFORNIA PLUMBING CODE. (REFER TO THE COVER SHEET)
- 4. BEFORE STARTING TRENCHING, THE CONTRACTOR SHALL VERIFY LOCATION AND DEPTH OF ALL EXISTING LINES AFFECTED BY THE CONTRACT AND IMMEDIATELY NOTIFY THE PROJECT MANAGER IF ANY REROUTING OF EXISTING LINES NECESSARY.
- 5. HVAC SYSTEM (REFER TO DRAWINGS)

ELECTRICA

- 1. REFER TO DRAWINGS FOR SITE SPECIFIC INFORMATION
- 2. ALL ELECTRIC WORK TO COMPLY WITH THE LATEST EDITION OF THE CALIFORNIA ELECTRICAL CODE. (REFER TO THE COVER SHEET)
- 3. ALL INTERIOR SEISMIC UNISTRUT SHALL BE GROUNDED WITH #6 STRANDED COPPER WITH GREEN JACKET, ALL CONNECTIONS TO BE DOUBLE LUG.
- 4. BEFORE STARTING TRENCHING, THE CONTRACTOR SHALL VERIFY LOCATION AND DEPTH OF ALL EXISTING LINES AFFECTED BY THE CONTRACT AND IMMEDIATELY NOTIFY THE PROJECT MANAGER IF ANY REROUTING OF EXISTING LINES IS NECESSARY.

| SSUE STATUS | REV. | DATE | DESCRIPTION | BY | 0 02/17/15 | 90% CONSTRUCTION | SR | 1 02/26/15 | 95% CONSTRUCTION | SR | 2 03/16/15 | OUTDOOR EQUIPMENT | EC



PROPRIETARY INFORMATION
THE INFORMATION CONTAINED IN THIS SET OF
DRAWINGS IS PROPRIETARY & CONFIDENTIAL TO

NY USE OR DISCLOSURE OTHER THAN AS IT RELATE TO VERIZON WIRELESS IS STRICTLY PROHIBITED



CACHUMA
PSL # 276864
2680 HWY 154
ANTA BARBARA CA, 9310

SHEET TITLE:

GENERAL NOTES &

SPECIFICATIONS

T-3

NOTES

OWNER(S): LOS PADRES COUNCIL BOY SCOUTS OF AMERICA

APN: 145-200-005

THIS DRAWING DOES NOT REPRESENT A BOUNDARY SURVEY OF ANY PARCEL OF LAND, NOR DOES IT IMPLY OR INFER THAT A BOUNDARY SURVEY WAS PERFORMED. THIS IS A SPECIALIZED TOPOGRAPHIC MAP WITH PROPERTY AND EASEMENTS BEING A GRAPHIC DEPICTION BASED ON INFORMATION GATHERED FROM VARIOUS SOURCES OF RECORD AND AVAILABLE MONUMENTATION. PROPERTY LINES AND LINES OF TITLE WERE NEITHER INVESTIGATED NOR SURVEYED AND SHALL BE CONSIDERED APPROXIMATE ONLY. NO PROPERTY

THE EASEMENTS (IF ANY) THAT APPEAR ON THIS MAP HAVE BEEN PLOTTED BASED SOLELY ON INFORMATION CONTAINED IN THE CONDITION OF TITLE REPORT BY: FIRST AMERICAN TITLE COMPANY, ORDER NO. 4201-4568493, DATED FEBRUARY 4, 2014. WITHIN SAID TITLE REPORT THERE ARE FIFTEEN (15) EXCEPTIONS LISTED, THREE (3) OF WHICH ARE EASEMENTS AND TWO (2) OF WHICH CAN NOT BE PLOTTED.

THE UNDERGROUND UTILITIES (IF ANY) THAT APPEAR ON THIS MAP HAVE BEEN LOCATED BY FIELD OBSERVATION. THE SURVEYOR MAKES NO GUARANTEE THAT THE UNDERGROUND UTILITIES SHOWN COMPRISE ALL SUCH UTILITIES IN THE AREA, EITHER IN SERVICE OR ABANDONED. THE SURVEYOR FURTHER DOES NOT WARRANT THAT THE UNDERGROUND UTILITIES SHOWN ARE IN THE EXACT LOCATION INDICATED ALTHOUGH HE DOES STATE THAT THEY ARE LOCATED AS ACCURATELY AS POSSIBLE FROM THE INFORMATION AVAILABLE.

THE FEDERAL EMERGENCY MANAGEMENT AGENCY FLOOD RATE MAP FOR COMMUNITY NO. 06083C. PANEL

LESSOR'S PROPERTY LEGAL DESCRITPION PER TITLE REPORT:

REAL PROPERTY IN THE UNINCORPORATED AREA OF THE COUNTY OF SANTA BARBARA, STATE OF CALIFORNIA, DESCRIBED AS FOLLOWS:

PARCEL NO. 1

GOVERNMENT LOTS ONE (1) AND TWO (2), AND THE SOUTH HALF (S ½) OF THE NORTHEAST QUARTER (NE ½) OF SECTION THIRTY-TWO (32), TOWNSHIP SIX (6) NORTH, RANGE TWENTY-NINE (29) WEST, SAN BERNARDING BASE AND MERIDIAN, IN THE COUNTY OF SANTA BARBARA, STATE OF CALIFORNIA, ACCORDING

PARCEL NO. 2: ALL OF LOT FOUR (4), A PORTION OF LOT THREE (3), AND A PORTION OF THE NORTHEAST QUARTER (NE ALL OF LOT FOOR (4), A PORTION OF LOT INTERE (3), AND A PORTION OF THE NORTHEAST GOARTER (NE 4) OF THE SOUTHWEST QUARTER (SW ½) OF SECTION THIRTY—THREE (33), TOWNSHIP SIX (6) NORTH, RANGE TWENTY—NINE (29) WEST, SAN BERNARDINO BASE AND MERIDIAN, IN THE COUNTY OF SANTA BARBARA, STATE OF CALIFORNIA, ACCORDING TO GOVERNMENT SURVEY THEREOF, DESCRIBED AS FOLLOWS: BEGINNING AT THE NORTHWEST CORNER OF SAID LOT 4; THENCE SOUTH, ALONG THE WESTERLY LINE OF SAID LOT 4, TO THE SOUTHWEST CORNER THEREOF; THENCE EAST, ALONG THE SOUTH LINE OF SAID LOT, TO THE SOUTHEAST CORNER THEREOF, BEING ALSO THE NORTHWEST CORNER OF THE NORTHEAST QUARTER (NE ¼) OF THE SOUTHWEST QUARTER (SW ¼) OF SAID SECTION; THENCE SOUTH 1320 FEET TO THE SOUTHWEST CORNER OF INTER SOUTHWEST CONNER OF THE SOUTHWEST CONNER OF SAID NORTHEAST QUARTER (NE ¼) OF THE SOUTHWEST QUARTER (SW ¼), BEING ALSO THE NORTHWEST CORNER OF THE TRACT OF LAND SECONDLY DESCRIBED IN THE DEED TO ADRIAN H. COOLEY, ET UX., RECORDED DECEMBER 26, 1933, IN BOOK 295, AT PAGE IT OF OFFICIAL RECORDS OF SAID COUNTY; THENCE EAST, ALONG THE SOUTH LINE OF THE NORTHEAST QUARTER (NE ¼) OF THE SOUTHWEST QUARTER (SW ½) OF SAID SECTION 33, 1070.27 FEET TO THE SOUTHWEST CORNER OF THE TRACT OF LAND FIRSTLY DESCRIBED IN SAID DEED TO COOLEY ABOVE MENTIONED; THENCE NORTH 1645.06 FEET ALONG THE WEST LINE OF SAID TRACT OF COOLEY FIRSTLY DESCRIBED IN SAID DEED, TO THE NORTHERLY LINE OF SAID LOT 3; THENCE NORTH 62'40' WEST, ALONG THE NORTH LINE OF SAID LOTS 3 AND 4, TO THE POINT OF

APN: 145-200-005 AND 145-200-006


EASEMENT(S) PER TITLE REPORT:


4. A RIGHT OF WAY FOR DITCHES AND CANALS AS RESERVED BY THE UNITED STATES OF AMERICA IN THE PATENT RECORDED SEPTEMBER 2, 1903 IN BOOK D OF PATENTS, PAGE 173.
THE LOCATION OF THE EASEMENT CANNOT BE DETERMINED FROM RECORD INFORMATION.

5. AN EASEMENT FOR MAINTENANCE AND INCIDENTAL PURPOSES, RECORDED SEPTEMBER 24, 1935 IN BOOK 35.0, PAGE 66 OF OFFICIAL RECORDS.
IN FAVOR OF: THE UNITED STATES OF AMERICA
AFFECTS: AS DESCRIBED THEREIN

PLOTTED AS SHOWN HEREON ***

N EASEMENT FOR POLE LINES AND INCIDENTAL PURPOSES, RECORDED NOVEMBER 24, 1937 IN BOOK 418, PAGE 148 OF OFFICIAL RECORDS.
IN FAVOR OF: SANTA BARBARA TELEPHONE COMPANY, A CORPORATION AFFECTS: AS DESCRIBED THEREIN
THE LOCATION OF THE EASEMENT CANNOT BE DETERMINED FROM RECORD INFORMATION.

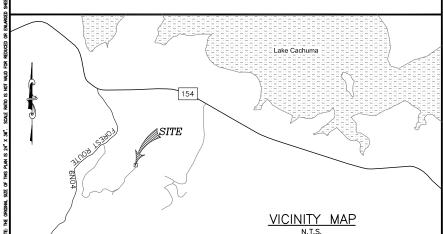

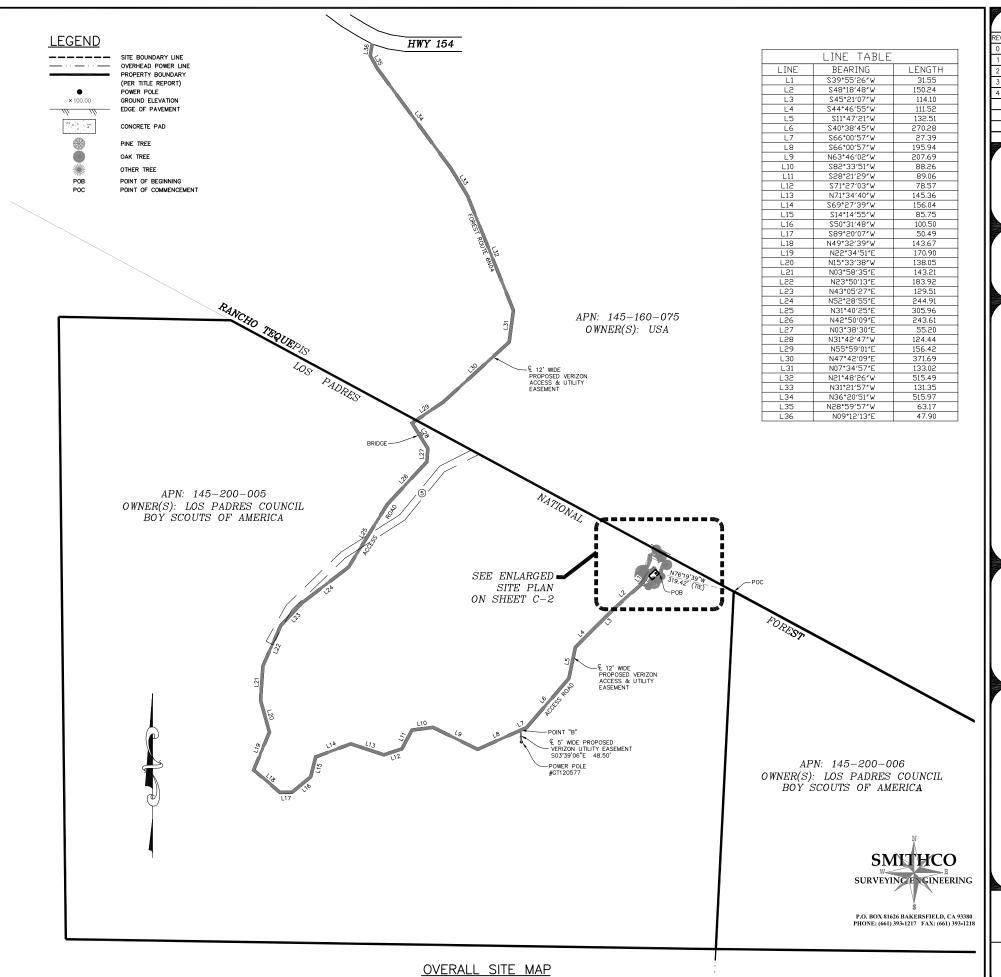

ISSUE STATUS DESCRIPTION DATE 02/19/14 PRELIMINARY 1 06/06/14 ADD LEASE/FASEMENTS 2 09/09/14 TITLE REVIEW 02/02/15 REV. LEASE/EASEMENT REV. LEASE

SMITHCO JOB NO: 82-232



WIRELESS ENIDA ENCINAS, SUI CARLSBAD, CA 92008

PROPRIETARY INFORMATION

THE INFORMATION CONTAINED IN THIS SET F DRAWINGS IS PROPRIETARY & CONFIDENTIA TO VERIZON WIRELESS

S **On**wirele.

S

LAKE **CACHUMA**

2680 HWY 154, CA 93105

SANTA BARBARA **COUNTY**

SHEET TITLE:

SITE SURVEY FOR EXAMINATION ONLY

C-1

PROPOSED VERIZON WIRELESS DEMISED PREMISE DESCRIPTION:

ALL THAT PORTION OF THE HEREON DESCRIBED LESSOR'S PROPERTY, MORE PARTICULARLY DESCRIBED AS FOLLOWS:

COMMENCING AT THE EASTERLY MOST CORNER OF SAID PROPERTY, THENCE N $76^{\circ}19'39"$ W, A DISTANCE OF 319.42 FEET TO THE TRUE POINT OF BEGINNING;

THENCE 1) S 47'45'54" W, A DISTANCE OF 39.50 FEET; N 42"14'06" W, A DISTANCE OF 19.74 FEET;

THENCE 2) THENCE 3)

N 14'16'00" E, A DISTANCE OF 5.00 FEET; N 47'45'54" E, A DISTANCE OF 29.33 FEET TO POINT "A"; THENCE 4)

CONTINUING N 47'45'54" E, A DISTANCE OF 6.00 FEET; S 42'14'06" E, A DISTANCE OF 22.50 FEET TO THE POINT OF BEGINNING. THENCE 6)

CONTAINING 883 SQUARE FEET, MORE OR LESS.

PROPOSED VERIZON WIRELESS ACCESS AND UTILITY EASEMENT DESCRIPTION:

A 12.00 FOOT WIDE NON-EXCLUSIVE EASEMENT FOR INGRESS AND EGRESS, AND UTILITY PURPOSES, THE CENTERLINE OF WHICH IS DESCRIBED AS FOLLOWS:

BEGINNING AT THE ABOVE DESCRIBED POINT "A";

N 42"14'06" W. A DISTANCE OF 6.00 FEFT: THENCE 1) \$ 47'45'54" W, A DISTANCE OF 35.54 FEET; \$ 23'10'18" W, A DISTANCE OF 18.59 FEET; \$ 39'55'26" W, A DISTANCE OF 31.55 FEET; THENCE 2) THENCE 3 THENCE \$ 4818'48" W, A DISTANCE OF 150.24 FEET; \$ 45'21'07" W, A DISTANCE OF 114.10 FEET; \$ 44'46'55" W, A DISTANCE OF 111.52 FEET; \$ 11'47'21" W, A DISTANCE OF 132.51 FEET; THENCE 5) THENCE 6) THENCE 7 THENCE 8) THENCE 9) S 40'38'45" W, A DISTANCE OF 270.28 FEET; S 66'00'57" W, A DISTANCE OF 27.39 FEET TO POINT "B"; THENCE 10) CONTINUING S 66'00'57" W, A DISTANCE OF 195.94 FEET; N 63'46'02" W, A DISTANCE OF 207.69 FEET; THENCE 11) THENCE 12) THENCE S 82'33'51" W, A DISTANCE OF 88.26 FEET; S 28'21'29" W. A DISTANCE OF 89.06 FEET; THENCE 14) S 26 21 29 W, A DISTANCE OF 69.06 FEET;
N 71'34'40" W, A DISTANCE OF 145.36 FEET;
N 71'34'40" W, A DISTANCE OF 156.04 FEET;
S 69'27'39" W, A DISTANCE OF 156.04 FEET;
S 50'31'48" W, A DISTANCE OF 85.75 FEET; THENCE THENCE 16) THENCE THENCE 18) THENCE 19) S 89'20'07" W. A DISTANCE OF 50.49 FEET: THENCE 20) N 4932'39" W, A DISTANCE OF 143.67 FEET; N 22'34'51" E, A DISTANCE OF 170.90 FEET; N 15'33'38" W, A DISTANCE OF 138.05 FEET; THENCE 21) THENCE 22) THENCE 23) THENCE 24) THENCE 25) N 03'58'35" E, A DISTANCE OF 143.21 FEET; N 23'50'13" E, A DISTANCE OF 183.92 FEET; N 43'05'27" E, A DISTANCE OF 129.51 FEET; N 52'28'55" E, A DISTANCE OF 244.91 FEET; THENCE 26) THENCE 27) N 31'40'25" E, A DISTANCE OF 305.96 FEET; N 42'50'09" E, A DISTANCE OF 243.61 FEET; THENCE 28) THENCE 29) N 03'38'30" E, A DISTANCE OF 55.20 FEET; N 31'42'47" W, A DISTANCE OF 124.44 FEET THENCE 30) THENCE 31) N 55.59'01" E, A DISTANCE OF 156.42 FEET; N 47*42'09" E. A DISTANCE OF 371.69 FEET THENCE 33) N 07'34'57" E, A DISTANCE OF 133.02 FEET N 21'48'26" W, A DISTANCE OF 515.49 FEET; N 31'21'57" W, A DISTANCE OF 131.35 FEET; N 36'20'51" W, A DISTANCE OF 515.97 FEET; N 28'59'57" W, A DISTANCE OF 63.17 FEET; THENCE 35) THENCE 37) THENCE 38) N 09"2'13" E, A DISTANCE OF 47.90 FEET TO THE SOUTHERLY LINE OF STATE HIGHWAY 154 AND THE TERMINUS OF THIS DESCRIPTION. THENCE 39)


PROPOSED VERIZON WIRELESS UTILITY EASEMENT DESCRIPTION:

A 5.00 FOOT WIDE EASEMENT FOR UTILITY PURPOSES, THE CENTERLINE OF WHICH IS DESCRIBED AS FOLLOWS:

THE SIDELINES SHALL BE SHORTENED OR LENGTHENED TO INTERSECT WITH SAID SOUTHERLY LINE OF STATE HIGHWAY 154.

BEGINNING AT THE ABOVE DESCRIBED POINT "B";

THENCE 1) S 03'39'06" E, A DISTANCE OF 48.50 FEET TO THE TERMINUS OF THIS DESCRIPTION.

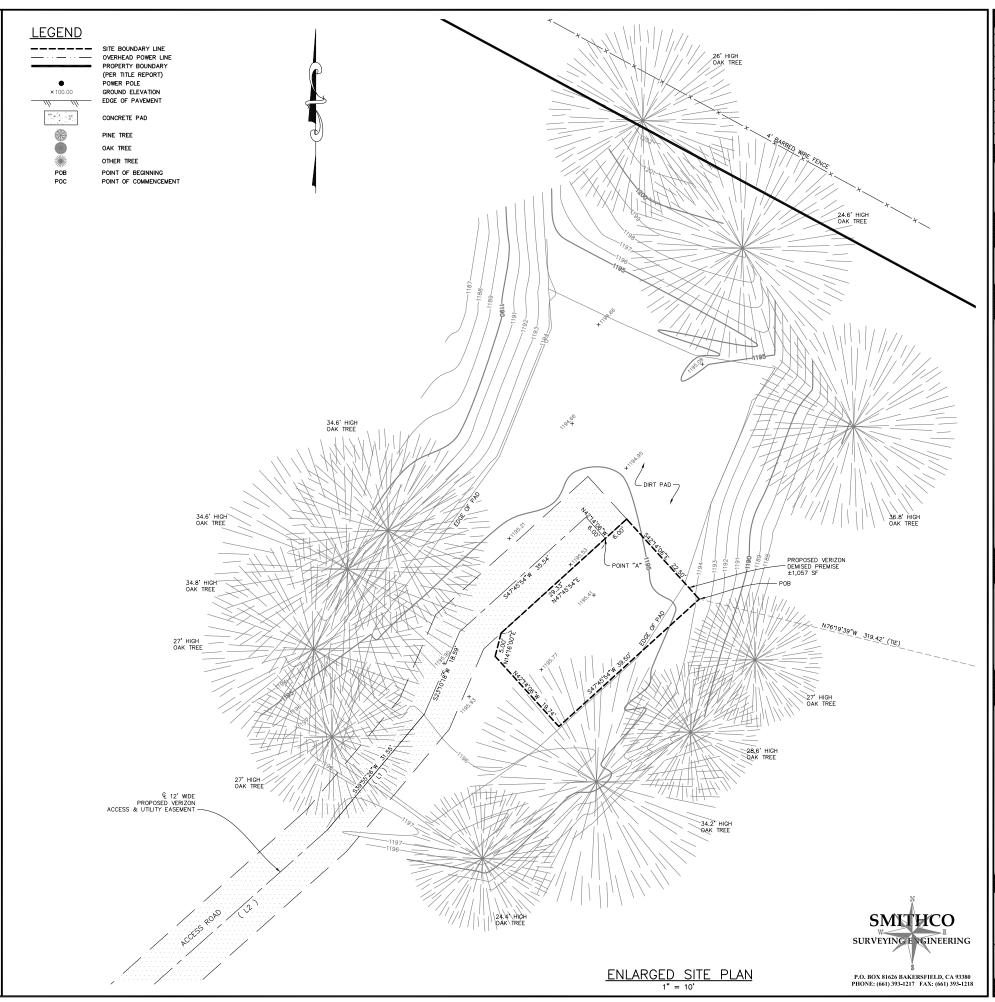

ISSUE STATUS DESCRIPTION DATE 02/19/14 PRELIMINARY 1 06/06/14 ADD LEASE/EASEMENT 2 09/09/14 TITLE REVIEW 02/02/15 REV. LEASE/EASEMENT REV. LEASE

SMITHCO JOB NO: 82-232

WIRELESS

PROPRIETARY INFORMATION THE INFORMATION CONTAINED IN THIS SET F DRAWINGS IS PROPRIETARY & CONFIDENTIA TO VERIZON WIRELESS

S **On**wireles. BLDG

CA

LAKE **CACHUMA**


2680 HWY 154, CA 93105


SANTA BARBARA COUNTY

SHEET TITLE:

SITE SURVEY FOR EXAMINATION ONLY


C-2

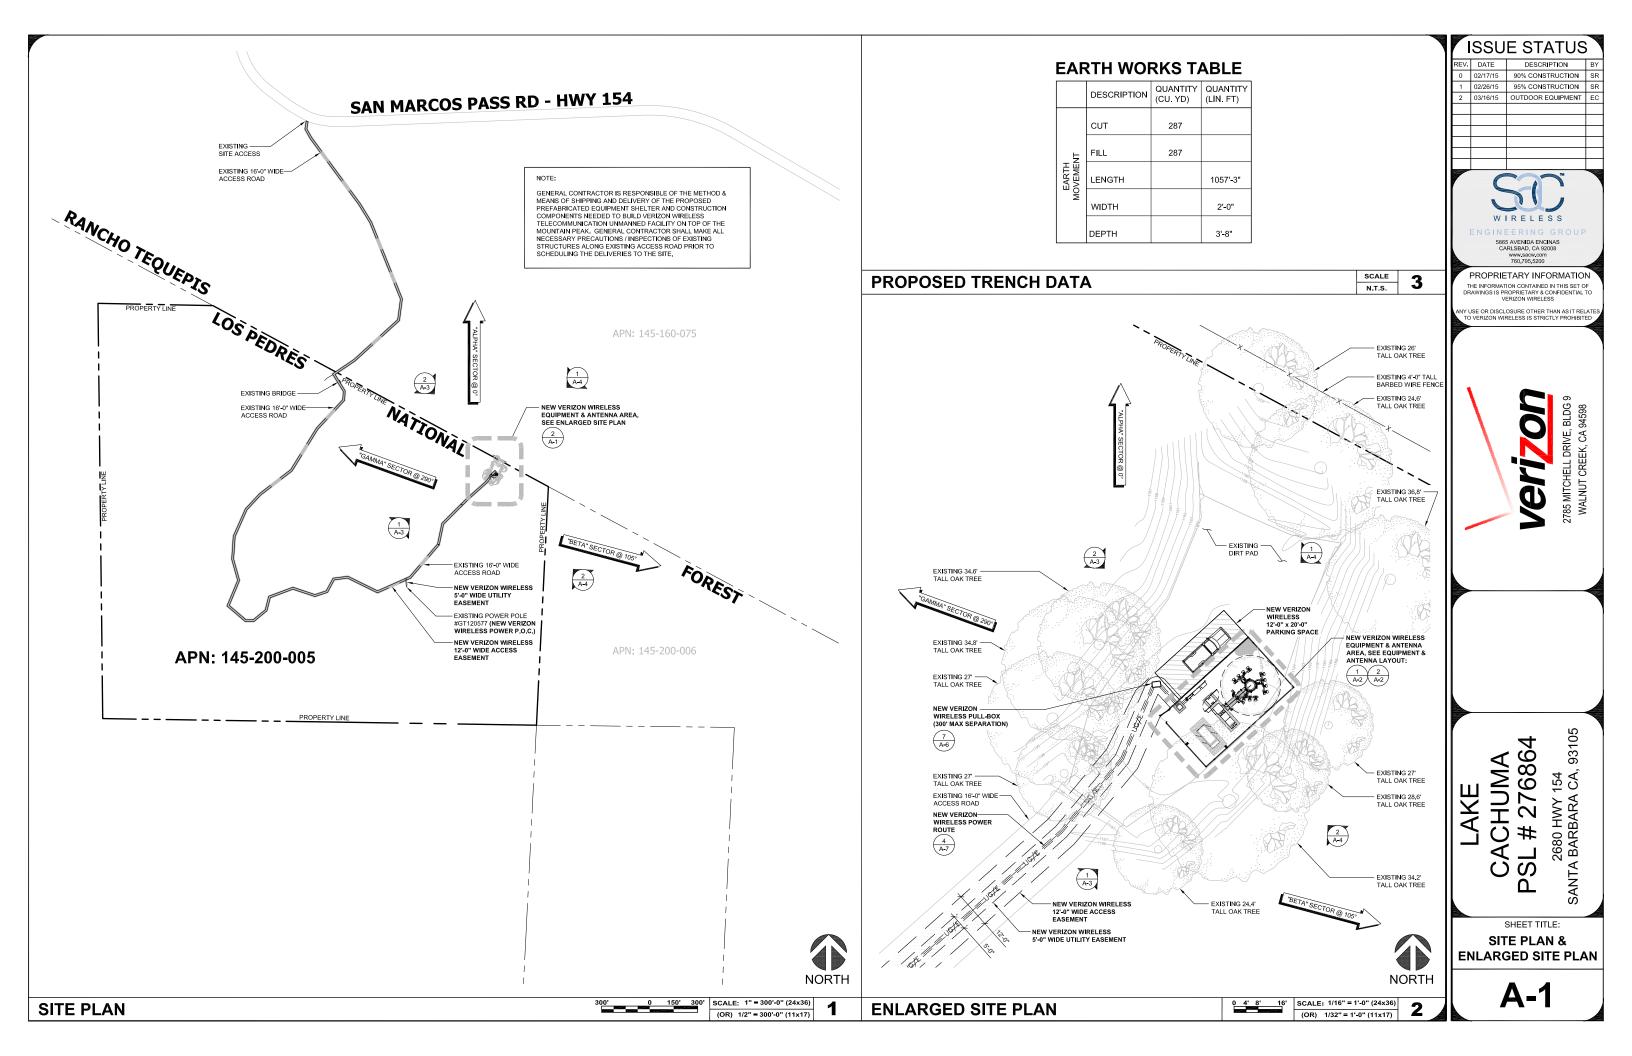


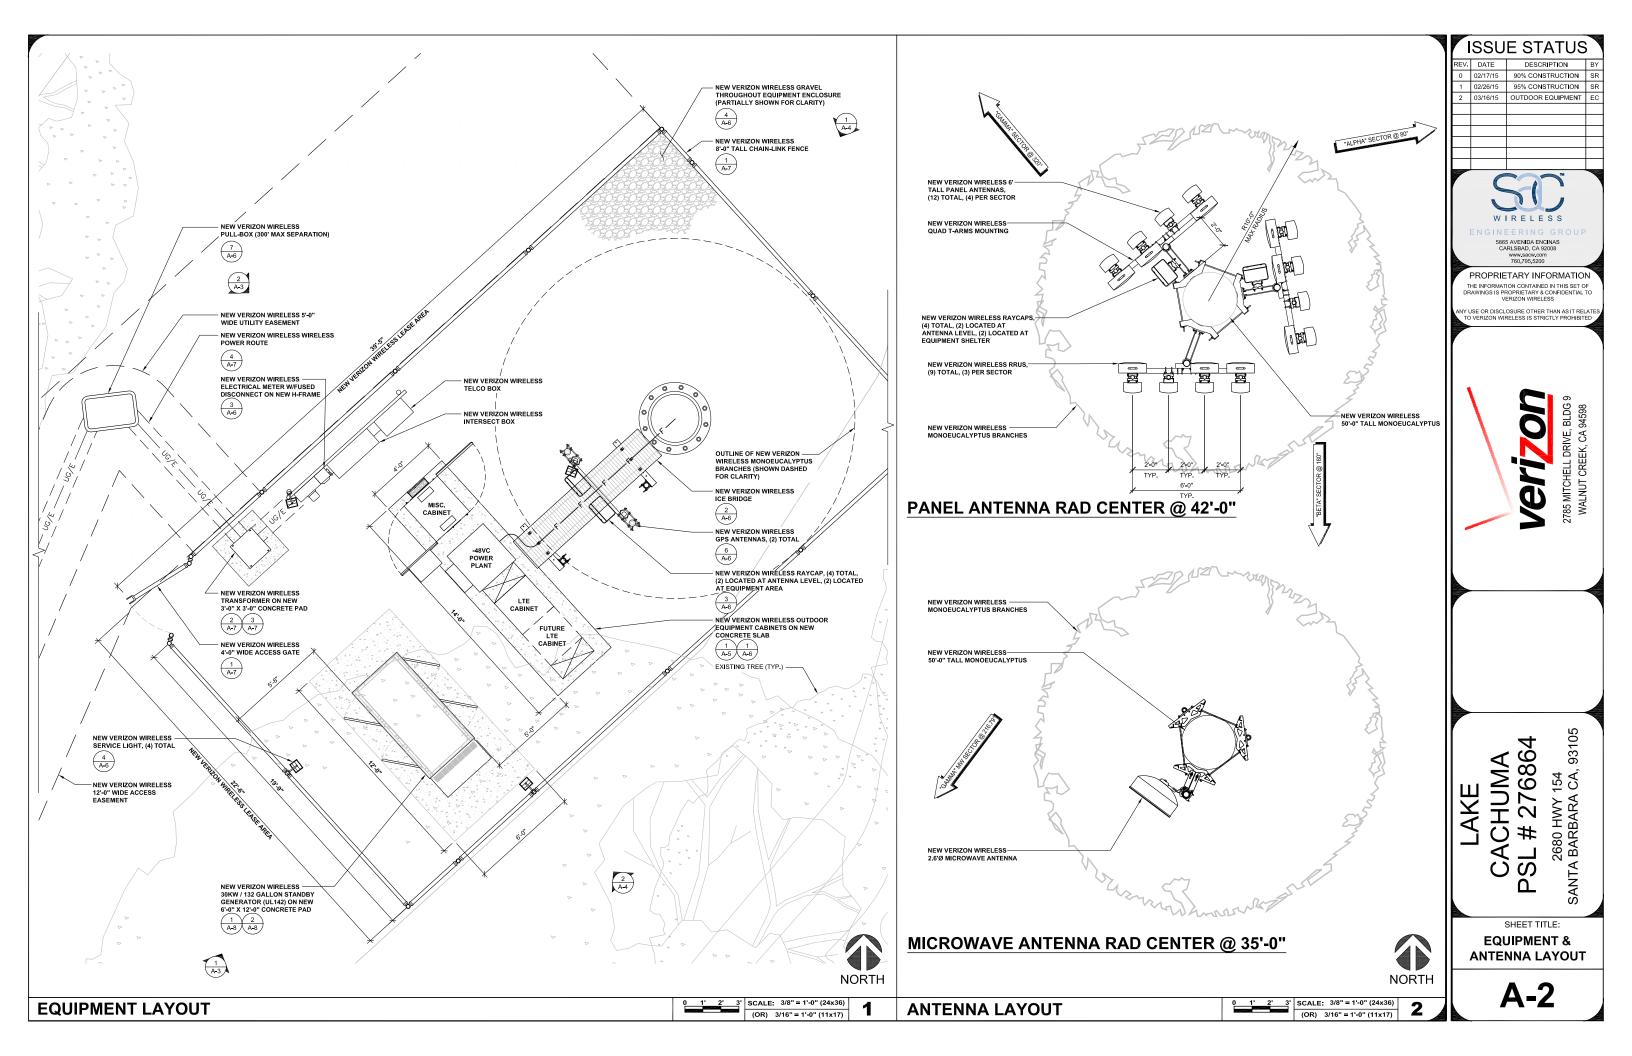



- ANTENNAS TO BE COVERED WITH ANTENNA SOCKS WITH EUCALYPTUS LEAVES
 ALL EXPOSED ANTENNA COMPONENTS AND SUPPORTED EQUIPMENT TO BE PAINTED "BLACKENED BEAM"
 EXTERIOR WALLS OF EQUIPMENT SHELTER TO BE EXPOSED AGGREGATE FINISH

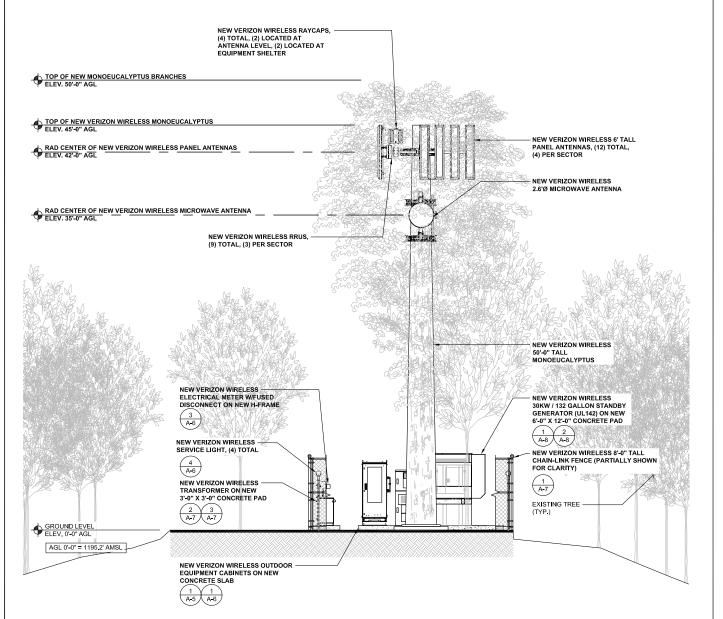

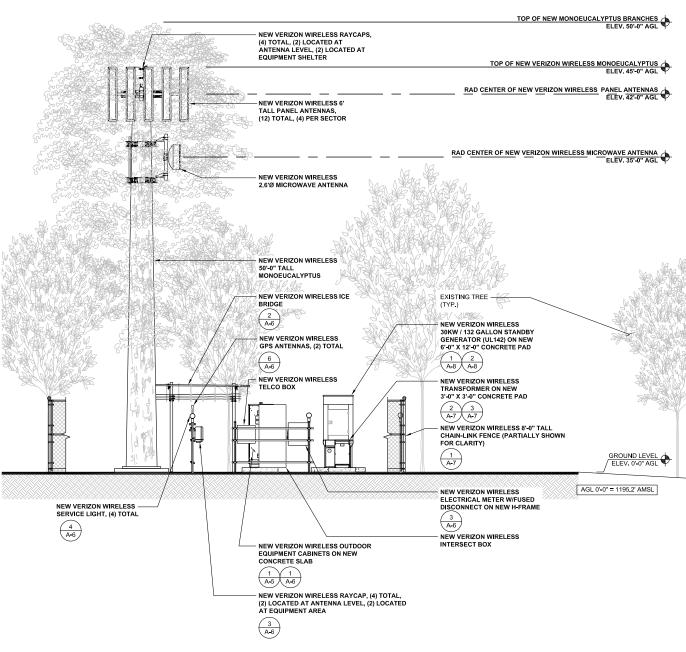

90% CONSTRUCTION 1 02/26/15 95% CONSTRUCTION SR 2 03/16/15 OUTDOOR EQUIPMENT | EC 5865 AVENIDA ENCINAS CARLSBAD, CA 92008 www.sacw.com 760.795.5200 PROPRIETARY INFORMATION THE INFORMATION CONTAINED IN THIS SET OF DRAWINGS IS PROPRIETARY & CONFIDENTIAL TO VERIZON WIRELESS Y USE OR DISCLOSURE OTHER THAN AS IT RELATE TO VERIZON WIRELESS IS STRICTLY PROHIBITED 2785 MITCHELL DRIVE, BLDG 9 WALNUT CREEK, CA 94598

ISSUE STATUS

DESCRIPTION


DATE

2680 HWY 154 SANTA BARBARA CA, 93105 276864 ACHUMA S

SHEET TITLE:
SOUTHWEST & NORTHWEST **ELEVATIONS**

Δ


A-3

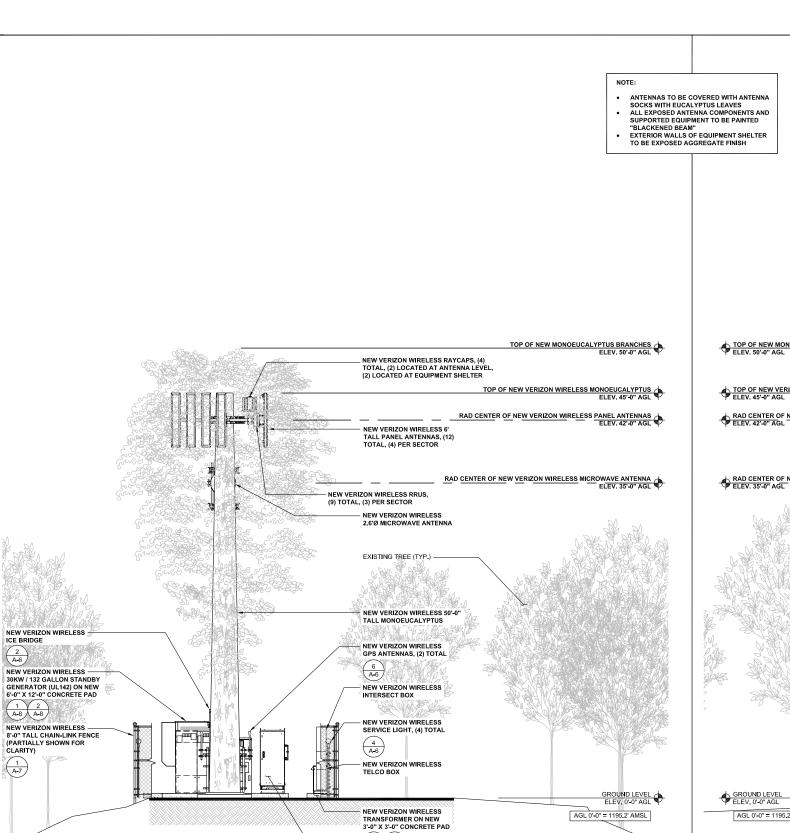

 $\begin{pmatrix} 2 & 3 \\ A-7 & A-7 \end{pmatrix}$

1 1 A-5 A-6

NEW VERIZON WIRELESS OUTDOOR EQUIPMENT CABINETS ON NEW CONCRETE SLAB

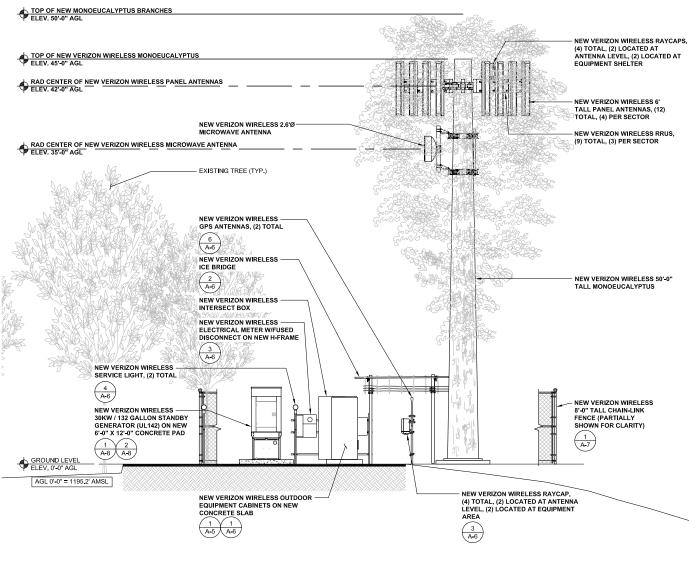

ISSUE STATUS DESCRIPTION 90% CONSTRUCTION 1 02/26/15 95% CONSTRUCTION SR 2 03/16/15 OUTDOOR EQUIPMENT | EC 5865 AVENIDA ENCINAS CARLSBAD, CA 92008 www.sacw.com 760,795,5200 PROPRIETARY INFORMATION THE INFORMATION CONTAINED IN THIS SET OF DRAWINGS IS PROPRIETARY & CONFIDENTIAL TO VERIZON WIRELESS Y USE OR DISCLOSURE OTHER THAN AS IT RELATE TO VERIZON WIRELESS IS STRICTLY PROHIBITED 276864 ACHUMA S Δ SHEET TITLE:
NORTHEAST &

2785 MITCHELL DRIVE, BLDG 9 WALNUT CREEK, CA 94598

2680 HWY 154 SANTA BARBARA CA, 93105

SCALE: 3/16" = 1'-0" (24x36) (OR) 3/32" = 1'-0" (11x17)

SOUTHEAST **ELEVATIONS**

SCALE 3 **NOT USED** PROPOSED OUTDOOR EQUIPMENT LAYOUT SCALE: 1/4'=1'-0' NDTES: BATT CAB = CHARLES INDUSTRIES W/ 3 STRINGS OF 180AH BATTERIES (540AH) LTE/AWS/PCS RRH'S SITE HAS GENERATOR



2785 MITCHELL DRIVE, BLDG 9 WALNUT CREEK, CA 94598

ISSUE STATUS

DESCRIPTION


REV. DATE


SHEET TITLE: EQUIPMENT SCHEMATIC


A-5


2

N.T.S.

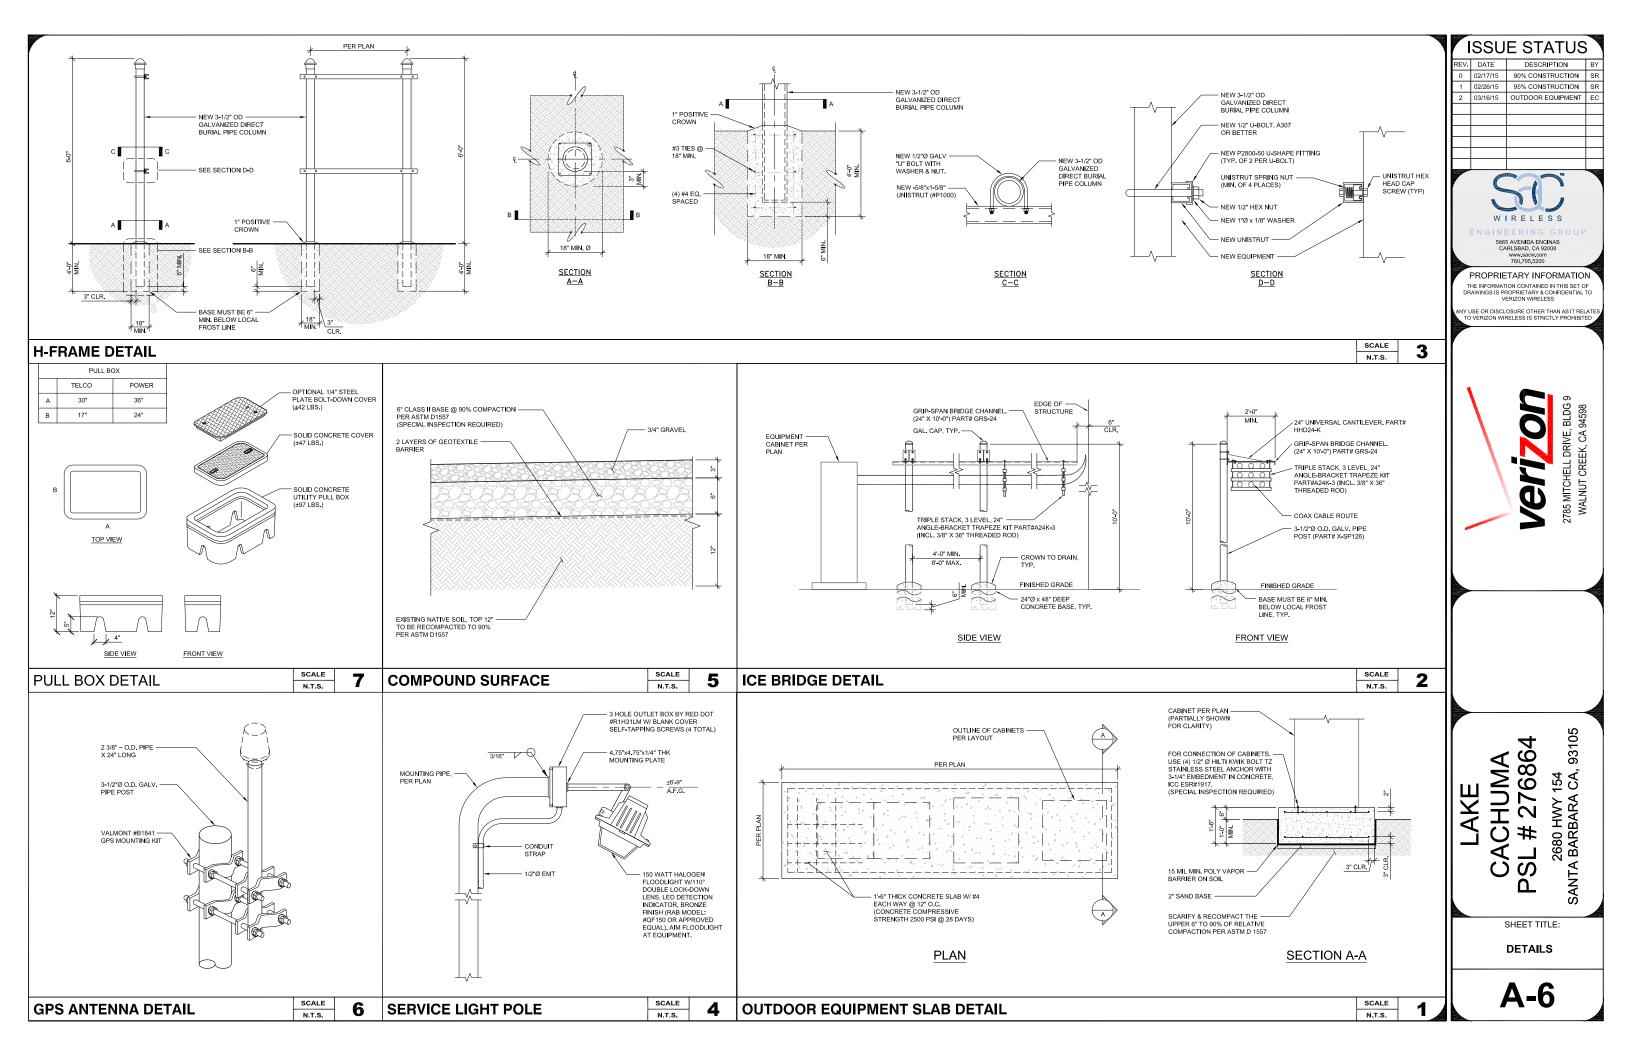


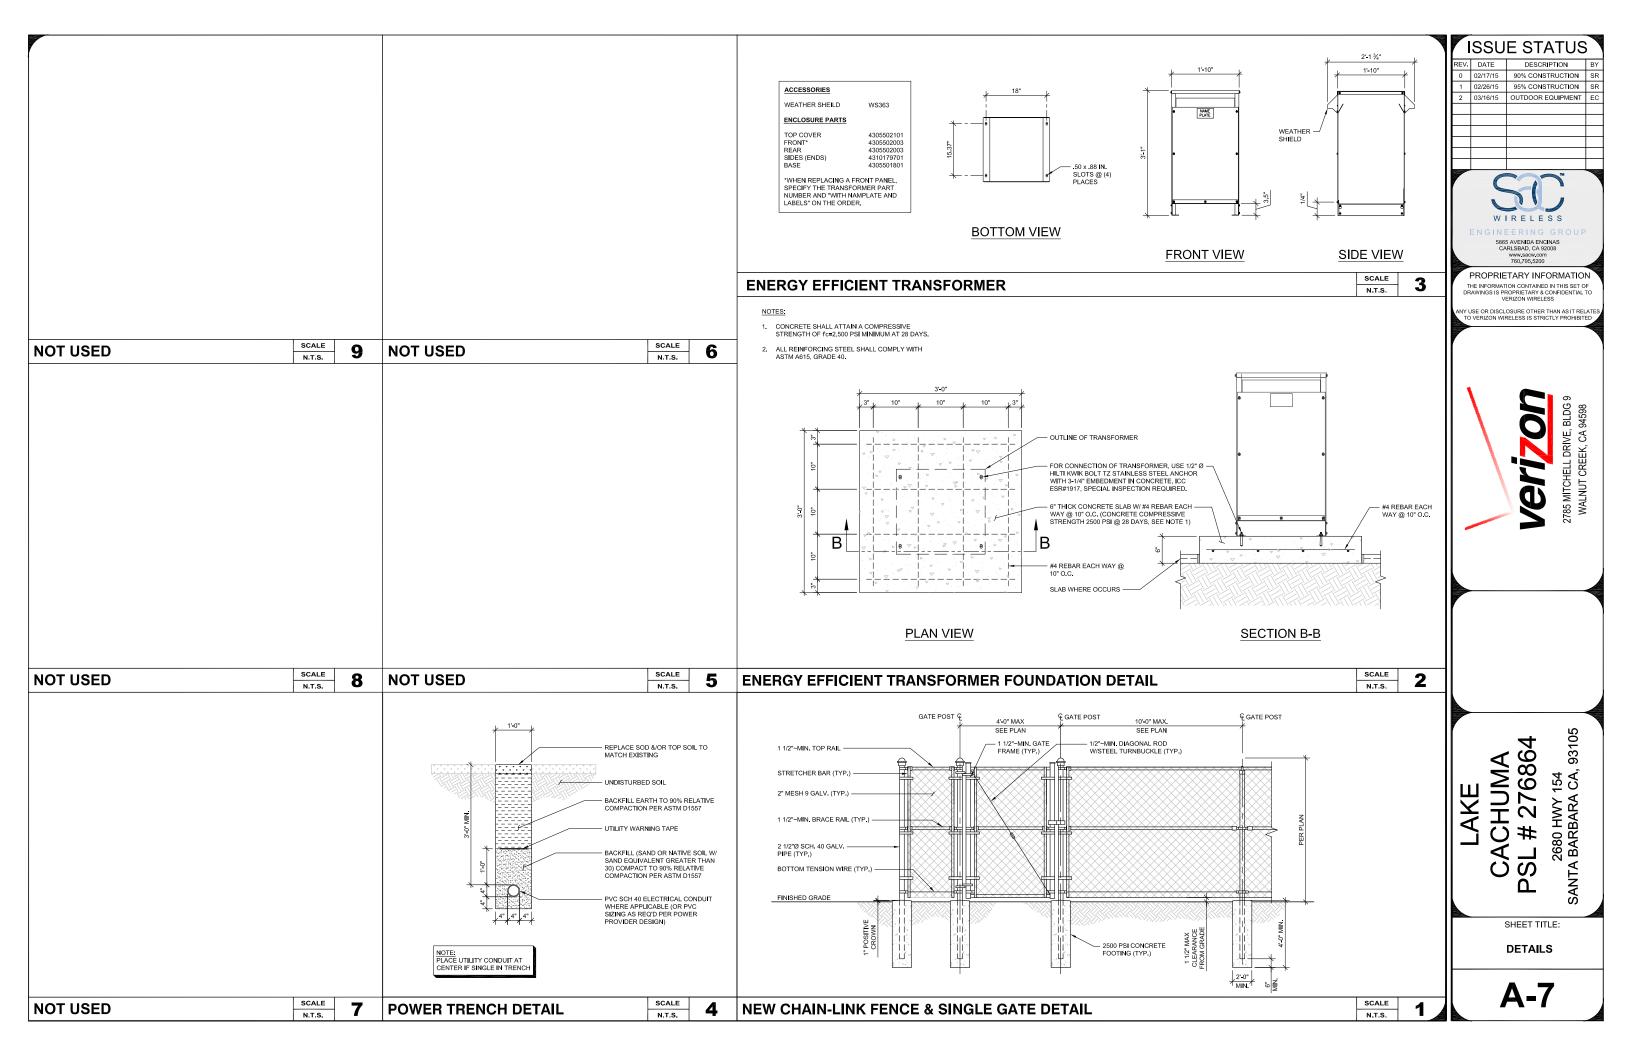


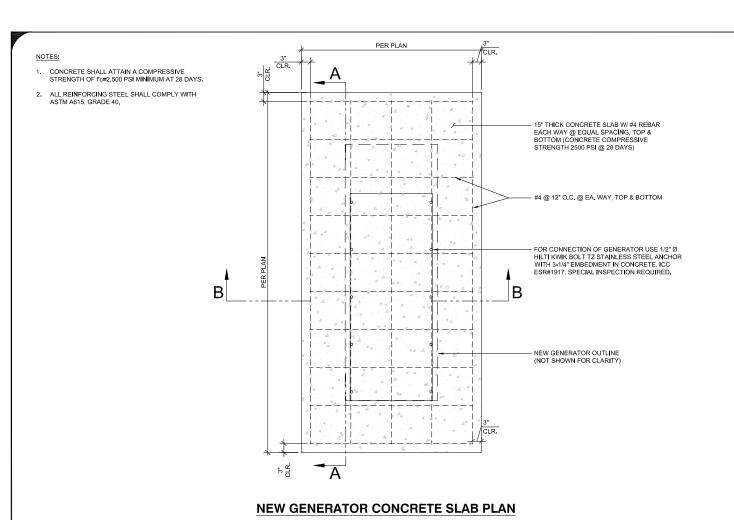

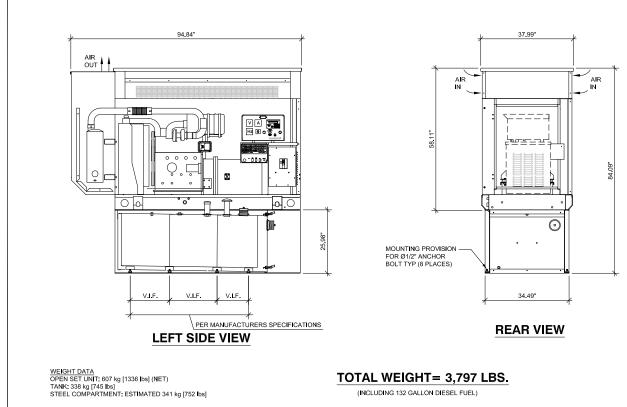

NEW VERIZON WIRELESS 30KW GENERACS INANG VERY GENERATOR 1/2*O HILT IKWIK BOLIT TZ STAINLESS STEEL AMONOR WIRI 1-3/4" ENBEDMENT NSSPECTION REGULARS 34* CHAMFER (I'VP.) 34* CHAMFER (I'VP.) GENERATOR CONCRETE SLAB DETAIL SECTION A-A SCARRY AND RECOMPACT THE UPPER 6*TO 90% RELATIVE COMPACT THE UPPER 6*TO 90% RELATIV

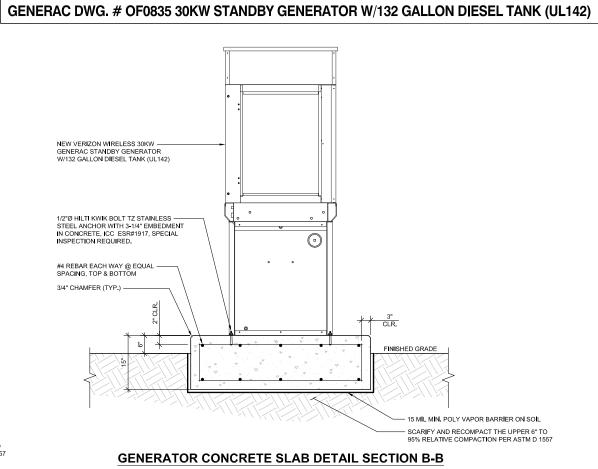

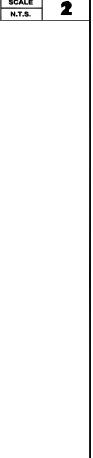

DESCRIPTION 90% CONSTRUCTION 1 02/26/15 95% CONSTRUCTION SR 2 03/16/15 OUTDOOR EQUIPMENT | EC PROPRIETARY INFORMATION THE INFORMATION CONTAINED IN THIS SET OF DRAWINGS IS PROPRIETARY & CONFIDENTIAL TO VERIZON WIRELESS Y USE OR DISCLOSURE OTHER THAN AS IT RELAT TO VERIZON WIRELESS IS STRICTLY PROHIBITED


ISSUE STATUS

CACHUMA
PSL # 276864

2680 HWY 154
SANTA BARBARA CA, 93105

SHEET TITLE:
STANDBY GENERATOR
SPECS &
ANCHORAGE DETAILS

A-8

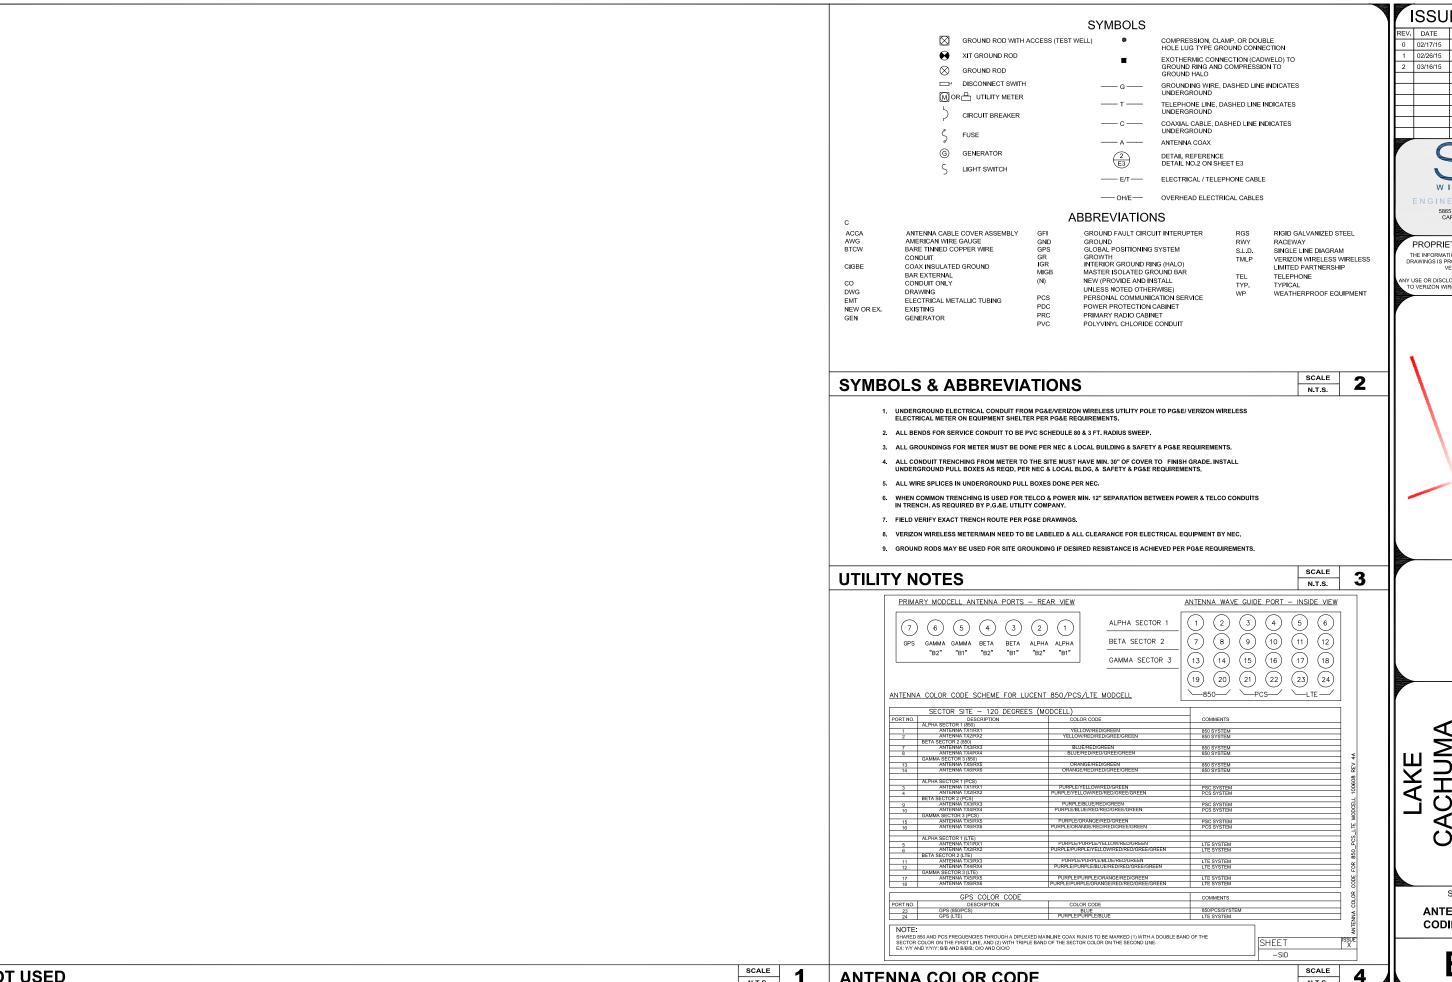

ISSUE STATUS

REV. DATE DESCRIPTION BY 90% CONSTRUCTION 1 02/26/15 95% CONSTRUCTION SR OUTDOOR EQUIPMENT | EC



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ANY USE OR DISCLOSURE OTHER THAN AS IT RELATE TO VERIZON WIRELESS IS STRICTLY PROHIBITED



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SHEET TITLE:

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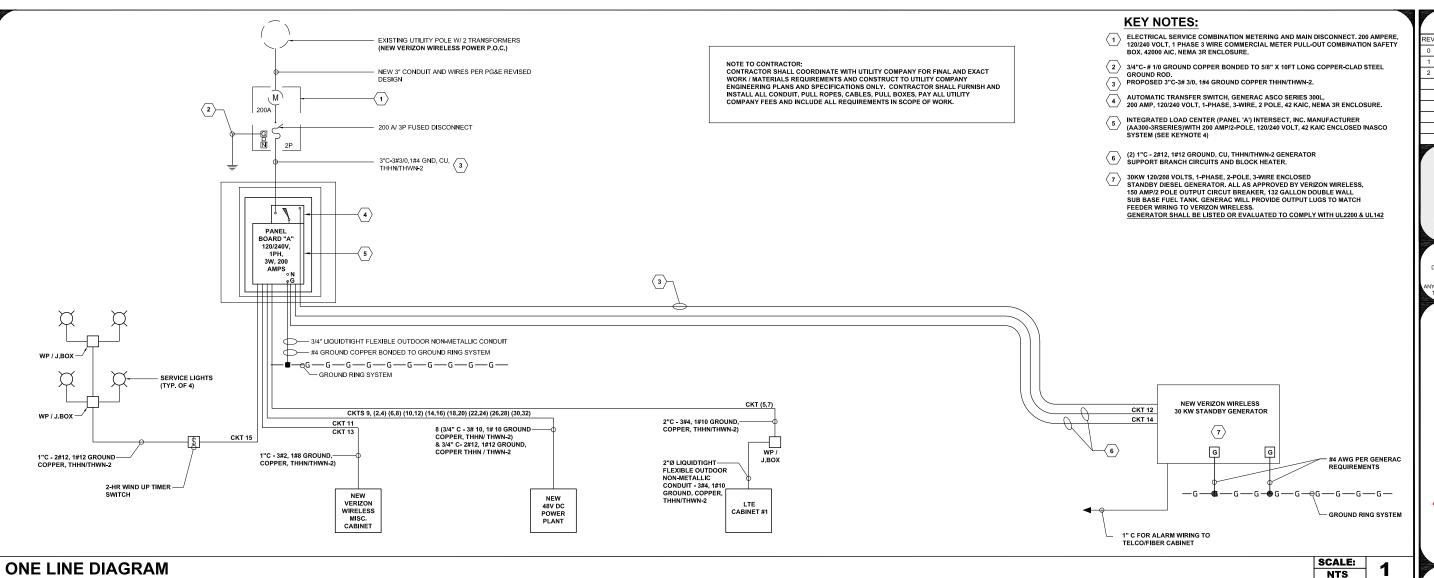
2680 HWY 154 SANTA BARBARA CA, 93105

ANTENNA COLOR CODING & NOTES

E-1

N.T.S.

N.T.S.



1. ALL NEW GROUNDINGS FOR METER MUST BE DONE PER NEC & LOCAL BUILDING & SAFETY REQUIREMENTS.

2. ALL NEW CONDUIT TRENCHING FROM METER TO THE SITE MUST HAVE MIN. 30" OF COVER TO FINISH GRADE. INSTALL UNDERGROUND PULL BOXES AS REQD. PER NEC & LOCAL BLDG. & SAFETY REQUIREMENTS & MUST HAVE TRAFFIC COVER.

3. ALL NEW UNDERGROUND PULL BOXES MUST HAVE MIN. 2 FT. OF 1" CRUSHED ROCK AS BASE, AND TOP OF BOX TO BE 1 1/2" ABOVE FINISH GRADE INDOOR: EMT (RGS ON TRAFFIC AREAS)

4. ALL NEW WIRE SPLICES IN UNDERGROUND PULL BOXES DONE PER NEC.

5. FIELD VERIFY EXACT BORING ROUTE.

6. VERIZON WIRELESS NEW METER/MAIN NEED TO BE LABELED & ALL CLEARANCE FOR

7. NEW GROUND RODS MAYBE USED FOR SITE GROUNDING IF DESIRED RESISTANCE IS ACHIEVED.

8. CONTRACTOR TO INSTALL UTILITY CONDUIT (LATERAL).

1. UTILITY POINTS OF SERVICE AND WORK / MATERIALS SHOWN ARE BASED UPON PRELIMINARY INFORMATION PROVIDED BY THE UTILITY COMPANY AND ARE FOR BID PURPOSES ONLY.

2. CONTRACTOR SHALL COORDINATE WITH UTILITY COMPANY FOR FINAL AND EXACT WORK/ MATERIALS REQUIREMENTS AND CONSTRUCT TO UTILITY COMPANY ENGINEERING PLANS AND SPECIFICATIONS ONLY. CONTRACTOR SHALL FURNISH AND INSTALL ALL CONDUIT. PULL ROPES, CABLES, PULL BOXES, CONCRETE
ENCASEMENT OF CONDUIT (IF REQUIRED), TRANSFORMER
PAD, BARRIERS, POLE RISERS, TERCHING, BACKFILL, PAY
ALL UTILITY COMPANY FEES AND INCLUDE ALL REQUIREMENTS IN SCOPE OF WORK.

DESCRIPTION	C/B	NO.	PHASE A	PHASE B	NO.		DESCRIPTION
SURGE SUPPRESSOR (INTERNAL)	30A	1	1,200	-	2]20A/	48 VDC POWER PLANT
OOKOE OOF FREGOOK (INTERNAL)	/2P	3	-	1,200	4	2P	RECTIFIER #1
LTE CABINET #1	50A	5	3,900	-	6	20A	48 VDC POWER PLANT
2.2 0.02	2P	7	-	3,900	8	2P	RECTIFIER #2
48 VDC POWER PLANT GFI	20A 1P	9	2,400	-	10	20A	48 VDC POWER PLANT
MISC. CABINET CT1	20A 1P	11	-	2,400	12	/2P	RECTIFIER #3
MISC. CABINET GFI	20A 1P	13	2,400	-	14]20A/	48 VDC POWER PLANT
SERVICE LIGHTS	20A 1P	15	-	2,800	16	2P	RECTIFIER #4
SPACE		17	1,200	-	18	20A	48 VDC POWER PLANT
SPACE		19	-	1,200	20	2P	RECTIFIER #5 (FUTURE)
SPACE		21	1,200	-	22]20A/	48 VDC POWER PLANT
SPACE		23	-	1,200	24	2P	RECTIFIER #6 (FUTURE)
SPACE		25	1,200	-	26]20A/	48 VDC POWER PLANT
SPACE		27	-	1,200	28	2P	RECTIFIER #7 (FUTURE)
SPACE		29	1,200	-	30	20A/	48 VDC POWER PLANT
SPACE		31	-	1,200	32	/2P	RECTIFIER #8 (FUTURE)
SPACE		33	-	-	34		SPACE
SPACE		35	-	-	36		SPACE
SPACE		37			38		SPACE
SPACE		39			40		SPACE
SPACE		41			42		SPACE
CONNECTED LOAD PHASE A			14,700	15,100	PHASE B- CONNECTED LOAD		- CONNECTED LOAD
TOTAL LOAD PHASE A + PHASE I	3 =		29,800 W				
25% LCL =			400 W				
TOTAL LOAD (CONNECTED + 25%	LCL)	-	30,200 W				

ISSUE STATUS

REV.	DATE	DESCRIPTION	BY
0	02/17/15	90% CONSTRUCTION	SR
1	02/26/15	95% CONSTRUCTION	SR
2	03/16/15	OUTDOOR EQUIPMENT	EC



5865 AVENIDA ENCINAS CARLSBAD, CA 92008 www.sacw.com 760,795,5200

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Y USE OR DISCLOSURE OTHER THAN AS IT RELATE TO VERIZON WIRELESS IS STRICTLY PROHIBITED





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SHEET TITLE: 1-LINE DIAGRAM, **PANEL SCHEDULE & UTILITY NOTES**


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E-2



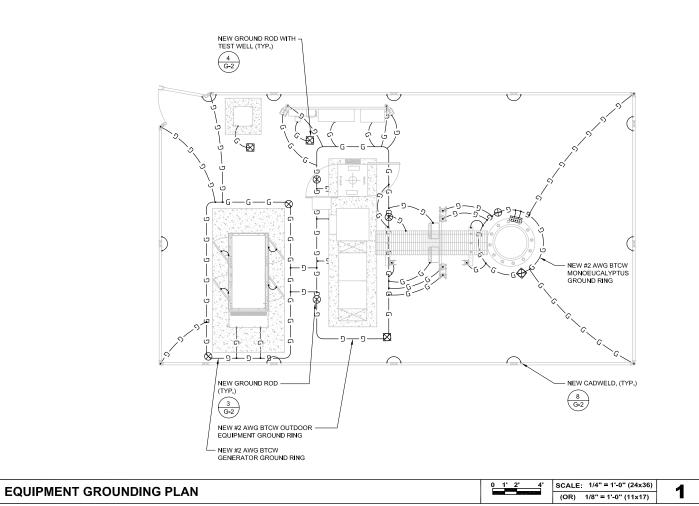

PANEL ANTENNA RAD CENTER @ 42'-0"

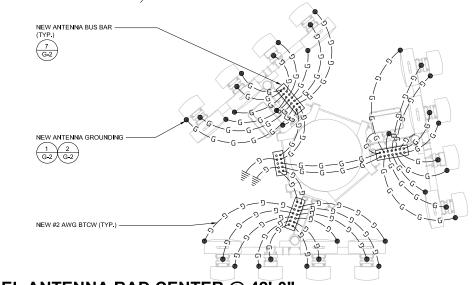

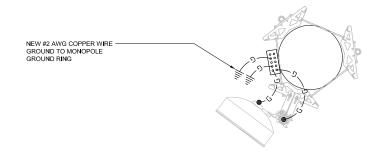MICROWAVE ANTENNA RAD CENTER @ 35'-0"

ANTENNA GROUNDING PLAN

0 6" 1' 2' SCALE: 1/2" = 1'-0" (24x36) (OR) 1/4" = 1'-0" (11x17)

2

SROUND BARS:

A. EQUIPMENT GROUND BUS BAR (EGB) LOCATED AT BOTTOM OF ANTENNA POLEMAST FOR MAKING GROUNDING JUMPER CONNECTIONS TO COAX FEEDER CABLES SHALL BE FURNISHED AND INSTALLED BY ELECTRICAL CONTRACTOR, JUMPERS (FURNISHED BY OWNERS) SHALL BE INSTALLED AND CONNECTED BY ELECTRICAL CONTRACTOR.

SERVICE GROUNDING.

BARE COPPER

PROJECT MANAGER.

DESCRIPTION 90% CONSTRUCTION

95% CONSTRUCTION SR

OUTDOOR EQUIPMENT | EC

ISSUE STATUS

DATE

1 02/26/15

2 03/16/15



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SHEET TITLE:

GROUND PLANE LAYOUT

G-1

1. ALL DETAILS ARE SHOWN IN GENERAL TERMS, ACTUAL GROUNDING INSTALLATION REQUIREMENTS AND CONSTRUCTION ACCORDING TO SITE CONDITIONS.
2. ALL GROUNDING CONDUCTORS: #2 AWG SOLID BARE TINNED COPPER WIRE UNLESS OTHERWISE NOTED.
3. GROUND BAR LOCATED IN BASE OF EQUIPMENT WILL BE PROVIDED, FURNISHED AND INSTALLED BY THE VENDOR.
4. ALL BELOW GRADE CONNECTIONS: EXOTHERMIC WELD TYPE, ABOVE GRADE CONNECTIONS: EXOTHERMIC WELD TYPE, ABOVE MINIMUM BELOW THE FROST LINE, WHICH EVER IS DEEPER.
5. GROUND RING SHALL BE LOCATED A MINIMUM OF 30" BELOW GRADE OR 6" MINIMUM BELOW THE FROST LINE, WHICH EVER IS DEEPER.
6. INSTALL GROUND CONDUCTORS AND GROUND ROD MINIMUM OF 1-0" FROM EQUIPMENT CONCRETE SLAB, SPREAD FOOTING, OR FENCE.
7. EXOTHERMIC WELD GROUND CONNECTION TO FENCE POST: TREAT WITH A COLD GALVANIZED SPRAY.
8. GROUND BARS:

8. GROUND BARS:

B. MAIN GROUND BUS BAR (MGB) LOCATED NEAR THE BASE OF THE B. MAIN GROUND BUS BAR (MGB) LOCATED NEAR THE BASE OF THE RADIO EQUIPMENT CABINET(S) SHALL BE FURNISHED AND INSTALLED BY ELECTRICAL CONTRACTOR.

2. ALL GROUNDING INSTALLATIONS AND CONNECTIONS SHALL BE MADE BY ELECTRICAL CONTRACTOR.

10. OBSERVE A.E.C. AND LOCAL UTILITY REQUIREMENTS FOR ELECTRICAL

SERVICE GROUNDING.

11. GROUNDING ATTACHMENT TO TOWER SHALL BE AS PER MANUFACTURER'S RECOMMENDATIONS OR AT GROUNDING POINTS PROVIDED (2 MINIMUM).

12. ALL NEW EXTERIOR GROUNDING AND TOP OF NEW GROUNDING RODS SHALL BE BURIED TO MINIMUM DEFTH OF 1'-8" BELOW FINISH GRADE, ELECTRIC METER GROUND EXCEPTED.

13. ALL NEW GROUNDING LEAD CONDUCTORS SHALL BE #2 SOLID TINNED

BARE COPPER.

14. NEW GROUND SYSTEM MUST BE TESTED AND SHALL HAVE A RESISTANCE OF 5 OHMS OR LESS, SUBMIT AND INDEPENDENT FALL OF POTENTIAL TESTING REPORT.

15. NOTIFY PROJECT MANAGER IF THERE ARE ANY DIFFICULTIES INSTALLING GROUNDING SYSTEM DUE TO SITE SOIL CONDITIONS.

16. CHEMICAL GROUNDS SHALL BE XIT, CHEM-ROC OR APPROVED EQUAL, MALEN BECLUEED.

16. CHEMICAL GROUNDS SHALL BE XIT, CHEM-ROC OR APPROVED EQUAL, WHEN REQUIRED.

17. ALL NEW UNDERGROUND GROUNDING CONNECTORS ARE TO BE CADWELDED ABOVE GRADE GROUNDING SHALL BE DE EITHER CADWELD OR MECHANICAL AS SPECIFIED ON DRAWINGS.

18. ALL NEW GROUNDING INSTALLATION IS TO BE IN ACCORDANCE WITH THE VERIZON WIRELESS STANDARDS AND SUPPLEMENTS PROVIDED BY THE

NOT USED

GROUNDING NOTES

N.T.S.

